# Rosemary/Columbia Hotel

110 West Rosemary Street

CONDITIONAL ZONING APPLICATION

CHAPEL HILL, NORTH CAROLINA

#### CONTRACT PURCHASER / CLIENT:

SMART OLYMPIA CAROLINA LLC 20600 CHAGRIN BOULEVARD, SUITE 705 SHAKER HEIGHTS, OH 44122 216-533-0500 CONTACT: ED SMALL

#### APPLICANT / CONSULTANT:

LANDSCAPE ARCHITECT / LAND PLANNER: 111 WEST MAIN STREET DURHAM, NC 27701 919-682-0368 CONTACT: WENDI RAMSDEN

#### RESOURCE CONSERVATION NOTES

ACCORDING TO FIRM MAP 3710978800K EFFECTIVE 11-17-17.

THERE ARE NO MAPPED STREAMS ON SITE.

FLOODPLAIN PROTECTION: THE SITE IS NOT IN AN AREA AFFECTED BY A MAPPED FLOODPLAIN

STEEP SLOPE PROTECTION: THERE ARE 2,173 SF OF STEEP SLOPES ON SITE - ALL ARE CONSTRUCTED (NOT NATURAL) SLOPES

WETLANDS: THERE ARE NO MAPPED WETLANDS ONSITE.

# LAND SWAF 8,887.26 SF TO TRANSFER -7,846.75 SF TO TO TOWN TO DEVELOPER PARCEL KEY 1"=500'

#### PROJECT NOTES

BOUNDARY AND TOPOGRAPHIC SURVEY PROVIDED BY BALLANTINE ASSOCIATES, PA DATED AUGUST 26, 2019

SURROUNDING SITE AND PROPERTY INFORMATION PER CHAPEL HILL GIS

#### TOWN OF CHAPEL HILL NOTES

- 1. A FIRE FLOW REPORT SHALL BE SUBMITTED TO THE TOWN FOR REVIEW AND APPROVAL PRIOR TO ISSUANCE OF A ZCP.
- 2. P.E. CERTIFICATION: PRIOR TO THE ISSUANCE OF A CERTIFICATE OF OCCUPANCY FOR ANY PHASE, THE APPLICANT SHALL PROVIDE A CERTIFICATION, SIGNED AND SEALED BY A NORTH CAROLINA-LICENSED PROFESSIONAL ENGINEER, THAT THE STORMWATER MANAGEMENT FACILITY IS CONSTRUCTED IN ACCORDANCE WITH THE APPROVED PLANS AND SPECIFICATIONS.
- 3. AS-BUILT PLANS: PRIOR TO THE ISSUANCE OF A CERTIFICATE OF OCCUPANCY, THE APPLICANT SHALL PROVIDE CERTIFIED AS-BUILT PLANS FOR BUILDING FOOTPRINTS, PARKING LOTS, STREET IMPROVEMENTS, STORM DRAINAGE SYSTEMS AND STORMWATER MANAGEMENT STRUCTURES, AND ALL OTHER IMPERVIOUS SURFACES, AND A TALLY OF THE CONSTRUCTED IMPERVIOUS AREA. THE AS-BUILT PLANS SHOULD BE IN DXF BINARY FORMAT USING STATE PLANE COORDINATES AND NAVD 88.

#### LIST OF SHEETS:

REVISED	CZ-0.0	COVER SHEET
	CZ-0.1	AREA MAP
	CZ-1.0	EXISTING CONDITIONS PLAN
	CZ-1.1	NOTES
REVISED	CZ-1.2	CONSTRUCTION MANAGEMENT PLAN
REVISED	CZ-1.3	LANDSCAPE PROTECTION PLAN
REVISED	CZ-2.0	SITE PLAN
REVISED	CZ-3.0	GRADING & STORMWATER PLAN
REVISED	CZ-5.0	UTILITY PLAN
REVISED	CZ-6.0	LIGHTING PLAN
REVISED	CZ-7.0	LANDSCAPE PLAN
	CZ-8.0	SITE DETAILS
REVISED	AS101	EXTERIOR ELEVATIONS AND BUILDING ENVELOPE
REVISED	AS102	EXTERIOR ELEVATIONS AND BUILDING ENVELOPE
	AS103	EXTERIOR ELEVATIONS AND BUILDING ENVELOPE

PARCEL A: ADDRESS PIN OWNER ACREAGE ZONING	108 WEST ROSEMARY STREE 9788-37-0680 KW RC PROPERTIES LLC 3,624.9 SF TC-2
PARCEL B:	TC-2

**ADDRESS** 114 WEST ROSEMARY STREET 9788-37-0549 KW RC PROPERTIES LLC OWNER ACREAGE 7,249.8 SF ZONING TC-2

PARCEL C: **ADDRESS** 208 PRITCHARD AVENUE 9788-27-9667 KW RC PROPERTIES LLC **ACREAGE** 15,262.3 SF PROPOSED ACREAGE: 8,887.26 SF / 0.204 AC ZONING

PARCEL D: **ADDRESS** N/A (NO STREET FRONTAGE) 9788-27-9700 OWNER KW RC PROPERTIES LLC ACREAGE 4,527.3 SF ZONING

PARCEL E: 205 NORTH COLUMBIA STREET **ADDRESS** 9788-37-0721 KW RC PROPERTIES LLC OWNER ACREAGE 9,320.0 SF ZONING

PARCEL F: **ADDRESS** 205 NORTH COLUMBIA STREET 9788-37-0647 KW RC PROPERTIES LLC OWNER **ACREAGE** 9,166.9 SF TC-2 ZONING PARCEL G: **ADDRESS** 110 WEST ROSEMARY STREET

9788-37-0535 OWNER TOWN OF CHAPEL HILL 7,846.75 SF **ACREAGE** TOTAL SURVEYED AREA: 56,997.96 SF / 1.31 AC

PARCELS A THRU F UNDER CONTRACT TO DEVELOPER: 49,151.20 PROPOSED POST DEVELOPMENT LAND OWNED BY PROJECT DEVELOPER: 48,110.70 SF / 1.10 AC

EXISTING VACANT COMMERCIAL, CONVERTED RESIDENCES, ONE SINGLE FAMILY RESIDENTIAL **PROPOSED** 

ZONING: PROPOSED OI REZONE TO TC-2 - CZD R-3 REZONE TO TC-2 - CZD

ALLOWABLE FAR FOR PROPOSED ZONE: 1.97 MAX.

- 1,250 SF ONE STORY BRICK BUILDING TO BE REMOVED **EXISTING BUILDINGS:** - 1,689 SF TWO STORY WOOD FRAME HOUSE TO BE REMOVED 2,939 SF TOTAL SQUARE FOOTAGE TO BE REMOVED

1,800 SF BUILDING TO REMAIN, TO BE DEEDED TO TOWN

(LOCATED ON PARCEL C)

PROPOSED BUILDINGS: +/- 20,500 SF FOOTPRINT (+/- 92,500 SF TOTAL)

130-135 ROOMS

BUILDING HEIGHT: 5 STORIES PLUS LOWER SERVICE LEVEL ACCESSED FROM NORTH DRIVEWAY

VEHICULAR PARKING:

LAND USE:

REQUIRED N/A (TOWN CENTER DISTRICT)

MAXIMUM 122 (0.9 PER LODGING UNIT - 135 X 0.9 = 122)

PROPOSED APPROX 40 SPACES ON-SITE

BICYCLE PARKING:

REQUIRED 9 (1 PER 15 LODGING UNITS 140 / 15 = 9)

PROPOSED 10 SPACES (5 LOOPS)

4 LOOPS IN PROTECTED PARKING DECK, 1 LOOP NEAR LOBBY ENTRY

PROJECT AREA: 74,134 SF / 1.70 AC

INCLUDES TOWN LAND TO BE DEVELOPED

TOTAL AREA DISTURBANCE PRE-DEV IMPERVIOUS POST-DEV IMPERVIOUS LOCATION NET AREA 53,727 SF PROJECT AREA 74,134 SF 63,200 SF 50,164 SF FINAL HOTEL SITE 47,440 SF 26,114 SF 39,249 SF 5,054 SF POCKET PARK PARCEL 8,180 SF 7,966 SF 5,184 SF



111 West Main Street

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NC BOARD OF LANDSCAPE ARCHITECTS LIC # C-104


Project:

*Rosemary/* Columbia Hote1

110 W. Rosemary St.

Orange County, North Carolina

9788-37-0680 9788-37-0549 9788-27-9667 9788-27-9700 9788-37-0721 9788-37-0647

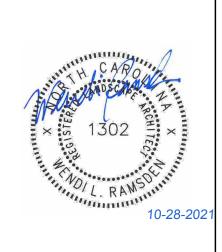

PRELIMINARY-DO NOT USE FOR CONSTRUCTION

Job Number: 1963


Drawn WLR, MTC Checked WLR Date 9-24-2020 Revisions TOWN REVIEW REVISIONS TOWN REVIEW REVISIONS 4-28-2021

FINAL CZ REVISIONS COUNCIL REVISIONS 10-28-2021

Conditional Zoning Sheet Title:

> COVER SHEET

Sheet Number CZ-0.0

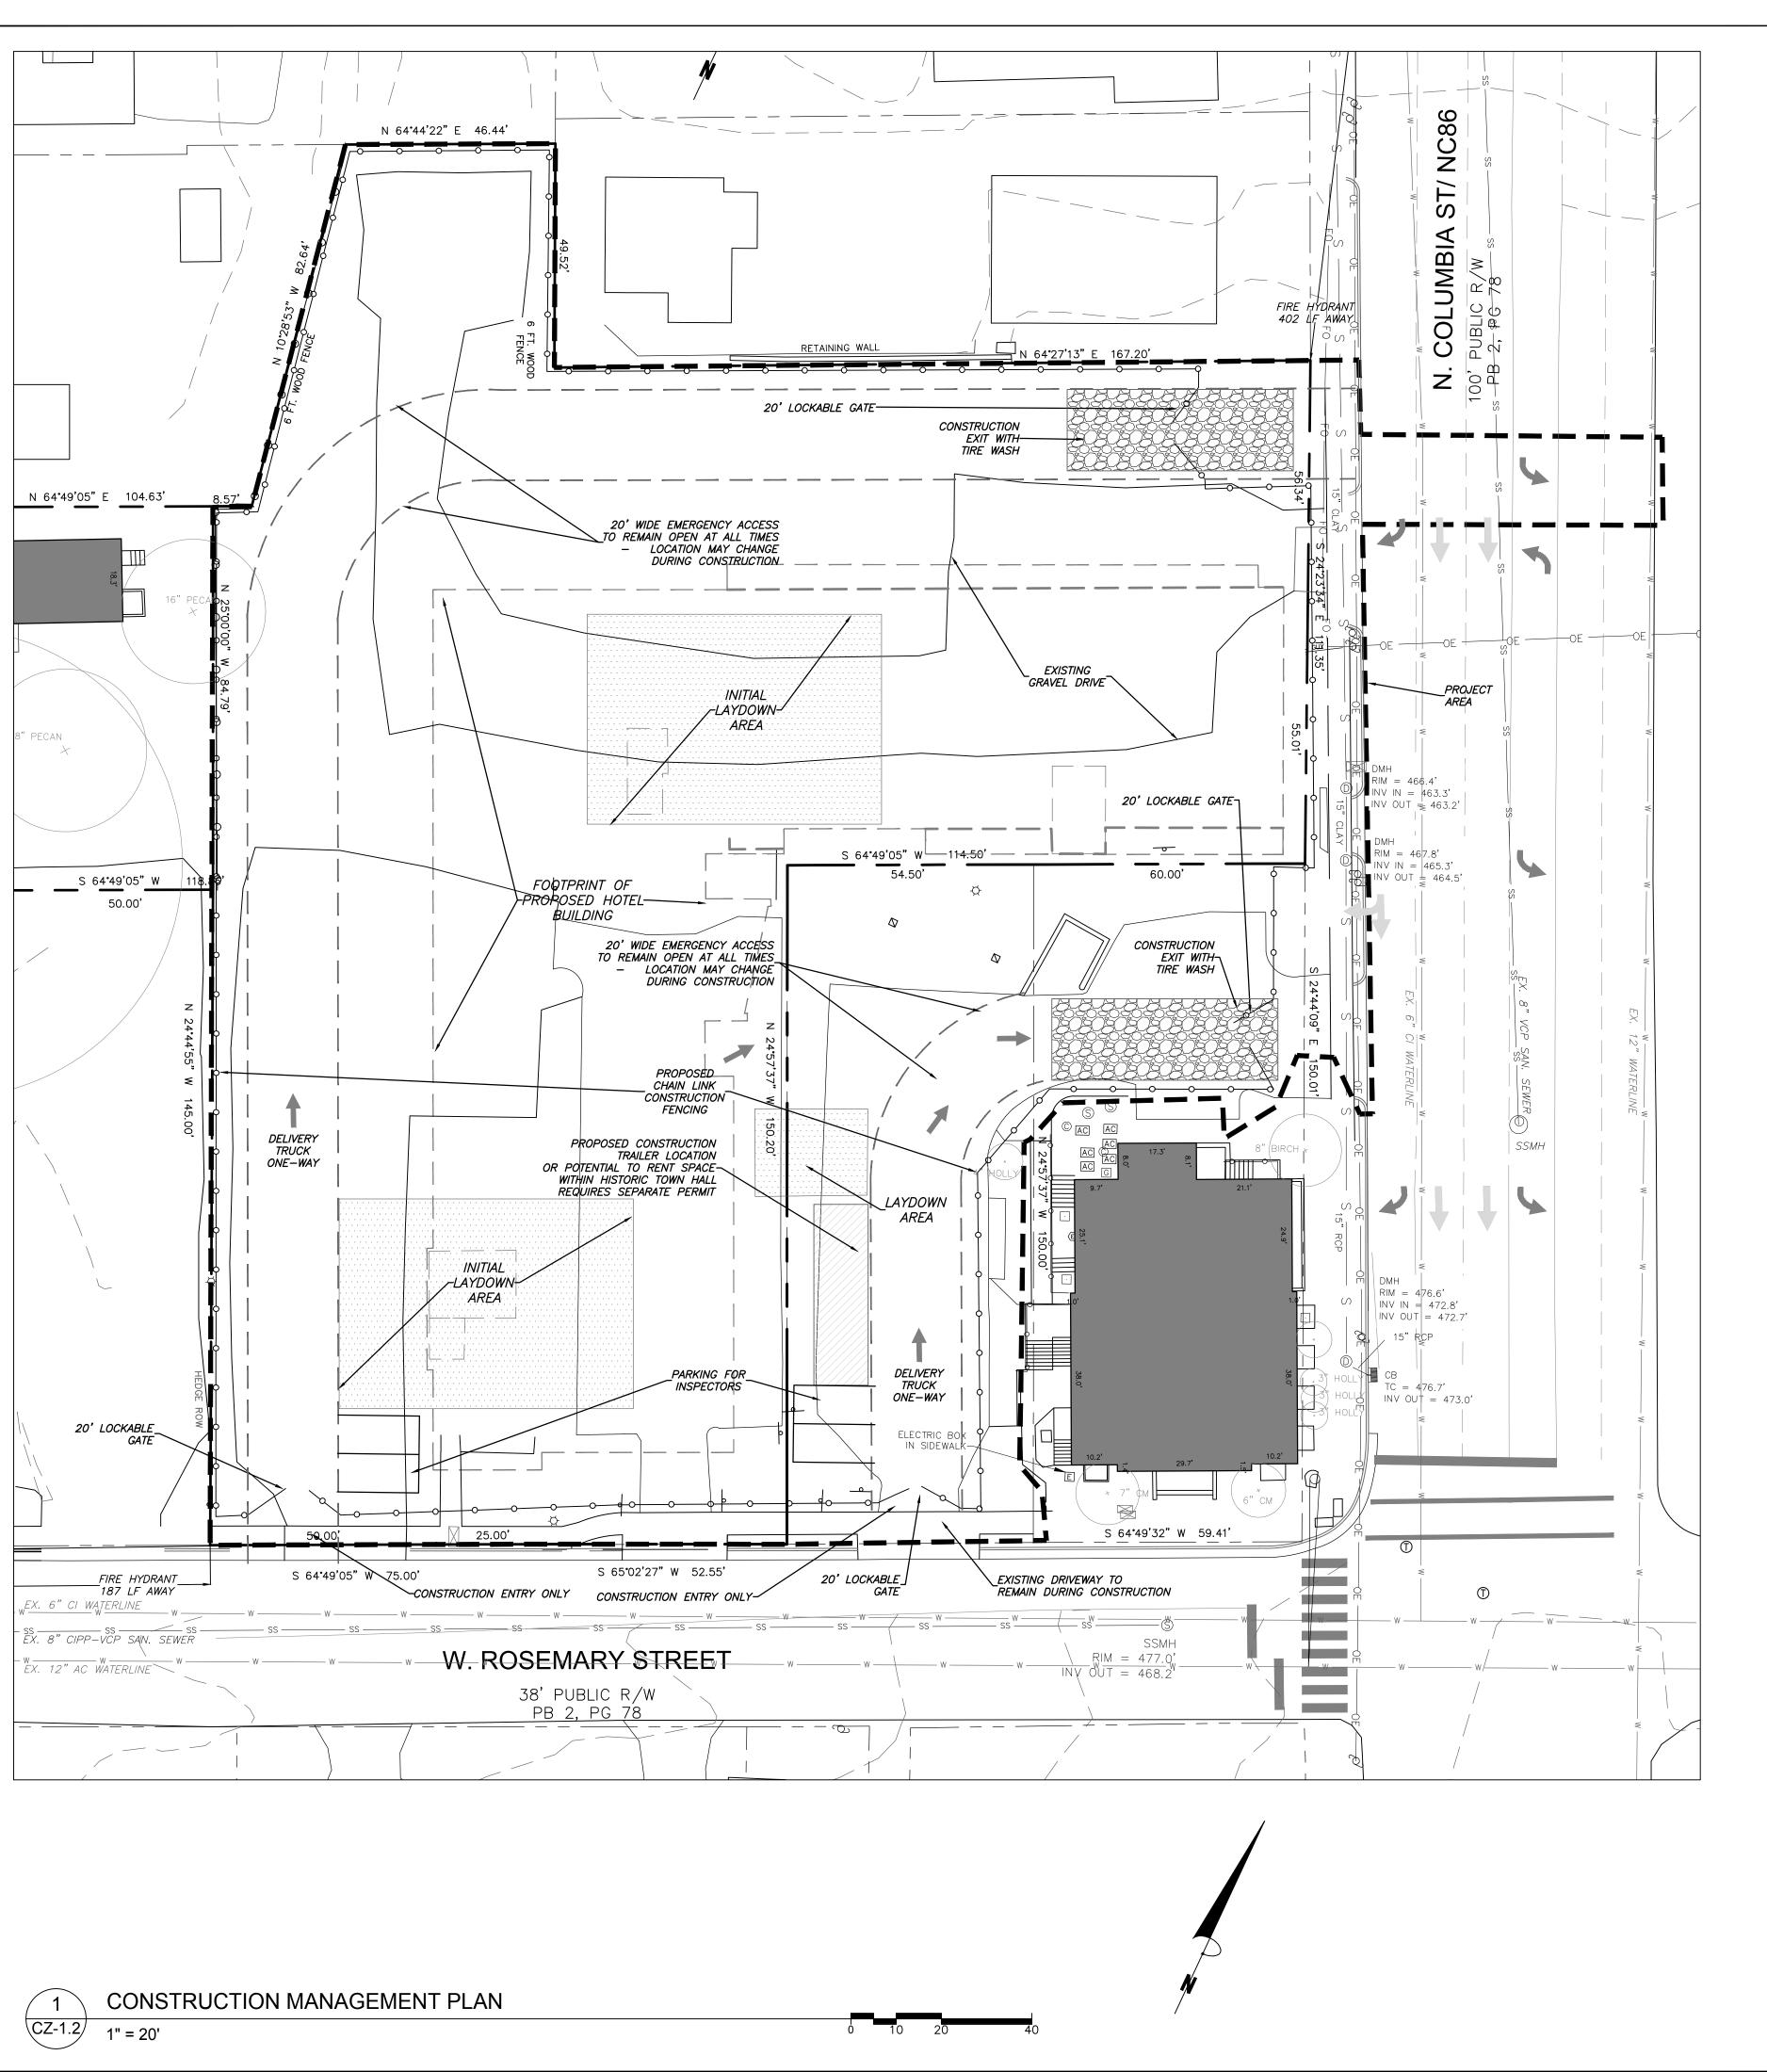

#### CONSTRUCTION STAGING NOTES

- EXISTING GRAVEL PARKING IS TO BE LEFT INTACT FOR CONSTRUCTION WORKERS UNTIL WORK IS DONE IN EACH AREA AND GRAVEL NEEDS TO BE REMOVED.
- 2. <u>NO CONSTRUCTION PARKING WILL BE ALLOWED ON ADJACENT RESIDENTIAL STREETS.</u>

ADMINISTRATION, AND NEIGHBORS NOTIFIED IN ADVANCE.

- 3. HOURS OF CONSTRUCTION ARE MONDAY TO FRIDAY 7 AM TO 6 PM, AND SATURDAY AS NEEDED BETWEEN 8 AM AND 6 PM. THERE WILL BE NO CONSTRUCTION ON SUNDAYS.

  THE TOWN OF CHAPEL HILL NOISE ORDINANCE MUST BE COMPLIED WITH. THE TOWN ORDINANCE SPECIFIES CONSTRUCTION OPERATIONS ARE LIMITED TO 7 AM TO 9 PM WEEKDAYS, AND 8 AM TO 9 PM WEEKENDS.

  ANY ROCK REMOVAL WORK NEEDS TO BE COORDINATED WITH TOWN
- 4. PROVIDE ON—SITE PARKING FOR INSPECTORS AT EACH BUILDING FOR THE DURATION OF THE CONSTRUCTION PROJECT.

#### FIRE PROTECTION NOTES

DARK SIGN WITH

WHITE LETTERING

- 1. CONTRACTOR SHALL MAINTAIN A FIRE WATCH DURING THE CONSTRUCTION OR DEMOLITION OF "HOT WORK" THAT MAY SUBJECT MATERIALS TO SPONTANEOUS COMBUSTION. THE FIRE WATCH SHALL CONSIST OF AT LEAST ONE PERSON WITH A MEANS OF COMMUNICATING AN ALARM TO 911, SHALL HAVE A WRITTEN ADDRESS POSTED IN A CONSPICUOUS LOCATION, AND SHALL MAINTAIN CONSTANT PATROLS.
- 2. ALL CONSTRUCTION AND DEMOLITION SHALL COMPLY WITH THE CURRENT EDITION OF CHAPTER 14 OF THE NC FPC (FIRE CODE).
- 3. ANY PERMANENT OR TEMPORARY GATES ACROSS FIRE ACCESS DRIVES SHALL BE A MINIMUM WIDTH OF 20', EITHER SWINGING OR SLIDING TYPE, HAVE AN EMERGENCY MEANS OF OPERATION, AND SHALL BE OPERABLE BY EITHER FORCIBLE ENTRY OR KEYED, CAPABLE OF BEING OPERATED BY ONE PERSON, AND SHALL BE INSTALLED AND MAINTAINED ACCORDING TO UL 325 AND ASTM F 2200 NC FPC 2012.

NAME

NOT TO SCALE

BOLT SIGN TO

POSTS

#### TRAFFIC/PEDESTRIAN CONTROL NOTES

- 1. SIGNS SHOWN ON THIS PLAN ARE REQUIRED DURING THE CONSTRUCTION OF THIS PROJECT.
- 2. CONSTRUCTION WILL REQUIRING TEMPORARY LANE CLOSURES ON PUBLIC STREETS NEED TOWN APPROVAL. TEMPORARY LANE CLOSURES ARE ONLY ALLOWED DURING DAYLIGHT
- HOURS.
  3. 4. ALL WORK ZONE SIGNAGE SHALL COMPLY WITH APPLICABLE M.U.T.C.D. STANDARDS AND DETAILS.
- 4. PRIOR TO ANY TRAFFIC LANE CLOSURES, IT WILL BE NECESSARY TO CONTACT ERNIE ROGERS AT 919-968-2833, OF THE CHAPEL HILL ENGINEERING DIVISION, AT LEAST 5 WORKING DAYS BEFORE THE PROPOSED WORK TO APPLY FOR A LANE CLOSURE PERMIT.
- 5. SIGNS AND TEMPORARY BARRICADES AS SHOWN BELOW WILL BE PLACED TO DIRECT PEDESTRIANS WHEN SIDEWALKS ARE IN THE CONSTRUCTION AREAS.

1. AT A MINIMUM, THE SIGN IS TO INCLUDE

NAME, OWNER CONTACT, CONTRACTOR

SIGN IS TO BE REMOVED AT PROJECT

4. THE SIGN WILL NEED A SEPARATE PERMIT

THROUGH TOWN OF CHAPEL HILL

PLANNING DEPARTMENT

2. SIGN IS TO BE A MAXIMUM OF 4' X 8'

COMPLETION

THE FOLLOWING INFORMATION: PROJECT

CONTACT, ZONING COMPLIANCE CONTACT.



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NC BOARD OF EXAMINERS FOR ENGINEERS AND SURVEYORS

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NC BOARD OF LANDSCAPE ARCHITECTS LIC # C-104

Project:

#### Rosemary/ Columbia Hotel

110 W. Rosemary St.

Orange County, North Carolina

PIN: 9788-37-0680 9788-37-0549 9788-27-9667

9788-27-9667 9788-27-9700 9788-37-0721 9788-37-0647

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10-28-202

PRELIMINARY-DO NOT
USE FOR CONSTRUCTION

Job Number: 1963

Drawn WLR, MTC
Checked WLR
Date 9-24-2020
Revisions TOWN REVIEW REVISIONS

3-3-2021 TOWN REVIEW REVISIONS 4-28-2021 FINAL CZ REVISIONS 9-15-2021 COUNCIL REVISIONS

Conditional Zoning


10-28-2021

Sheet Title:

CONSTRUCTION MANAGEMENT PLAN

Sheet Number

CZ-1.2

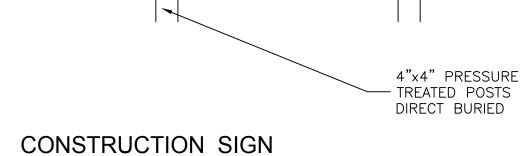

ROSEMARY / COLUMBIA HOTEL

Owner Representative

Contractor:

COMPANY NAME INC.

CONTACT NAME PHONE NUMBER

Zoning Compliance:


Town Of Chapel Hill Planning


Department: 919-968-2728

MINIMUM LETTER


HEIGHT: 4"

PHONE NUMBER

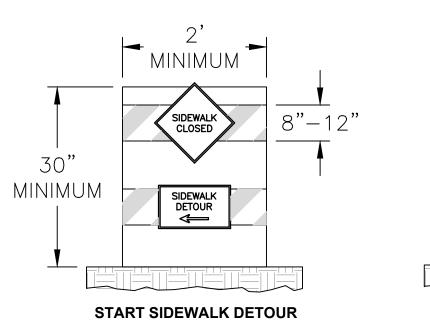

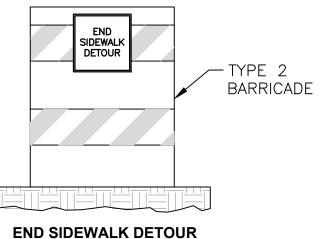

3 SIDEWALK CLOSURE SIGNAGE
CZ-1.2 NOT TO SCALE

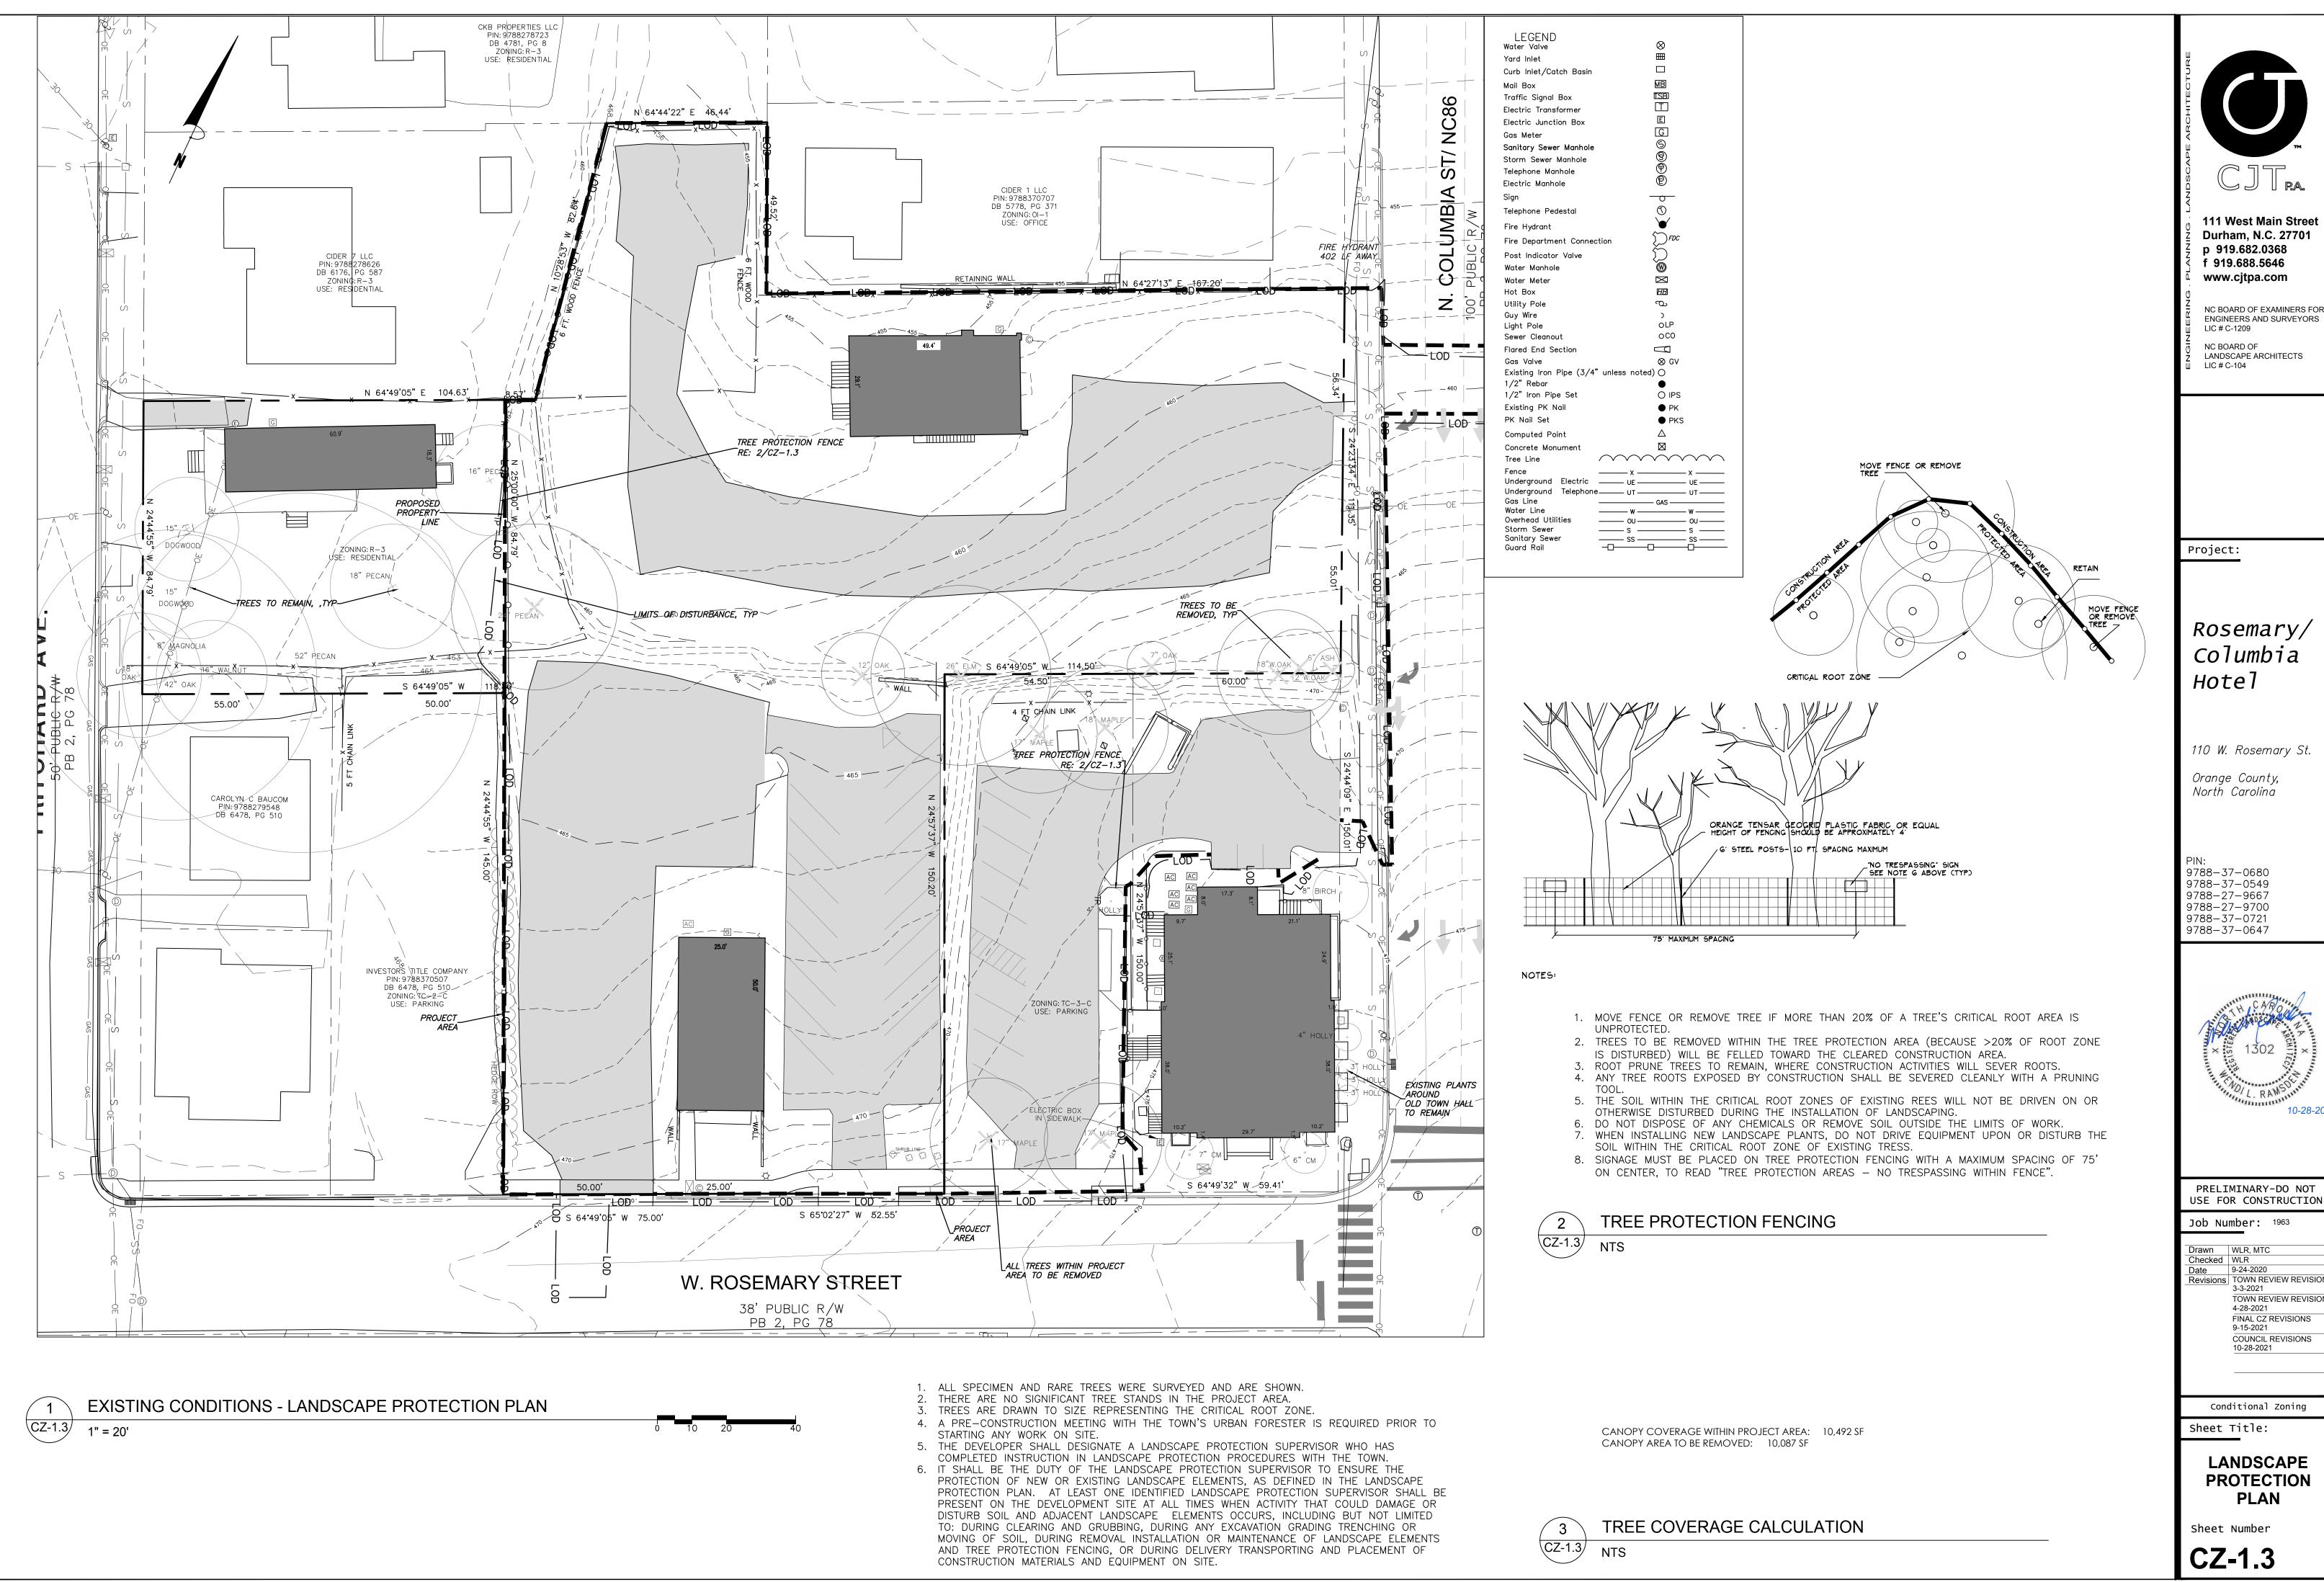

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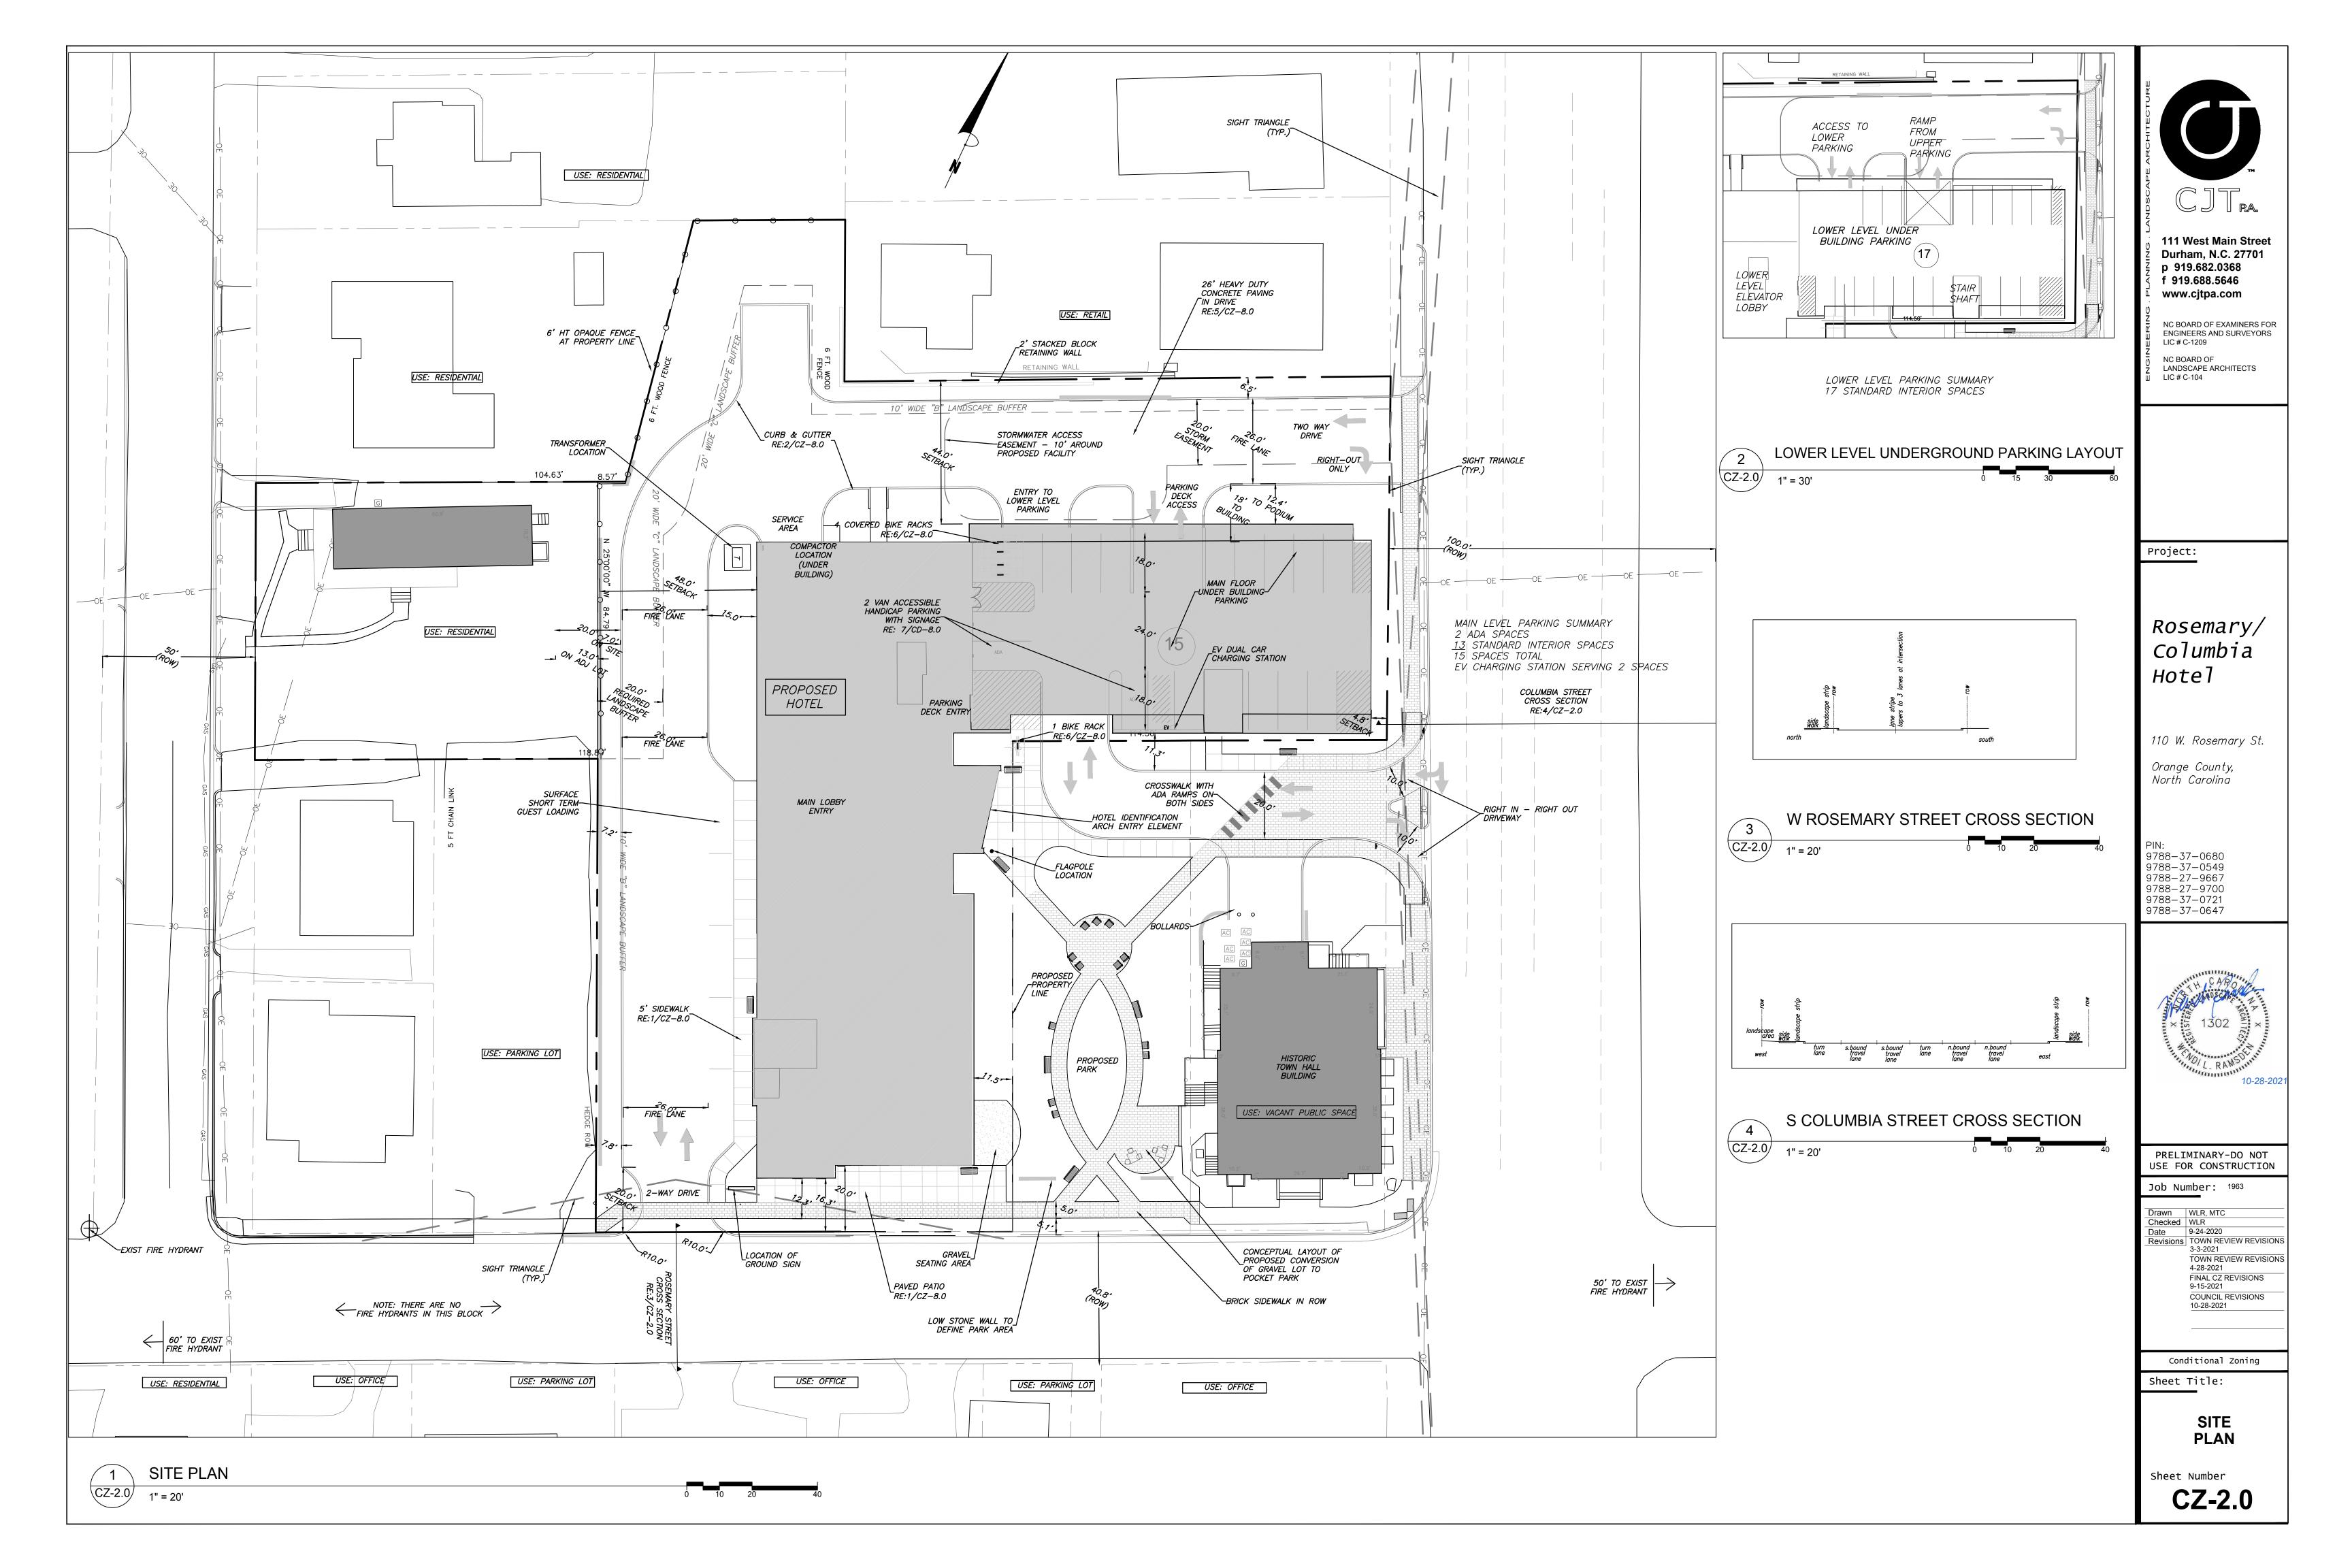
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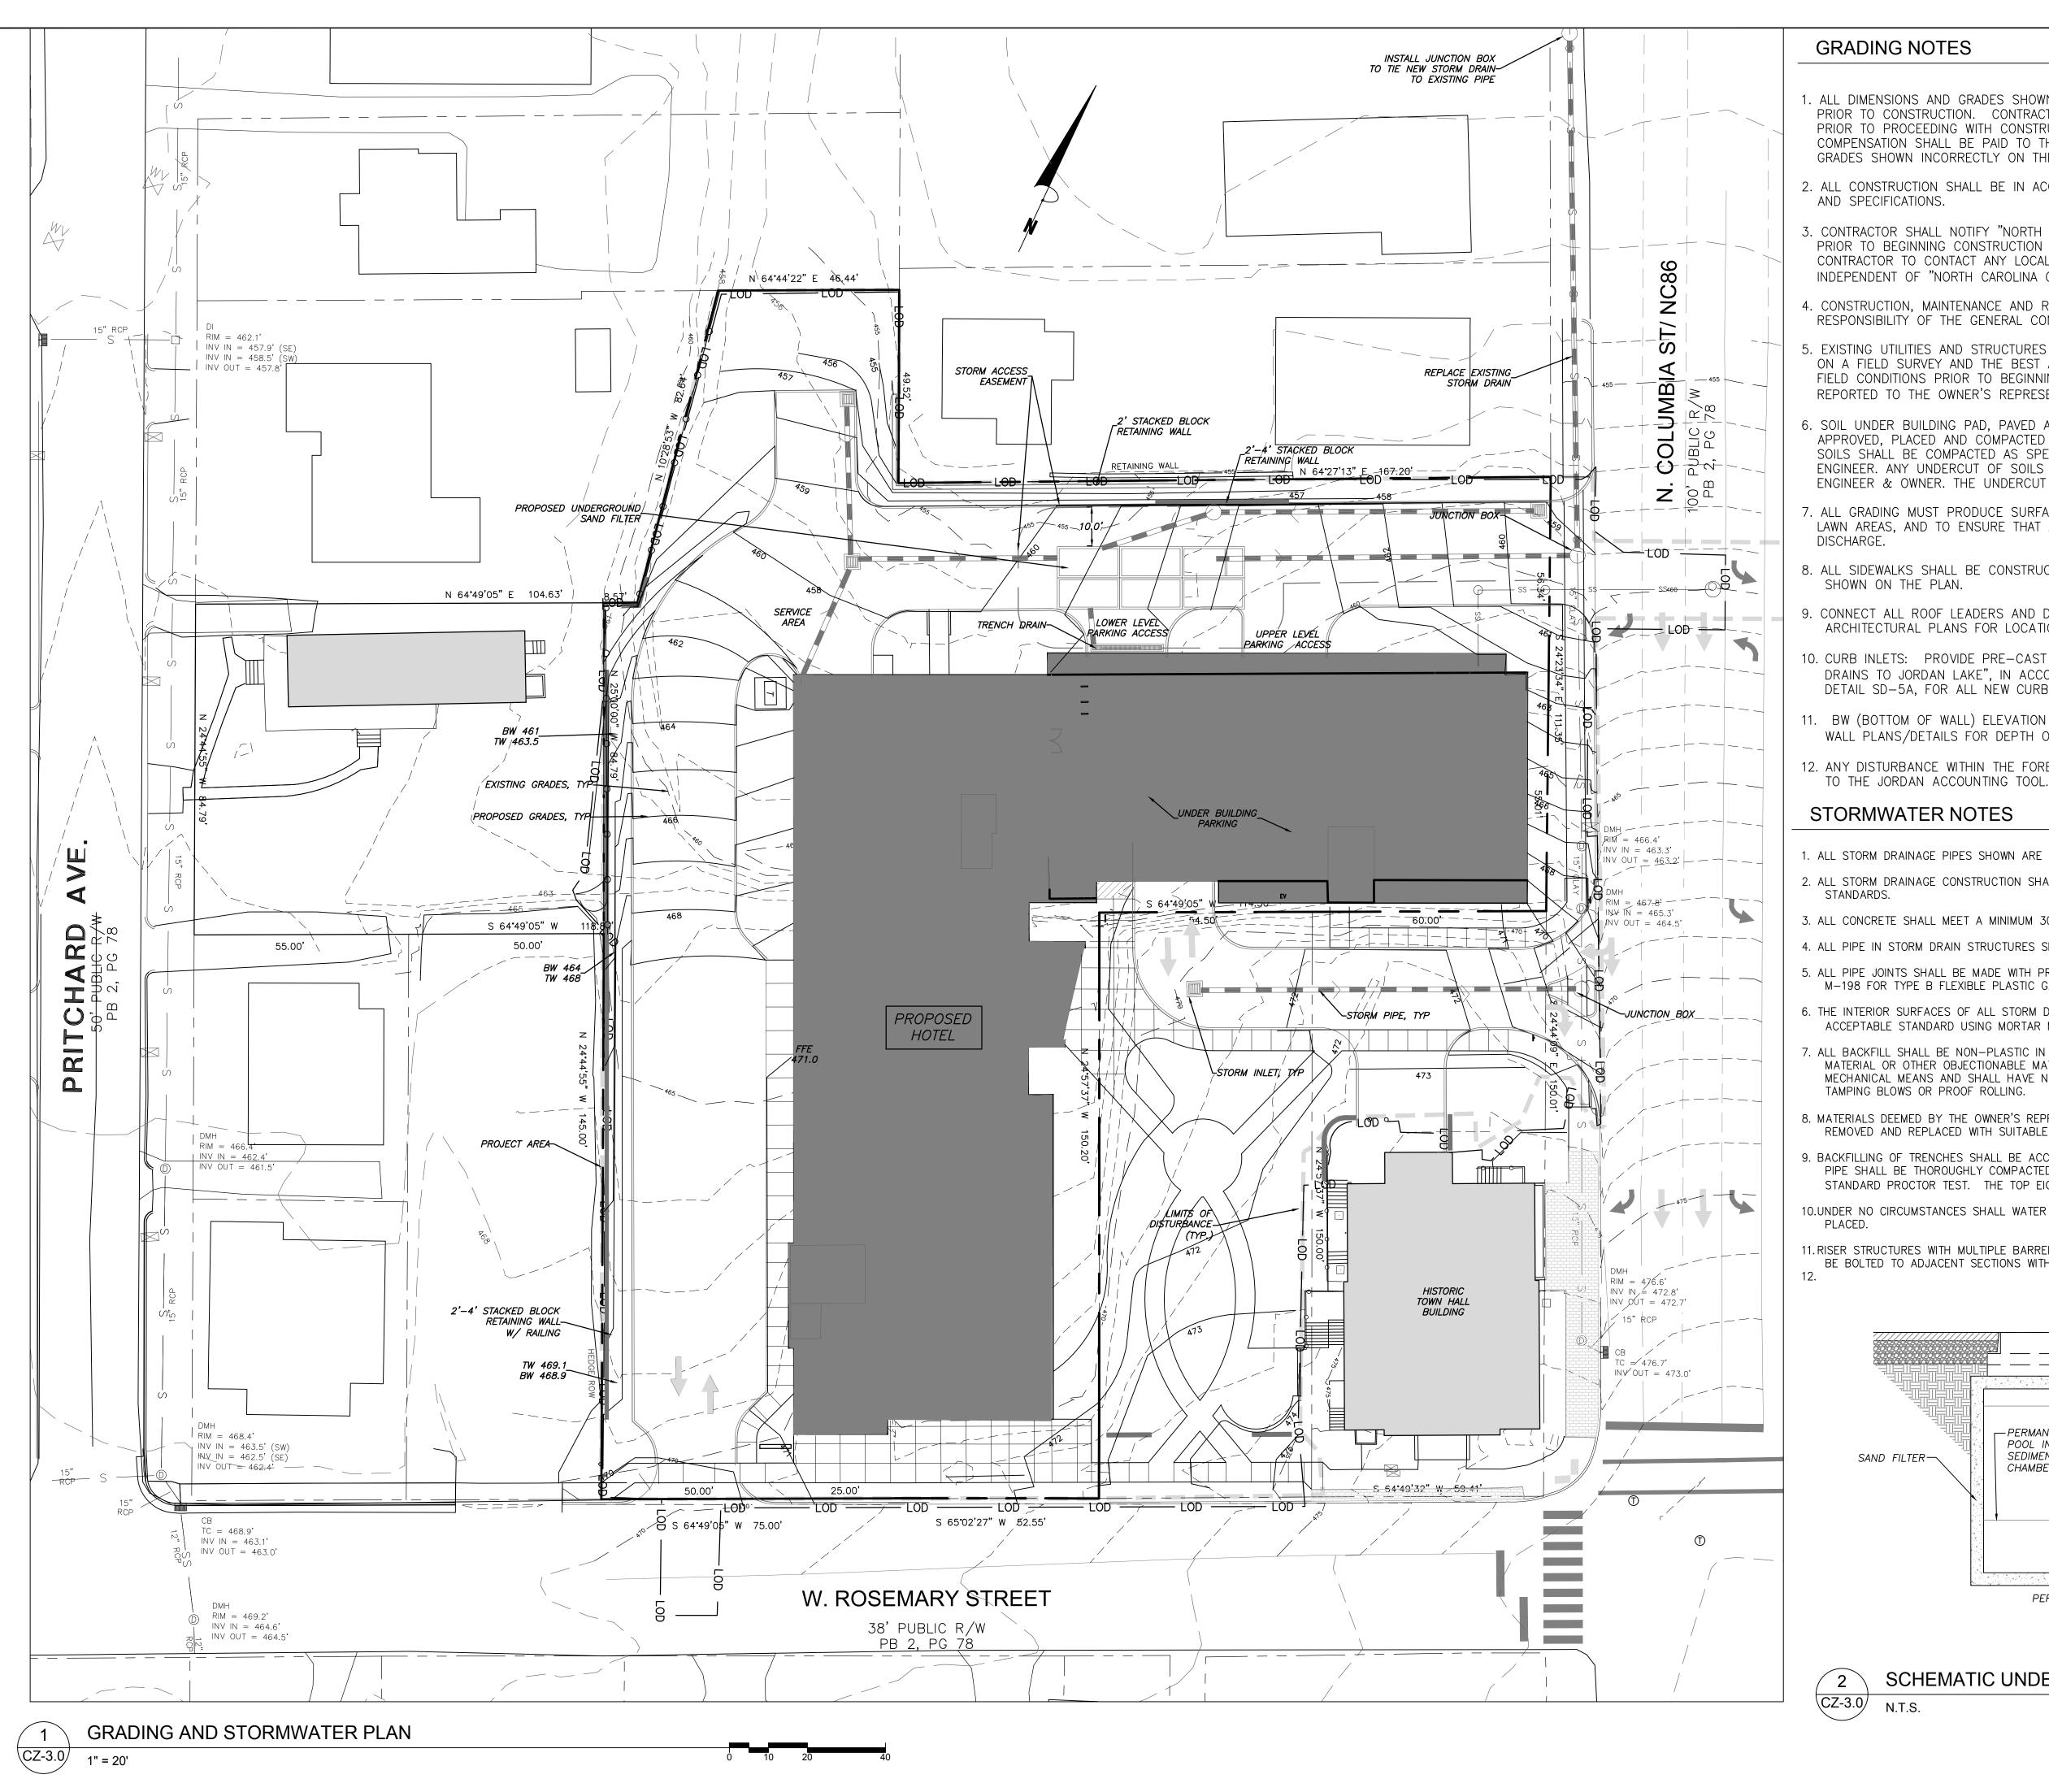
Sheet Title:

LANDSCAPE **PROTECTION PLAN** 

Sheet Number

**CZ-1.3** 






#### **GRADING NOTES**

- 1. ALL DIMENSIONS AND GRADES SHOWN ON THE PLANS SHALL BE FIELD VERIFIED BY THE CONTRACTOR PRIOR TO CONSTRUCTION. CONTRACTOR SHALL NOTIFY THE OWNER IF ANY DISCREPANCIES EXIST PRIOR TO PROCEEDING WITH CONSTRUCTION FOR NECESSARY PLAN OR GRADE CHANGES. NO EXTRA COMPENSATION SHALL BE PAID TO THE CONTRACTOR FOR ANY WORK DONE DUE TO DIMENSIONS OR GRADES SHOWN INCORRECTLY ON THESE PLANS IF SUCH NOTIFICATION HAS NOT BEEN GIVEN.
- 2. ALL CONSTRUCTION SHALL BE IN ACCORDANCE WITH TOWN OF CHAPEL HILL AND NCDOT STANDARDS AND SPECIFICATIONS.
- 3. CONTRACTOR SHALL NOTIFY "NORTH CAROLINA ONE CALL" (1-800-632-4949) AT LEAST 48 HOURS PRIOR TO BEGINNING CONSTRUCTION OR EXCAVATION TO HAVE EXISTING UTILITIES LOCATED. CONTRACTOR TO CONTACT ANY LOCAL UTILITIES THAT PROVIDE THEIR OWN LOCATOR SERVICES INDEPENDENT OF "NORTH CAROLINA ONE CALL".
- 4. CONSTRUCTION, MAINTENANCE AND REMOVAL OF ALL EROSION CONTROL DEVICES ARE THE RESPONSIBILITY OF THE GENERAL CONTRACTOR.
- 5. EXISTING UTILITIES AND STRUCTURES SHOWN, BOTH UNDERGROUND AND ABOVE GROUND, ARE BASED ON A FIELD SURVEY AND THE BEST AVAILABLE RECORD DRAWINGS. THE CONTRACTOR SHALL VERIFY FIELD CONDITIONS PRIOR TO BEGINNING RELATED CONSTRUCTION. ANY DISCREPANCIES SHALL BE REPORTED TO THE OWNER'S REPRESENTATIVE IMMEDIATELY.
- . SOIL UNDER BUILDING PAD, PAVED AREAS AND WITHIN SLOPES GREATER THAN 3:1 (H:V) SHALL BE APPROVED, PLACED AND COMPACTED AS RECOMMENDED BY THE GEOTECHNICAL ENGINEER. THESE SOILS SHALL BE COMPACTED AS SPECIFIED UNLESS OTHERWISE RECOMMENDED BY THE GEOTECHNIC ENGINEER. ANY UNDERCUT OF SOILS IN THESE AREAS SHALL BE APPROVED BY THE GEOTECHNICAL ENGINEER & OWNER. THE UNDERCUT SOILS SHALL ALSO QUANTIFIED BY THE GEOTECHNICAL ENGINEER
- 7. ALL GRADING MUST PRODUCE SURFACE DRAINAGE ADEQUATE TO PREVENT STANDING WATER OR WET LAWN AREAS, AND TO ENSURE THAT ALL STORM WATER FLOWS TO INLETS OR OTHER POINTS OF
- . ALL SIDEWALKS SHALL BE CONSTRUCTED WITH A MAXIMUM 1.8% CROSS SLOPE IN THE DIRECTION SHOWN ON THE PLAN.
- 9. CONNECT ALL ROOF LEADERS AND DOWNSPOUTS TO STORM DRAINAGE SYSTEM WITH PVC PIPE. SEE ARCHITECTURAL PLANS FOR LOCATIONS.
- 10. CURB INLETS: PROVIDE PRE—CAST CURB INLET HOODS AND COVERS STATING, "DUMP NO WASTE! DRAINS TO JORDAN LAKE", IN ACCORDANCE WITH THE SPECIFICATIONS OF THE TOWN STANDARD DETAIL SD-5A, FOR ALL NEW CURB INLETS FOR PRIVATE, TOWN AND STATE RIGHTS-OF-WAY.
- 11. BW (BOTTOM OF WALL) ELEVATION IS FINISH GRADE, NOT THE FOOTING. REFERENCE RETAINING WALL PLANS/DETAILS FOR DEPTH OF FOOTING.
- 12. ANY DISTURBANCE WITHIN THE FORESTED "NO LAND DISTURBANCE AREA" WILL REQUIRE AN UPDA-

#### STORMWATER NOTES

- 1. ALL STORM DRAINAGE PIPES SHOWN ARE TO BE CLASS III REINFORCED CONCRETE (RCP) UNLESS NOTED OTHERWIS
- 2. ALL STORM DRAINAGE CONSTRUCTION SHALL BE IN ACCORDANCE WITH THE TOWN OF CHAPEL HILL AND NCDOT
- 3. ALL CONCRETE SHALL MEET A MINIMUM 3000 PSI COMPRESSIVE STRENGTH.
- 4. ALL PIPE IN STORM DRAIN STRUCTURES SHALL BE STRUCK EVEN WITH INSIDE WALL.
- 5. ALL PIPE JOINTS SHALL BE MADE WITH PREFORMED JOINT SEALER, WHICH CONFORMS TO AASHTO SPECIFICATION M-198 FOR TYPE B FLEXIBLE PLASTIC GASKETS UNLESS OTHERWISE NOTED.
- 6. THE INTERIOR SURFACES OF ALL STORM DRAINAGE STRUCTURES SHALL BE POINTED AND SMOOTHED TO AN ACCEPTABLE STANDARD USING MORTAR MIXED TO MANUFACTURER'S SPECIFICATIONS.
- 7. ALL BACKFILL SHALL BE NON-PLASTIC IN NATURE, FREE FROM ROOTS, VEGETATION MATTER, WASTE CONSTRUCTIO MATERIAL OR OTHER OBJECTIONABLE MATERIAL. SAID MATERIAL SHALL BE CAPABLE OF BEING COMPACTED BY MECHANICAL MEANS AND SHALL HAVE NO TENDENCY TO FLOW OR BEHAVE IN A PLASTIC MANNER UNDER THE TAMPING BLOWS OR PROOF ROLLING.
- 8. MATERIALS DEEMED BY THE OWNER'S REPRESENTATIVE AS UNSUITABLE FOR BACKFILL PURPOSES SHALL BE REMOVED AND REPLACED WITH SUITABLE MATERIAL.
- 9. BACKFILLING OF TRENCHES SHALL BE ACCOMPLISHED IMMEDIATELY AFTER PIPE IS LAID. THE FILL AROUND THE PIPE SHALL BE THOROUGHLY COMPACTED TO 95% OF THE MAXIMUM DRY DENSITY OBTAINABLE WITH THE STANDARD PROCTOR TEST. THE TOP EIGHT (8) INCHES SHALL BE COMPACTED TO 100% STANDARD PROCTOR.
- 10.UNDER NO CIRCUMSTANCES SHALL WATER BE ALLOWED TO RISE IN UNBACKFILLED TRENCHES AFTER PIPE HAS BEE
- 11. RISER STRUCTURES WITH MULTIPLE BARREL SECTIONS SHALL HAVE GASKETTED JOINTS, AND EACH SECTION SHALL BE BOLTED TO ADJACENT SECTIONS WITH STAINLESS STEEL STRAPS.

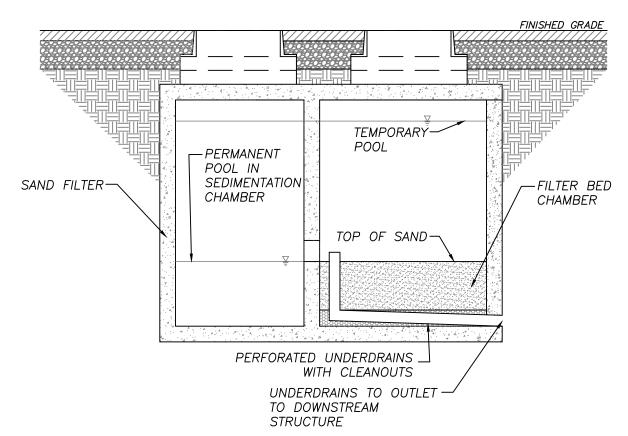

SCHEMATIC UNDERGROUND SAND FILTER

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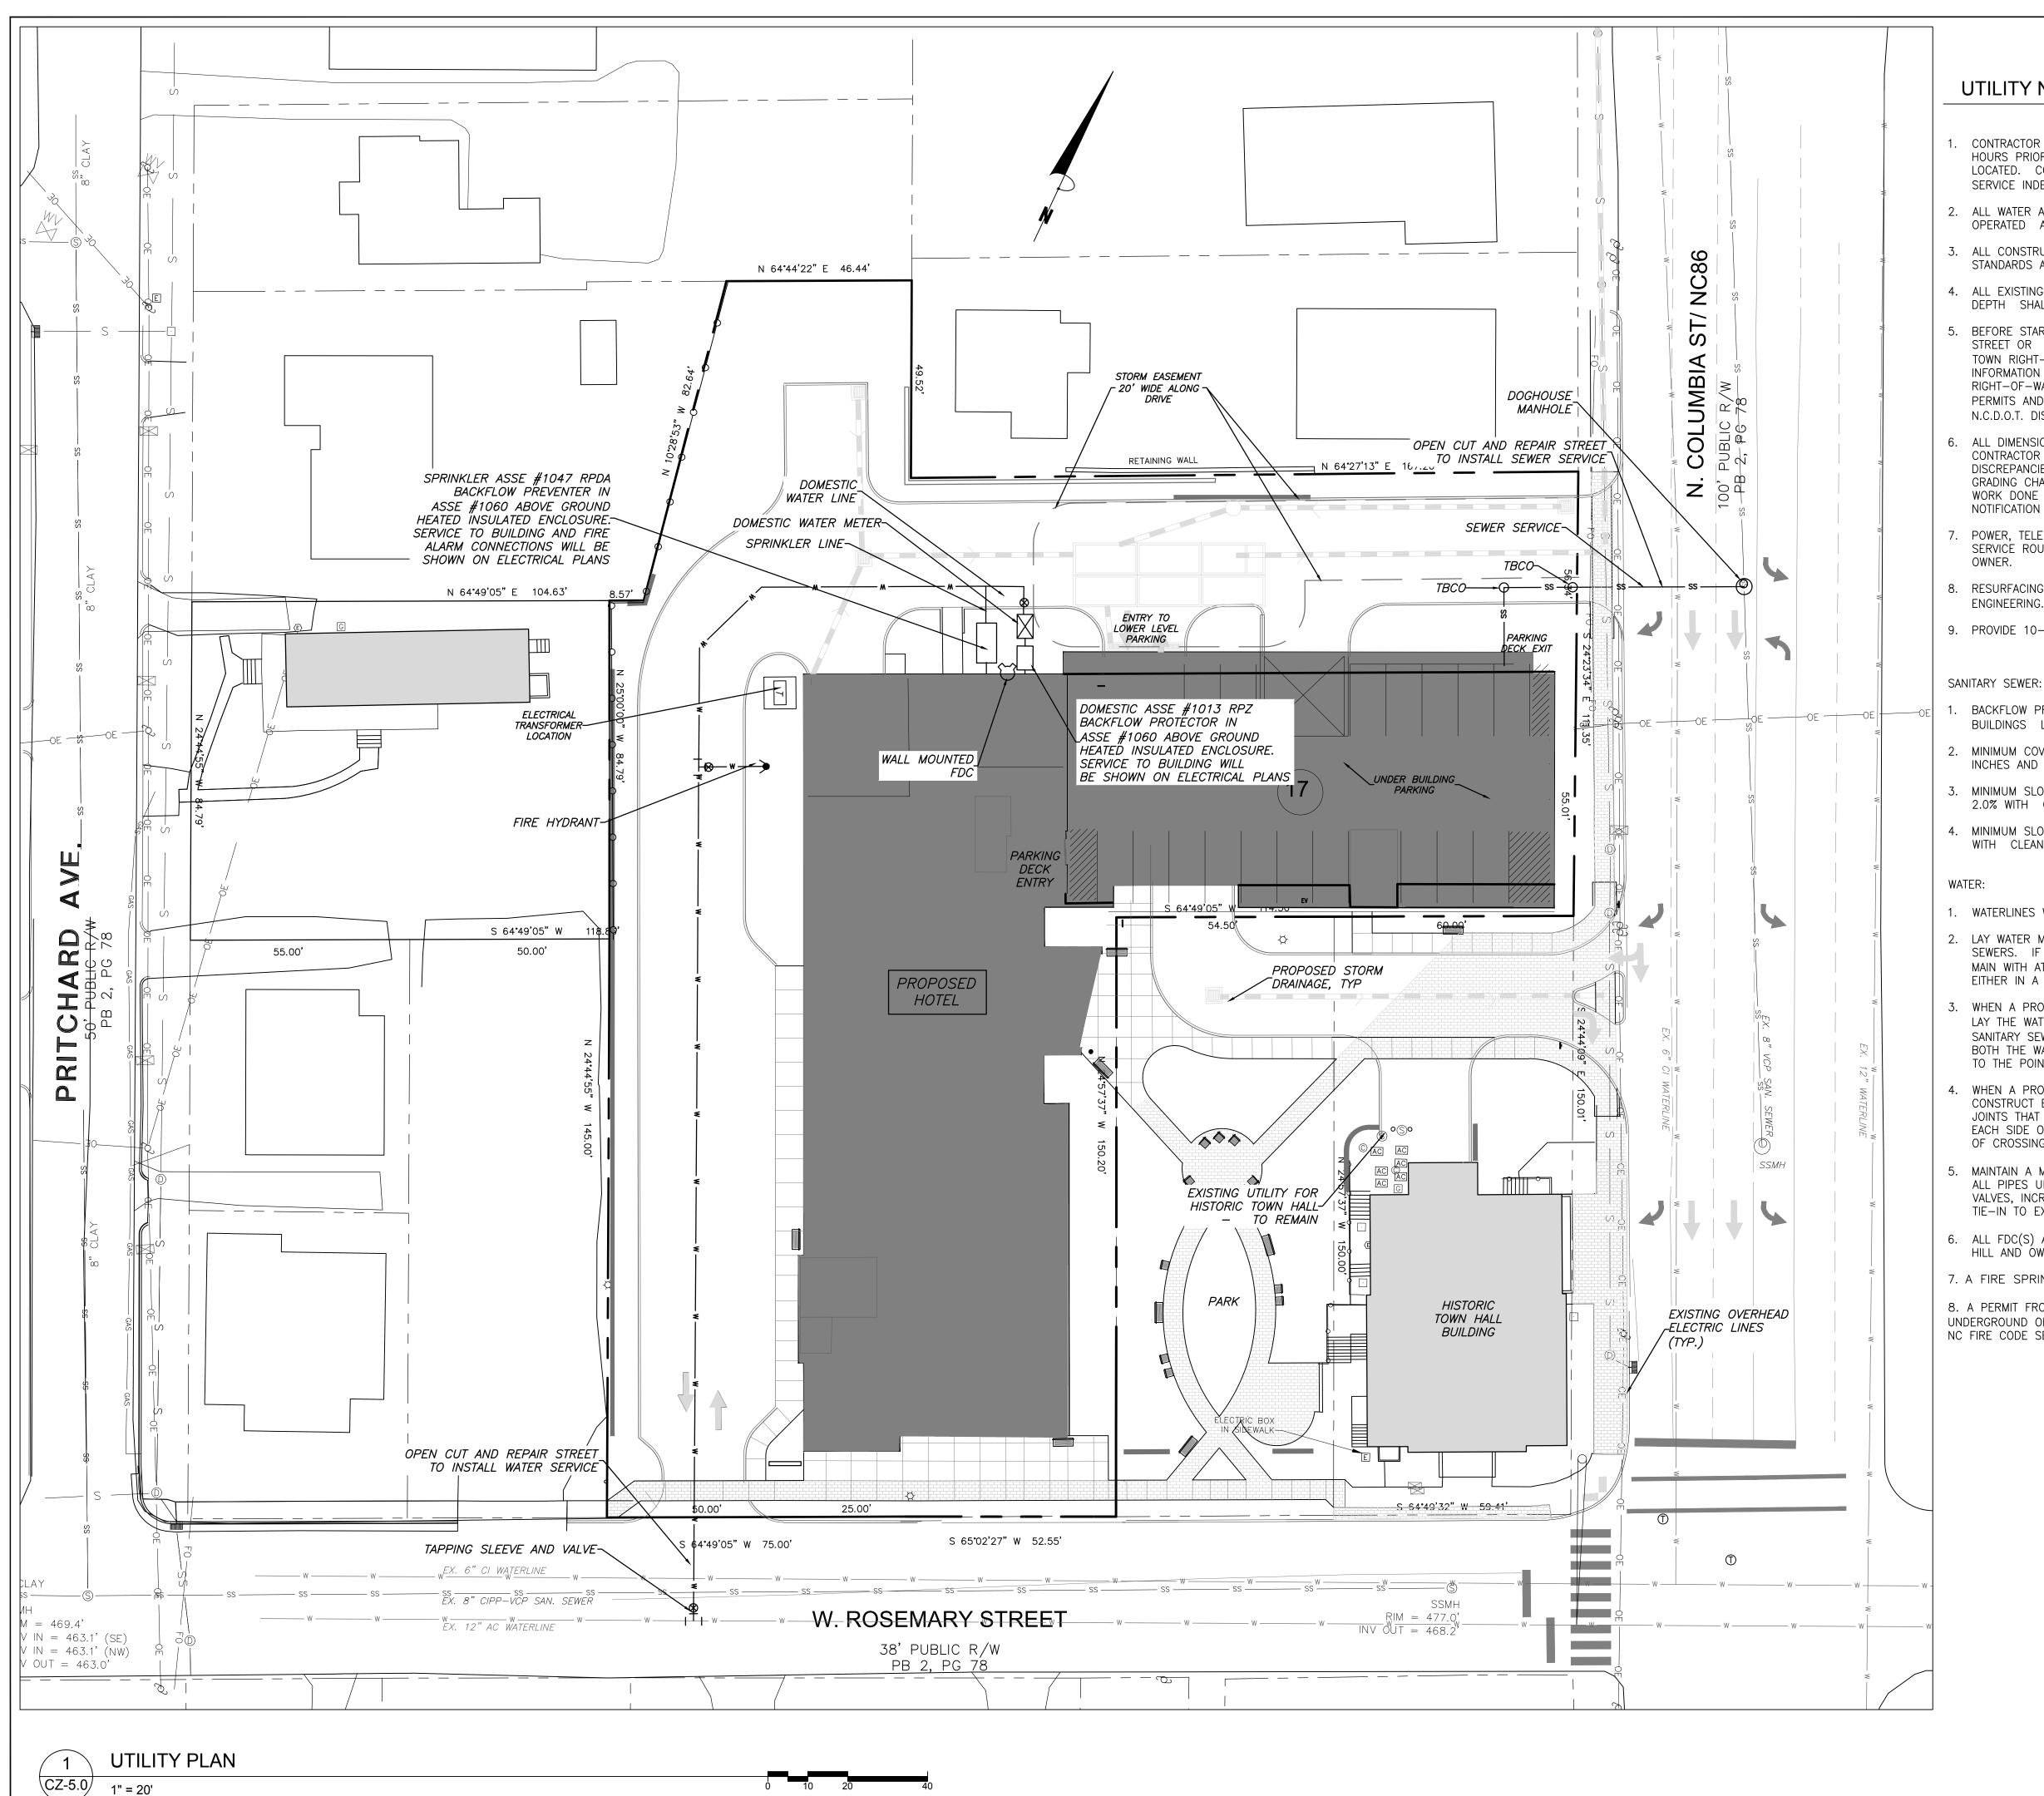
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Conditional Zoning

Sheet Title:

**GRADING AND STORMWATER PLAN** 

Sheet Number **CZ-3.0** 



#### **UTILITY NOTES**

- CONTRACTOR SHALL NOTIFY "NORTH CAROLINA ONE CALL" (1-800-632-4949) AT LEAST 48 HOURS PRIOR TO BEGINNING CONSTRUCTION OR EXCAVATION TO HAVE EXISTING UTILITIES LOCATED. CONTRACTOR TO CONTACT ANY LOCAL UTILITIES THAT PROVIDE THEIR OWN LOCATOR SERVICE INDEPENDENT OF "NORTH CAROLINA ONE CALL".
- 2. ALL WATER AND SEWER MAINS WITHIN PUBLIC EASEMENTS AND RIGHT-OF-WAYS TO BE OWNED, OPERATED AND MAINTAINED BY OWASA.
- 3. ALL CONSTRUCTION SHALL BE IN ACCORDANCE WITH THE TOWN OF CHAPEL HILL AND OWASA STANDARDS AND SPECIFICATIONS.
- 4. ALL EXISTING UNDERGROUND UTILITIES ARE APPROXIMATELY LOCATED. ACTUAL LOCATION AND DEPTH SHALL BE CONFIRMED IN THE FIELD PRIOR TO CONSTRUCTION.
- BEFORE STARTING ANY CONSTRUCTION OF IMPROVEMENTS WITHIN ANY TOWN OR N.C.D.O.T. STREET OR HIGHWAY RIGHT-OF-WAY THE FOLLOWING PROCEDURES SHOULD BE UNDERTAKEN; TOWN RIGHT-OF-WAY: CONTACT LOCAL AUTHORITIES' TRAFFIC ENGINEERING DEPT. FOR INFORMATION ON DETOURS, OPEN CUTTING OF STREETS OR FOR ANY CONSTRUCTION WITHIN RIGHT-OF-WAY. N.C.D.O.T. RIGHT-OF-WAY: CONTACT PROJECT ENGINEERS AND OBTAIN ALL PERMITS AND ENCROACHMENTS (KEEP COPIES ON CONSTRUCTION SITE, ALSO CONTACT N.C.D.O.T. DISTRICT OFFICE 24 HOURS IN ADVANCE BEFORE PLACING CURB AND GUTTER).
- 6. ALL DIMENSIONS AND GRADES SHOWN ON THE PLANS SHALL BE FIELD VERIFIED BY THE CONTRACTOR PRIOR TO CONSTRUCTION. CONTRACTOR SHALL NOTIFY THE OWNER IF ANY DISCREPANCIES EXIST. PRIOR TO PROCEEDING WITH CONSTRUCTION FOR NECESSARY PLAN OR GRADING CHANGES. NO EXTRA COMPENSATION SHALL BE PAID TO THE CONTRACTOR FOR ANY WORK DONE DUE TO DIMENSIONS OR GRADES SHOWN INCORRECTLY ON THESE PLANS IF SUCH NOTIFICATION HAS NOT BEEN GIVEN.
- POWER, TELEPHONE, AND GAS SERVICES TO BUILDINGS SHALL BE UNDERGROUND. ACCESS AND SERVICE ROUTES TO BE COORDINATED WITH THE PUBLIC UTILITIES, CONTRACTOR AND THE
- 8. RESURFACING OF STREET DUE TO UTILITY CUTS SHALL BE REQUIRED AT THE DIRECTION OF ENGINEERING. (MINIMUM 50' TO EITHER SIDE OF UTILITY CUTS).
- 9. PROVIDE 10-FT OF HORIZONTAL SEPARATION BETWEEN PROPOSED NEW WATER AND SEWER MAINS

- BACKFLOW PREVENTORS SHALL BE PROVIDED FOR ALL UNITS WITH FINAL FLOOR ELEVATIONS OF BUILDINGS LESS THAN 1'-0" ABOVE UPSTREAM MANHOLE.
- MINIMUM COVER OF 5 FEET IN TRAFFIC AREAS TO BE PROVIDED FOR ALL COLLECTOR LINES 4 INCHES AND LARGER. IF LESS THAN 5 FEET, DUCTILE IRON PIPE SHALL BE REQUIRED.
- MINIMUM SLOPE FOR 4 INCH SANITARY SEWER COLLECTION LINES SHALL BE NO LESS THAN 2.0% WITH CLEANOUTS EVERY 75 LINEAL FEET.
- 4. MINIMUM SLOPE FOR 6 INCH SANITARY SEWER COLLECTION LINES SHALL BE NO LESS THAN 1.0% WITH CLEANOUTS EVERY 75 LINEAL FEET.
- 1. WATERLINES WILL BE 3' OFF CURB AND GUTTER UNLESS SHOWN OTHERWISE.
- 2. LAY WATER MAINS AT LEAST 10 FEET LATERALLY FROM EXISTING OR PROPOSED SANITARY SEWERS. IF LOCAL CONDITIONS OR BARRIERS PREVENT A 10 FOOT SEPARATION, LAY THE WATER MAIN WITH AT LEAST 18" VERTICAL SEPARATION ABOVE THE TOP OF THE SANITARY SEWER PIPE EITHER IN A SEPARATE TRENCH OR IN THE SAME TRENCH ON A BENCH OF UNDISTURBED EARTH.
- WHEN A PROPOSED WATER MAIN CROSSES OVER A PROPOSED OR EXISTING SANITARY SEWER. LAY THE WATER MAIN WITH AT LEAST 18" VERTICAL SEPARATION ABOVE THE TOP OF THE SANITARY SEWER. IF LOCAL CONDITIONS PREVENT AN 18" VERTICAL SEPARATION, CONSTRUCT BOTH THE WATER MAIN AND THE SANITARY SEWER FOR A DISTANCE OF 10 FEET ON EACH SIDE TO THE POINT OF CROSSING WITH FERROUS PIPE HAVING WATER MAIN QUALITY JOINTS.
- WHEN A PROPOSED WATER MAIN CROSSES UNDER A PROPOSED OR EXISTING SANITARY SEWER, CONSTRUCT BOTH THE WATER MAIN AND THE SANITARY SEWER OF FERROUS MATERIALS WITH JOINTS THAT ARE EQUIVALENT TO WATER MAIN STANDARDS FOR A DISTANCE OF 10 FEET ON EACH SIDE OF THE POINT OF CROSSING. CENTER THE SECTION OF WATER PIPE AT THE POINT
- MAINTAIN A MINIMUM COVER OF 36" AND MAXIMUM COVER OF 42" BELOW FINISHED GRADE OVER ALL PIPES UNLESS OTHERWISE DIRECTED OR SHOWN ON THE PLANS. DUE TO THE HEIGHTS OF VALVES, INCREASE THE COVER DEPTHS ADJACENT TO THE VALVES OR VARIED AT POINTS OF TIE-IN TO EXISTING LINES.
- 6. ALL FDC(S) AND HYDRANT(S) SHALL BE SIAMESE CONNECTIONS AND MEET TOWN OF CHAPEL HILL AND OWASA STANDARDS.
- 7. A FIRE SPRINKLER SYSTEM WILL BE REQUIRED FOR THE HOTEL.
- 8. A PERMIT FROM THE CHAPEL HILL FIRE MARSHAL'S OFFICE IS REQUIRED TO INSTALL ANY NEW UNDERGROUND OR ABOVE-GROUND TANKS THAT CONTAINED FLAMMABLE/COMBUSTIBLE LIQUIDS. 2018 NC FIRE CODE SECTION 105.6.17.



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LIC # C-104

Project:

#### *Rosemary/ Columbia* Hotel

110 W. Rosemary St.

Orange County, North Carolina

9788-37-0680 9788-37-0549 9788-27-9667 9788-27-9700 9788-37-0721

9788-37-0647

PRELIMINARY-DO NOT USE FOR CONSTRUCTION

Job Number: 1963

Drawn WLR, MTC Checked WLR, PBR Date 9-24-2020 Revisions TOWN REVIEW REVISIONS


> TOWN REVIEW REVISIONS 4-28-2021 FINAL CZ REVISIONS 9-15-2021 COUNCIL REVISIONS

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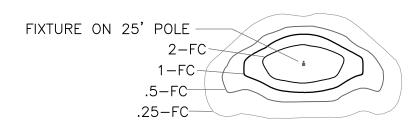
Conditional Zoning Sheet Title:

> UTILITY **PLAN**

Sheet Number **CZ-5.0** 

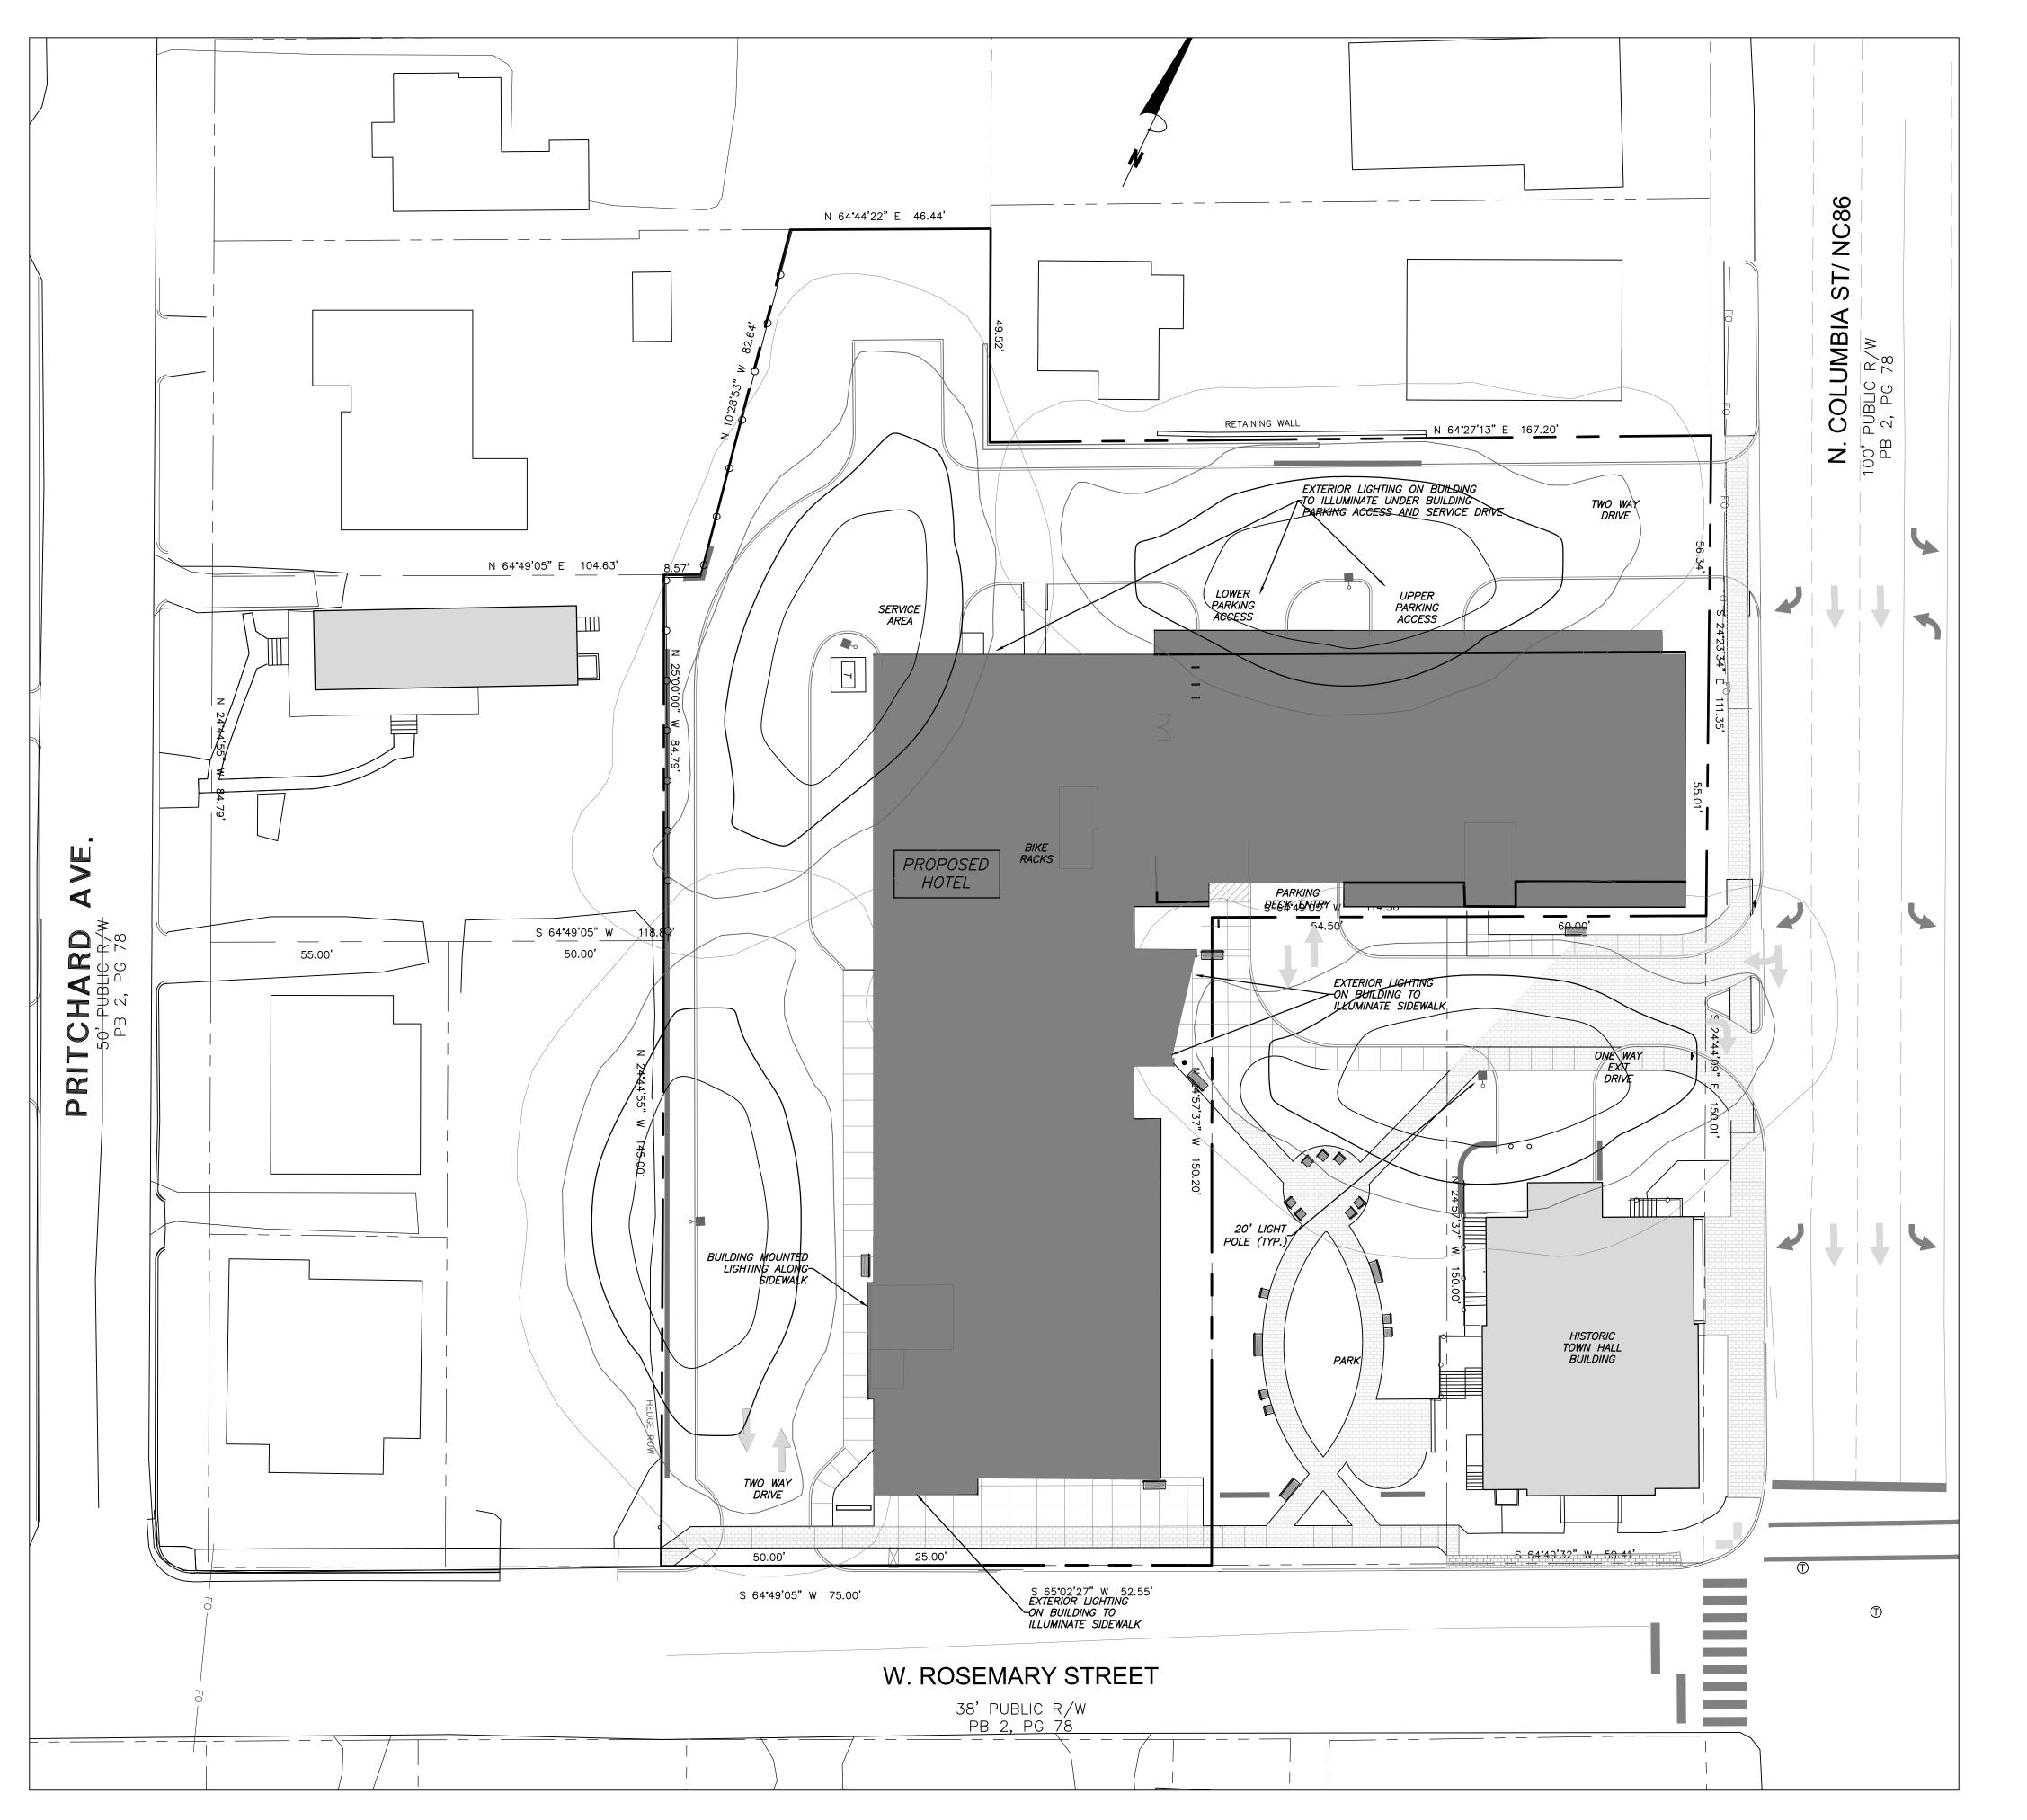

LEGEND



#### LIGHTING NOTES

#### LIGHTING CONDUIT

LIGHTING CONDUIT SHALL MEET THE FOLLOWING GUIDELINES.

- CONDUIT DESIGN MUST BE APPROVED BY DUKE ENERGY PRIOR TO INSTALLATION. CHANGING THE CONDUIT LAYOUT CAN CAUSE CONDUCTOR LENGTH TO EXCEED ACCEPTABLE VOLTAGE LEVEL WHICH WILL AFFECT THE LIGHT'S ABILITY TO OPERATE.
- 2. ALL CONDUITS ARE TO BE 2" SCHEDULE 40 GRAY ELECTRICAL PVC.
- 3. ALL JOINTS ARE TO BE GLUED.
- 4. ALL ENDS ARE TO BE MARKED WITH SCRAP CONDUIT OR A BOARD (PAINTING THE GROUND WITH MARKING PAINT IS NOT ACCEPTABLE). IT IS STRONGLY SUGGESTED THAT THE ENDS SHOULD BE IDENTIFIED BY GPS COORDINATES.
- 5. ALL ENDS ARE TO BE CAPPED TO PREVENT ENTRY OF DEBRIS.
- 6. ALL CONDUITS MORE THAN 30' IN LENGTH SHALL HAVE A STRING INSTALLED.
- 7. TO COMPLY WITH NESC; ALL CONDUIT ARE TO BE INSTALLED AT A MINIMUM DEPTH OF 30" FROM FINISH GRADE TO TOP OF CONDUIT. CONDUITS THAT CAN NOT MEET THIS CRITERIA MUST BE INCASED IN 3" MINIMUM CONCRETE ENVELOPE. (FLOWABLE FILL IS ACCEPTABLE IN PLACE OF CONCRETE).
- 8. IF CONCRETE ENCASED CONDUIT IS REQUIRED AT ANY POINT, IT MUST BE ENCASED IN CONCRETE UNTIL PIPE IS BACK DOWN TO REQUIRED DEPTH.
- 9. PEDESTAL AREAS WHERE MULTIPLE CONDUIT ENDS TERMINATE ARE TO HAVE THE CONDUIT ENDS WITHIN 12" OF EACH OTHER.
- 10.DIRECT BURIED LIGHT POLE AREAS ARE TO HAVE CONDUITS TERMINATE 36" APART AND 12" BACK OF POLE LOCATION.
- 11.CONDUITS SERVING LIGHTS ON CONCRETE REVEALS ARE TO BE CONTINUOUS FROM REVEAL TO REVEAL.

#### LIGHTING NOTES

- 1. MEASURES SHALL BE PROVIDED TO PREVENT LIGHT SPILLOVER ONTO ADJACENT PROPERTIES AND GLARE TOWARD MOTOR VEHICLE OPERATORS. EXTERIOR LIGHTS SHALL BE SHIELDED SO THEY DO NOT CAST DIRECT LIGHT BEYOND THE PROPERTY LINE.
- 2. PROVIDE 2" PVC CONDUIT UNDER PAVEMENT, UNDER HEAVILY LANDSCAPED AREAS AS NECESSARY, AND AS DETERMINED BY DUKE ENERGY TO PROVIDE ACCESS TO ALL LIGHT FIXTURES. COORDINATE WITH DUKE ENERGY TO FINALIZE CONDUIT LOCATIONS AND LENGTHS.

#### SPECIAL COORDINATION NOTES:

- 1. CONTRACTOR IS TO COORDINATE LIGHT POLE AND CONDUIT LOCATIONS WITH DUKE ENERGY PRIOR TO INSTALLATION OF WALLS AND PAVING.
- 2. ABOVE GROUND PEDESTALS AND LIGHT POLES WILL BE PROVIDED AND INSTALLED BY DUKE
- 3. CONTRACTOR IS TO REFER TO DUKE ENERGY SPECIFICATIONS FOR CONDUIT INSTALLATION.
- 4. CONDUIT IS TO BE FURNISHED AND INSTALLED BY CONTRACTOR.



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NC BOARD OF EXAMINERS FOR ENGINEERS AND SURVEYORS LIC # C-1209

NC BOARD OF LANDSCAPE ARCHITECTS LIC # C-104

Project:

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Conditional Zoning

Sheet Title:


LIGHTING PLAN


Sheet Number **CZ-6.0** 

1 LIGHTING PLAN

CZ-6.0 1" = 20'

0 10 20 40

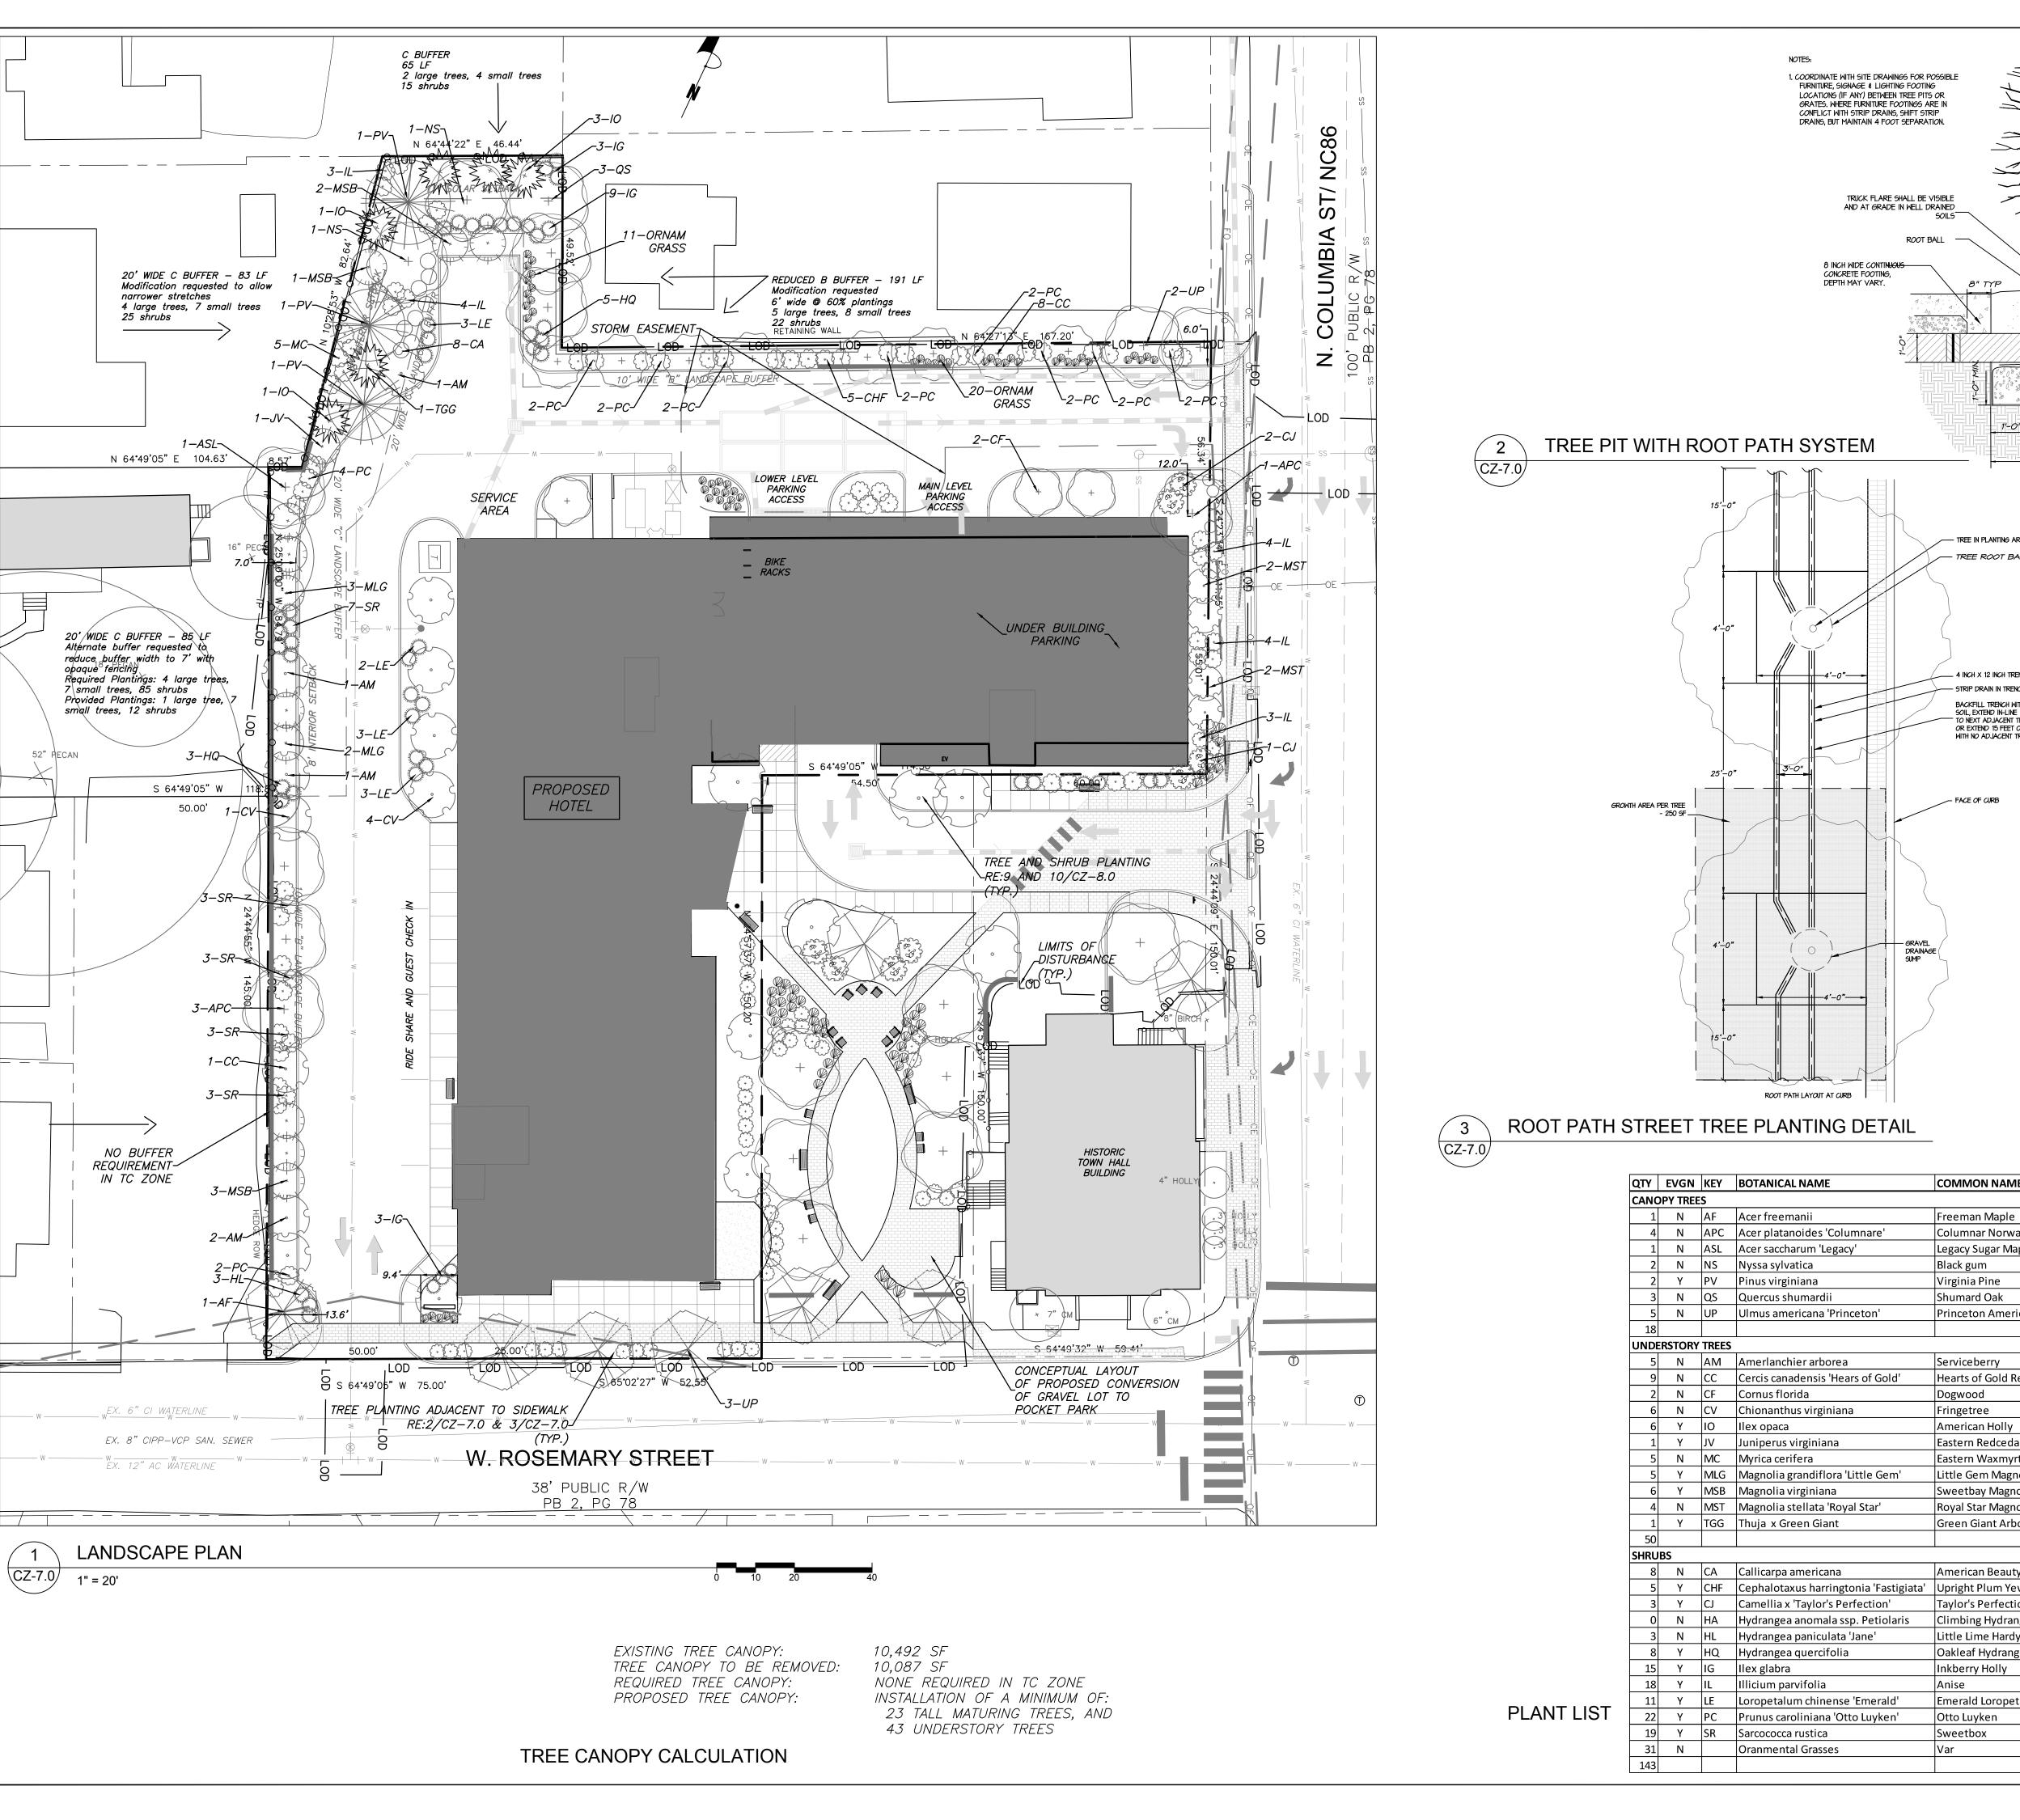

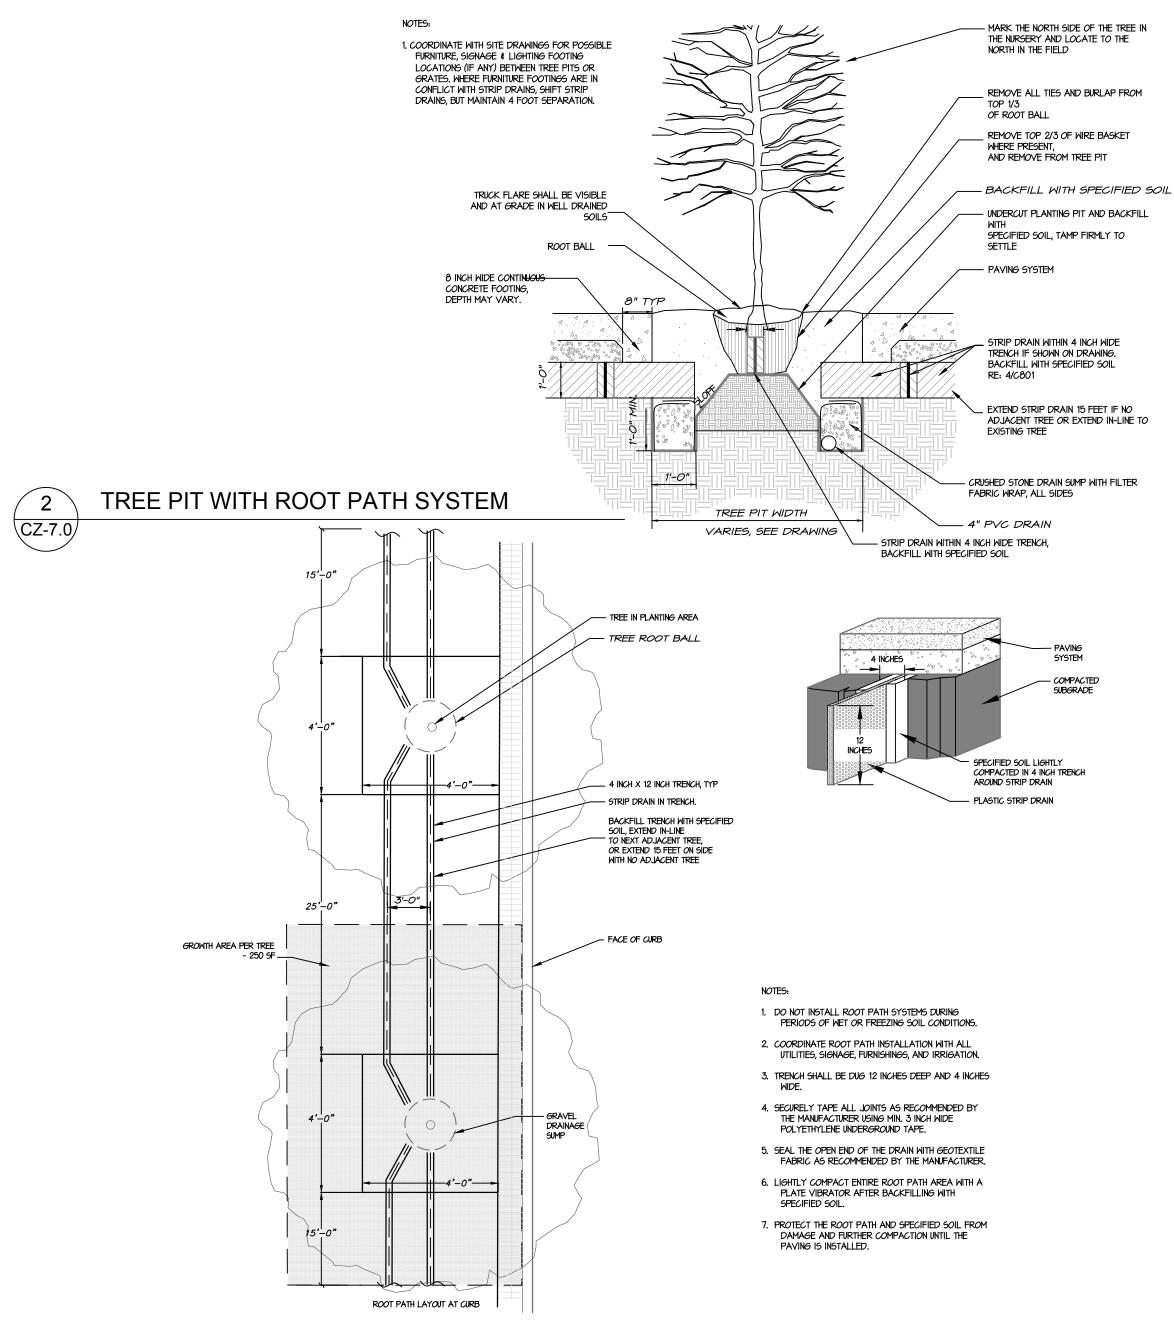

COMMON NAME SIZE SPACING REMARKS 14' ht. AS SHOWN SINGLE TRUNK & LEADER 2.5" CAL. SINGLE TRUNK & LEADER Columnar Norway Maple 2.5" CAL. SINGLE TRUNK & LEADER Legacy Sugar Maple 2.5" CAL. AS SHOWN SINGLE TRUNK & LEADER 2.5" CAL AS SHOWN AS SHOWN SINGLE TRUNK & LEADER 2" cal. 12' ht. 2.5" CAL. 12' ht. AS SHOWN SINGLE TRUNK & LEADER SINGLE TRUNK & LEADER 2.5" CAL. 14' ht. AS SHOWN Princeton American Elm 8' HT. AS SHOWN MULTI-TRUNK Hearts of Gold Redbud 8' HT. AS SHOWN SINGLE TRUNK & LEADER 1" cal. 8' HT. AS SHOWN AS SHOWN 8' HT. 1" cal. 6' HT. 8' O.C. SINGLE TRUNK & LEADER 1" cal. FULL AND MATCHING Eastern Redcedar 8' HT. AS SHOWN 8' HT. AS SHOWN Eastern Waxmyrtle 10' O.C. FULL AND MATCHING Little Gem Magnolia 1.5" cal. 1.5" cal. AS SHOWN Sweetbay Magnolia Royal Star Magnolia 1.5" cal. Green Giant Arborvitae 24" ht. FULL AND MATCHING American Beautyberry 5 Y CHF Cephalotaxus harringtonia 'Fastigiata' Upright Plum Yew AS SHOWN FULL AND MATCHING Taylor's Perfection Camellia 24" ht FULL AND MATCHING 5' o.c. Climbing Hydrangea AS SHOWN Little Lime Hardy Hydrangea 24" 4' o.c. FULL AND MATCHING Oakleaf Hydrangea 5' o.c. FULL AND MATCHING FULL AND MATCHING 15" HT. 36" O.C. 24" ht 4' o.c. FULL AND MATCHING 15" HT. 36" O.C. FULL AND MATCHING Emerald Loropetalum

18" HT.

18" HT.

36" O.C.

36" O.C.

30" O.C.

FULL AND MATCHING

FULL AND MATCHING

FULL AND MATCHING

111 West Main Street

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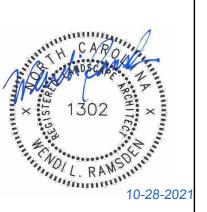
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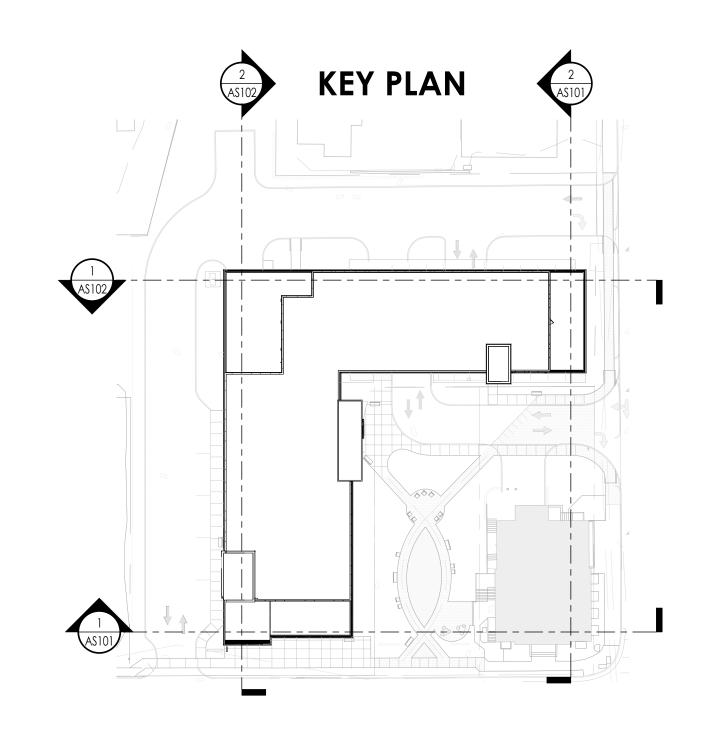
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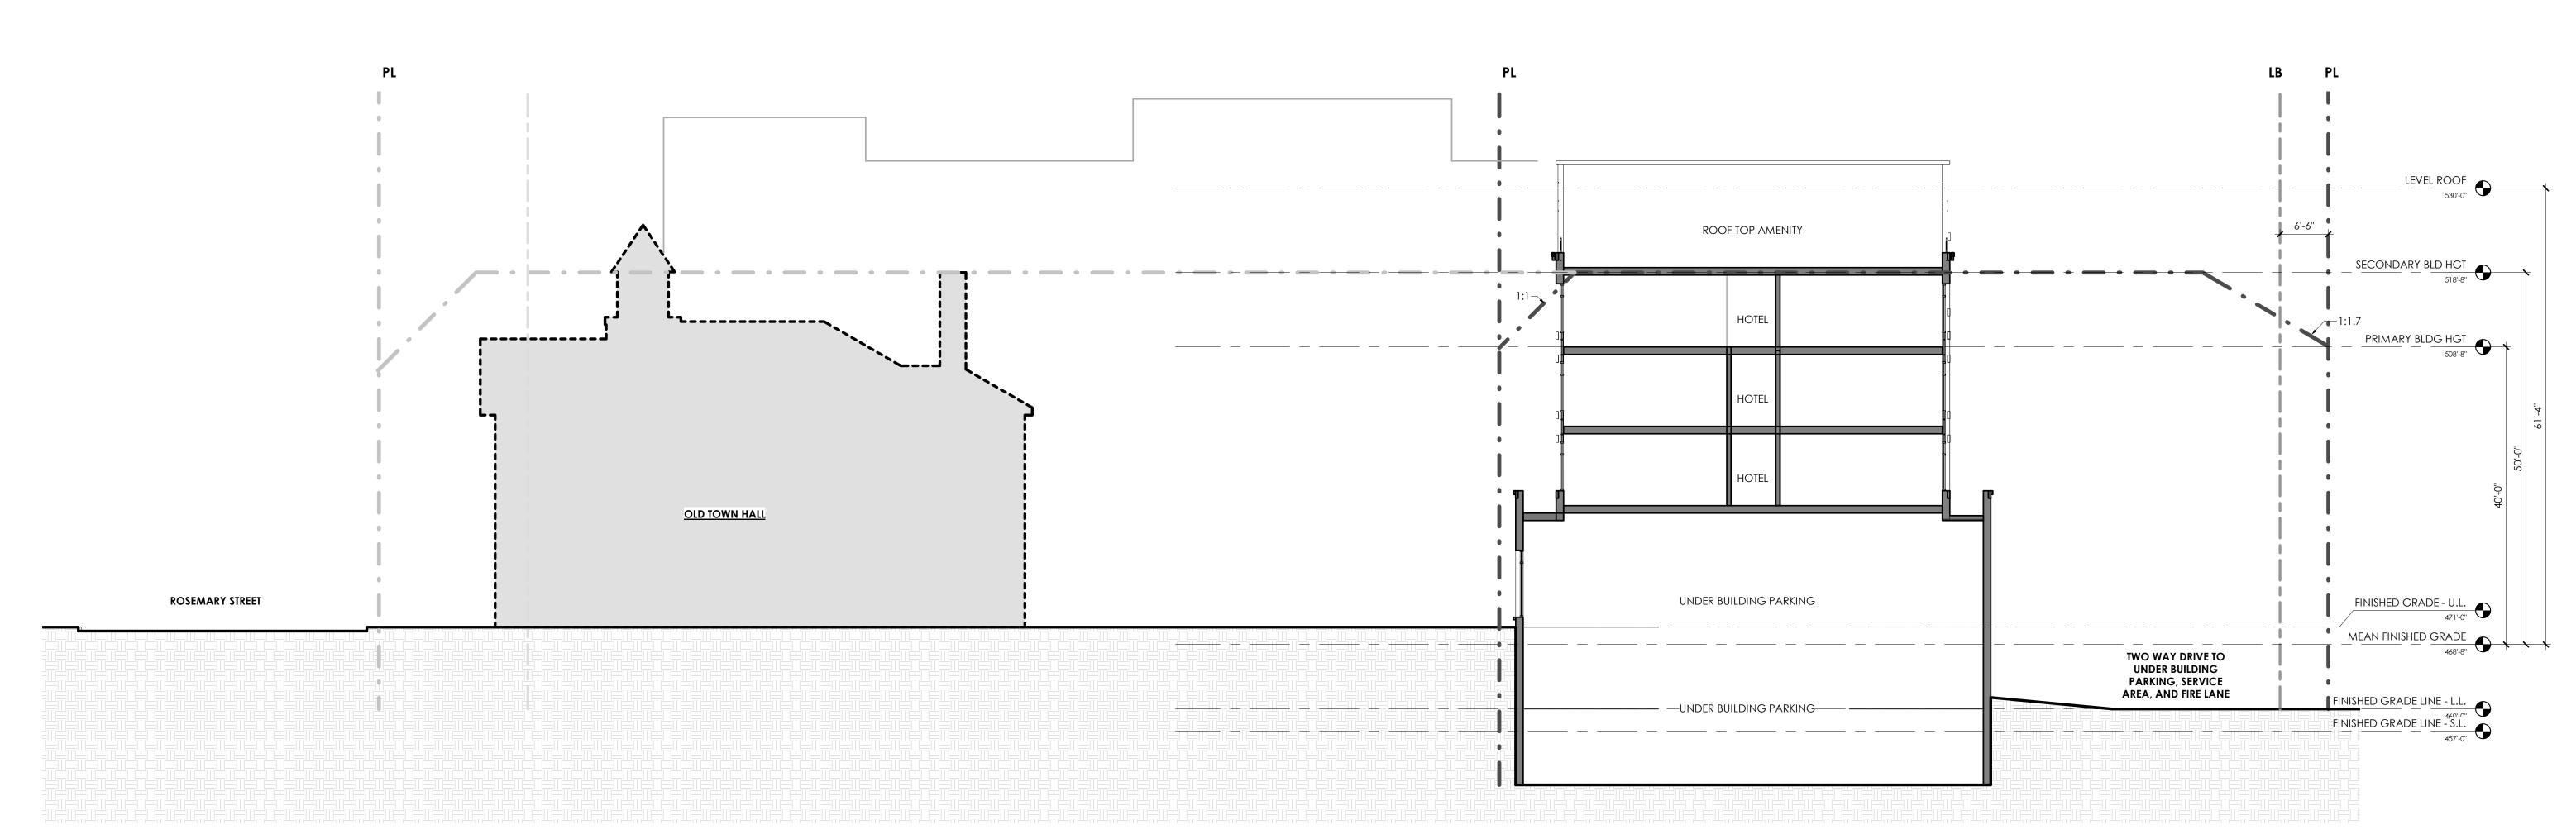
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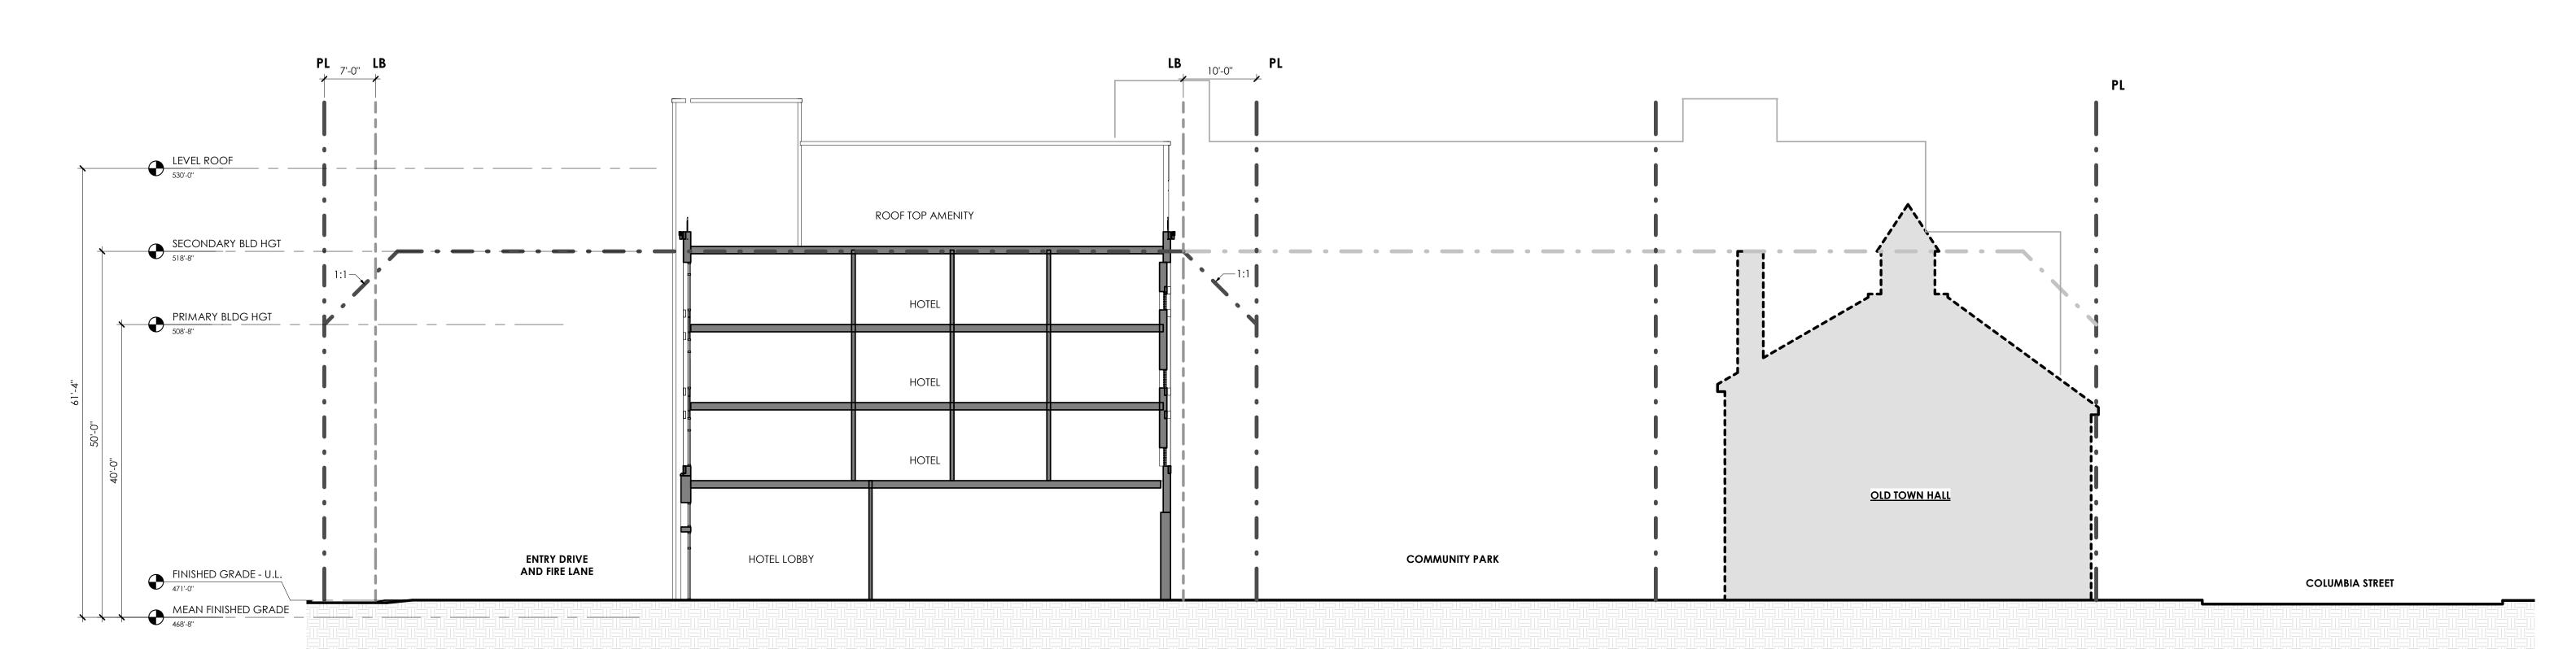
LANDSCAPE **PLAN** 

Sheet Number **CZ-7.0** 





EAST ELEVATION - COLUMBIA WING
3/32" = 1'-0"
2





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-DURHAM -GREENVILLE -PITTSBORO -ASHEVILLE

## ROSEMARY / COLUMBIA HOTEL

#### GENERAL NOTE:

IN TC2 WITHIN NCD THE PRIMARY HEIGHT IS 40' ABOVE MEAN FINISH GRADE WITH A SECONDARY HEIGHT OF 50' EXCEPT WHERE ADJACENT TO "R" ZONING WHERE THE PRIMARY BUILDING HEIGHT IS 30'.

THIS PROJECT PROPOSES TO BE WITHIN THE REQUIRED SOLAR OVERLAY OTHER THAN THE 5TH FLOOR AND PORTIONS OF THE 4TH FLOOR AS ILLUSTRATED BELOW.

#### **WEST ROSEMARY STREET DESIGN GUIDELINES**

THE PROJECT PROPOSES TO MEET THE GUIDELINES OF THE WEST ROSEMARY STREET DEVELOPMENT GUIDE IN THE FOLLOWING MANNER:

- PUBLIC REALM: PROVIDING SUFFICIENT SPACE FOR PEDESTRIANS ALONG ROSEMARY ST. PROVIDING IMPROVED AND CONTINUOUS SIDEWALKS ALONG ROSEMARY ST. EXISTING ROSEMARY ST LIGHTING IS ALREADY IN PLACE. ADDITIONAL LIGHTING WILL BE PROVIDED ON THE BUILDING FACADE TO CREATE A SAFE AND WELCOMING PEDESTRIAN
- LANDSCAPE BUFFER, 10' PEDESTRIAN ZONE, AND 5' SUPPLEMENTAL ZONE. PROJECT
- PROPOSES SUBSTANTIAL COMPLIANCE WITH THIS RECOMMENDATION OTHER THAN A PORTION OF THE BUILDING WHICH ENCROACHES INTO THE 5' SUPPLEMENTAL ZONE. ALL OPERATIONS DELIVERIES AND LOADING AREAS WILL BE MANAGED VIA BACK OF HOUSE PROGRAM.
- THE PROJECT PROPOSES TO REDUCE THE NUMBER OF EXISTING CURB CUTS.

PARKING IS PROPOSED TO BE STRUCTURED AND WILL BE SCREENED TO MINIMIZE VISIBILITY FROM THE PUBLIC RIGHT OF WAY.

#### BUILDING DESIGN:

EXPERIENCE.

ALL BUILDING ENTRIES ARE PROVIDED OFF OF PUBLIC STREETS OR PUBLIC AREAS. PEDESTRIAN SCALE SIGNAGE AND AMENITIES WILL BE CONSIDERED AND ENCOURAGED. VERTICAL BAYS, VARIETY IN THE UPPER CORNICE HEIGHTS AND VISUAL BREAKS IN THE

FACADE WILL BE CONSIDERED. WHERE POSSIBLE, UTILITY SERVICES WILL BE LOCATED BELOW GROUND OR IN THE REAR OF THE SITE TO MINIMIZE VISIBILITY FROM THE PUBLIC RIGHT OF WAY. THE PROJECT PROPOSES DEFINING AND ENCOURAGING PEDESTRIAN ACTIVITY ALONG THE

GROUND FLOOR OF THE BUILDING. 5. THE PROJECT PROPOSES TO ACCENTUATE VISIBLE CORNERS TO CELEBRATE KEY BUILDING ALL GLAZING AT GROUND LEVEL RETAIL, SERVICE, AND TRADE USES THAT FACE A PUBLIC

SPACE WILL HAVE CLEAR GLASS ON AT LEAST 60% OF THEIR FACADE BETWEEN 3 FEET AND 8 FEET ABOVE GRADE. THE USE OF CANOPIES WILL BE UTILIZED NEAR RETAIL SPACES.

PERPENDICULAR SIGNAGE AND PLANTERS AND OR LANDSCAPING WILL BE USED ALONG PUBLIC SPACES THAT ARE NEAR RETAIL. 0. THE USE OF DIFFERENT PAVING TYPES WILL BE UTILIZED TO DELINIATE PUBLIC VS SEMI-PRIVATE SPACES.

. GROUND LEVEL GLAZING AROUND PUBLIC SPACES WITH BE CLEAR OR SPANDREL. 2. ALTHOUGH THE PROJECT DOES PROPOSE TO EXCEED THE HEIGHT LIMITS OUTLINED IN THE GUIDELINES AND THE ORDINANCE, THE BUILDING DOES NOT EXTEND TO THE SETBACK LINE WHERE ADJACENT TO A RESIDENTIAL USE. THIS ALLOWS FOR THE PROJECT TO MEET AND EXCEED THE REQUIRED LANDSCAPE BUFFERS ADJACENT TO RESIDENTIAL USE. THE PROJECT ALSO PROPOSES TO ELIMINATE THE NW CORNER OF THE TOP FLOOR TO ASSIST IN MINIMIZING MASSING ADJACENT TO RESIDENTIAL USES.

3. THE PROJECT PROPOSES TO MEET ALL BUFFERS NOTED IN THE GUIDELINES AND REQUIRED BY ORDINANCE OTHER THAN THE NORTH BUFFER WHERE THE PROPERTY IS ADJACENT TO A LAW OFFICE ZONED OI-1. BASED ON PAST EXPERIENCE WITH PROJECTS IN TOWN AND UPON EXAMINATION OF SIMILAR DOWNTOWN (URBAN) CONDITIONS, THE PROJECT CONTENDS THAT AN ALTERNATE BUFFER AT THIS LOCATION SHOULD BE CONSIDERED AS TWO COMMERCIAL PROPERTIES ARE ADJACENT TO EACH OTHER. AT THIS LOCATION, POTENTIAL NUISANCES (NOISE, DUST, ODOR, GLARE OF LIGHTS) ARE MITIGATED THROUGH LANDSCAPING AND BUILDING PROGRAM ORIENTATION.

4. AT THE COLUMBIA ST FRONTAGE, THE PROJECT PROPOSES AN ALTERNATE MINIMIZED BUFFER TO THE REQUIRED 30' WIDE "D" LANDSCAPE BUFFER TO ALLOW FOR THE BUILDING TO ENGAGE THE STREETSCAPE IN A SIMILAR MANNER (ALBEIT NOT PROGRAMMED SPACE) TO WHAT IS BEING PROVIDED ON ROSEMARY ST. 5. AS ILLUSTRATED IN THE SOLAR ELEVATION STUDIES, THE PROJECT PROPOSES TO MEET ALL REQUIRED SOLAR SETBACKS DEFINED WITHIN THE GUIDELINES AND ORDINANCE OTHER THAN THE EXCEPTION OF THE BUILDING HEIGHT ENCROACHMENT OF THE  $5^{TH}$  AND PARTIAL

#### CHAPEL HILL LAND USE MANAGEMENT ORDINANCE

3.8.3 EXCEPTIONS TO SETBACK AND HEIGHT REGULATIONS.

(B)THE FOLLOWING FEATURES MAY PROJECT ABOVE THE BUILDING ENVELOPE DEFINED BY THE MAXIMUM HEIGHT LIMITATIONS AND ADDITIONAL SETBACK REQUIREMENTS CONTAINED IN RULES FOR INTERPRETATION OF TABLE 3.8-1, COLUMNS (F) AND (G), BELOW, PROVIDED THE TOWN MANAGER DETERMINES THAT SUCH FEATURES DO NOT SIGNIFICANTLY IMPAIR THE DEGREE OF SOLAR ACCESS PROVIDED ADJACENT PROPERTIES THROUGH APPLICATION OF THE APPROPRIATE SOLAR SETBACK REQUIREMENTS: (1) CHIMNEYS, ACCESSORY RADIO OR TELEVISION ANTENNAS, FLAGPOLES,

MONUMENTS, CUPOLAS, PARAPETS, DORMERS, CLOCK TOWERS OR DECORATIVE TOWERS WITH A FOOTPRINT NOT EXCEEDING TWENTY (20) PERCENT OF THE PRINCIPAL BUILDING, PROVIDED THE PROJECTION OF SUCH STRUCTURES ABOVE THE BUILDING ENVELOPE DOES NOT EXCEED FIFTEEN (15) PERCENT OF THE MAXIMUM HEIGHT LIMITATION THAT DEFINES THE PORTION OF THE BUILDING NVELOPE PENETRATED BY SUCH STRUCTURES;

#### DRAWING LEGEND

LANDSCAPE BUFFER (LB)


PROPERTY LINE (PL) & SETBACKS / SOLAR SETBACKS (DIMENSIONAL MATRIX RESTRICTIONS)


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COUNCIL REVISIONS 10/21/21

SHEET NAME: **EXTERIOR ELEVATIONS & BUILDING ENVELOPE** 

SHEET NUMBER



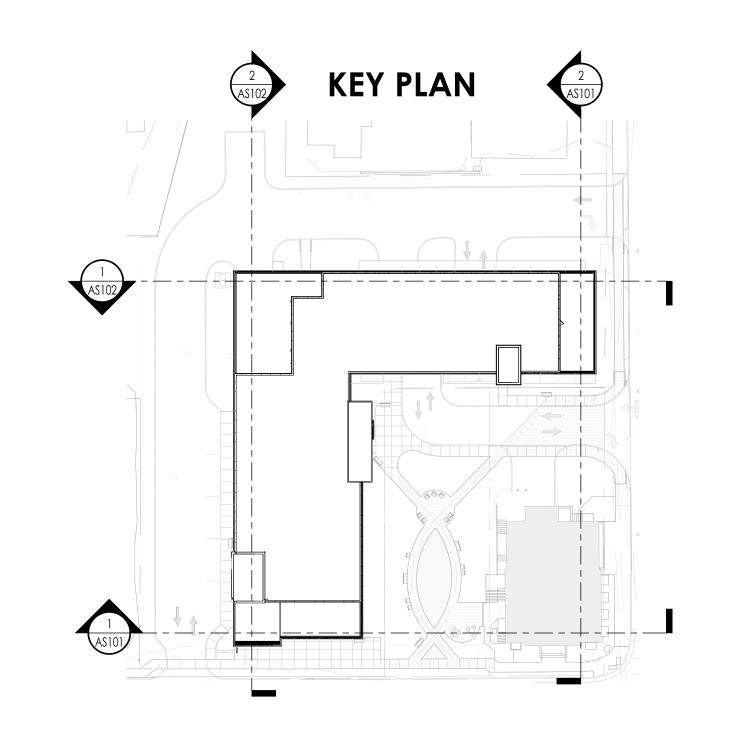

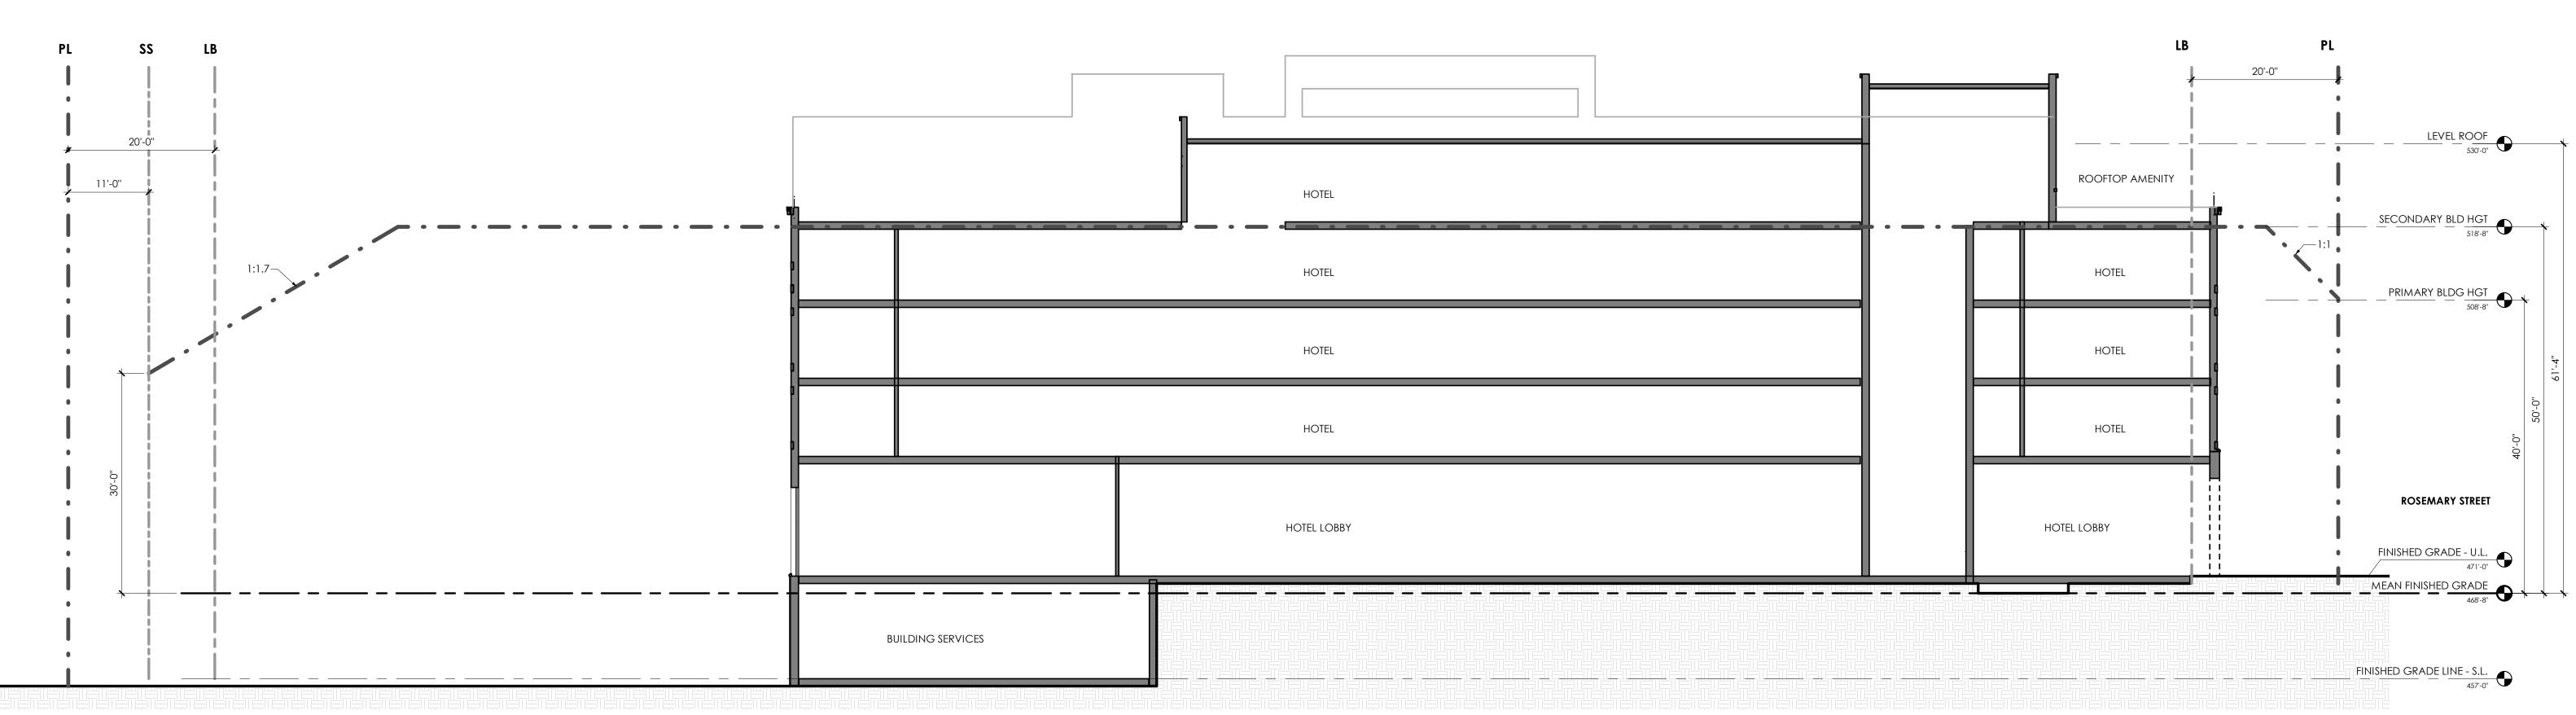**ADJACENT** PROPERTY 20'-0'' 7'-0" LEVEL ROOF
530'-0" 13'-0" ROOF TOP AMENITY HOTEL HOTEL HOTEL HOTEL HOTEL HOTEL HOTEL UNDER BUILDING PARKING HOTEL LOBBY HOTEL COLUMBIA STREET UNDER BUILDING PARKING BUILDING SERVICES BUILDING SERVICES FINISHED GRADE LINE - S.I.



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-DURHAM -GREENVILLE -PITTSBORO -ASHEVILLE

## ROSEMARY / COLUMBIA HOTEL

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#### CHAPEL HILL LAND USE MANAGEMENT ORDINANCE

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#### DRAWING LEGEND

PROPERTY LINE (PL) & SETBACKS / SOLAR SETBACKS (DIMENSIONAL MATRIX RESTRICTIONS)

LANDSCAPE BUFFER (LB)

\_\_\_\_\_

COUNCIL REVISIONS 10/21/21

SHEET NAME: **EXTERIOR ELEVATIONS & BUILDING ENVELOPE** 

SHEET NUMBER

WEST ELEVATION - ROSEMARY WING

3/32" = 1'-0"

2