CONTRACT PURCHASER / CLIENT:

Smart Olympia Carolina LLC 20600 CHAGRIN BOULEVARD, SUITE 705 Shaker Heights, OH 44122 216-533-0500 CONTACT: ED SMAL

APPLICANT / CONSULTANT:

LANDSCAPE ARCHITECT / LAND PLANNER: CJT, PA 111 WEST MAIN STREET DURHAM, NC 27701 919-682-0368 CONTACT: WENDI RAMSDEN

RESOURCE CONSERVATION NOTES

STREAM BUFFERS: THERE ARE NO MAPPED STREAMS ON SITE.

FLOODPLAIN PROTECTION:

THE SITE IS NOT IN AN AREA AFFECTED BY A MAPPED FLOODPLAIN ACCORDING TO FIRM MAP 3710978800K EFFECTIVE 11-17-17.

STEEP SLOPE PROTECTION: THERE ARE 2,173 SF OF STEEP SLOPES ON SITE - ALL ARE CONSTRUCTED (NOT NATURAL) SLOPES

WETLANDS: THERE ARE NO MAPPED WETLANDS ONSITE.

PROJECT NOTES

BOUNDARY AND TOPOGRAPHIC SURVEY PROVIDED BY BALLANTINE ASSOCIATES, PA DATED AUGUST 26, 2019

SURROUNDING SITE AND PROPERTY INFORMATION PER CHAPEL HILL GIS


TOWN OF CHAPEL HILL NOTES

- 1. A FIRE FLOW REPORT SHALL BE SUBMITTED TO THE TOWN FOR REVIEW AND APPROVAL PRIOR TO ISSUANCE OF A ZCP.
- 2. P.E. CERTIFICATION: PRIOR TO THE ISSUANCE OF A CERTIFICATE OF OCCUPANCY FOR ANY PHASE, THE APPLICANT SHALL PROVIDE A CERTIFICATION, SIGNED AND SEALED BY A NORTH CAROLINA-LICENSED PROFESSIONAL ENGINEER, THAT THE STORMWATER MANAGEMENT FACILITY IS CONSTRUCTED IN ACCORDANCE WITH THE APPROVED PLANS AND SPECIFICATIONS.
- 3. AS-BUILT PLANS: PRIOR TO THE ISSUANCE OF A CERTIFICATE OF OCCUPANCY, THE APPLICANT SHALL PROVIDE CERTIFIED AS-BUILT PLANS FOR BUILDING FOOTPRINTS, PARKING LOTS, STREET IMPROVEMENTS, STORM DRAINAGE SYSTEMS AND STORMWATER MANAGEMENT STRUCTURES, AND ALL OTHER IMPERVIOUS SURFACES, AND A TALLY OF THE CONSTRUCTED IMPERVIOUS AREA. THE AS-BUILT PLANS SHOULD BE IN DXF BINARY FORMAT USING STATE PLANE COORDINATES AND NAVD 88.

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1"=500'

LIST OF SHEETS:

CZ-0.0 COVER SHEET CZ-0.1 AREA MAP CZ-1.0 EXISTING CONDITIONS PLAN CZ-1.1 NOTES CZ-1.2 CONSTRUCTION MANAGEMENT PLAN CZ-1.3 LANDSCAPE PROTECTION PLAN CZ-2.0 SITE PLAN CZ-3.0 **GRADING & STORMWATER PLAN** CZ-5.0 UTILITY PLAN CZ-6.0 LIGHTING PLAN CZ-7.0 LANDSCAPE PLAN CZ-8.0 SITE DETAILS EXTERIOR ELEVATIONS AND BUILDING ENVELOPE AS101 AS102 EXTERIOR ELEVATIONS AND BUILDING ENVELOPE AS103 EXTERIOR ELEVATIONS AND BUILDING ENVELOPE

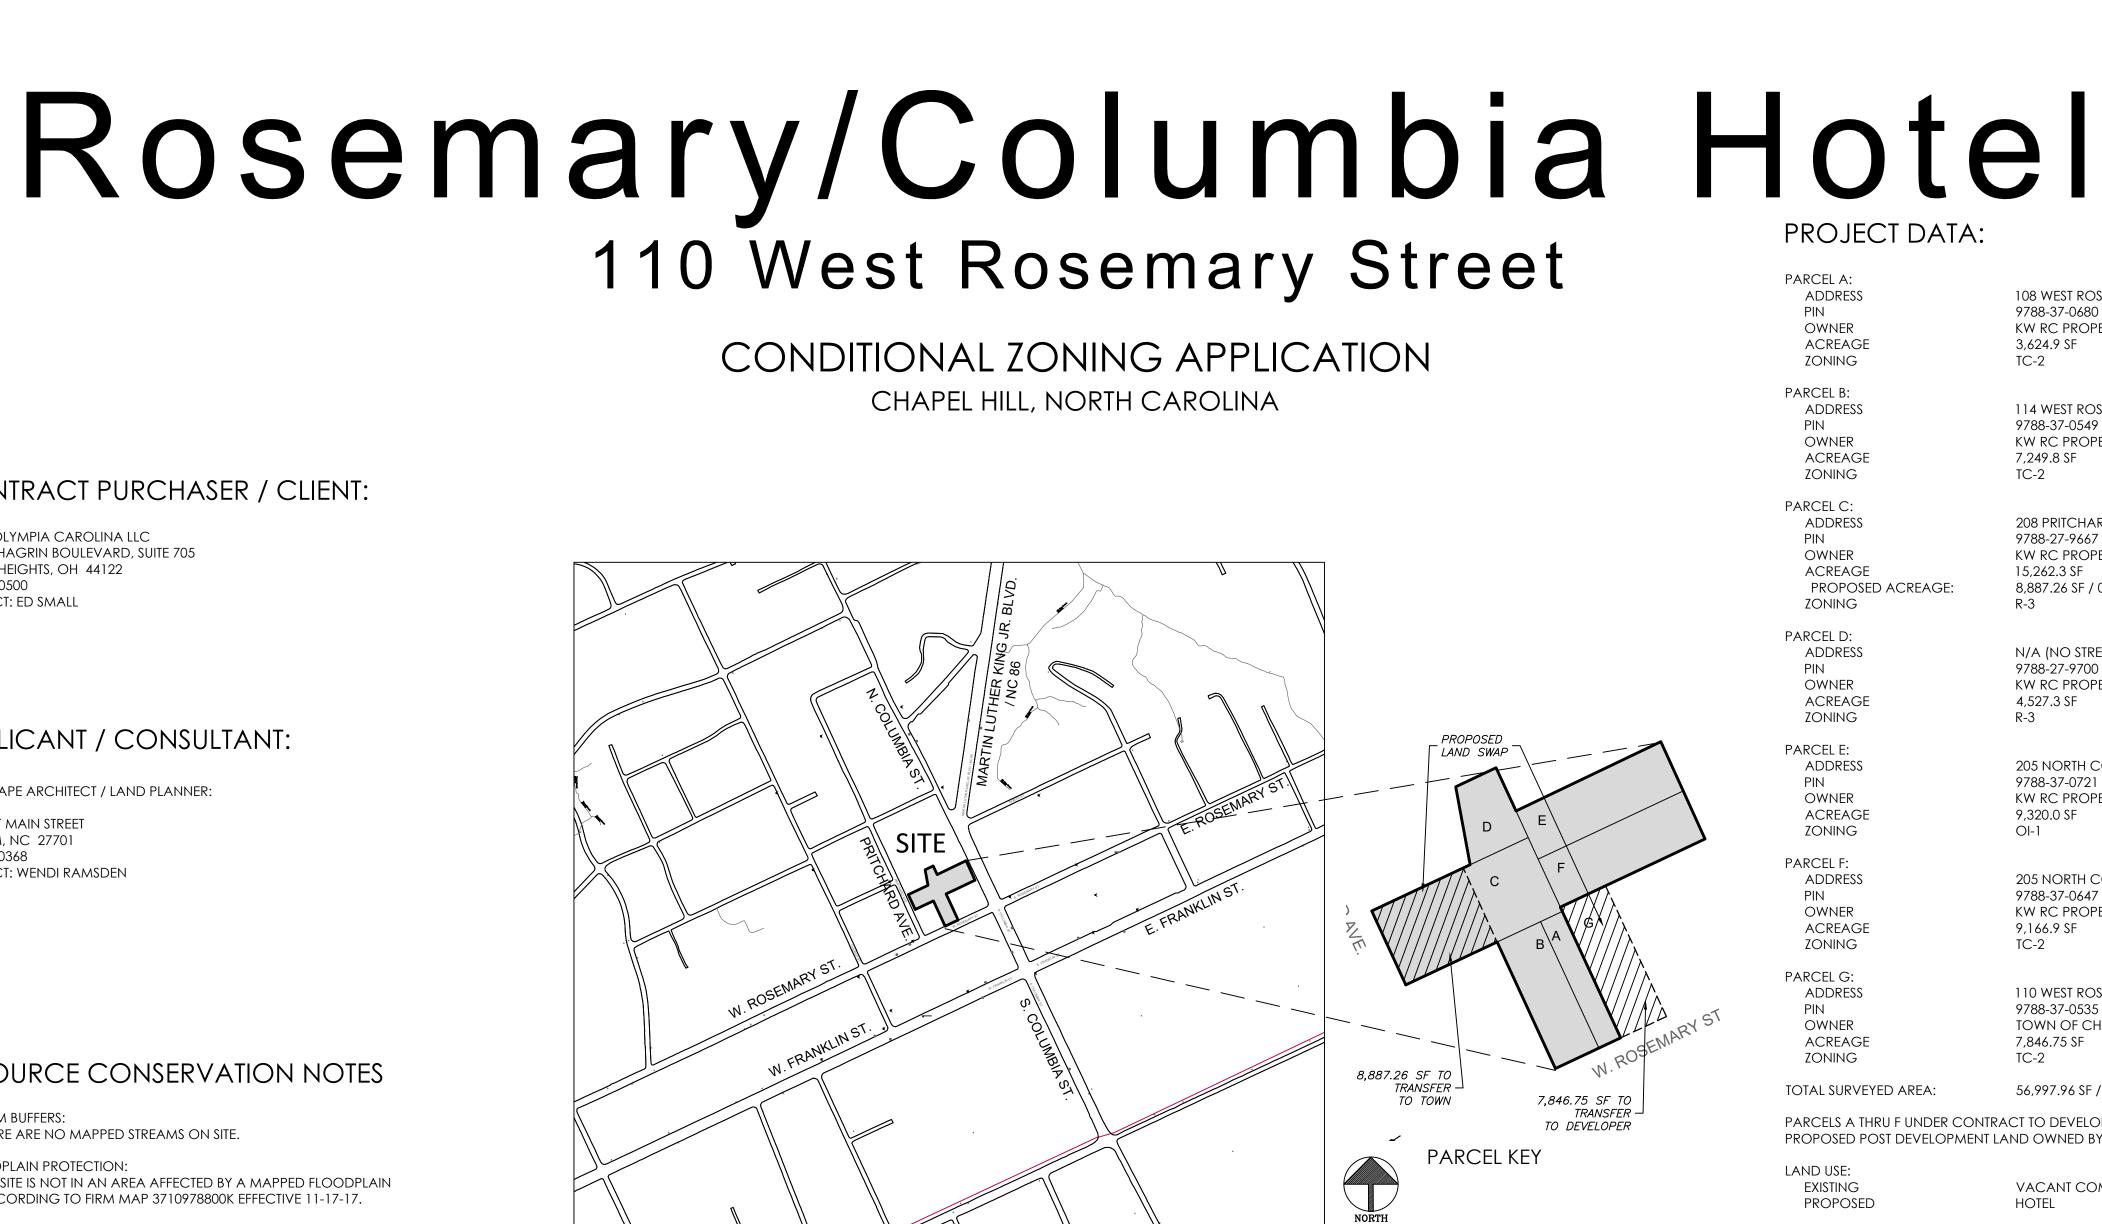PROPOSED BICYCLE PARKING: REQUIRED PROPOSED

PROJECT DATA:

ADDRESS PIN OWNER ACREAGE zoning

ADDRESS PIN OWNER ACREAGE ZONING

ADDRESS PIN OWNER ACREAGE PROPOSED ACREAGE: ZONING

ADDRESS PIN OWNER ACREAGE ZONING

ADDRESS PIN OWNER ACREAGE ZONING

PARCEL F: ADDRESS PIN OWNER ACREAGE ZONING

> ADDRESS PIN OWNER ACREAGE ZONING

TOTAL SURVEYED AREA:

PARCELS A THRU F UNDER CONTRACT TO DEVELOPER: 49,151.20

existing PROPOSED

ZONING: PROPOSED

ALLOWABLE FAR FOR PROPOSED ZONE: EXISTING BUILDINGS:

PROPOSED BUILDINGS: HOTEL

BUILDING HEIGHT:

VEHICULAR PARKING:

REQUIRED MAXIMUM

PROJECT AREA:

LOCATION

PROJECT AREA FINAL HOTEL SITE

POCKET PARK PARCEL

108 WEST ROSEMARY STREET 9788-37-0680 KW RC PROPERTIES LLC 3,624.9 SF TC-2

114 WEST ROSEMARY STREET 9788-37-0549 KW RC PROPERTIES LLC 7,249.8 SF TC-2

208 PRITCHARD AVENUE 9788-27-9667 KW RC PROPERTIES LLC 15,262.3 SF 8,887.26 SF / 0.204 AC R-3

N/A (NO STREET FRONTAGE) 9788-27-9700 KW RC PROPERTIES LLC 4,527.3 SF R-3

205 NORTH COLUMBIA STREET 9788-37-0721 KW RC PROPERTIES LLC 9,320.0 SF OI-1

205 NORTH COLUMBIA STREET 9788-37-0647 KW RC PROPERTIES LLC 9,166.9 SF TC-2

110 WEST ROSEMARY STREET 9788-37-0535 TOWN OF CHAPEL HILL 7,846.75 SF TC-2

56,997.96 SF / 1.31 AC

HOTEL

PROPOSED POST DEVELOPMENT LAND OWNED BY PROJECT DEVELOPER: 48,110.70 SF / 1.10 AC

OI REZONE TO TC-2 - CZD R-3 REZONE TO TC-2 - CZD

VACANT COMMERCIAL, CONVERTED RESIDENCES, ONE SINGLE FAMILY RESIDENTIAL

1.97 MAX.

- 1,250 SF ONE STORY BRICK BUILDING TO BE REMOVED - 1,689 SF TWO STORY WOOD FRAME HOUSE TO BE REMOVED 2,939 SF TOTAL SQUARE FOOTAGE TO BE REMOVED

1,800 SF BUILDING TO REMAIN, TO BE DEEDED TO TOWN (LOCATED ON PARCEL C)

+/- 25,300 SF FOOTPRINT (+/- 88,000 SF TOTAL) 125-140 ROOMS 5 STORIES PLUS LOWER LEVEL ACCESSED FROM NORTH DRIVEWAY

N/A (TOWN CENTER DISTRICT) 126 (0.9 PER LODGING UNIT - 140 X 0.9 = 126) APPROX 70 SPACES ON-SITE


9 (1 PER 15 LODGING UNITS 140 / 15 = 9) 10 SPACES (5 LOOPS) 4 LOOPS IN PROTECTED PARKING DECK, 1 LOOP AT LOBBY ENTRY

74,134 SF / 1.70 AC INCLUDES TOWN LAND TO BE DEVELOPED

TOTAL AREA DISTURBANCE PRE-DEV IMPERVIOUS POST-DEV IMPERVIOUS NET AREA

	74,134 SF	62,350 SF	50,164 SF	53,727 SF
	48,111 SF	47,440 SF	26,114 SF	39,249 SF
L	8,180 SF	7,966 SF	5,184 SF	5,054 SF

 In the second second
<pre>Project: Rosemary/ Columbia Hotel</pre>
110 W. Rosemary St. Orange County, North Carolina
PIN: 9788-37-0680 9788-37-0549 9788-27-9667 9788-27-9700 9788-37-0721 9788-37-0647
× 1302 Triver × 15 1302 Triver + NO/L. RAMSOC
PRELIMINARY-DO NOT USE FOR CONSTRUCTION
Job Number: ¹⁹⁶³
Drawn WLR, MTC Checked WLR
Date 9-24-2020 Revisions TOWN REVIEW REVISIONS 3-3-2021 TOWN REVIEW REVISIONS
4-28-2021
Conditional Zoning
Sheet Title:
COVER SHEET
Sheet Number
CZ-0.0

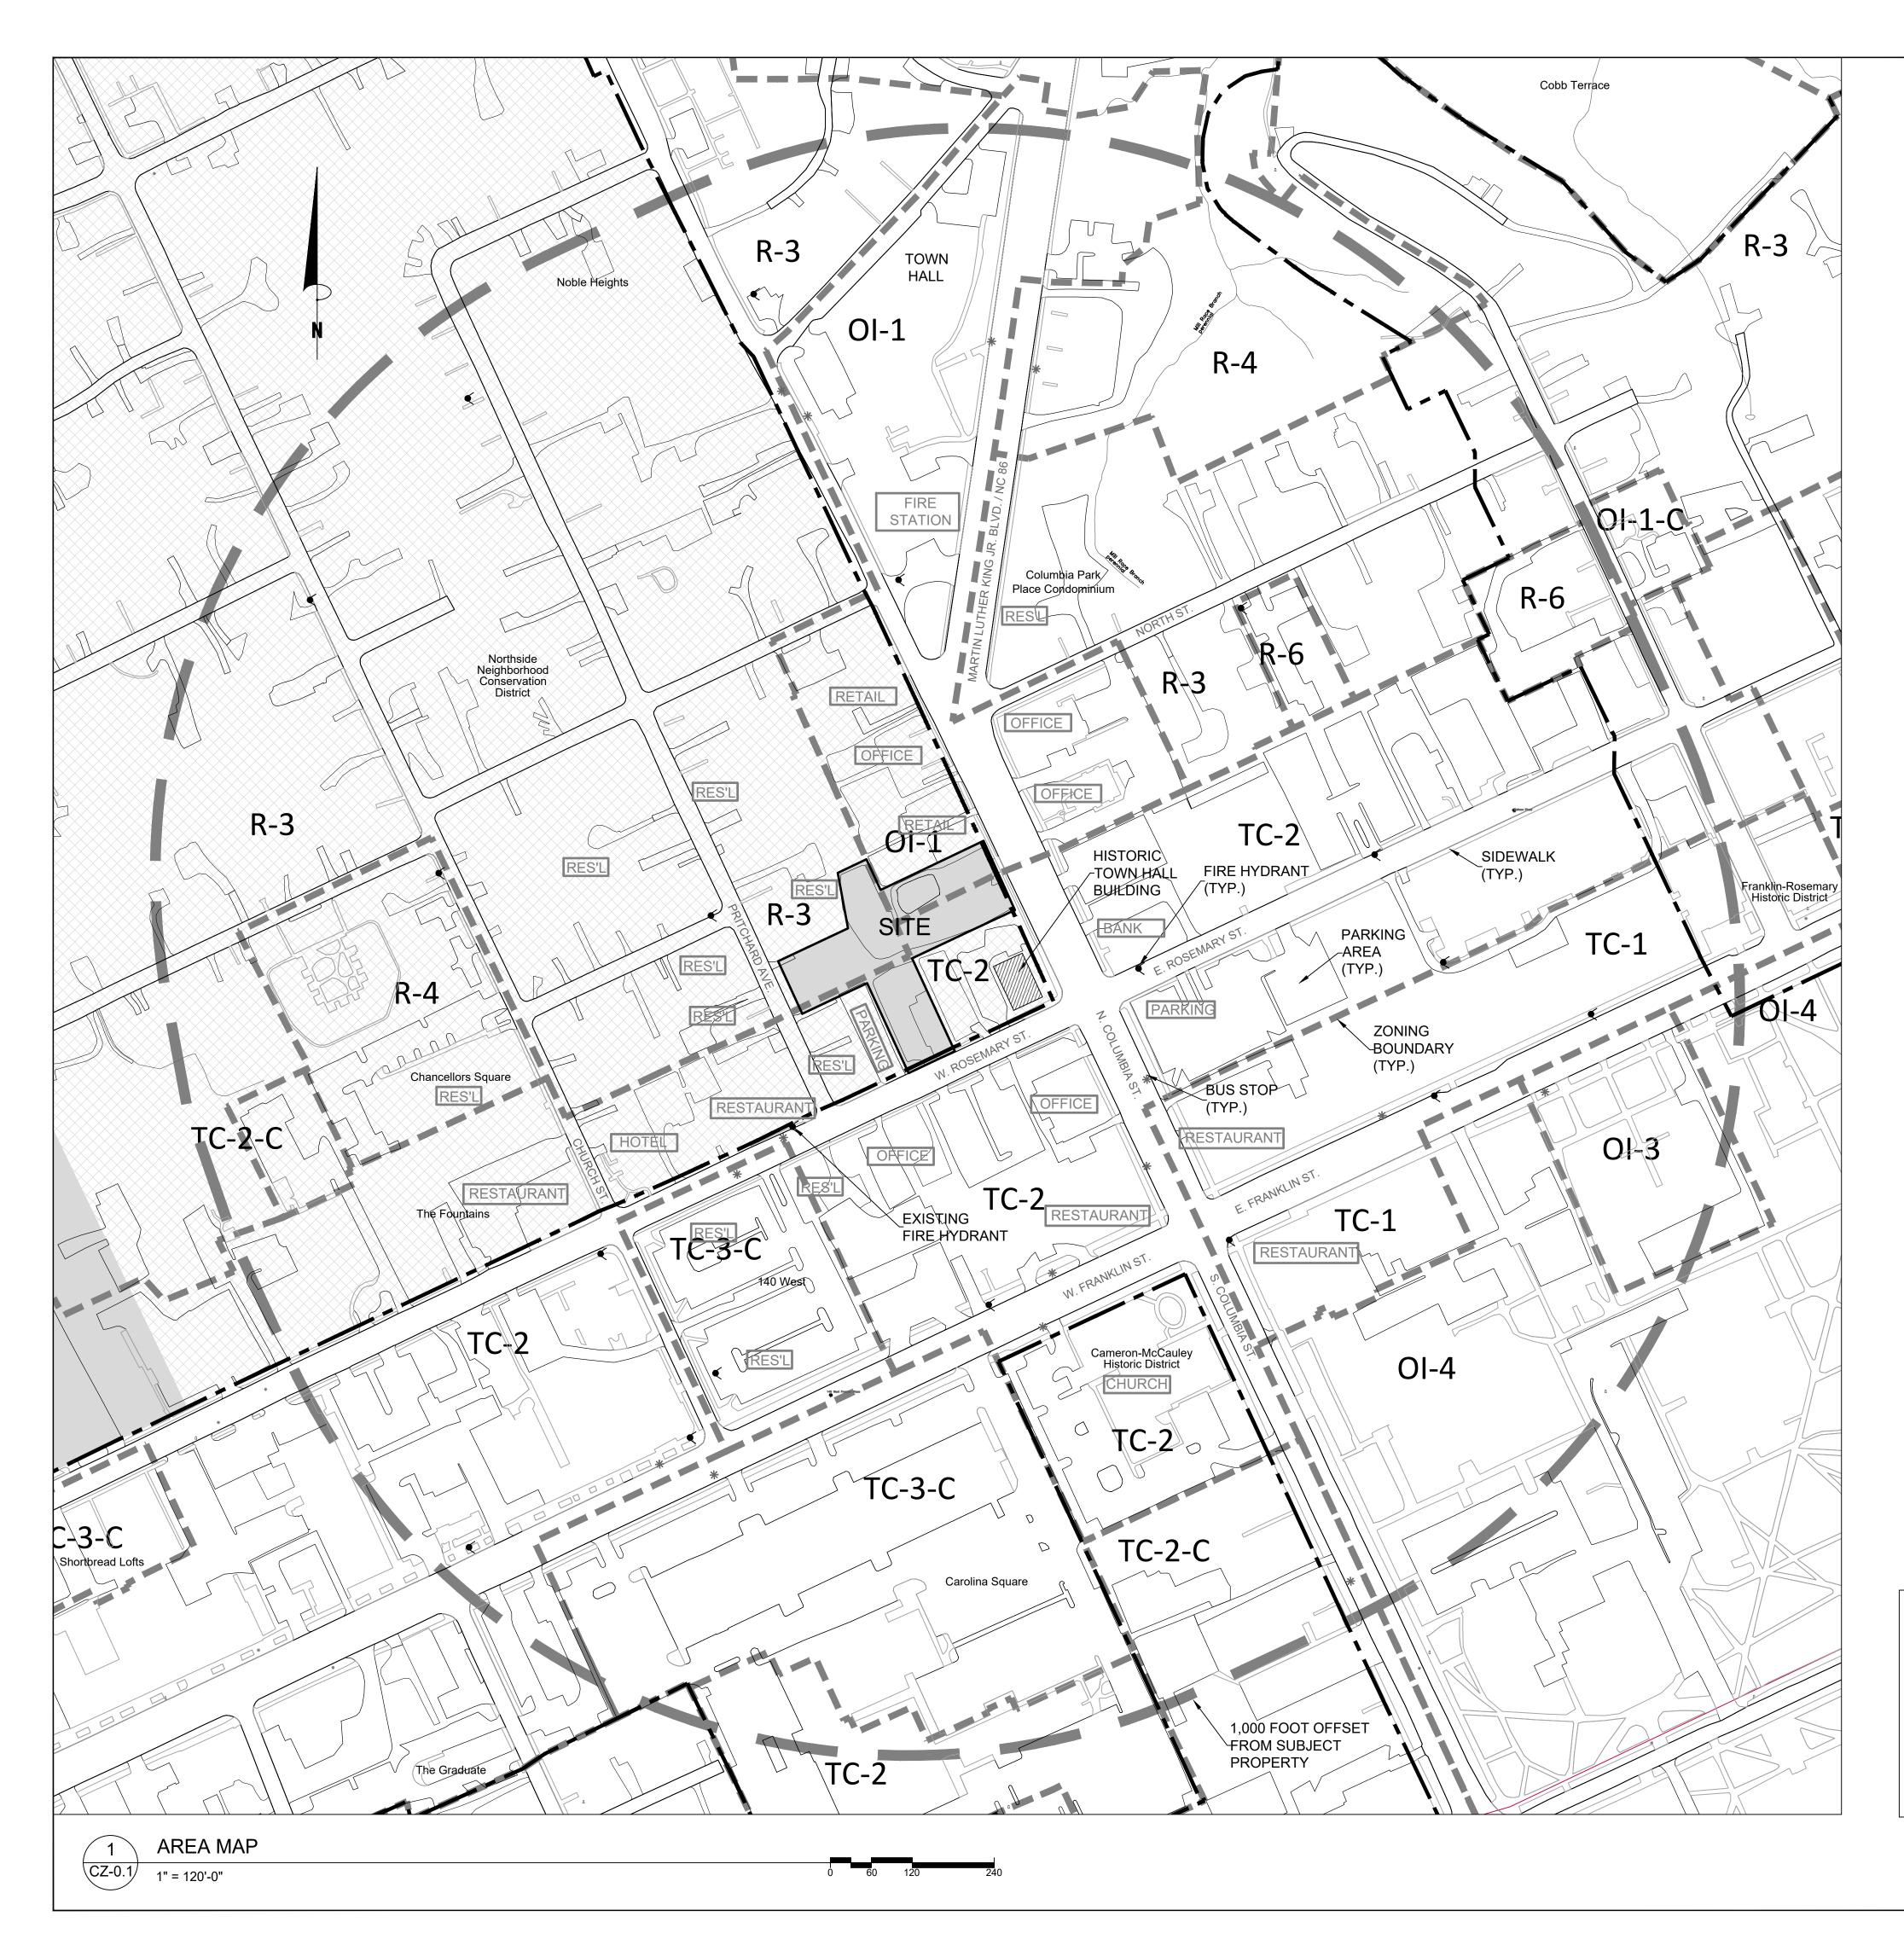


<u>LEGEND</u>

LAND USE

 NC BOARD OF EXAMINERS FOR ENGINEERS AND SURVEYORS LIC # C-104 NC BOARD OF LANDSCAPE ARCHITECTS LIC # C-104 	
Project:	
Rosemary/ Columbia Hotel 110 W. Rosemary St. Orange County, North Carolina	
PIN: 9788-37-0680 9788-37-0549 9788-27-9667 9788-27-9700 9788-37-0721 9788-37-0647	
× 1302 × ++++++++++++++++++++++++++++++++++++	
PRELIMINARY-DO NOT USE FOR CONSTRUCTION Job Number: 1963 Drawn WLR, MTC Checked WLR Date 9-24-2020 Revisions TOWN REVIEW REVISIONS 3-3-2021 TOWN REVIEW REVISIONS 4-28-2021	
Conditional Zoning Sheet Title: AREA MAP Sheet Number CZ-0.1	

FIRE HYDRANT	$\mathbf{\hat{\mathbf{A}}}$
ZONING BOUNDARY	
EXISTING ZONING	OI-4
NCD BOUNDARY NORTHSIDE NEIGHBORHOOD	
LAND USE	COMM [*] L

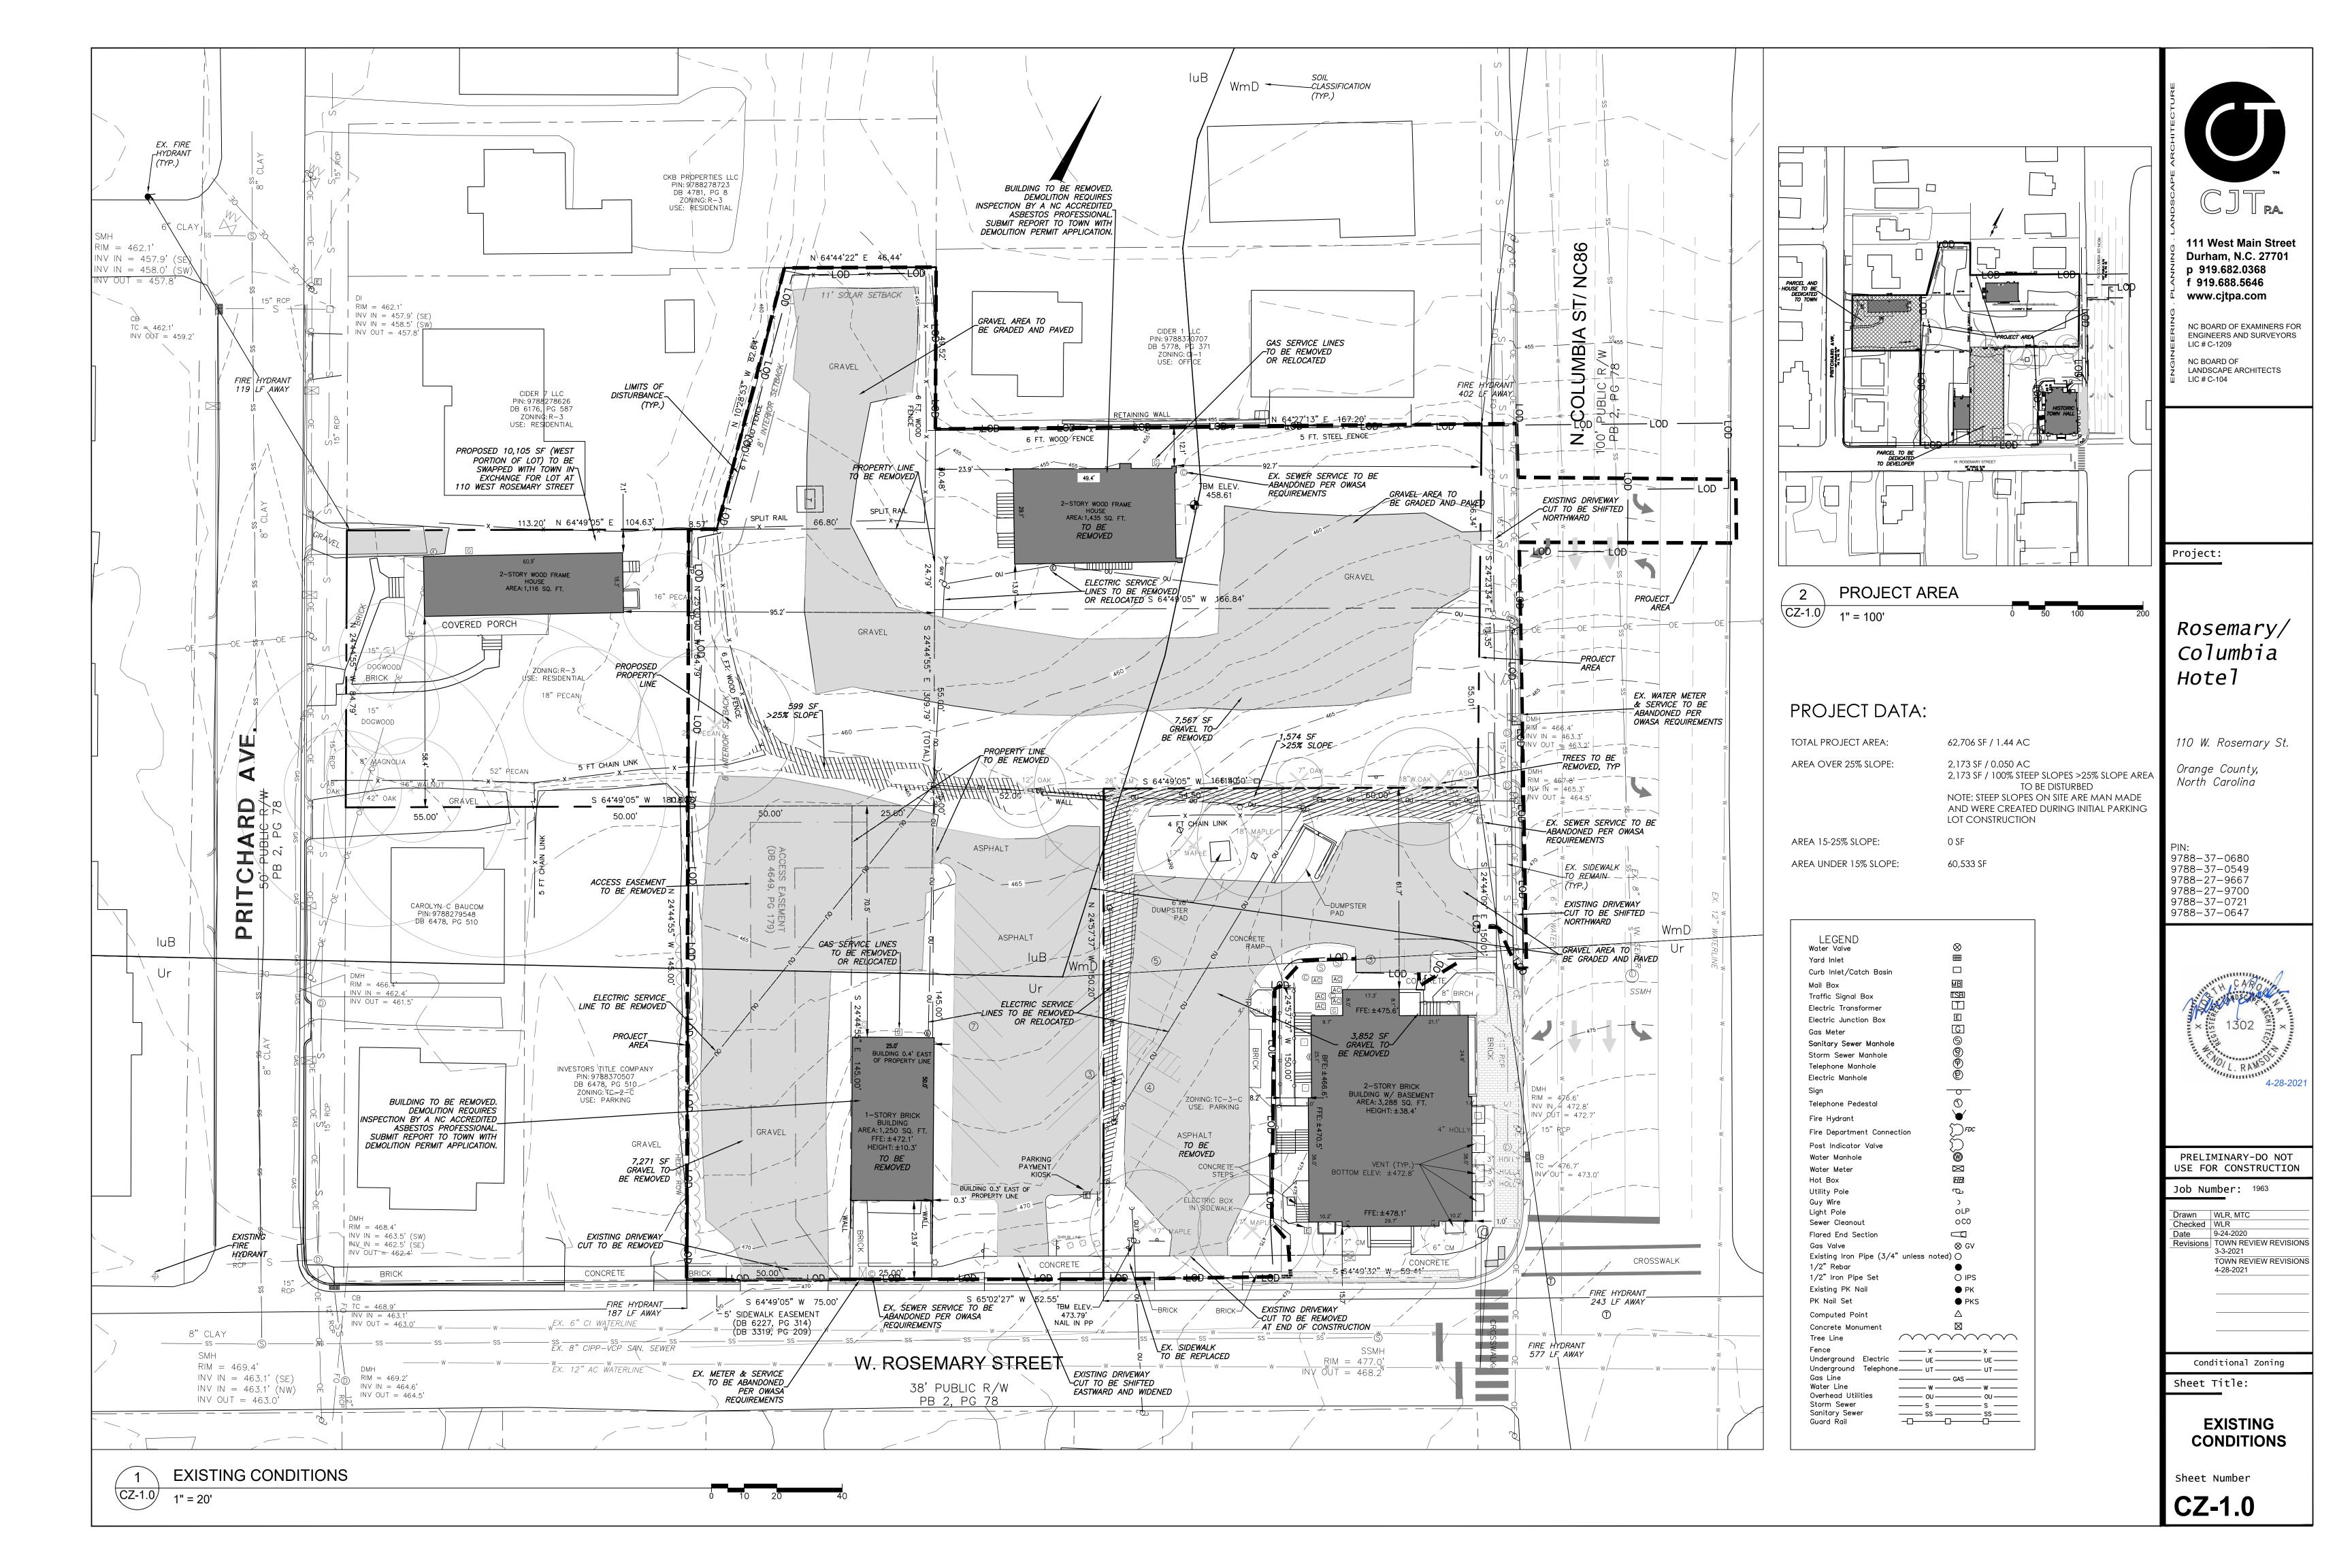



	1. EROSION CONTROL BOND: IF ONE (1) ACRE OR MORE IS UNCOVERED BY LAND-DISTURBING ACTIVITIES FOR THIS PROJECT, THEN A PERFORMANCE GUARANTEE IN ACCORDANCE WITH SECTION 5-97.1 BONDS OF THE TOWN CODE OF ORDINANCES SHALL BE REQUIRED PRIOR TO FINAL AUTHORIZATION TO BEGIN LAND-DISTURBING ACTIVITIES. THIS FINANCIAL GUARANTEE IS INTENDED TO COVER THE COSTS OF RESTORATION OF FAILED OR FAILING SOIL EROSION AND SEDIMENTATION CONTROLS, AND/OR TO REMEDY DAMAGES RESULTING FROM LAND-DISTURBING ACTIVITIES, SHOULD THE RESPONSIBLE PARTY OR PARTIES FAIL TO PROVIDE PROMPT AND EFFECTIVE REMEDIES ACCEPTABLE TO THE TOWN.	1. NCFPC SECTION RADIO COVERA PUBLIC SAFETY REQUIRE IMPR
	2. THE APPLICANT SHALL PROVIDE A COPY OF THE APPROVED EROSION AND SEDIMENT CONTROL PERMIT FROM ORANGE COUNTY EROSION CONTROL DIVISION PRIOR TO RECEIVING A ZONING COMPLIANCE PERMIT. DURING THE CONSTRUCTION PHASE, ADDITIONAL EROSION AND SEDIMENT CONTROLS MAY BE REQUIRED IF THE PROPOSED MEASURES DO NOT CONTAIN THE SEDIMENT. SEDIMENT LEAVING THE PROPERTY IS A VIOLATION OF THE TOWN'S EROSION AND SEDIMENT CONTROL ORDINANCE.	2.FIRE WATCH; DU OTHER HAZARE MAINTAINING A ALARM TO 911 2018 NCFC SE
	 THE CONTRACTOR SHALL TAKE THE APPROPRIATE MEASURES TO PREVENT AND REMOVE THE DEPOSIT OF WET OR DRY SILT ON ADJACENT PAVED ROADWAYS. 	3. CONSTRUCTION/ OF THE NC FI
	4. EROSION CONTROL INSPECTIONS: IN ADDITION TO THE REQUIREMENT DURING CONSTRUCTION FOR INSPECTION AFTER EVERY RAINFALL, THE APPLICANT SHALL INSPECT THE EROSION AND SEDIMENT CONTROL DEVICES WEEKLY, MAKE ANY NECESSARY REPAIRS OR ADJUSTMENTS TO THE DEVICES, AND MAINTAIN INSPECTION LOGS DOCUMENTING THE DAILY INSPECTIONS AND ANY NECESSARY REPAIRS.	4. FIRE DEPARTME SPACE OF 78' APPROVED BY
(4 EROSION CONTROL NOTES	FROM IMPACTS
	CZ-1.1	5. FIRE PROTECTIC PROVIDE THE CALCULATIONS SUPPLY FLOW PER MINUTE.
1.	LANDSCAPING MUST BE IN PLACE PRIOR TO REQUEST FOR A CERTIFICATE OF OCCUPANCY OR CERTIFICATE OF COMPLIANCE.	6. AUTOMATIC FIRE
2.	CONTRACTOR SHALL FIELD VERIFY ALL DIMENSIONS, DEPTHS, QUANTITIES, DISTANCES, ANGLES AND SLOPES PRIOR TO ORDERING MATERIALS OR INSTALLING PROJECT.	STANDARD #13 (1)IN NEW N I. THE BU
3.	IN AREAS OF GROUND COVER, MAINTAIN A 12" MINIMUM DISTANCE BETWEEN PLANTS AND HARD IMPROVEMENTS.	II. TWENT (200)
4.	BED LINES SHALL CONFORM TO CONFIGURATION SHOWN ON THE PLANS. BED LINES SHALL MEET CURBS, WALKS, BUILDINGS, ETC. AT RIGHT ANGLES UNLESS SHOWN OTHERWISE.	III. THE LOT TO
5.	CONTRACTOR SHALL VISIT THE SITE AND FAMILIARIZE THEMSELF WITH ACTUAL CONDITIONS AND VERIFY EXISTING CONDITIONS IN THE FIELD. CONTRACTOR SHALL REPORT ALL DISCREPANCIES TO LANDSCAPE ARCHITECT.	IN ADDITION, AL SYSTEM SHALL LICENSED ALARM
6.	CONTRACTOR SHALL ACCEPT ACTUAL CONDITIONS AT SITE AND PERFORM THE WORK SPECIFIED INCLUDING FINE GRADING AND INCORPORATION OF TOP SOIL INTO PLANTING AREAS, WITHOUT ADDITIONAL COMPENSATION FOR POSSIBLE VARIATION FROM GRADES AND CONDITIONS SHOWN, WHETHER SURFACE OR SUBSURFACE, EXCEPT AS PROVIDED FOR IN CONTRACT DOCUMENTS.	7. WATER SUPPLY OR PERMANEN
7.	IN LAWN AREAS, 2" TOPSOIL SHALL BE TILLED INTO THE TOP 5" OF GROUND PRIOR TO SEEDING.	8.KEY BOXES; 50 SECURED OPEI
8.	CONTRACTOR WILL OBTAIN WRITTEN APPROVAL FROM LANDSCAPE ARCHITECT FOR ANY PLANT SUBSTITUTIONS OF SPECIES, SIZE, OR TYPE OF CONTAINER.	OFFICIAL IS AL APPROVED TYF THE FIRE COD
9.	CONTRACTOR SHALL LOCATE ALL UNDERGROUND UTILITIES PRIOR TO CONSTRUCTION AND SHALL BE RESPONSIBLE FOR THE PROTECTION OF THESE UTILITIES DURING INSTALLATION, AND SHALL PROMPTLY REPAIR AND RESTORE SERVICES AT NO ADDITIONAL COST TO THE OWNER IF DAMAGE OCCURS DURING INSTALLATION. CONTRACTOR SHALL BECOME THOROUGHLY FAMILIAR WITH THE FULL SET OF CONSTRUCTION DRAWINGS AND SPECIFICATIONS FOR COORDINATION WITH UTILITIES, ARCHITECTURAL FEATURES, ETC.	9. ADDRESS IDENT ADDRESS IDEN STREET OR RC ADDRESS NUM
10.	CONTRACTOR WILL LEAVE DISTURBED AREAS LEVEL AND RAKED SMOOTH, REMOVING ALL ROCKS AND DEBRIS.	CHARACTER SH REQUIRED BY FACILITATE EMB
	MULCH IS TO BE A 3" LAYER OF TRIPLE SHREDDED HARDWOOD MULCH. MULCH IS TO BE KEPT AWAY FROM TREE TRUNKS. ANY DAMAGE TO EXISTING CONDITIONS OUTSIDE THE CONTRACT LIMITS, INCLUDING CURBS, SIDEWALKS, TURF AREAS AND	THE PUBLIC W IDENTIFICATION
	PAVING, SHALL BE RESTORED TO ORIGINAL CONDITION BY THE CONTRACTOR WITHOUT EXTRA COST TO THE OWNER.	10. AERIAL FIRE A OVER THE AER
	IN CASE OF DISCREPANCY BETWEEN THE QUANTITY OF PLANTS ON THE PLANS COMPARED TO THE PLANT LIST, THE CONTRACTOR SHALL SUPPLY QUANTITIES AS SHOWN ON THE PLANS.	OBSTRUCTIONS D105
	ALL UNPAVED SURFACES ARE TO BE COVERED IN PLANTS, MULCH, OR GRASS. LINE OF SIGHT NOTE: NO PROPOSED LANDSCAPING WITHIN THE LINE OF SIGHT EASEMENT SHALL EXCEED 24" AT MATURITY.	11.FIRE LANES; W INCLUDE THE
	ANY NEW TREES SHALL BE LIMBED TO 7' ABOVE FINISHED GRADE.	OR PROHIBIT AND LEGIBLE NCFC SECTION
	ANY INVASIVE, EXOTIC PLANT MATERIAL WILL BE REMOVED. A SURVEY OF EXISTING THE LANDSCAPE BUFFERS TO REMAIN WILL BE CONDUCTED FOLLOWING INITIAL CLEARING, AND ANY INVASIVE OR EXOTIC SPECIES FOUND WILL BE REMOVED. THE AREA WITHIN THE SIGHT TRIANGLE AREA SHALL BE THINNED OF ALL SHRUBS, UNDERSTORY TREES UNDER 1" IN CALIPER,	12.FIRE APPARATU
	VINES, AND DEAD PLANT MATERIAL. EXISTING TREES LARGER THAN 1" SHALL BE LIMBED UP TO 7' ABOVE EXISTING GRADE TO IMPROVE VISIBILITY.	OR PERMIT MO OR WHERE NE
		13.FIRE APPARATU (1)503.1 WH 503.1.1 TH
(_	5 LANDSCAPE NOTES	14. TRAFFIC CALMI NCFC 503.4.1
	CZ-1.1)	15. OBSTRUCTION INCLUDING THE SHALL BE MAII
		16.FIRE DEPARTMI TEMPORARY ST VEHICLES. SIG 2018 NCFC SE
		17.FIRE DEPARTM SLIDE MOTION. EMERGENCY AG
		18.FIRE DEPARTM CONSTRUCTED INFORMATION (
	1. WRITTEN OWASA APPROVAL IS REQUIRED FOR INSTALLATION OF ANY BACKFLOW PREVENTERS, GREASE TRAPS, OIL/WATER SEPARATORS, WATER METERS, ELEVATOR SUMP PUMPS.	
,		7 FIF
	CZ-1.1 UTILITY NOTES	CZ-1.1
		-

PC SECTION 510. EMERGENCY RESPONDER RADIO COVERAGE IN NEW BUILDINGS. ALL NEW BUILDINGS SHALL HAVE APPROVED DIO COVERAGE FOR EMERGENCY RESPONDERS WITHIN THE BUILDING BASED UPON THE EXISTING COVERAGE LEVELS OF THE BLIC SAFETY COMMUNICATION SYSTEMS OF THE JURISDICTION AT THE EXTERIOR OF THE BUILDING. THIS SECTION SHALL NOT QUIRE IMPROVEMENT OF THE EXISTING PUBLIC SAFETY COMMUNICATION SYSTEMS.

WATCH; DURING CONSTRUCTION AND DEMOLITION WHERE HOT WORK, MATERIALS SUBJECT TO SPONTANEOUS COMBUSTION, OR HER HAZARDOUS CONSTRUCTION OR DEMOLITION IS OCCURRING, THE OWNER OR THEIR DESIGNEE SHALL BE RESPONSIBLE FOR INTAINING A FIRE WATCH. THE FIRE WATCH SHALL CONSIST OF AT LEAST ONE PERSON WITH A MEANS OF COMMUNICATING AN ARM TO 911, SHALL HAVE A WRITTEN ADDRESS POSTED IN A CONSPICUOUS LOCATION, AND SHALL MAINTAIN CONSTANT PATROLS. 18 NCFC SECTION 3304.5

ISTRUCTION/DEMOLITION; ALL CONSTRUCTION AND DEMOLITION CONDUCTED SHALL BE IN COMPLIANCE OF THE CURRENT EDITION THE NC FIRE CODE. 2018 NCFC CHAPTER 33

DEPARTMENT CONNECTIONS, INSTALLATION; A WORKING SPACE OF NOT LESS THAN 36" IN WIDTH AND DEPTH AND A WORKING ACE OF 78" IN HEIGHT SHALL BE PROVIDED ON ALL SIDES WITH THE EXCEPTION OF WALL MOUNTED FDCS UNLESS OTHERWISE PROVED BY THE FIRE CODE OFFICIAL. THE FDCS WHERE REQUIRED MUST BE PHYSICALLY PROTECTED BY AN APPROVED BARRIER OM IMPACTS. 2018 NCFC SECTION 912

PROTECTION AND UTILITY PLAN; SHALL INCLUDE THE FIRE FLOW REPORT: FOR A HYDRANT WITHIN 500' OF EACH BUILDING, OVIDE THE CALCULATED GALLONS PER MINUTE OF WITH A RESIDUAL PRESSURE OF 20 POUNDS PER SQUARE INCH. THE LCULATIONS SHOULD BE SEALED BY A PROFESSIONAL ENGINEER LICENSED IN THE STATE OF NC AND ACCOMPANIED BY A WATER PPLY FLOW TEST CONDUCTED WITHIN ONE YEAR OF THE SUBMITTAL. REFERENCE TOWN DESIGN MANUAL FOR REQUIRED GALLONS

OMATIC FIRE SPRINKLER SYSTEM REQUIRED: AN AUTOMATIC FIRE SPRINKLER SYSTEM MEETING THE REQUIREMENTS OF NFPA ANDARD #13 IS REQUIRED TO BE INSTALLED IN NON-RESIDENTIAL CONSTRUCTION, AS FOLLOWS.)IN NEW NON-RESIDENTIAL STRUCTURES IF:

I. THE BUILDING HAS MORE THAN 6,000 SQUARE FEET OF FLOOR AREA;

II. TWENTY (20) PER CENT OR MORE OF THE TOTAL FLOOR AREA IS MORE THAN TWO HUNDRED

(200) FEET OF TRAVEL DISTANCE FROM THE NEAREST ACCESS POINT FOR A FIRE TRUCK; OR

III. THE BUILDING EXCEEDS TWO (2) STORIES OR TWENTY-FOUR (24) FEET IN HEIGHT FROM THE AVERAGE GRADE OF THE LOT TO THE WINDOWS ON THE TOPMOST OCCUPIED FLOOR. DDITION, ALL CONNECTIONS SHALL BE LOCATED ON THE STREET SIDE OF EACH BUILDING, AND ACTIVATION OF THE SPRINKLER

EM SHALL ACTIVATE BOTH A LOCAL BUILDING ALARM AND A SUPERVISORY ALARM AT A TWENTY-FOUR (24) HOUR CERTIFIED AND NSED ALARM MONITORING SERVICE. TOWN ORDINANCE 7-56

ER SUPPLY FOR FIRE PROTECTION: WHEN REQUIRED. AN APPROVED WATER SUPPLY FOR FIRE PROTECTION, EITHER TEMPORARY PERMANENT, SHALL BE MADE AVAILABLE AS SOON AS COMBUSTIBLE MATERIAL ARRIVES ON THE SITE. 2018 NCFC 3312

BOXES; 506.1 WHERE REQUIRED. WHERE ACCESS TO OR WITHIN A STRUCTURE OR AN AREA IS RESTRICTED BECAUSE OF CURED OPENINGS OR WHERE IMMEDIATE ACCESS IS NECESSARY FOR LIFE-SAVING OR FIRE-FIGHTING PURPOSES, THE FIRE CODE FICIAL IS AUTHORIZED TO REQUIRE A KEY BOX TO BE INSTALLED IN AN APPROVED LOCATION. THE KEY BOX SHALL BE OF AN PROVED TYPE LISTED IN ACCORDANCE WITH UL 1037, AND SHALL CONTAIN KEYS TO GAIN NECESSARY ACCESS AS REQUIRED BY E FIRE CODE OFFICIAL. 2018 NCFC 506.1

RESS IDENTIFICATION; 505.1 ADDRESS IDENTIFICATION. NEW AND EXISTING BUILDINGS SHALL BE PROVIDED WITH APPROVED DRESS IDENTIFICATION. THE ADDRESS IDENTIFICATION SHALL BE LEGIBLE AND PLACED IN A POSITION THAT IS VISIBLE FROM THE REET OR ROAD FRONT THE PROPERTY. ADDRESS IDENTIFICATION CHARACTERS SHALL CONTRAST WITH THEIR BACKGROUND. DRESS NUMBERS SHALL BE ARABIC NUMBERS OR ALPHABETICAL LETTERS. NUMBERS SHALL NOT BE SPELLED OUT. EACH ARACTER SHALL BE NOT LESS THAN 6 INCHES (153 MM) HIGH WITH A MINIMUM STROKE WIDTH OF 3/4 INCH (2Q MM). WHERE QUIRED BY THE FIRE CODE OFFICIAL, ADDRESS IDENTIFICATION SHALL BE PROVIDED IN ADDITIONAL APPROVED LOCATIONS TO CILITATE EMERGENCY RESPONSE. WHERE ACCESS IS BY MEANS OF A PRIVATE ROAD AND THE BUILDING CANNOT BE VIEWED FROM PUBLIC WAY, A MONUMENT, POLE, OR OTHER SIGN OR MEANS SHALL BE USED TO IDENTIFY THE STRUCTURE. ADDRESS NTIFICATION SHALL BE MAINTAINED. 2018 NCFC 505.1

RIAL FIRE APPARATUS ACCESS ROADS; D105.4 OBSTRUCTIONS. OVERHEAD UTILITY AND POWER LINES SHALL NOT BE LOCATED ER THE AERIAL FIRE APPARATUS ACCESS ROAD OR BETWEEN THE AERIAL FIRE APPARATUS ROAD AND THE BUILDING. OTHER STRUCTIONS SHALL BE PERMITTED TO BE PLACED WITH THE APPROVAL OF THE FIRE CODE OFFICIAL. 2018 NCFC APPENDIX

LANES; WHERE REQUIRED BY THE FIRE CODE OFFICIAL, APPROVED SIGNS OR OTHER APPROVED NOTICES OR MARKINGS THAT LUDE THE WORDS NO PARKING-FIRE LANE SHALL BE PROVIDED FOR FIRE APPARATUS ACCESS ROADS TO IDENTIFY SUCH ROADS PROHIBIT THE OBSTRUCTION THEREOF. THE MEANS BY WHICH FIRE LANES ARE DESIGNATED SHALL BE MAINTAINED IN A CLEAN D LEGIBLE CONDITION AT ALL TIMES AND BE REPLACED OR REPAIRED WHEN NECESSARY TO PROVIDE ADEQUATE VISIBILITY. 2018 FC SECTION 503.3 AND APPENDIX D D 103.6, D 1036.1, D 103.6.2

APPARATUS ACCESS ROADS AUTHORITY; 503.2. AUTHORITY. THE FIRE CODE OFFICIAL SHALL HAVE THE AUTHORITY TO REQUIRE PERMIT MODIFICATIONS TO THE REQUIRED ACCESS WIDTHS WHERE THEY ARE INADEQUATE FOR FIRE OR RESCUE OPERATIONS WHERE NECESSARY TO MEET THE PUBLIC SAFETY OBJECTIVES OF THE JURISDICTION. 2018 NCFC SECTION 503

E APPARATUS ACCESS ROADS;

503.1 WHERE REQUIRED. FIRE APPARATUS ACCESS ROADS SHALL BE PROVIDED AND MAINTAINED IN ACCORDANCE WITH SECTIONS 503.1.1 THROUGH 503.1.3

AFFIC CALMING DEVICES. TRAFFIC CALMING DEVICES SHALL BE PROHIBITED UNLESS APPROVED BY THE FIRE CODE OFFICIAL. 2018

STRUCTION OF FIRE APPARATUS ACCESS ROADS. FIRE APPARATUS ACCESS ROADS SHALL NOT BE OBSTRUCTED IN ANY MANNER. CLUDING THE PARKING OF VEHICLES. THE MINIMUM WIDTHS AND CLEARANCES ESTABLISHED IN SECTIONS 503.2.1 AND 503.2.2 ALL BE MAINTAINED AT ALL TIMES. 2018 NCFC 503.4


DEPARTMENT ACCESS/CONSTRUCTION: DURING CONSTRUCTION, VEHICLE ACCESS FOR FIREFIGHTING SHALL BE PROVIDED. MPORARY STREET SIGNS SHALL BE INSTALLED AT EACH STREET INTERSECTION WHEN CONSTRUCTION ALLOWS THE PASSAGE OF HICLES. SIGNS SHALL BE OF AN APPROVED SIZE, WEATHER RESISTANT, AND MAINTAINED UNTIL REPLACED BY PERMANENT SIGNS. 18 NCFC SECTION 505.2

DEPARTMENT ACCESS/CONSTRUCTION: FENCING AROUND PROJECTS SHALL INCLUDE ACCESS GATES WITH A 20 FOOT SWING OR DE MOTION. ANY AREAS WHICH WILL BE INACCESSIBLE FOR FIREFIGHTING OR RESCUE OPERATIONS SHALL BE NOTED. ERGENCY ACCESS DESIGNATION FOR APPARATUS SHALL BE PROVIDED. 2018 NCFC SECTION 503, APPENDIX D.

E DEPARTMENT ACCESS: ALL TURNS, RADII, BRIDGES, AND DEPRESSIONS WITHIN ROADWAYS SHALL BE DESIGNED AND NSTRUCTED TO BE ACCESSIBLE BY THE LARGEST FIRE APPARATUS OPERATED BY THE TOWN OF CHAPEL HILL. TECHNICAL ORMATION ON THIS EQUIPMENT IS AVAILABLE FROM THE TOWNS FIRE MARSHAL. 2018 NCFC SECTION 503, APPENDIX D.

FIRE NOTES * FIRE NOTES ABOVE WILL BE ADDRESSED DURING ZCP AND/OR BUILDING PERMIT PLANS.

 In the second second
Project:
Rosemary/ Columbia Hotel
110 W. Rosemary St. Orange County, North Carolina
PIN: 9788-37-0680 9788-37-0549 9788-27-9667 9788-27-9700 9788-37-0721 9788-37-0647
× 15 1302 L. RAMSOL 4-28-2021
PRELIMINARY-DO NOT USE FOR CONSTRUCTION
Job Number: 1963
Drawn WLR, MTC Checked WLR Date 9-24-2020 Revisions TOWN REVIEW REVISIONS 3-3-2021 TOWN REVIEW REVISIONS 4-28-2021
Conditional Zoning Sheet Title:
NOTES Sheet Number CZ-1.1

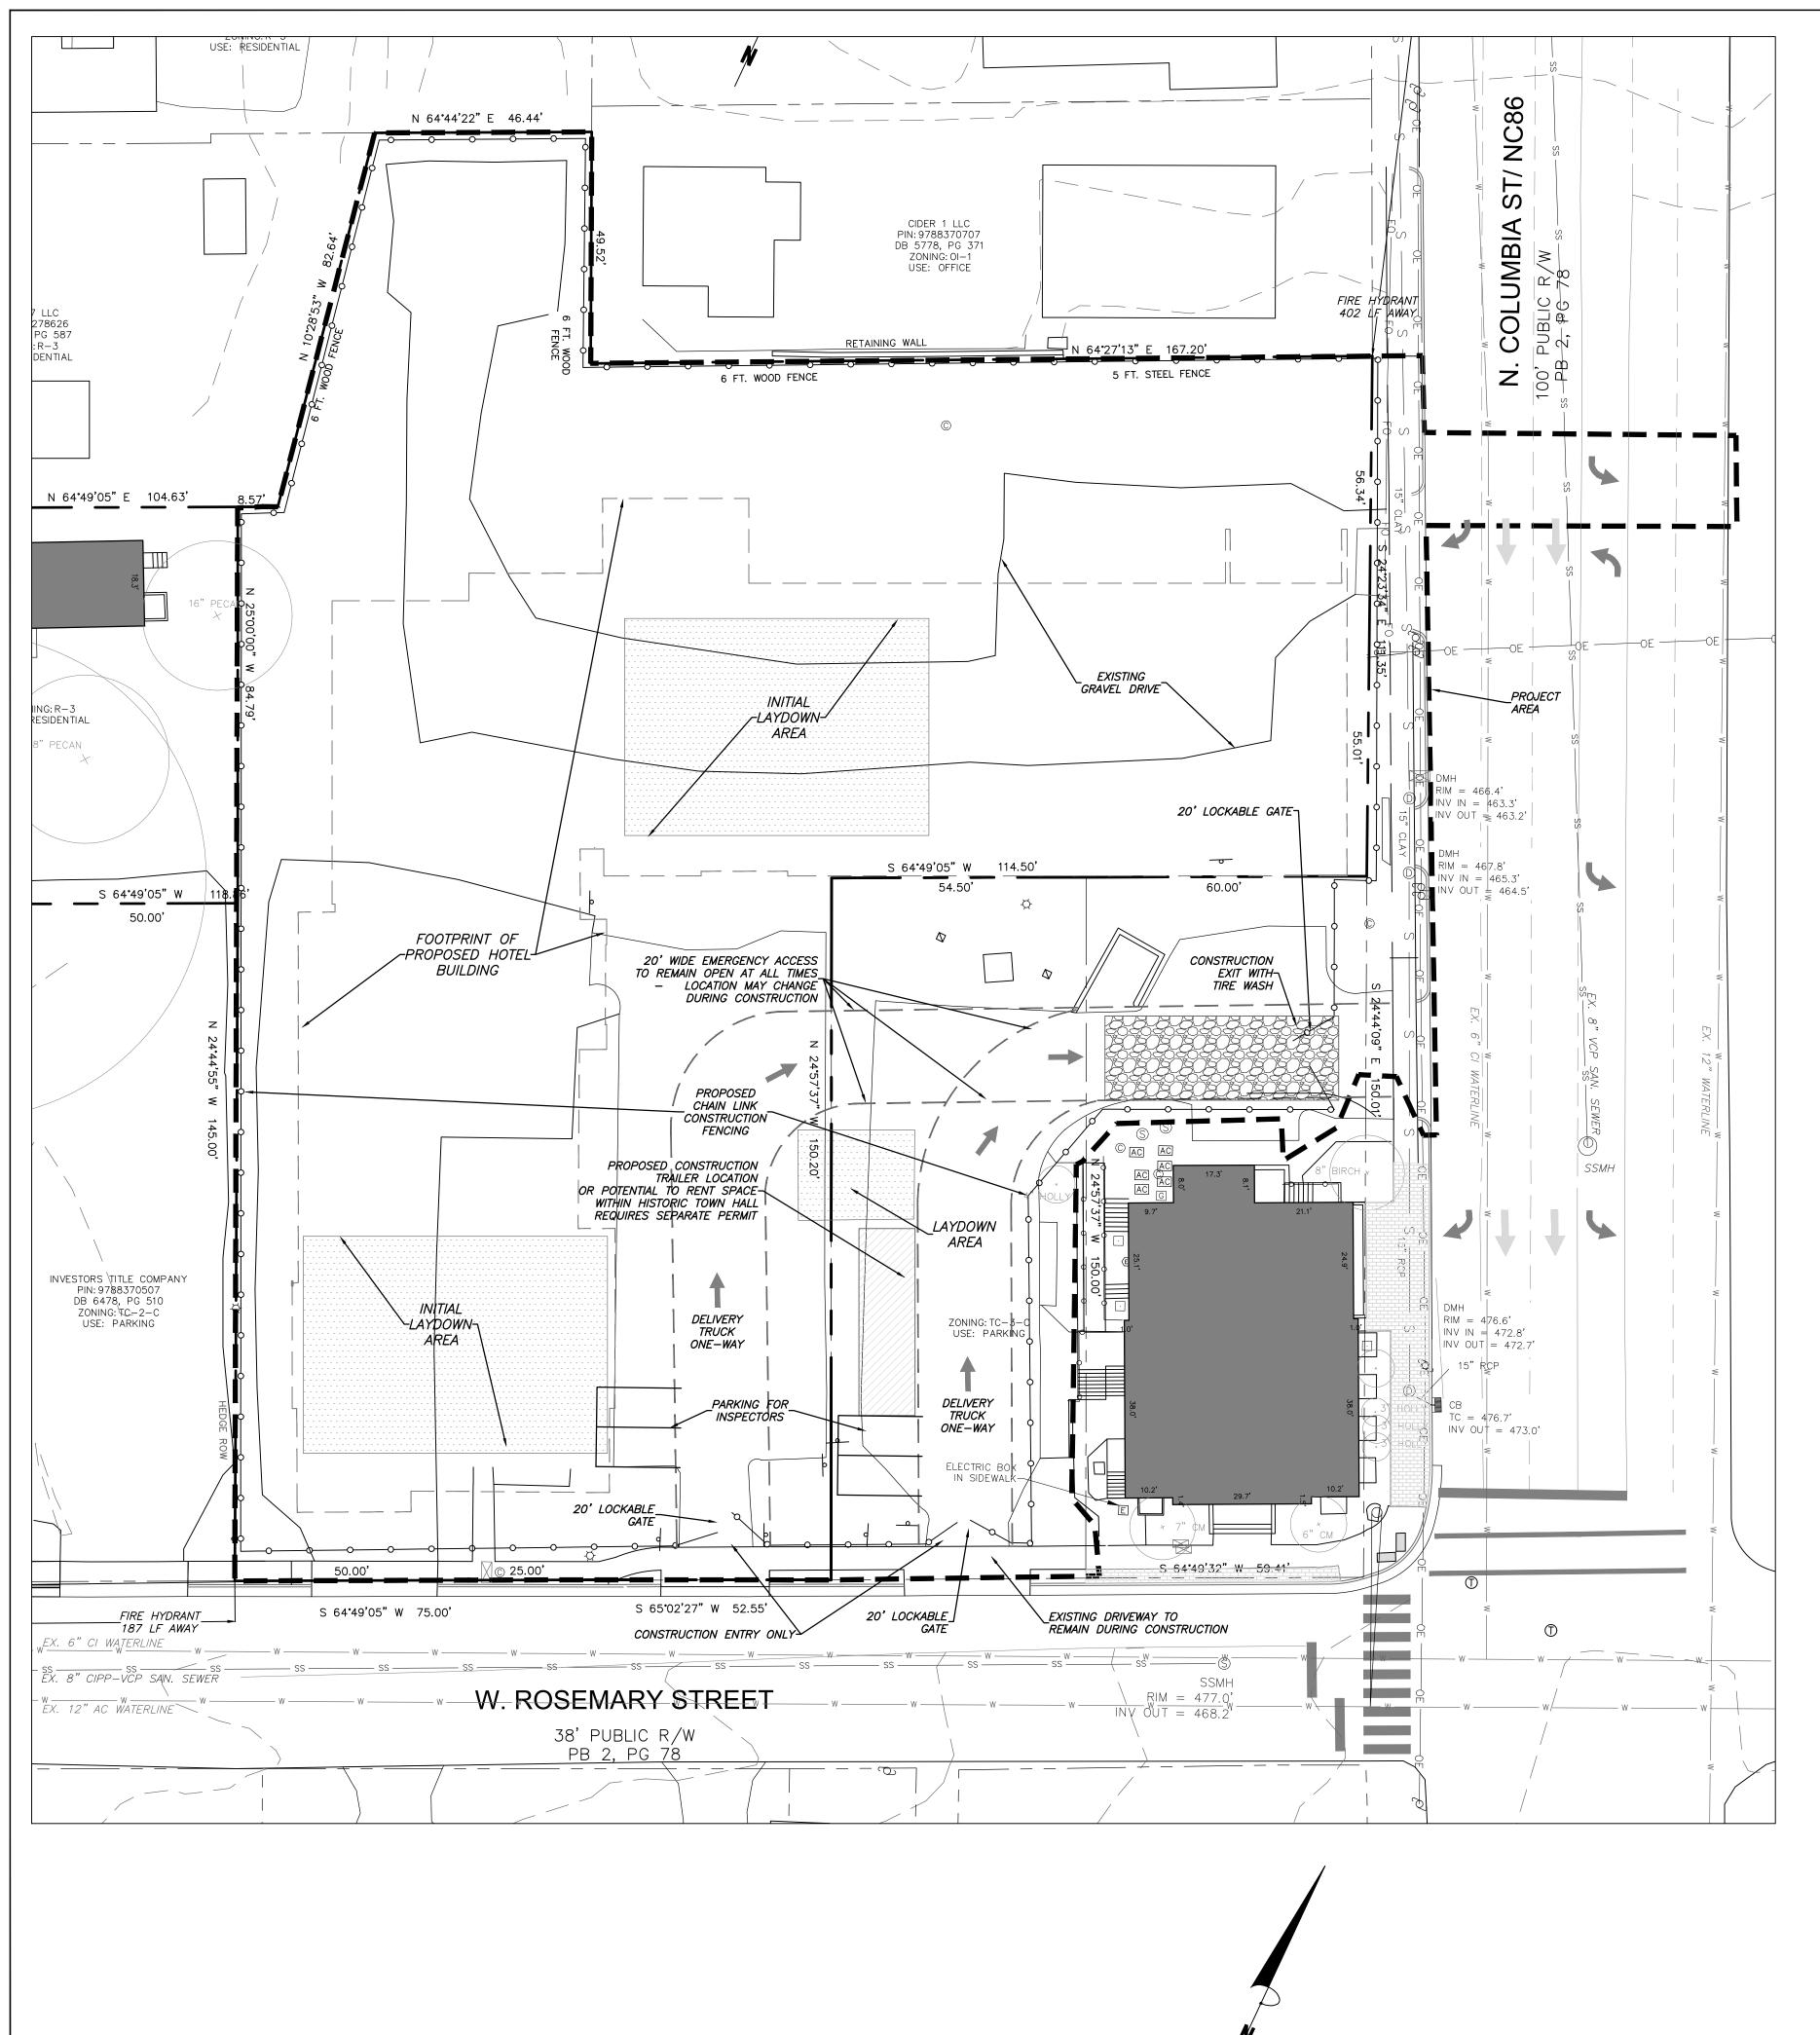


CONSTRUCTION MANAGEMENT PLAN CZ-1.2/ 1" = 20'

CONSTRUCTION STAGING NOTES

- 1. EXISTING GRAVEL PARKING IS TO BE LEFT INTACT FOR CONSTRUCTION WORKERS UNTIL WORK IS DONE IN EACH AREA AND GRAVEL NEEDS TO BE REMOVED.
- 2. NO CONSTRUCTION PARKING WILL BE ALLOWED ON ADJACENT <u>RESIDENTIAL STREETS.</u>
- 3. HOURS OF CONSTRUCTION ARE MONDAY TO FRIDAY 7 AM TO 6 PM, AND SATURDAY AS NEEDED BETWEEN 8 AM AND 6 PM. THERE WILL BE NO CONSTRUCTION ON SUNDAYS. THE TOWN OF CHAPEL HILL NOISE ORDINANCE MUST BE COMPLIED WITH. THE TOWN ORDINANCE SPECIFIES CONSTRUCTION OPERATIONS ARE LIMITED TO 7 AM TO 9 PM WEEKDAYS, AND 8 AM TO 9 PM WEEKENDS. ANY ROCK REMOVAL WORK NEEDS TO BE COORDINATED WITH TOWN ADMINISTRATION, AND NEIGHBORS NOTIFIED IN ADVANCE.
- 4. PROVIDE ON-SITE PARKING FOR INSPECTORS AT EACH BUILDING FOR THE DURATION OF THE CONSTRUCTION PROJECT.


FIRE PROTECTION NOTES

- 1. CONTRACTOR SHALL MAINTAIN A FIRE WATCH DURING THE CONSTRUCTION OR DEMOLITION OF "HOT WORK" THAT MAY SUBJECT MATERIALS TO SPONTANEOUS COMBUSTION. THE FIRE WATCH SHALL CONSIST OF AT LEAST ONE PERSON WITH A MEANS OF COMMUNICATING AN ALARM TO 911. SHALL HAVE A WRITTEN ADDRESS POSTED IN A CONSPICUOUS LOCATION, AND SHALL MAINTAIN CONSTANT PATROLS.
- 2. ALL CONSTRUCTION AND DEMOLITION SHALL COMPLY WITH THE CURRENT EDITION OF CHAPTER 14 OF THE NC FPC (FIRE CODE).
- 3. ANY PERMANENT OR TEMPORARY GATES ACROSS FIRE ACCESS DRIVES SHALL BE A MINIMUM WIDTH OF 20', EITHER SWINGING OR SLIDING TYPE, HAVE AN EMERGENCY MEANS OF OPERATION, AND SHALL BE OPERABLE BY EITHER FORCIBLE ENTRY OR KEYED, CAPABLE OF BEING OPERATED BY ONE PERSON, AND SHALL BE INSTALLED AND MAINTAINED ACCORDING TO UL 325 AND ASTM F 2200 NC FPC 2012.

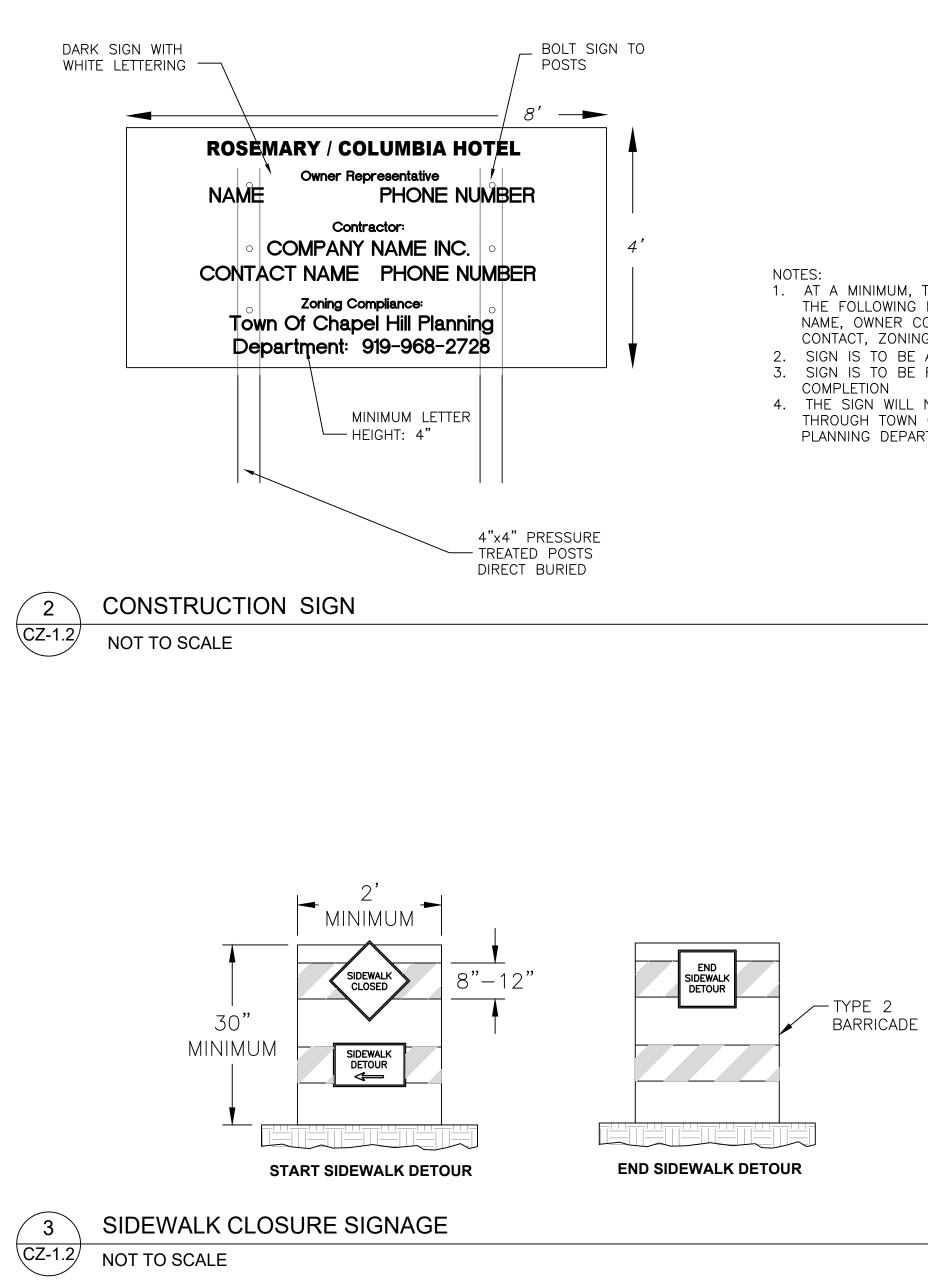


TRAFFIC/PEDESTRIAN CONTROL NOTES


- 1. SIGNS SHOWN ON THIS PLAN ARE REQUIRED DURING THE CONSTRUCTION OF THIS PROJECT.
- 2. CONSTRUCTION WILL REQUIRING TEMPORARY LANE CLOSURES ON PUBLIC STREETS NEED TOWN APPROVAL. TEMPORARY LANE CLOSURES ARE ONLY ALLOWED DURING DAYLIGHT
- HOURS. 3. 4. ALL WORK ZONE SIGNAGE SHALL COMPLY WITH
- APPLICABLE M.U.T.C.D. STANDARDS AND DETAILS. 4. PRIOR TO ANY TRAFFIC LANE CLOSURES, IT WILL BE NECESSARY TO CONTACT ERNIE ROGERS AT 919-968-2833, OF THE CHAPEL HILL ENGINEERING DIVISION, AT LEAST 5
- WORKING DAYS BEFORE THE PROPOSED WORK TO APPLY FOR A LANE CLOSURE PERMIT. 5. SIGNS AND TEMPORARY BARRICADES AS SHOWN BELOW WILL
- BE PLACED TO DIRECT PEDESTRIANS WHEN SIDEWALKS ARE IN THE CONSTRUCTION AREAS.
- - 1. AT A MINIMUM, THE SIGN IS TO INCLUDE THE FOLLOWING INFORMATION: PROJECT NAME, OWNER CONTACT, CONTRACTOR CONTACT, ZONING COMPLIANCE CONTACT. 2. SIGN IS TO BE A MAXIMUM OF 4' X 8'
 - SIGN IS TO BE REMOVED AT PROJECT
 - 4. THE SIGN WILL NEED A SEPARATE PERMIT THROUGH TOWN OF CHAPEL HILL PLANNING DEPARTMENT

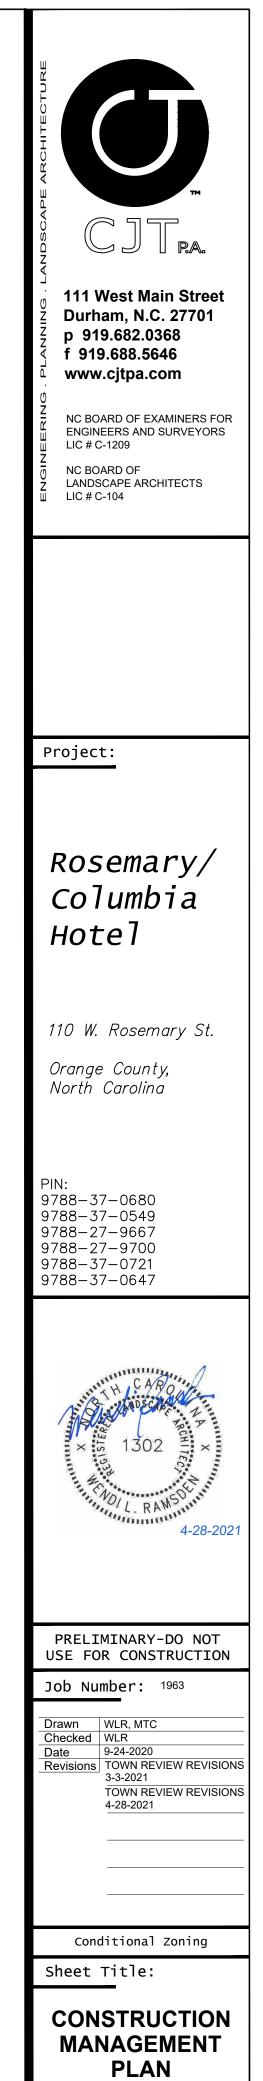


Sheet Number

CZ-1.2

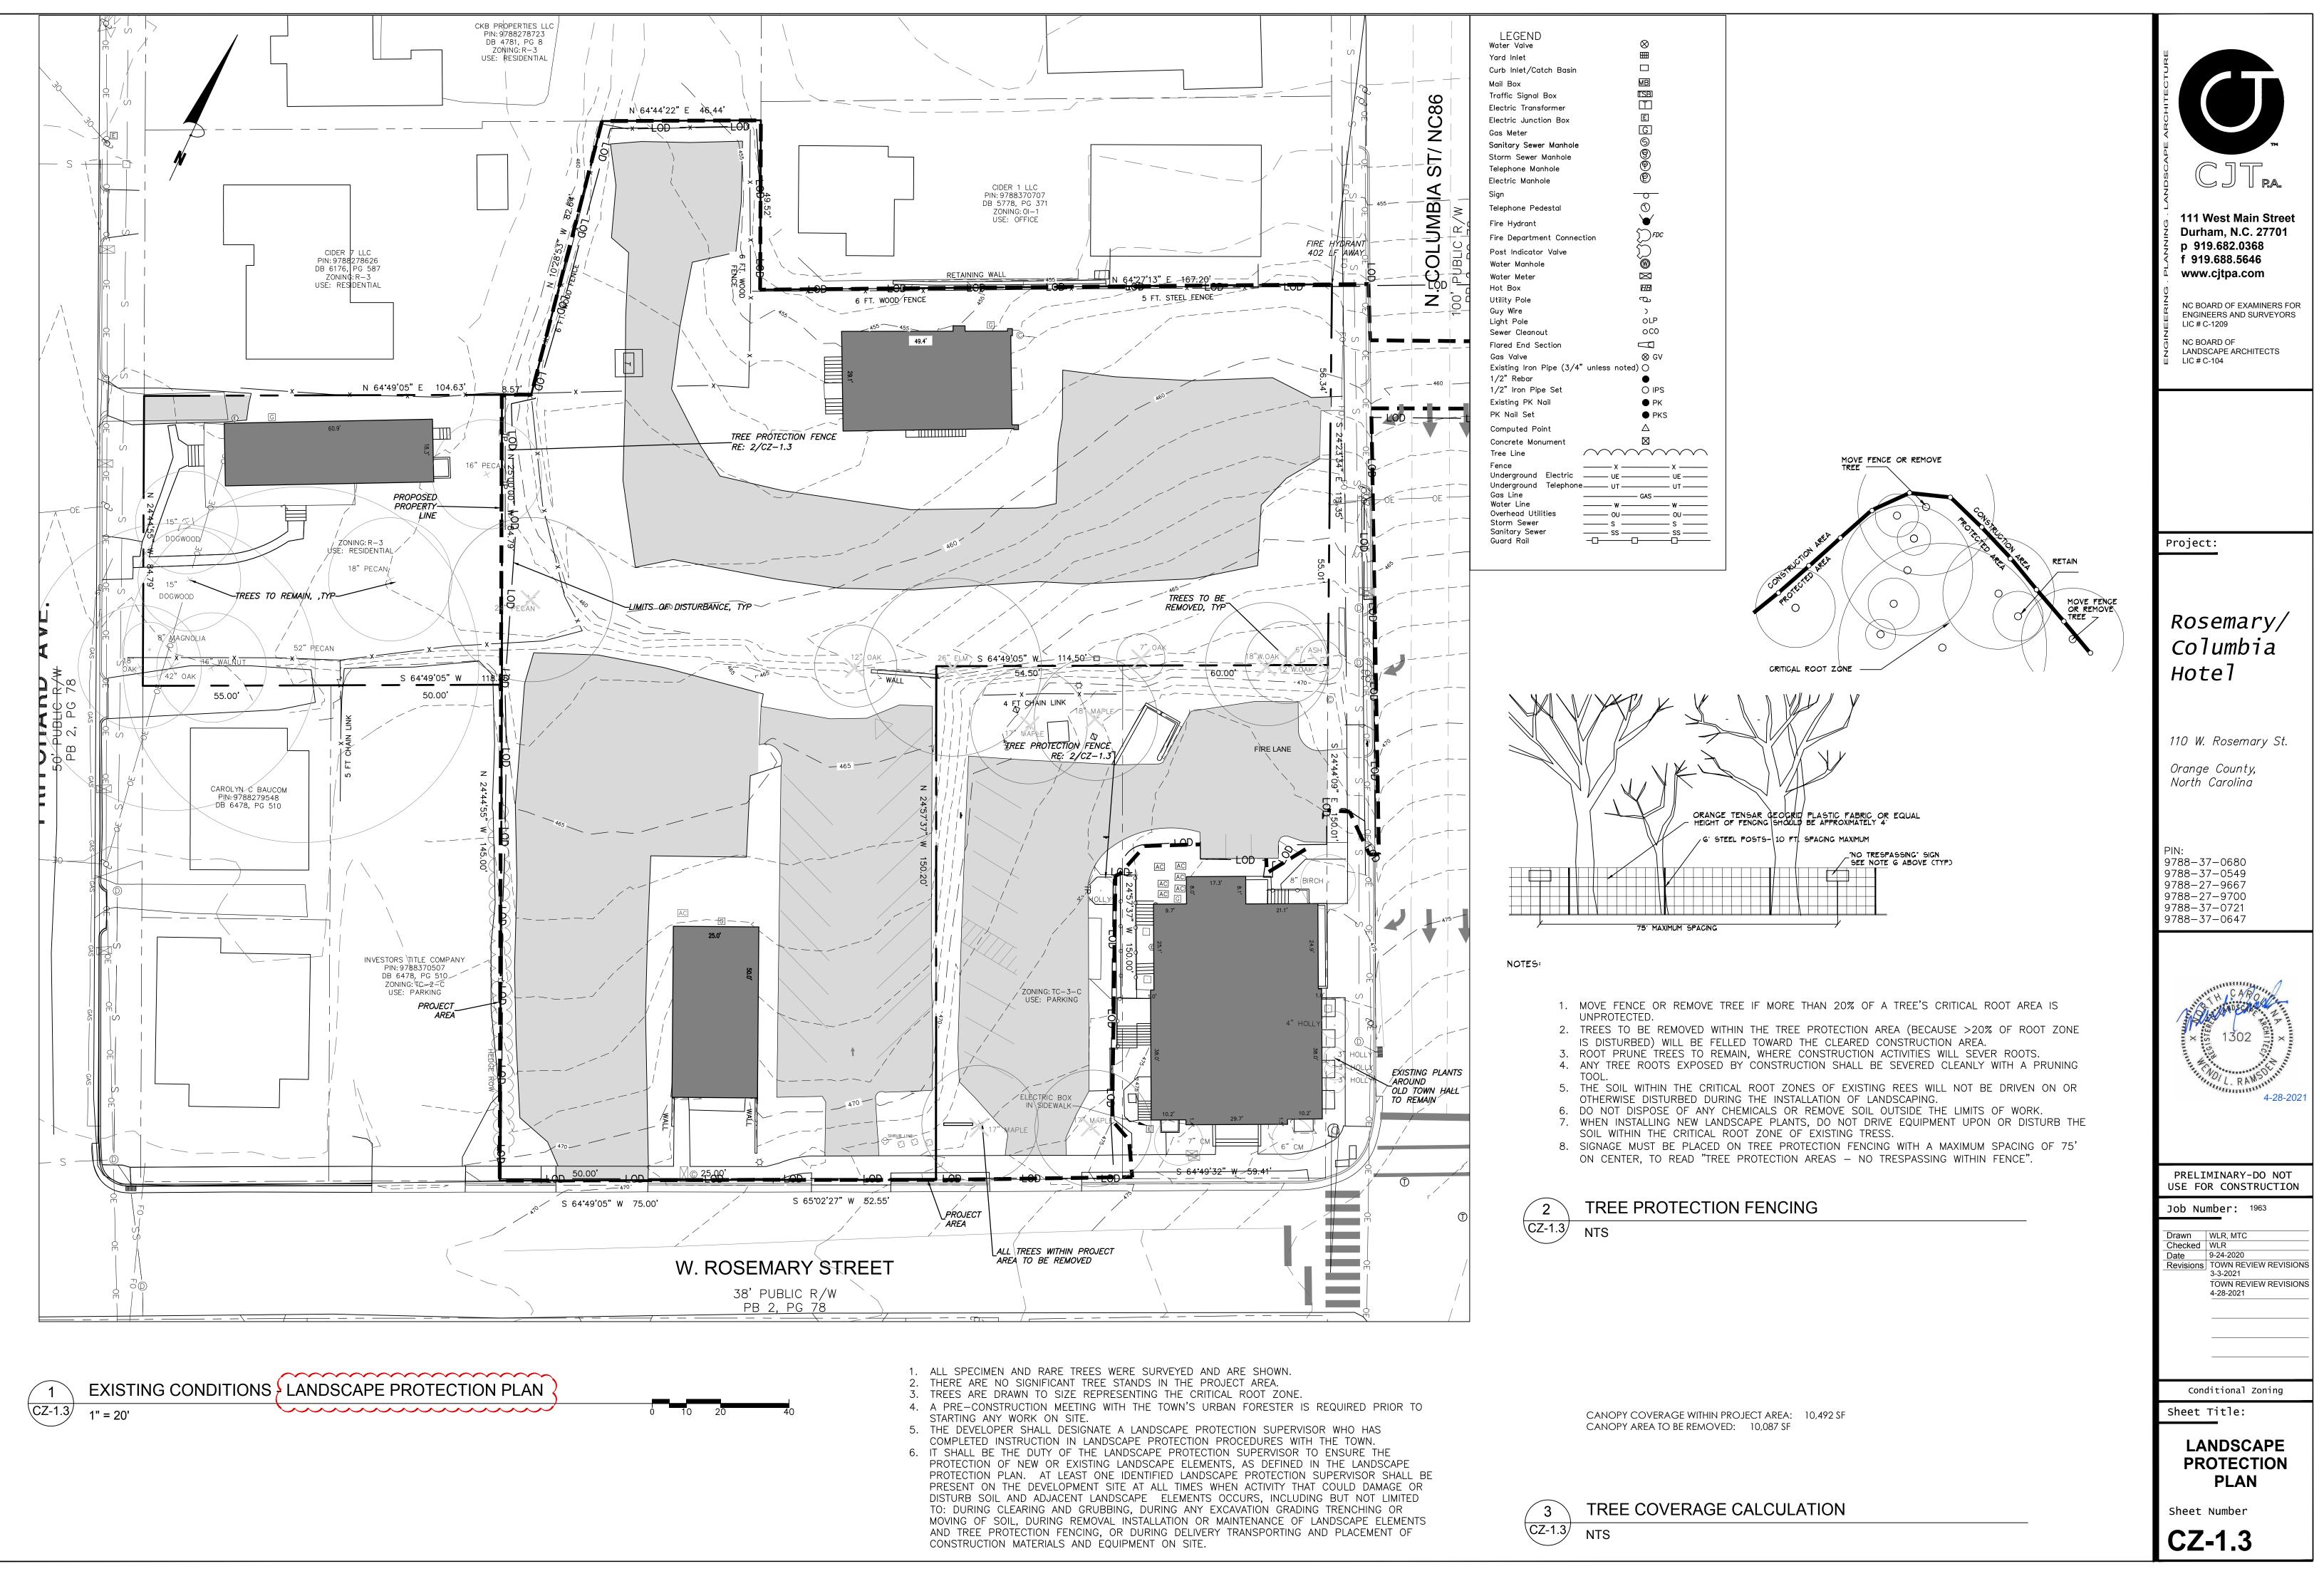

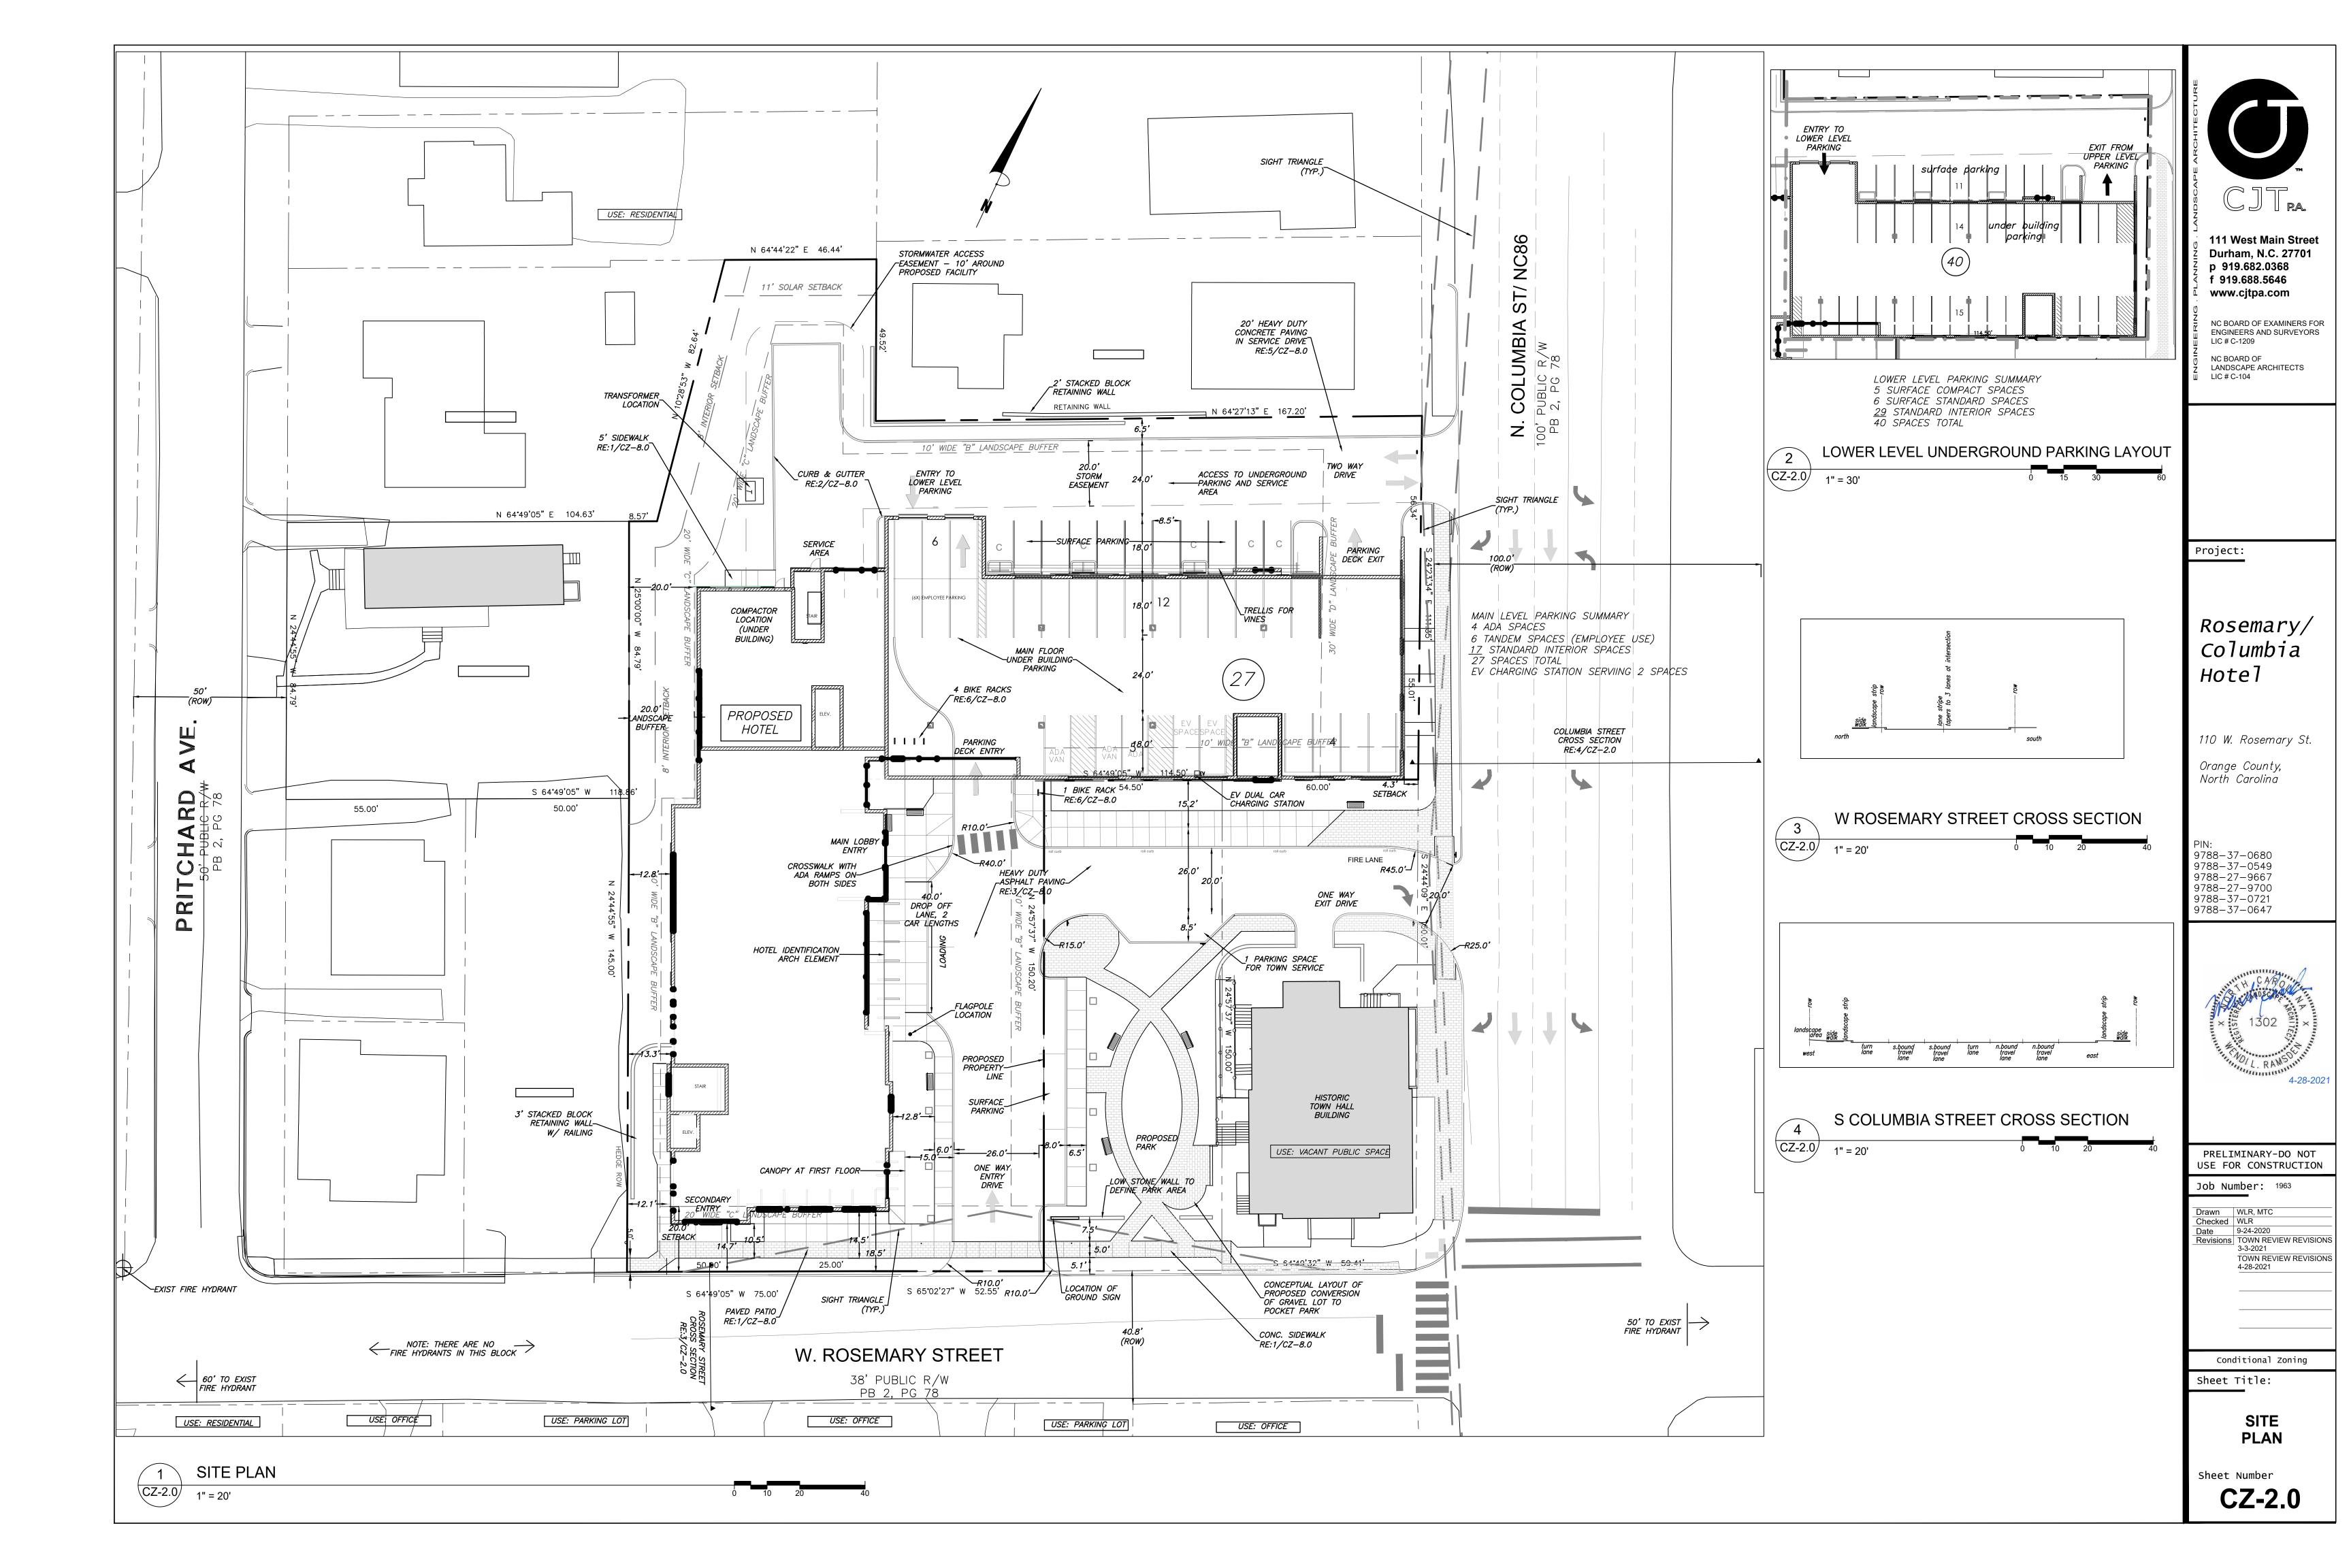

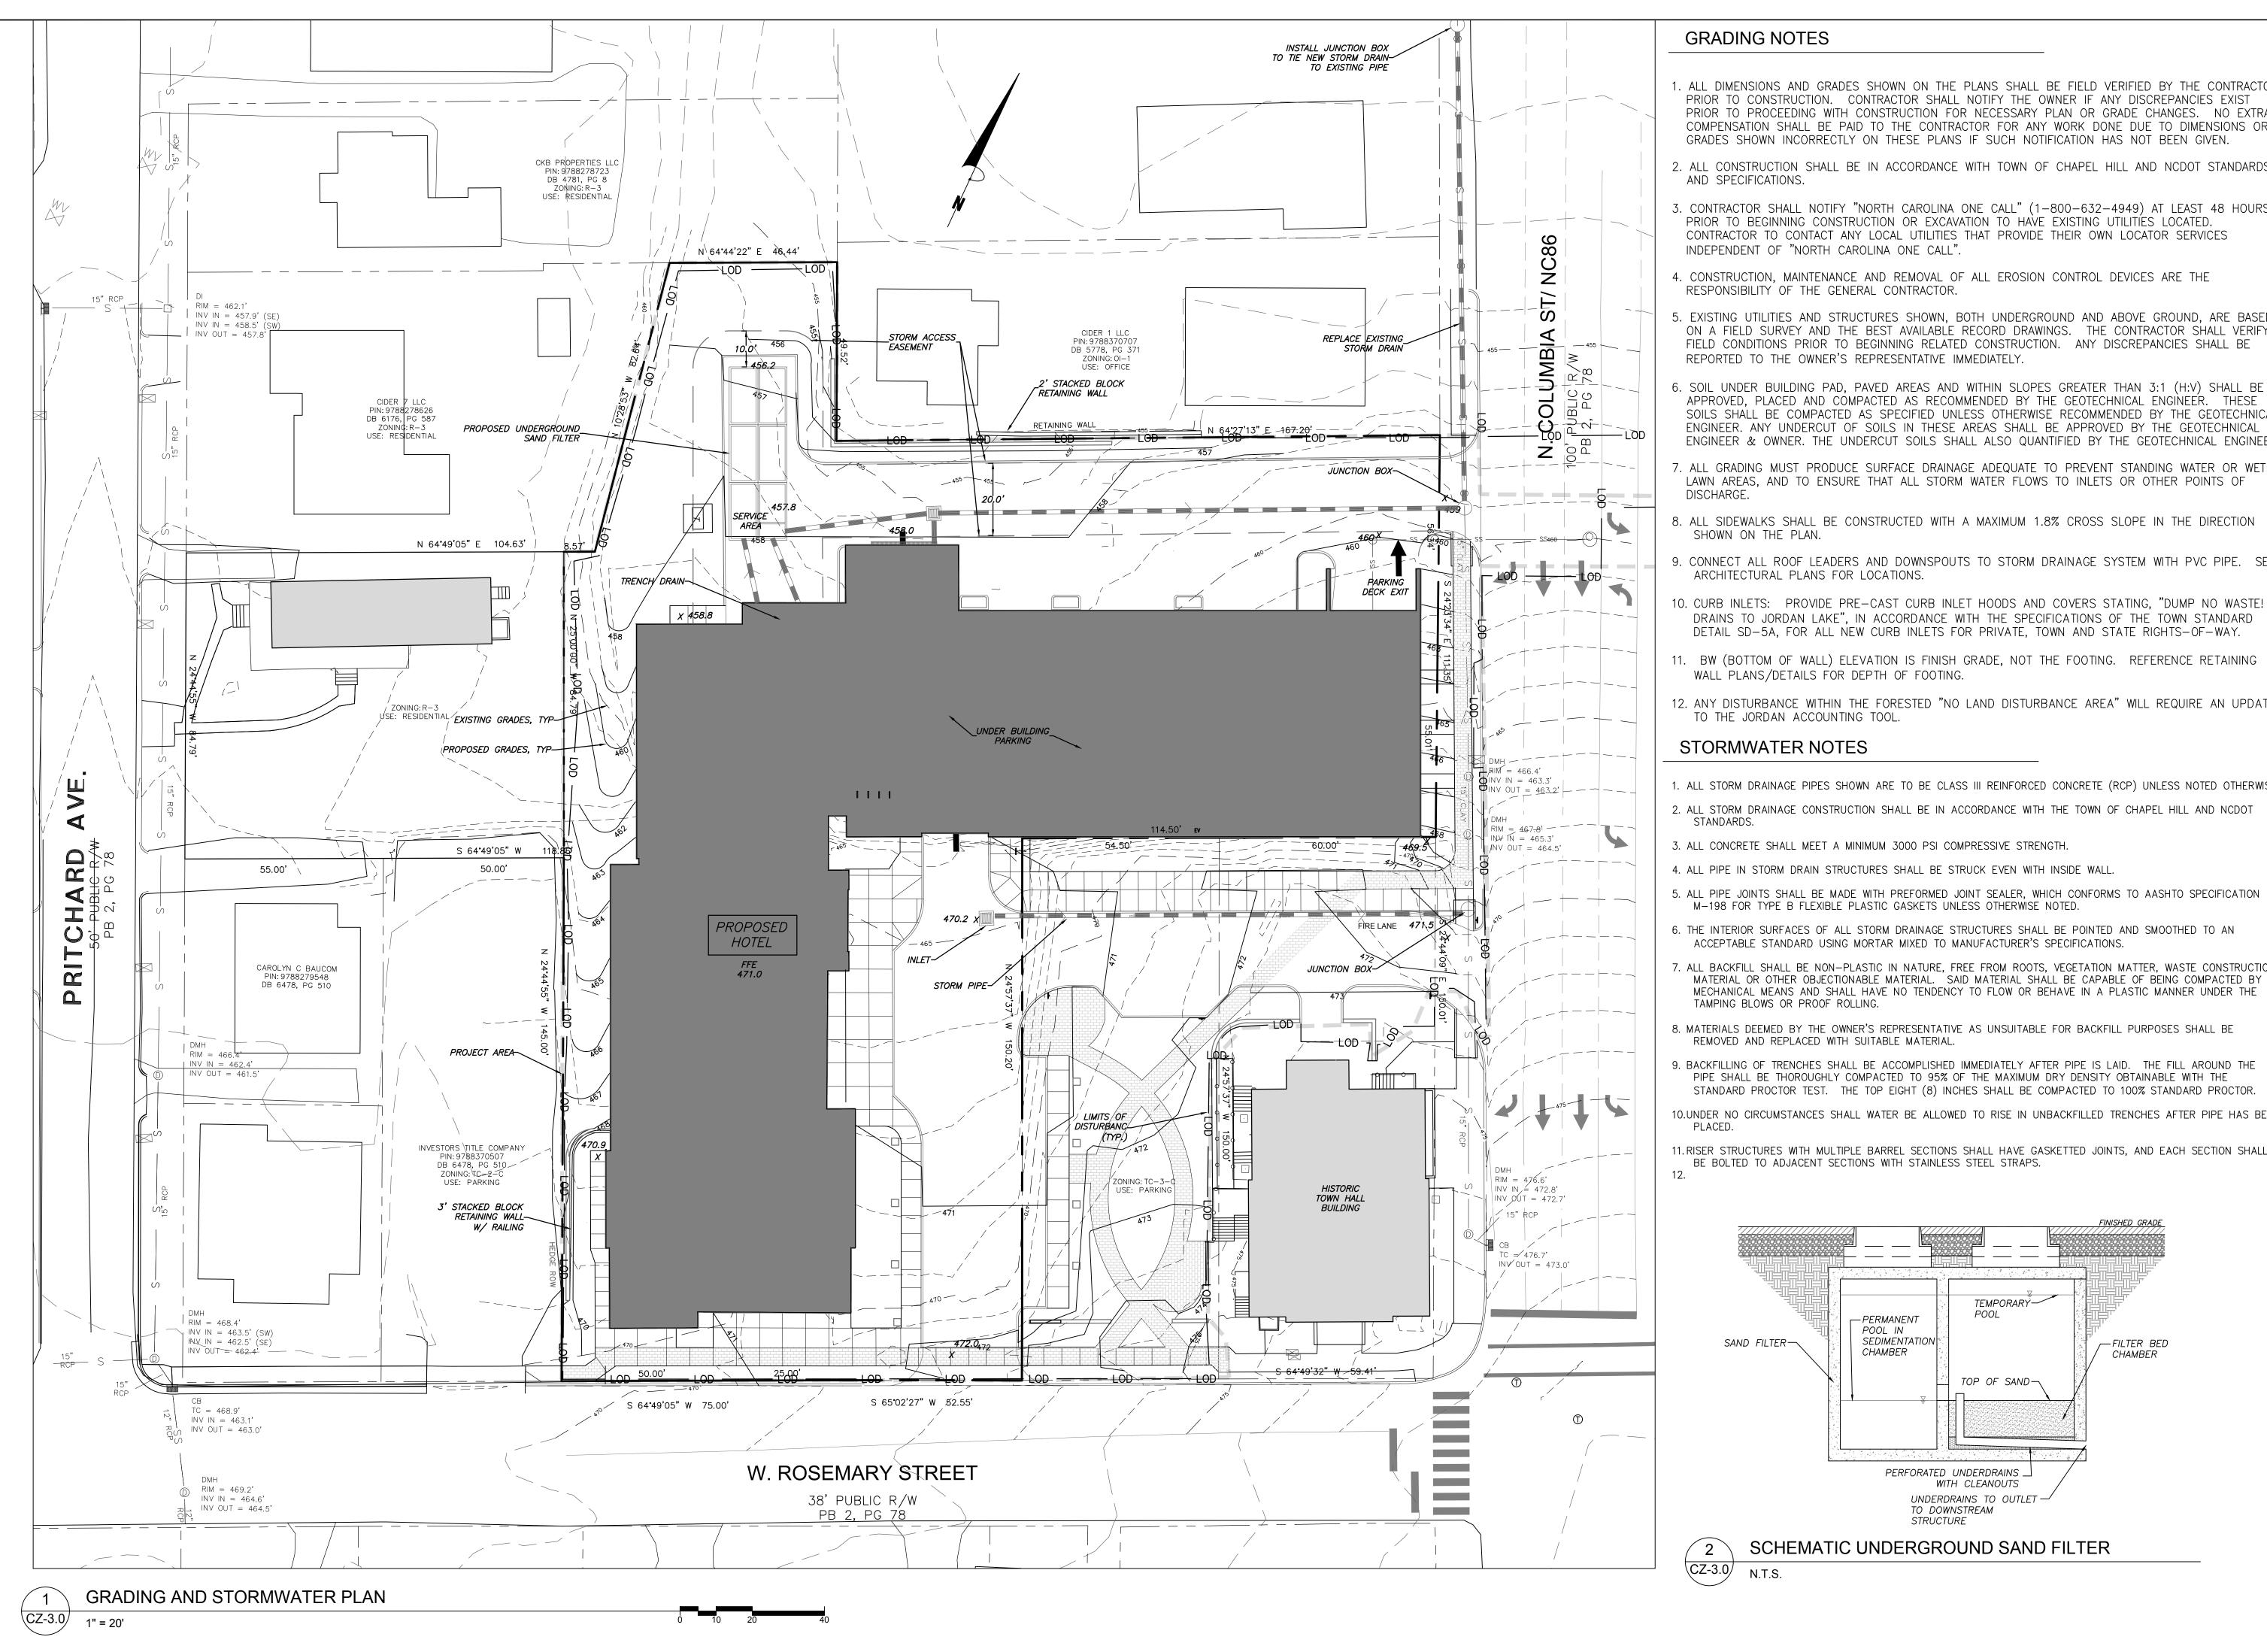

1. ALL DIMENSIONS AND GRADES SHOWN ON THE PLANS SHALL BE FIELD VERIFIED BY THE CONTRACTOR PRIOR TO CONSTRUCTION. CONTRACTOR SHALL NOTIFY THE OWNER IF ANY DISCREPANCIES EXIST PRIOR TO PROCEEDING WITH CONSTRUCTION FOR NECESSARY PLAN OR GRADE CHANGES. NO EXTRA COMPENSATION SHALL BE PAID TO THE CONTRACTOR FOR ANY WORK DONE DUE TO DIMENSIONS OR GRADES SHOWN INCORRECTLY ON THESE PLANS IF SUCH NOTIFICATION HAS NOT BEEN GIVEN.

2. ALL CONSTRUCTION SHALL BE IN ACCORDANCE WITH TOWN OF CHAPEL HILL AND NCDOT STANDARDS

3. CONTRACTOR SHALL NOTIFY "NORTH CAROLINA ONE CALL" (1-800-632-4949) AT LEAST 48 HOURS PRIOR TO BEGINNING CONSTRUCTION OR EXCAVATION TO HAVE EXISTING UTILITIES LOCATED. CONTRACTOR TO CONTACT ANY LOCAL UTILITIES THAT PROVIDE THEIR OWN LOCATOR SERVICES

4. CONSTRUCTION, MAINTENANCE AND REMOVAL OF ALL EROSION CONTROL DEVICES ARE THE

5. EXISTING UTILITIES AND STRUCTURES SHOWN, BOTH UNDERGROUND AND ABOVE GROUND, ARE BASED ON A FIELD SURVEY AND THE BEST AVAILABLE RECORD DRAWINGS. THE CONTRACTOR SHALL VERIFY FIELD CONDITIONS PRIOR TO BEGINNING RELATED CONSTRUCTION. ANY DISCREPANCIES SHALL BE

SOIL UNDER BUILDING PAD, PAVED AREAS AND WITHIN SLOPES GREATER THAN 3:1 (H:V) SHALL BE APPROVED, PLACED AND COMPACTED AS RECOMMENDED BY THE GEOTECHNICAL ENGINEER. THESE SOILS SHALL BE COMPACTED AS SPECIFIED UNLESS OTHERWISE RECOMMENDED BY THE GEOTECHNIC ENGINEER. ANY UNDERCUT OF SOILS IN THESE AREAS SHALL BE APPROVED BY THE GEOTECHNICAL ENGINEER & OWNER. THE UNDERCUT SOILS SHALL ALSO QUANTIFIED BY THE GEOTECHNICAL ENGINEER

7. ALL GRADING MUST PRODUCE SURFACE DRAINAGE ADEQUATE TO PREVENT STANDING WATER OR WET LAWN AREAS, AND TO ENSURE THAT ALL STORM WATER FLOWS TO INLETS OR OTHER POINTS OF

8. ALL SIDEWALKS SHALL BE CONSTRUCTED WITH A MAXIMUM 1.8% CROSS SLOPE IN THE DIRECTION

9. CONNECT ALL ROOF LEADERS AND DOWNSPOUTS TO STORM DRAINAGE SYSTEM WITH PVC PIPE. SEE

10. CURB INLETS: PROVIDE PRE-CAST CURB INLET HOODS AND COVERS STATING, "DUMP NO WASTE! DRAINS TO JORDAN LAKE", IN ACCORDANCE WITH THE SPECIFICATIONS OF THE TOWN STANDARD DETAIL SD-5A, FOR ALL NEW CURB INLETS FOR PRIVATE, TOWN AND STATE RIGHTS-OF-WAY.

11. BW (BOTTOM OF WALL) ELEVATION IS FINISH GRADE, NOT THE FOOTING. REFERENCE RETAINING

12. ANY DISTURBANCE WITHIN THE FORESTED "NO LAND DISTURBANCE AREA" WILL REQUIRE AN UPDA

1. ALL STORM DRAINAGE PIPES SHOWN ARE TO BE CLASS III REINFORCED CONCRETE (RCP) UNLESS NOTED OTHERWIS 2. ALL STORM DRAINAGE CONSTRUCTION SHALL BE IN ACCORDANCE WITH THE TOWN OF CHAPEL HILL AND NCDOT

5. ALL PIPE JOINTS SHALL BE MADE WITH PREFORMED JOINT SEALER, WHICH CONFORMS TO AASHTO SPECIFICATION

6. THE INTERIOR SURFACES OF ALL STORM DRAINAGE STRUCTURES SHALL BE POINTED AND SMOOTHED TO AN

MATERIAL OR OTHER OBJECTIONABLE MATERIAL. SAID MATERIAL SHALL BE CAPABLE OF BEING COMPACTED BY MECHANICAL MEANS AND SHALL HAVE NO TENDENCY TO FLOW OR BEHAVE IN A PLASTIC MANNER UNDER THE

8. MATERIALS DEEMED BY THE OWNER'S REPRESENTATIVE AS UNSUITABLE FOR BACKFILL PURPOSES SHALL BE


PIPE SHALL BE THOROUGHLY COMPACTED TO 95% OF THE MAXIMUM DRY DENSITY OBTAINABLE WITH THE STANDARD PROCTOR TEST. THE TOP EIGHT (8) INCHES SHALL BE COMPACTED TO 100% STANDARD PROCTOR.

11. RISER STRUCTURES WITH MULTIPLE BARREL SECTIONS SHALL HAVE GASKETTED JOINTS, AND EACH SECTION SHALL

U I RA 111 West Main Street Durham, N.C. 27701 p 919.682.0368 f 919.688.5646 www.cjtpa.com NC BOARD OF EXAMINERS FOR ENGINEERS AND SURVEYORS LIC # C-1209 NC BOARD OF LANDSCAPE ARCHITECTS LIC # C-104 Project: Rosemary/ Columbia Hotel 110 W. Rosemary St. Orange County, North Carolina 9788-37-0680 9788-37-0549 9788-27-9667 9788-27-9700 9788-37-0721 9788-37-0647 CAR SEAL 35003 STON B. P 4/28/21 PRELIMINARY-DO NOT USE FOR CONSTRUCTION Job Number: ¹⁹⁶³ Drawn WLR, MTC Checked WLR, PBR Date 9-24-2020 Revisions TOWN REVIEW REVISIONS 3-3-2021 TOWN REVIEW REVISIONS 4-28-2021 Conditional Zoning Sheet Title: **GRADING AND**

STORMWATER PLAN

Sheet Number **CZ-3.0**

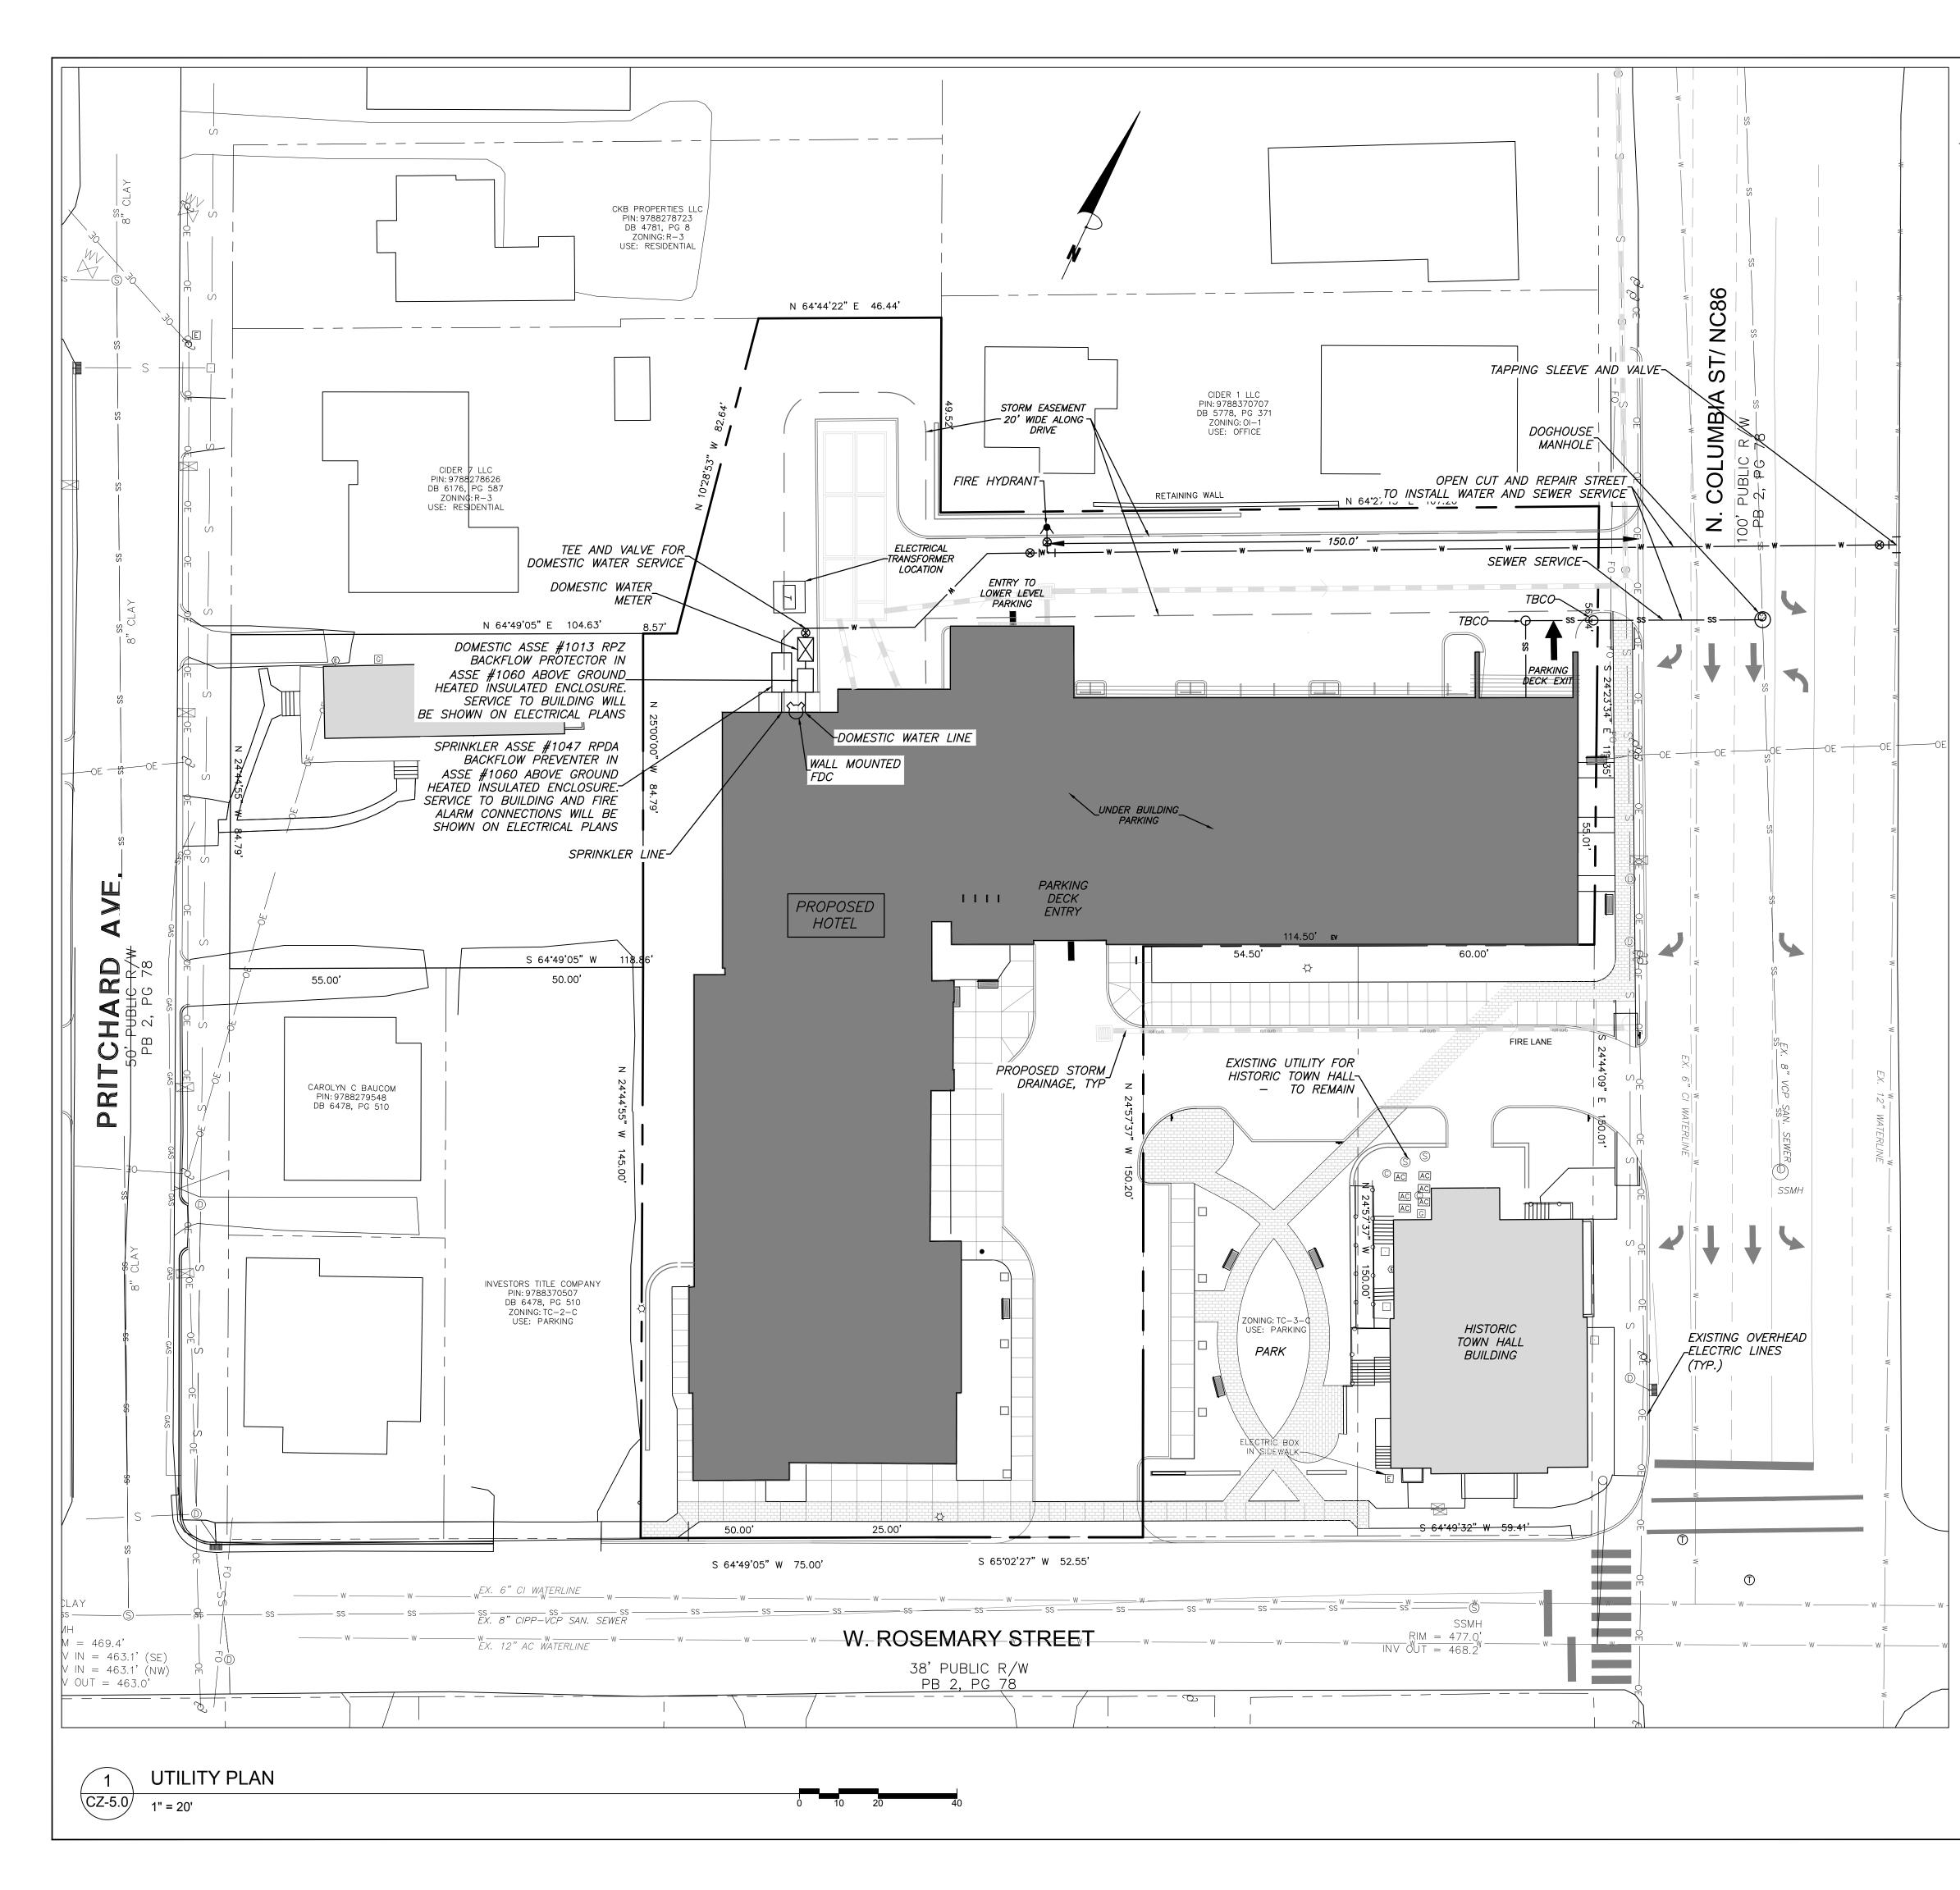

UTILITY NOTES

- CONTRACTOR SHALL NOTIFY "NORTH CAROLINA ONE CALL" (1-800-632-4949) AT LEAST 48 HOURS PRIOR TO BEGINNING CONSTRUCTION OR EXCAVATION TO HAVE EXISTING UTILITIES LOCATED. CONTRACTOR TO CONTACT ANY LOCAL UTILITIES THAT PROVIDE THEIR OWN LOCATOR SERVICE INDEPENDENT OF "NORTH CAROLINA ONE CALL".
- 2. ALL WATER AND SEWER MAINS WITHIN PUBLIC EASEMENTS AND RIGHT-OF-WAYS TO BE OWNED, OPERATED AND MAINTAINED BY OWASA.
- 3. ALL CONSTRUCTION SHALL BE IN ACCORDANCE WITH THE TOWN OF CHAPEL HILL AND OWASA STANDARDS AND SPECIFICATIONS.
- 4. ALL EXISTING UNDERGROUND UTILITIES ARE APPROXIMATELY LOCATED. ACTUAL LOCATION AND DEPTH SHALL BE CONFIRMED IN THE FIELD PRIOR TO CONSTRUCTION.
- 5. BEFORE STARTING ANY CONSTRUCTION OF IMPROVEMENTS WITHIN ANY TOWN OR N.C.D.O.T. STREET OR HIGHWAY RIGHT-OF-WAY THE FOLLOWING PROCEDURES SHOULD BE UNDERTAKEN; TOWN RIGHT-OF-WAY: CONTACT LOCAL AUTHORITIES' TRAFFIC ENGINEERING DEPT. FOR INFORMATION ON DETOURS, OPEN CUTTING OF STREETS OR FOR ANY CONSTRUCTION WITHIN RIGHT-OF-WAY. N.C.D.O.T. RIGHT-OF-WAY: CONTACT PROJECT ENGINEERS AND OBTAIN ALL PERMITS AND ENCROACHMENTS (KEEP COPIES ON CONSTRUCTION SITE, ALSO CONTACT N.C.D.O.T. DISTRICT OFFICE 24 HOURS IN ADVANCE BEFORE PLACING CURB AND GUTTER).
- 6. ALL DIMENSIONS AND GRADES SHOWN ON THE PLANS SHALL BE FIELD VERIFIED BY THE CONTRACTOR PRIOR TO CONSTRUCTION. CONTRACTOR SHALL NOTIFY THE OWNER IF ANY DISCREPANCIES EXIST. PRIOR TO PROCEEDING WITH CONSTRUCTION FOR NECESSARY PLAN OR GRADING CHANGES. NO EXTRA COMPENSATION SHALL BE PAID TO THE CONTRACTOR FOR ANY WORK DONE DUE TO DIMENSIONS OR GRADES SHOWN INCORRECTLY ON THESE PLANS IF SUCH NOTIFICATION HAS NOT BEEN GIVEN.
- 7. POWER, TELEPHONE, AND GAS SERVICES TO BUILDINGS SHALL BE UNDERGROUND. ACCESS AND SERVICE ROUTES TO BE COORDINATED WITH THE PUBLIC UTILITIES, CONTRACTOR AND THE OWNER.
- 8. RESURFACING OF STREET DUE TO UTILITY CUTS SHALL BE REQUIRED AT THE DIRECTION OF ENGINEERING. (MINIMUM 50' TO EITHER SIDE OF UTILITY CUTS).
- 9. PROVIDE 10-FT OF HORIZONTAL SEPARATION BETWEEN PROPOSED NEW WATER AND SEWER MAINS


SANITARY SEWER:

- 1. BACKFLOW PREVENTORS SHALL BE PROVIDED FOR ALL UNITS WITH FINAL FLOOR ELEVATIONS OF BUILDINGS LESS THAN 1'-0" ABOVE UPSTREAM MANHOLE.
- 2. MINIMUM COVER OF 5 FEET IN TRAFFIC AREAS TO BE PROVIDED FOR ALL COLLECTOR LINES 4 INCHES AND LARGER. IF LESS THAN 5 FEET, DUCTILE IRON PIPE SHALL BE REQUIRED.
- MINIMUM SLOPE FOR 4 INCH SANITARY SEWER COLLECTION LINES SHALL BE NO LESS THAN 2.0% WITH CLEANOUTS EVERY 75 LINEAL FEET.
- 4. MINIMUM SLOPE FOR 6 INCH SANITARY SEWER COLLECTION LINES SHALL BE NO LESS THAN 1.0% WITH CLEANOUTS EVERY 75 LINEAL FEET.


WATER:

- 1. WATERLINES WILL BE 3' OFF CURB AND GUTTER UNLESS SHOWN OTHERWISE.
- 2. LAY WATER MAINS AT LEAST 10 FEET LATERALLY FROM EXISTING OR PROPOSED SANITARY SEWERS. IF LOCAL CONDITIONS OR BARRIERS PREVENT A 10 FOOT SEPARATION, LAY THE WATER MAIN WITH AT LEAST 18" VERTICAL SEPARATION ABOVE THE TOP OF THE SANITARY SEWER PIPE EITHER IN A SEPARATE TRENCH OR IN THE SAME TRENCH ON A BENCH OF UNDISTURBED EARTH.
- 3. WHEN A PROPOSED WATER MAIN CROSSES OVER A PROPOSED OR EXISTING SANITARY SEWER, LAY THE WATER MAIN WITH AT LEAST 18" VERTICAL SEPARATION ABOVE THE TOP OF THE SANITARY SEWER. IF LOCAL CONDITIONS PREVENT AN 18" VERTICAL SEPARATION, CONSTRUCT BOTH THE WATER MAIN AND THE SANITARY SEWER FOR A DISTANCE OF 10 FEET ON EACH SIDE TO THE POINT OF CROSSING WITH FERROUS PIPE HAVING WATER MAIN QUALITY JOINTS.
- 4. WHEN A PROPOSED WATER MAIN CROSSES UNDER A PROPOSED OR EXISTING SANITARY SEWER, CONSTRUCT BOTH THE WATER MAIN AND THE SANITARY SEWER OF FERROUS MATERIALS WITH JOINTS THAT ARE EQUIVALENT TO WATER MAIN STANDARDS FOR A DISTANCE OF 10 FEET ON EACH SIDE OF THE POINT OF CROSSING. CENTER THE SECTION OF WATER PIPE AT THE POINT OF CROSSING.
- 5. MAINTAIN A MINIMUM COVER OF 36" AND MAXIMUM COVER OF 42" BELOW FINISHED GRADE OVER ALL PIPES UNLESS OTHERWISE DIRECTED OR SHOWN ON THE PLANS. DUE TO THE HEIGHTS OF VALVES, INCREASE THE COVER DEPTHS ADJACENT TO THE VALVES OR VARIED AT POINTS OF TIE-IN TO EXISTING LINES.
- 6. ALL FDC(S) AND HYDRANT(S) SHALL BE SIAMESE CONNECTIONS AND MEET TOWN OF CHAPEL HILL AND OWASA STANDARDS.
- 7. A FIRE SPRINKLER SYSTEM WILL BE REQUIRED FOR THE HOTEL.

8. A PERMIT FROM THE CHAPEL HILL FIRE MARSHAL'S OFFICE IS REQUIRED TO INSTALL ANY NEW UNDERGROUND OR ABOVE-GROUND TANKS THAT CONTAINED FLAMMABLE/COMBUSTIBLE LIQUIDS. 2018 NC FIRE CODE SECTION 105.6.17.

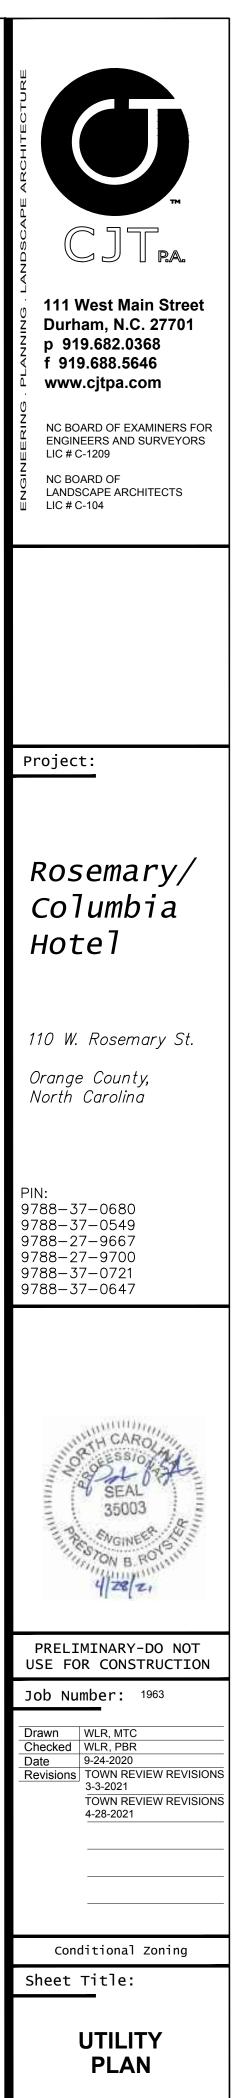

Sheet Number

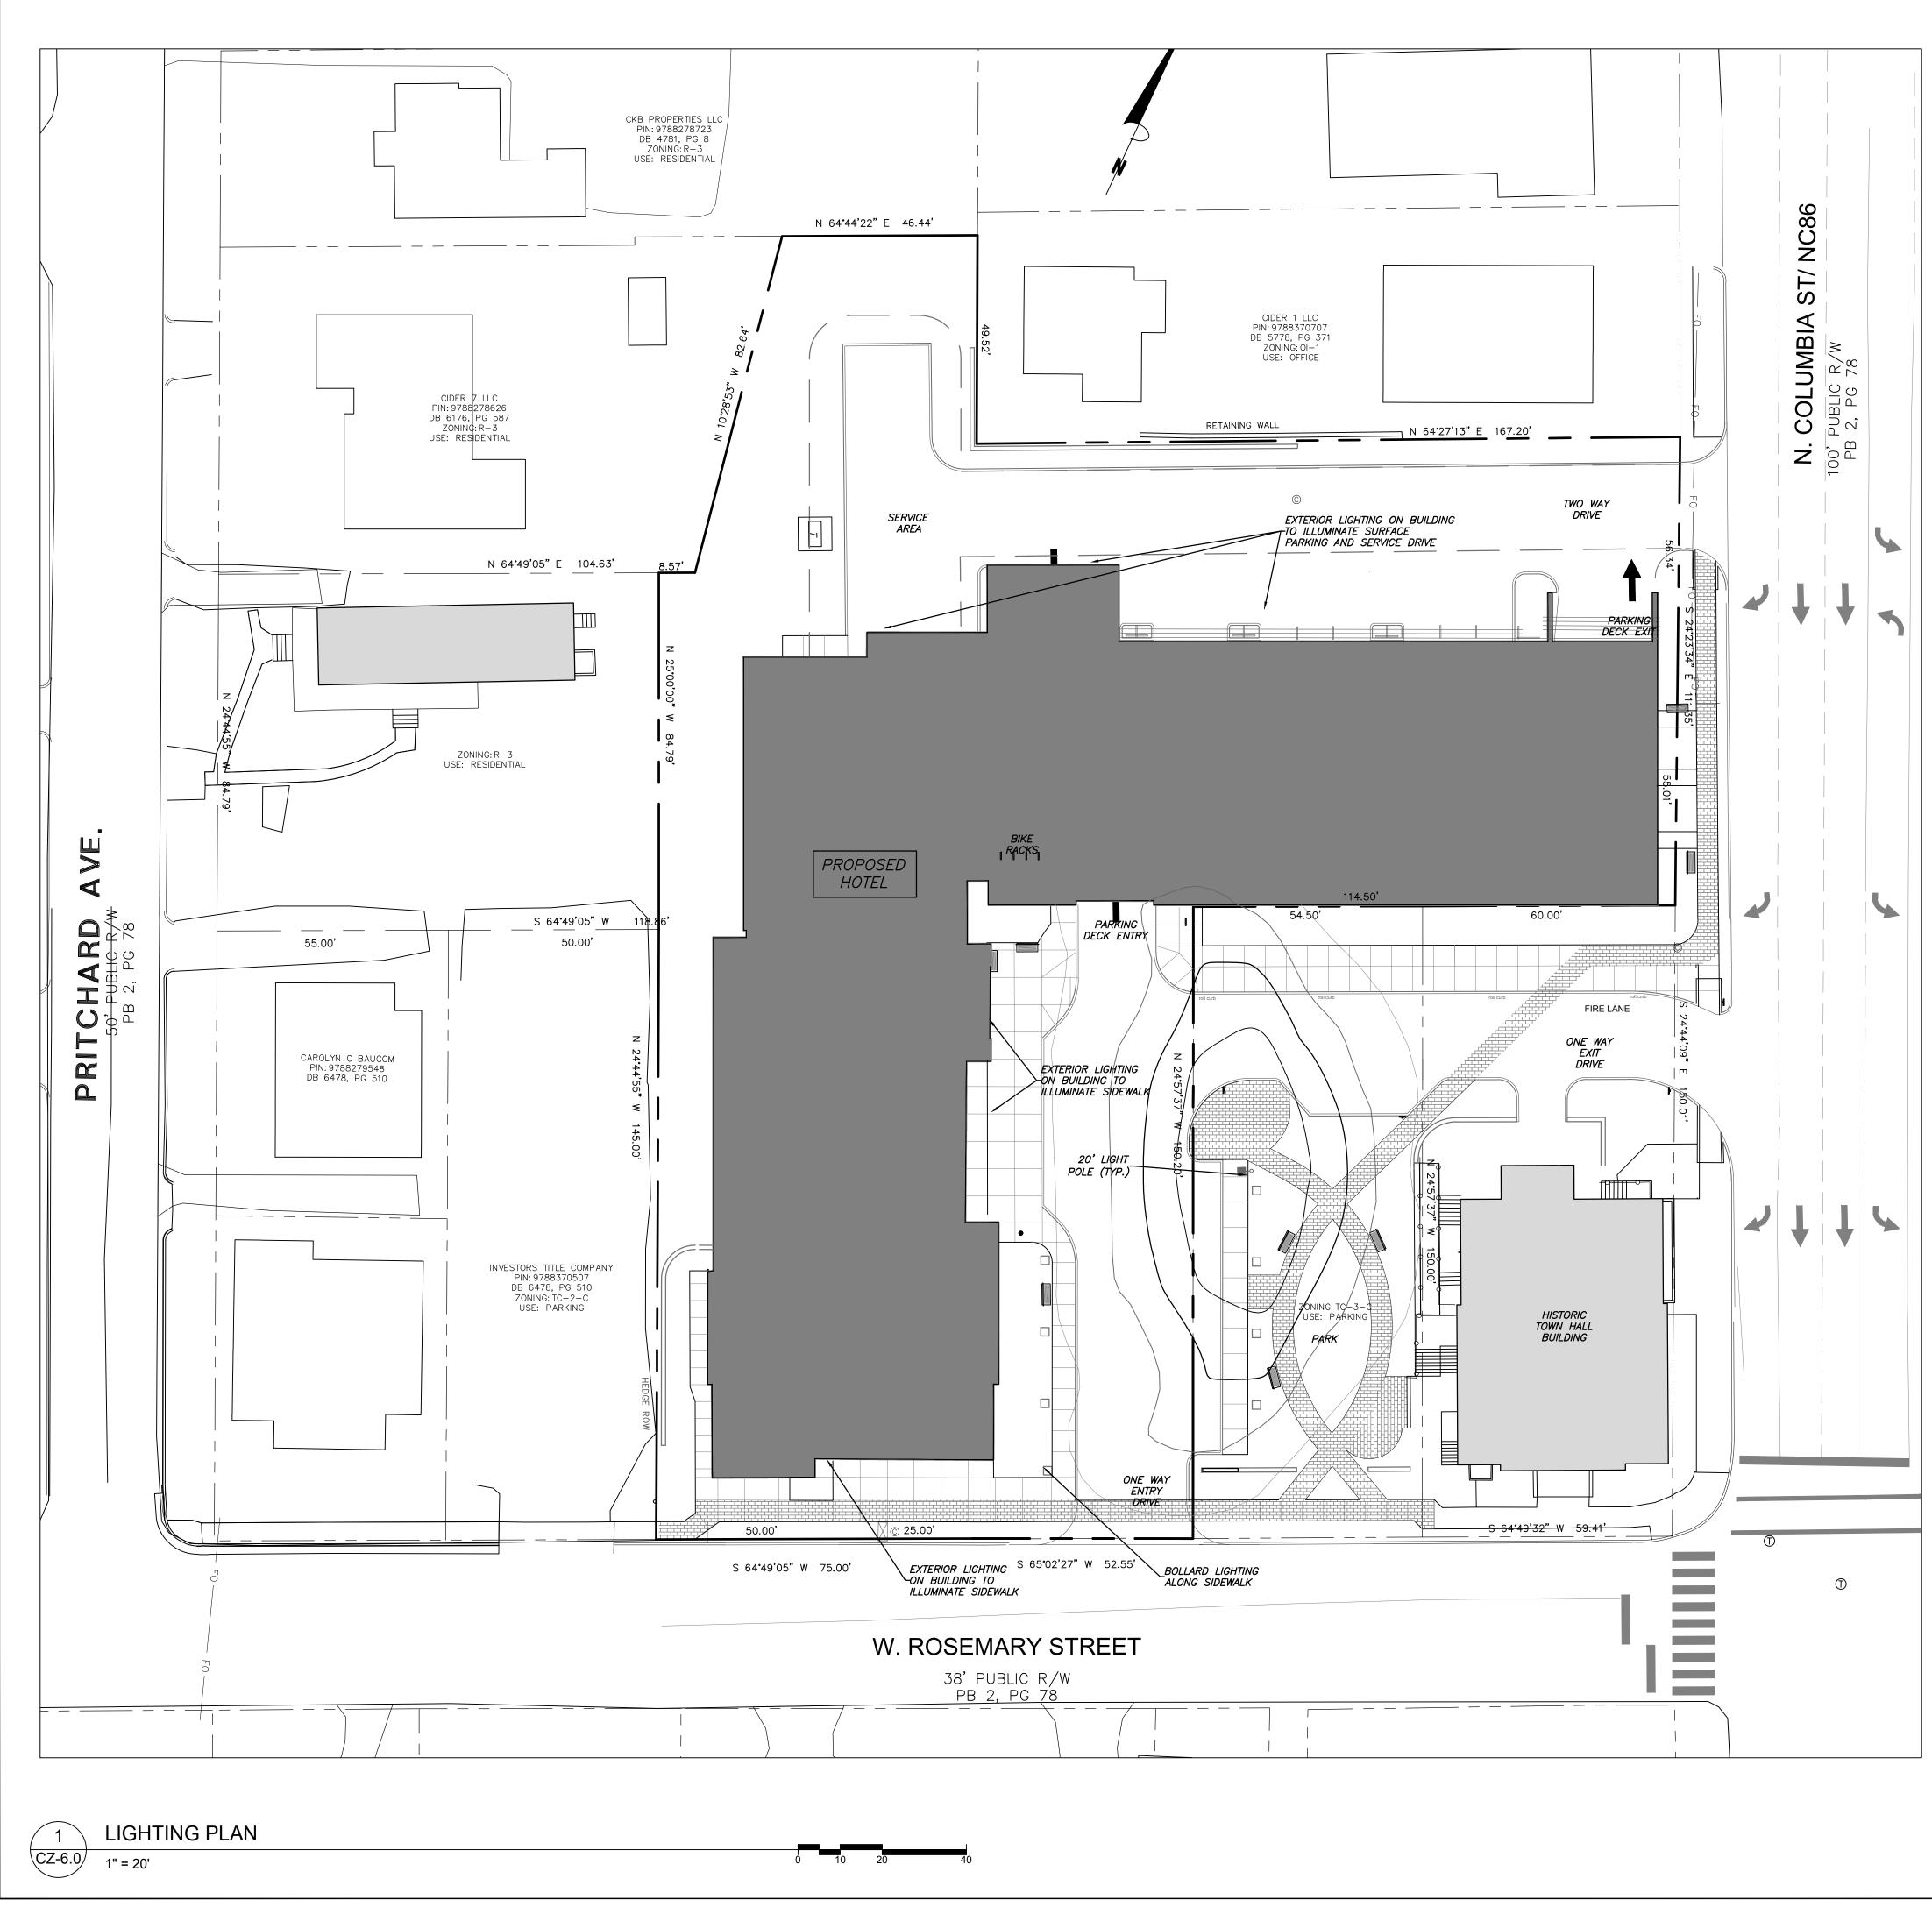

LEGEND

FIXTURE ON 25' POLE 2-FC 1-FC-.5-FC-.25-FC-

LIGHTING NOTES

LIGHTING CONDUIT


- LIGHTING CONDUIT SHALL MEET THE FOLLOWING GUIDELINES.
- 1. CONDUIT DESIGN MUST BE APPROVED BY DUKE ENERGY PRIOR TO INSTALLATION. CHANGING THE CONDUIT LAYOUT CAN CAUSE CONDUCTOR LENGTH TO EXCEED ACCEPTABLE VOLTAGE LEVEL WHICH WILL AFFECT THE LIGHT'S ABILITY TO OPERATE.
- 2. ALL CONDUITS ARE TO BE 2" SCHEDULE 40 GRAY ELECTRICAL PVC.
- 3. ALL JOINTS ARE TO BE GLUED.
- 4. ALL ENDS ARE TO BE MARKED WITH SCRAP CONDUIT OR A BOARD (PAINTING THE GROUND WITH MARKING PAINT IS NOT ACCEPTABLE). IT IS STRONGLY SUGGESTED THAT THE ENDS SHOULD BE IDENTIFIED BY GPS COORDINATES.
- 5. ALL ENDS ARE TO BE CAPPED TO PREVENT ENTRY OF DEBRIS.
- 6. ALL CONDUITS MORE THAN 30' IN LENGTH SHALL HAVE A STRING INSTALLED.
- 7. TO COMPLY WITH NESC; ALL CONDUIT ARE TO BE INSTALLED AT A MINIMUM DEPTH OF 30" FROM FINISH GRADE TO TOP OF CONDUIT. CONDUITS THAT CAN NOT MEET THIS CRITERIA MUST BE INCASED IN 3" MINIMUM CONCRETE ENVELOPE. (FLOWABLE FILL IS ACCEPTABLE IN PLACE OF CONCRETE).
- 8. IF CONCRETE ENCASED CONDUIT IS REQUIRED AT ANY POINT, IT MUST BE ENCASED IN CONCRETE UNTIL PIPE IS BACK DOWN TO REQUIRED DEPTH.
- 9. PEDESTAL AREAS WHERE MULTIPLE CONDUIT ENDS TERMINATE ARE TO HAVE THE CONDUIT ENDS WITHIN 12" OF EACH OTHER.
- 10.DIRECT BURIED LIGHT POLE AREAS ARE TO HAVE CONDUITS TERMINATE 36" APART AND 12" BACK OF POLE LOCATION.
- 11.CONDUITS SERVING LIGHTS ON CONCRETE REVEALS ARE TO BE CONTINUOUS FROM REVEAL TO REVEAL.


LIGHTING NOTES


- 1. MEASURES SHALL BE PROVIDED TO PREVENT LIGHT SPILLOVER ONTO ADJACENT PROPERTIES AND GLARE TOWARD MOTOR VEHICLE OPERATORS. EXTERIOR LIGHTS SHALL BE SHIELDED SO THEY DO NOT CAST DIRECT LIGHT BEYOND THE PROPERTY LINE.
- 2. PROVIDE 2" PVC CONDUIT UNDER PAVEMENT, UNDER HEAVILY LANDSCAPED AREAS AS NECESSARY, AND AS DETERMINED BY DUKE ENERGY TO PROVIDE ACCESS TO ALL LIGHT FIXTURES. COORDINATE WITH DUKE ENERGY TO FINALIZE CONDUIT LOCATIONS AND LENGTHS.

SPECIAL COORDINATION NOTES:

- 1. CONTRACTOR IS TO COORDINATE LIGHT POLE AND CONDUIT LOCATIONS WITH DUKE ENERGY PRIOR TO INSTALLATION OF WALLS AND PAVING.
- 2. ABOVE GROUND PEDESTALS AND LIGHT POLES WILL BE PROVIDED AND INSTALLED BY DUKE ENERGY.
- 3. CONTRACTOR IS TO REFER TO DUKE ENERGY SPECIFICATIONS FOR CONDUIT INSTALLATION.
- 4. CONDUIT IS TO BE FURNISHED AND INSTALLED BY CONTRACTOR.

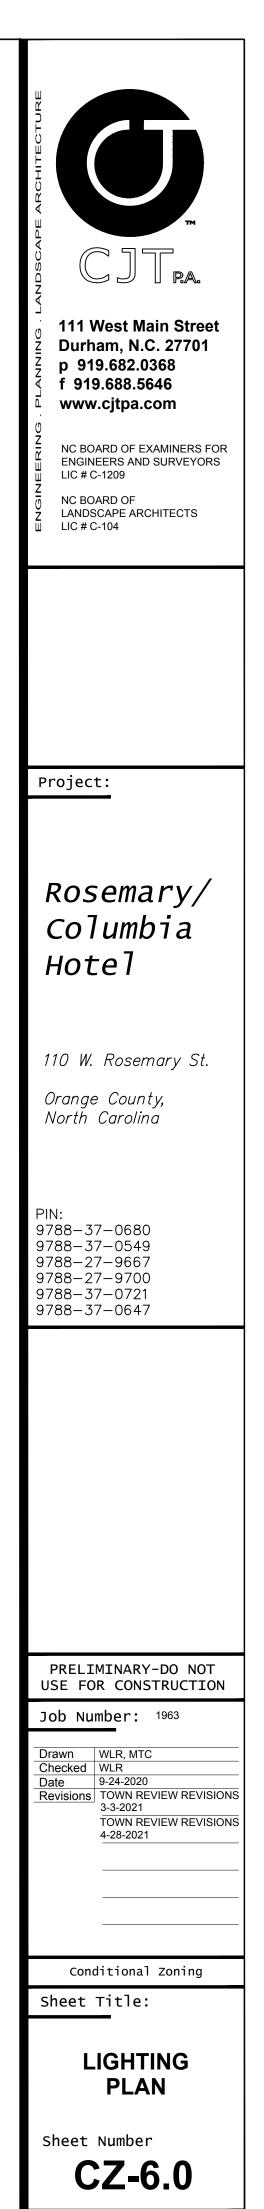

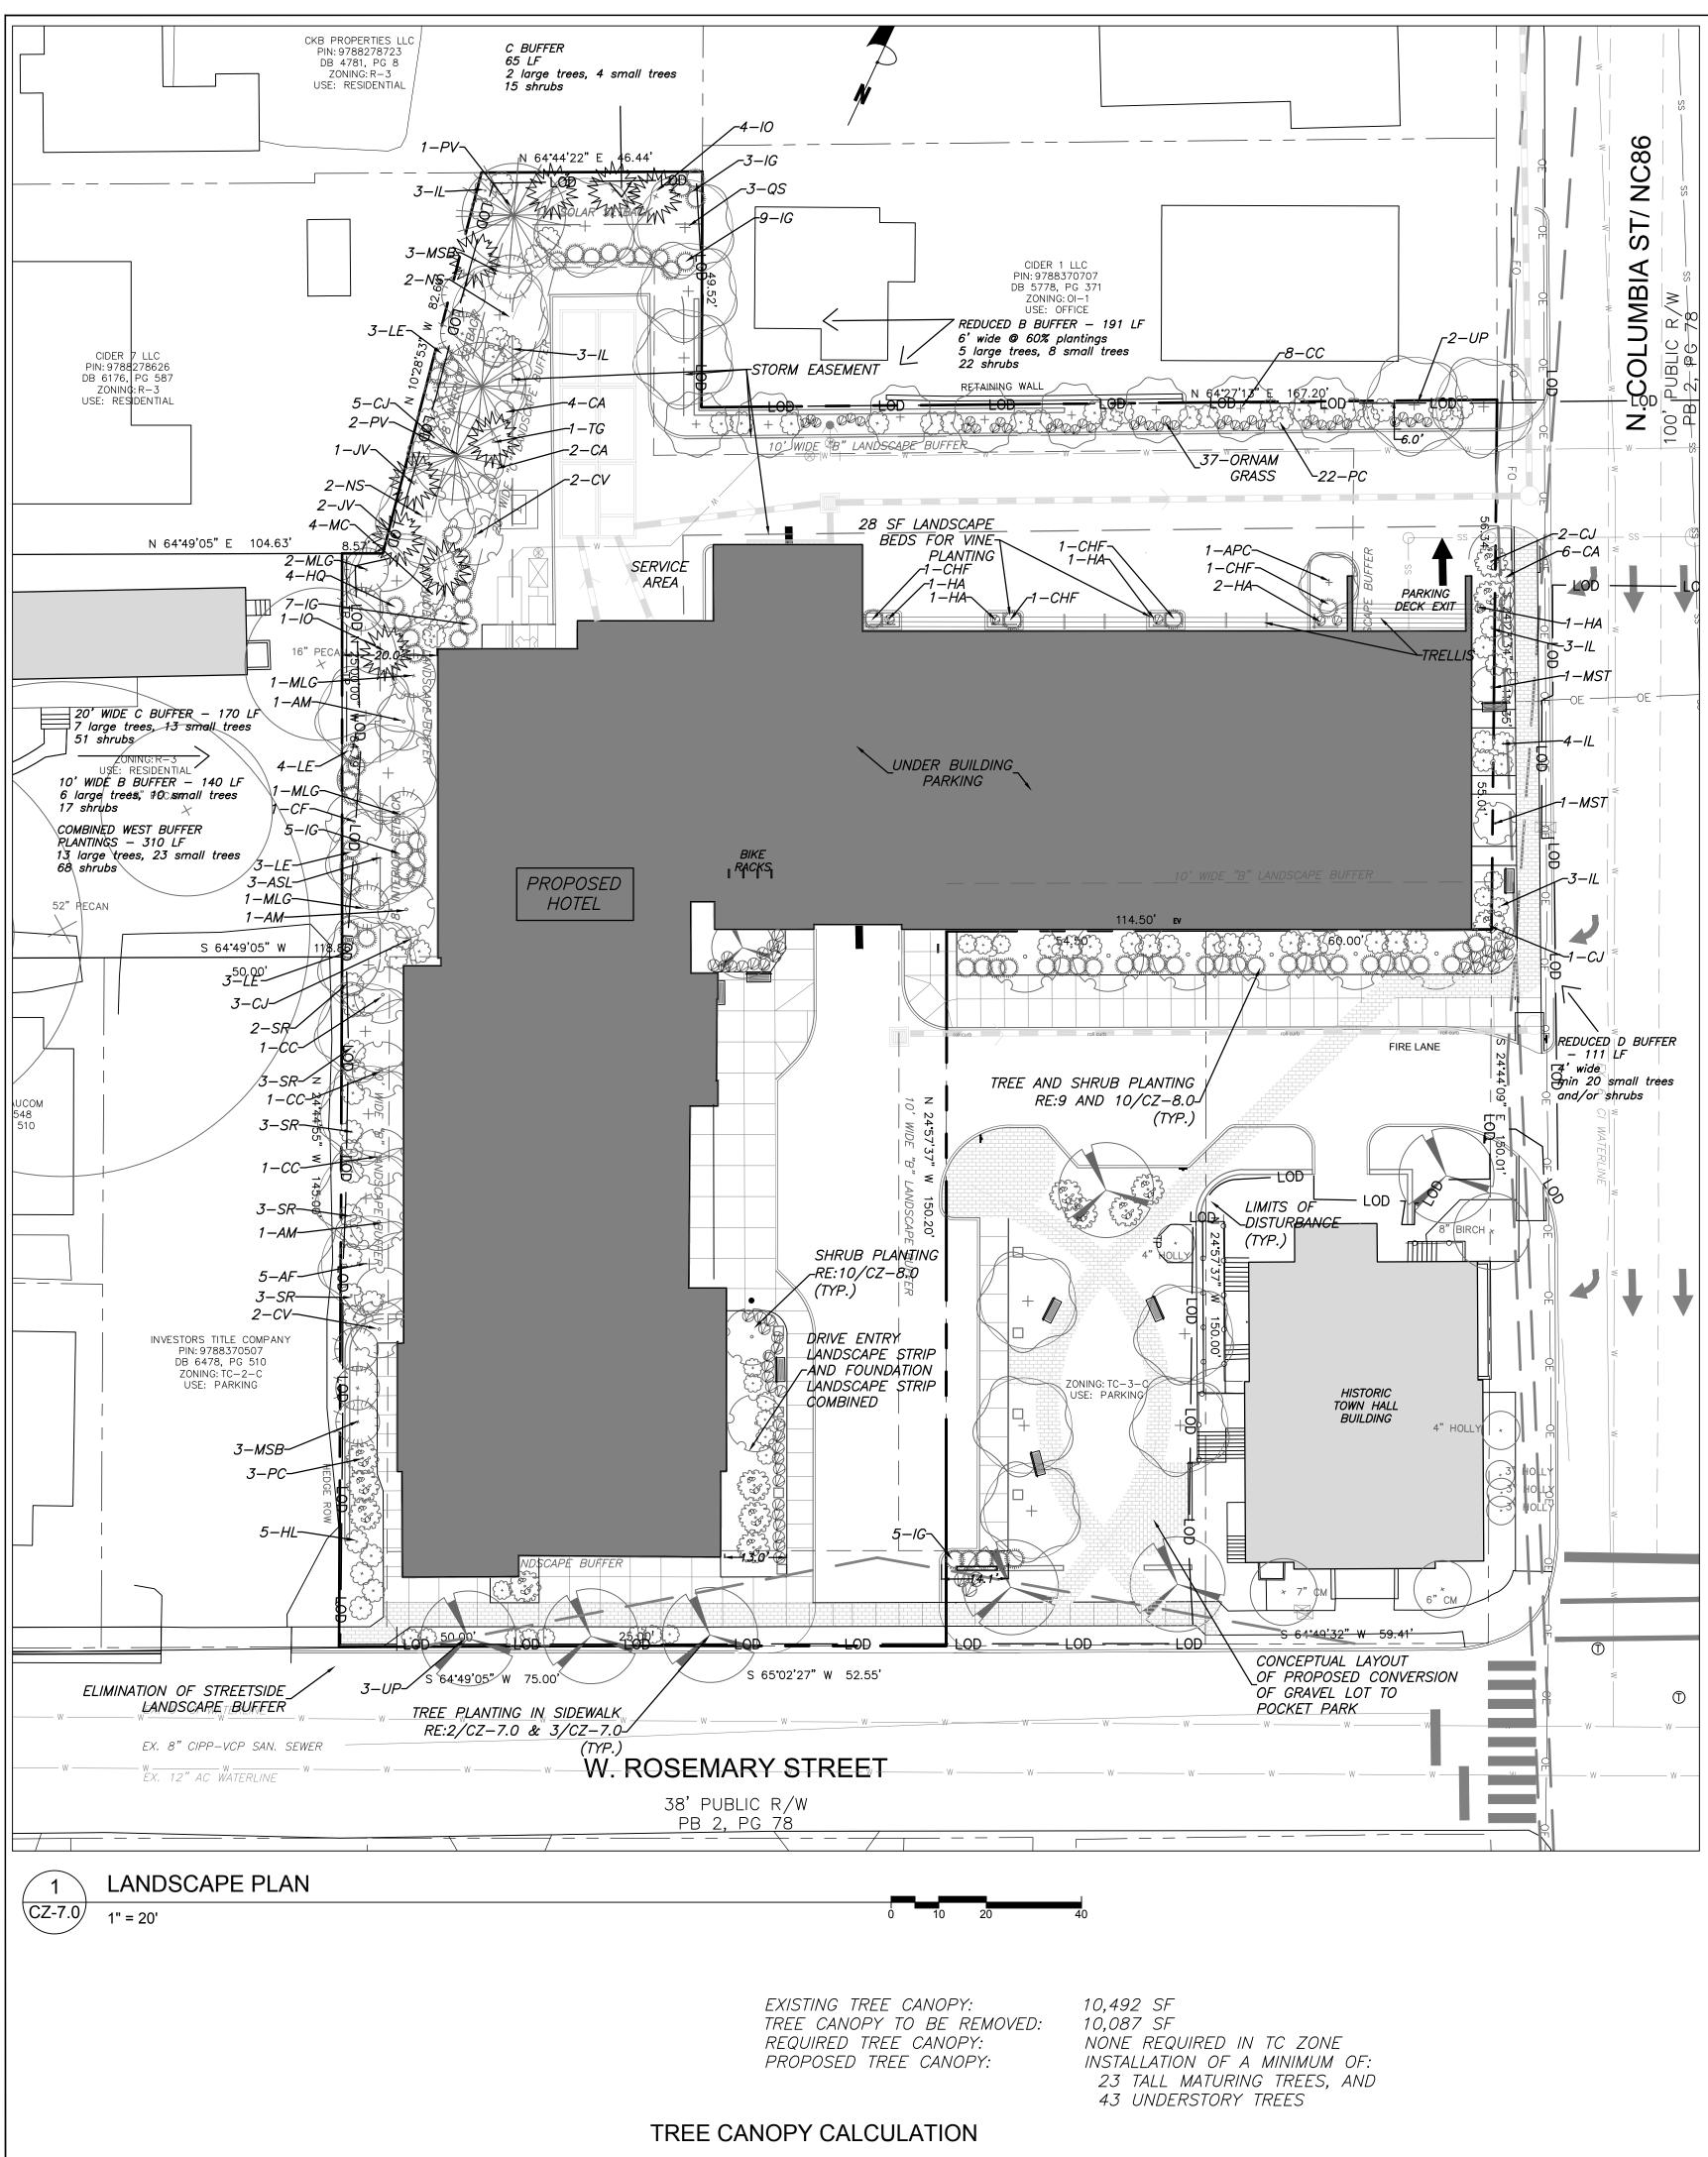

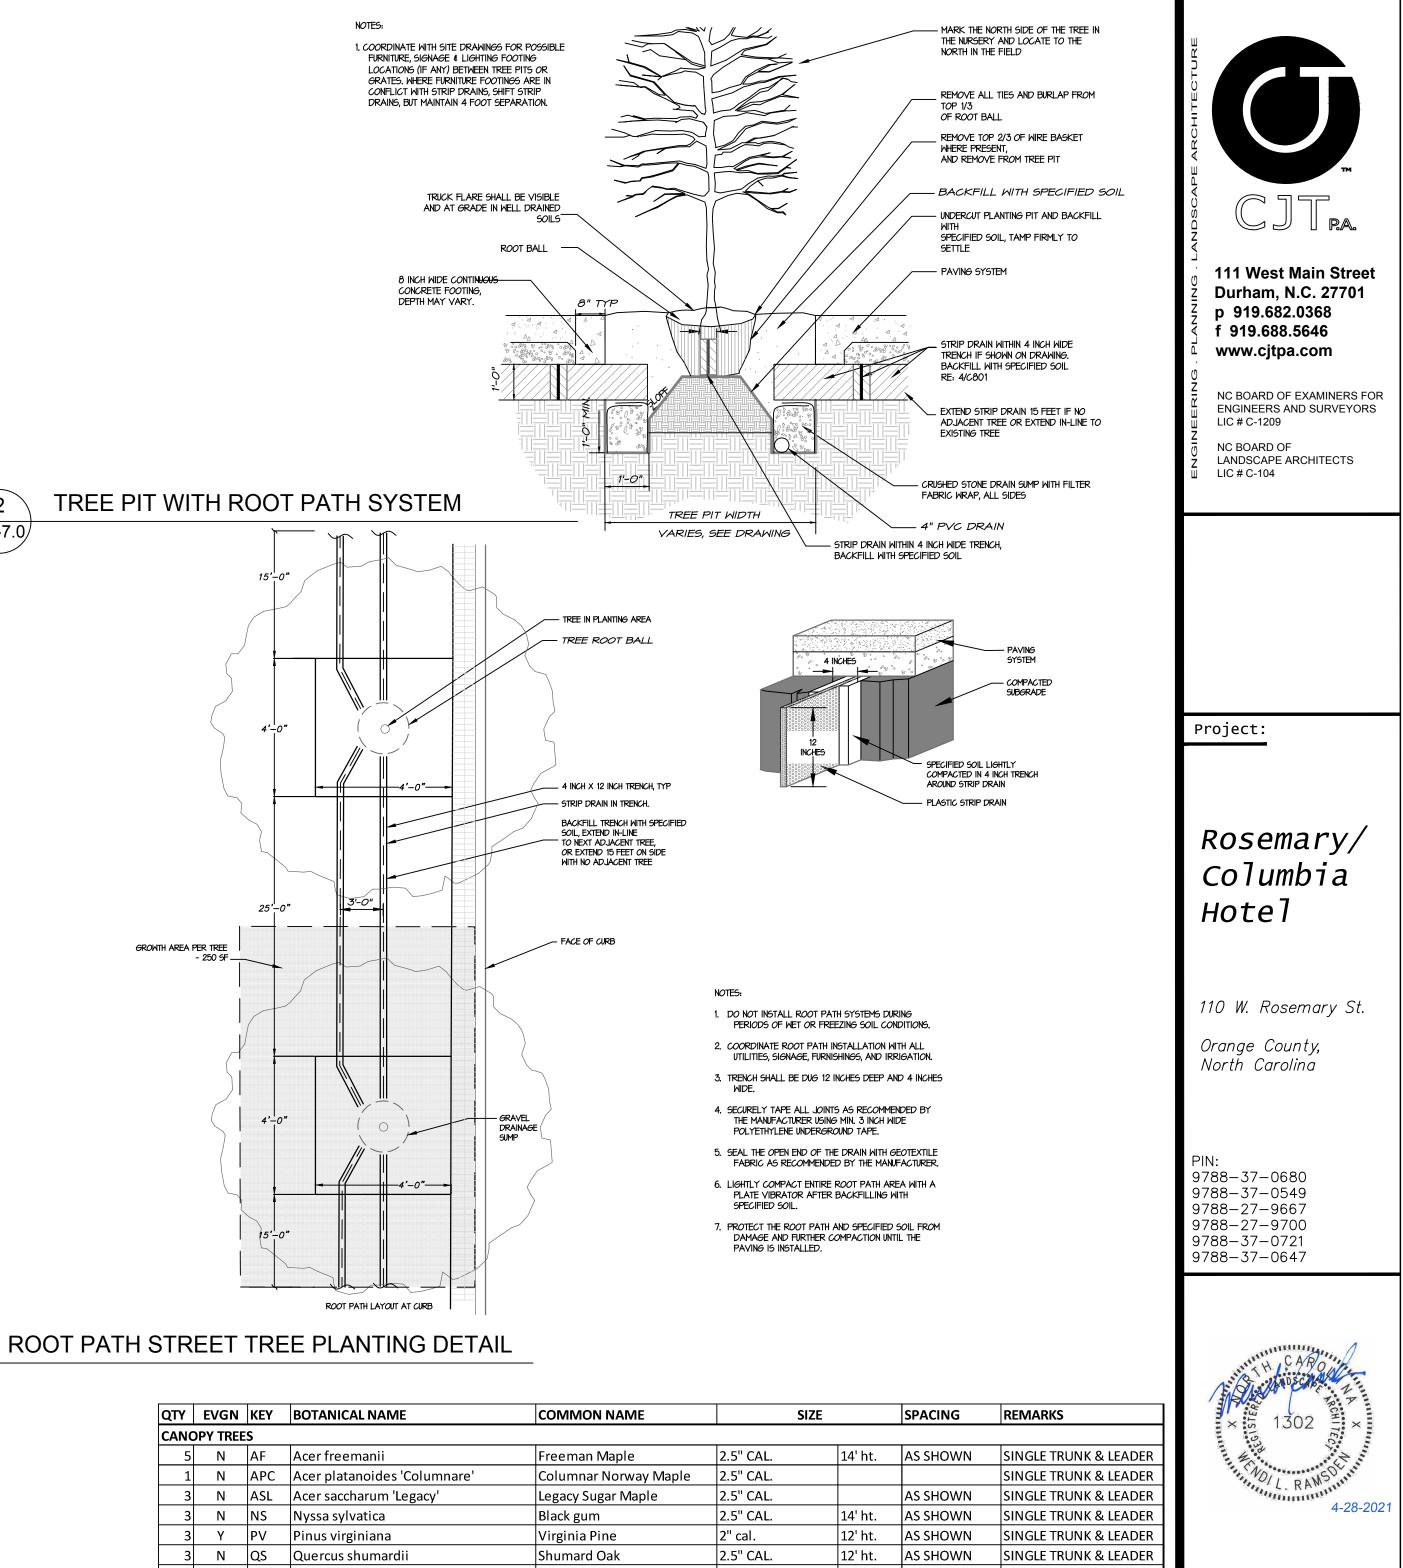

3 CZ-7.0

2

CZ-7.0


QTY	EVGN	KEY	BOTANICAL NAME		SIZE		SPACING	REMARKS
CANOPY TREES								
5	N	AF	Acer freemanii	Freeman Maple	2.5" CAL.	14' ht.	AS SHOWN	SINGLE TRUNK & LEADER
1	Ν	APC	Acer platanoides 'Columnare'	Columnar Norway Maple	2.5" CAL.			SINGLE TRUNK & LEADER
3	Ν	ASL	Acer saccharum 'Legacy'	Legacy Sugar Maple	2.5" CAL.		AS SHOWN	SINGLE TRUNK & LEADER
3	Ν	NS	Nyssa sylvatica	Black gum	2.5" CAL.	14' ht.	AS SHOWN	SINGLE TRUNK & LEADER
3	Y	PV	Pinus virginiana	Virginia Pine	2" cal.	12' ht.	AS SHOWN	SINGLE TRUNK & LEADER
3	Ν	QS	Quercus shumardii	Shumard Oak	2.5" CAL.	12' ht.	AS SHOWN	SINGLE TRUNK & LEADER
5	Ν	UP	Ulmus americana 'Princeton'	Princeton American Elm	2.5" CAL.	14' ht.	AS SHOWN	SINGLE TRUNK & LEADER
23								
UNDE	RSTORY	TREES		r	1		1	
3	N	AM	Amerlanchier arborea	Serviceberry	1" cal.	8' HT.	AS SHOWN	MULTI-TRUNK
11	Ν	CC	Cercis canadensis 'Hears of Gold'	Hearts of Gold Redbud	1" cal.	8' HT.	AS SHOWN	SINGLE TRUNK & LEADER
1	Ν	CF	Cornus florida	Dogwood	1" cal.	8' HT.	AS SHOWN	
4	Ν	CV	Chionanthus virginiana	Fringetree	1" cal.	8' HT.	AS SHOWN	
5	Y	10	Ilex opaca	American Holly	1" cal.	6' HT.	8' O.C.	SINGLE TRUNK & LEADER
3	Y	JV	Juniperus virginiana	Eastern Redcedar		8' HT.	AS SHOWN	FULL AND MATCHING
4	Ν	MC	Myrica cerifera	Eastern Waxmyrtle		8' HT.	AS SHOWN	FULL
5	Y	MLG	Magnolia grandiflora 'Little Gem'	Little Gem Magnolia	1.5" cal.	8' ht.	10' O.C.	FULL AND MATCHING
6	Y	MSB	Magnolia virginiana	Sweetbay Magnolia	1.5" cal.	8' ht.	AS SHOWN	FULL
2	Ν	MST	Magnolia stellata 'Royal Star'	Royal Star Magnolia		5' ht		FULL
1	Y	TGG	Thuja x Green Giant	Green Giant Arborvitae	1.5" cal.	8' ht.	10' O.C.	FULL
45								
SHRU	BS							
11	Ν	CA	Callicarpa americana	American Beautyberry	24" ht.		5' o.c.	FULL AND MATCHING
4	Y	CHF	Cephalotaxus harringtonia 'Fastigiata'	Upright Plum Yew	36" ht.		AS SHOWN	FULL AND MATCHING
11	Y	CJ	Camellia x 'Taylor's Perfection'	Taylor's Perfection Camellia	24" ht		5' o.c.	FULL AND MATCHING
6	Ν	HA	Hydrangea anomala ssp. Petiolaris	Climbing Hydrangea	3 gal		AS SHOWN	
5	N	HL	Hydrangea paniculata 'Jane'	Little Lime Hardy Hydrangea	24"		4' o.c.	FULL AND MATCHING
4	Y	HQ	Hydrangea quercifolia	Oakleaf Hydrangea	24" ht		5' o.c.	FULL AND MATCHING
24	Y	IG	Ilex glabra	Inkberry Holly	15" HT.		36" O.C.	FULL AND MATCHING
16	Y	IL	Illicium parvifolia	Anise	24" ht		4' o.c.	FULL AND MATCHING
13	Y	LE	Loropetalum chinense 'Emerald'	Emerald Loropetalum	15" HT.		36" O.C.	FULL AND MATCHING
25	Y	РС	Prunus caroliniana 'Otto Luyken'	Otto Luyken	18" HT.		36" O.C.	FULL AND MATCHING
14	Y	SR	Sarcococca rustica	Sweetbox	18" HT.		36" O.C.	FULL AND MATCHING
0	Ν	WS	Weigeala 'Florida Variegata'	Variegated Weigela	18" HT.		36" O.C.	FULL AND MATCHING
133								


PLANT LIST

PRELIMINARY-DO NOT USE FOR CONSTRUCTION Job Number: ¹⁹⁶³ Drawn WLR, MTC Checked WLR Date 9-24-2020 Revisions TOWN REVIEW REVISIONS 3-3-2021 TOWN REVIEW REVISIONS 4-28-2021 Conditional Zoning Sheet Title:


LANDSCAPE PLAN Sheet Number

CZ-7.0

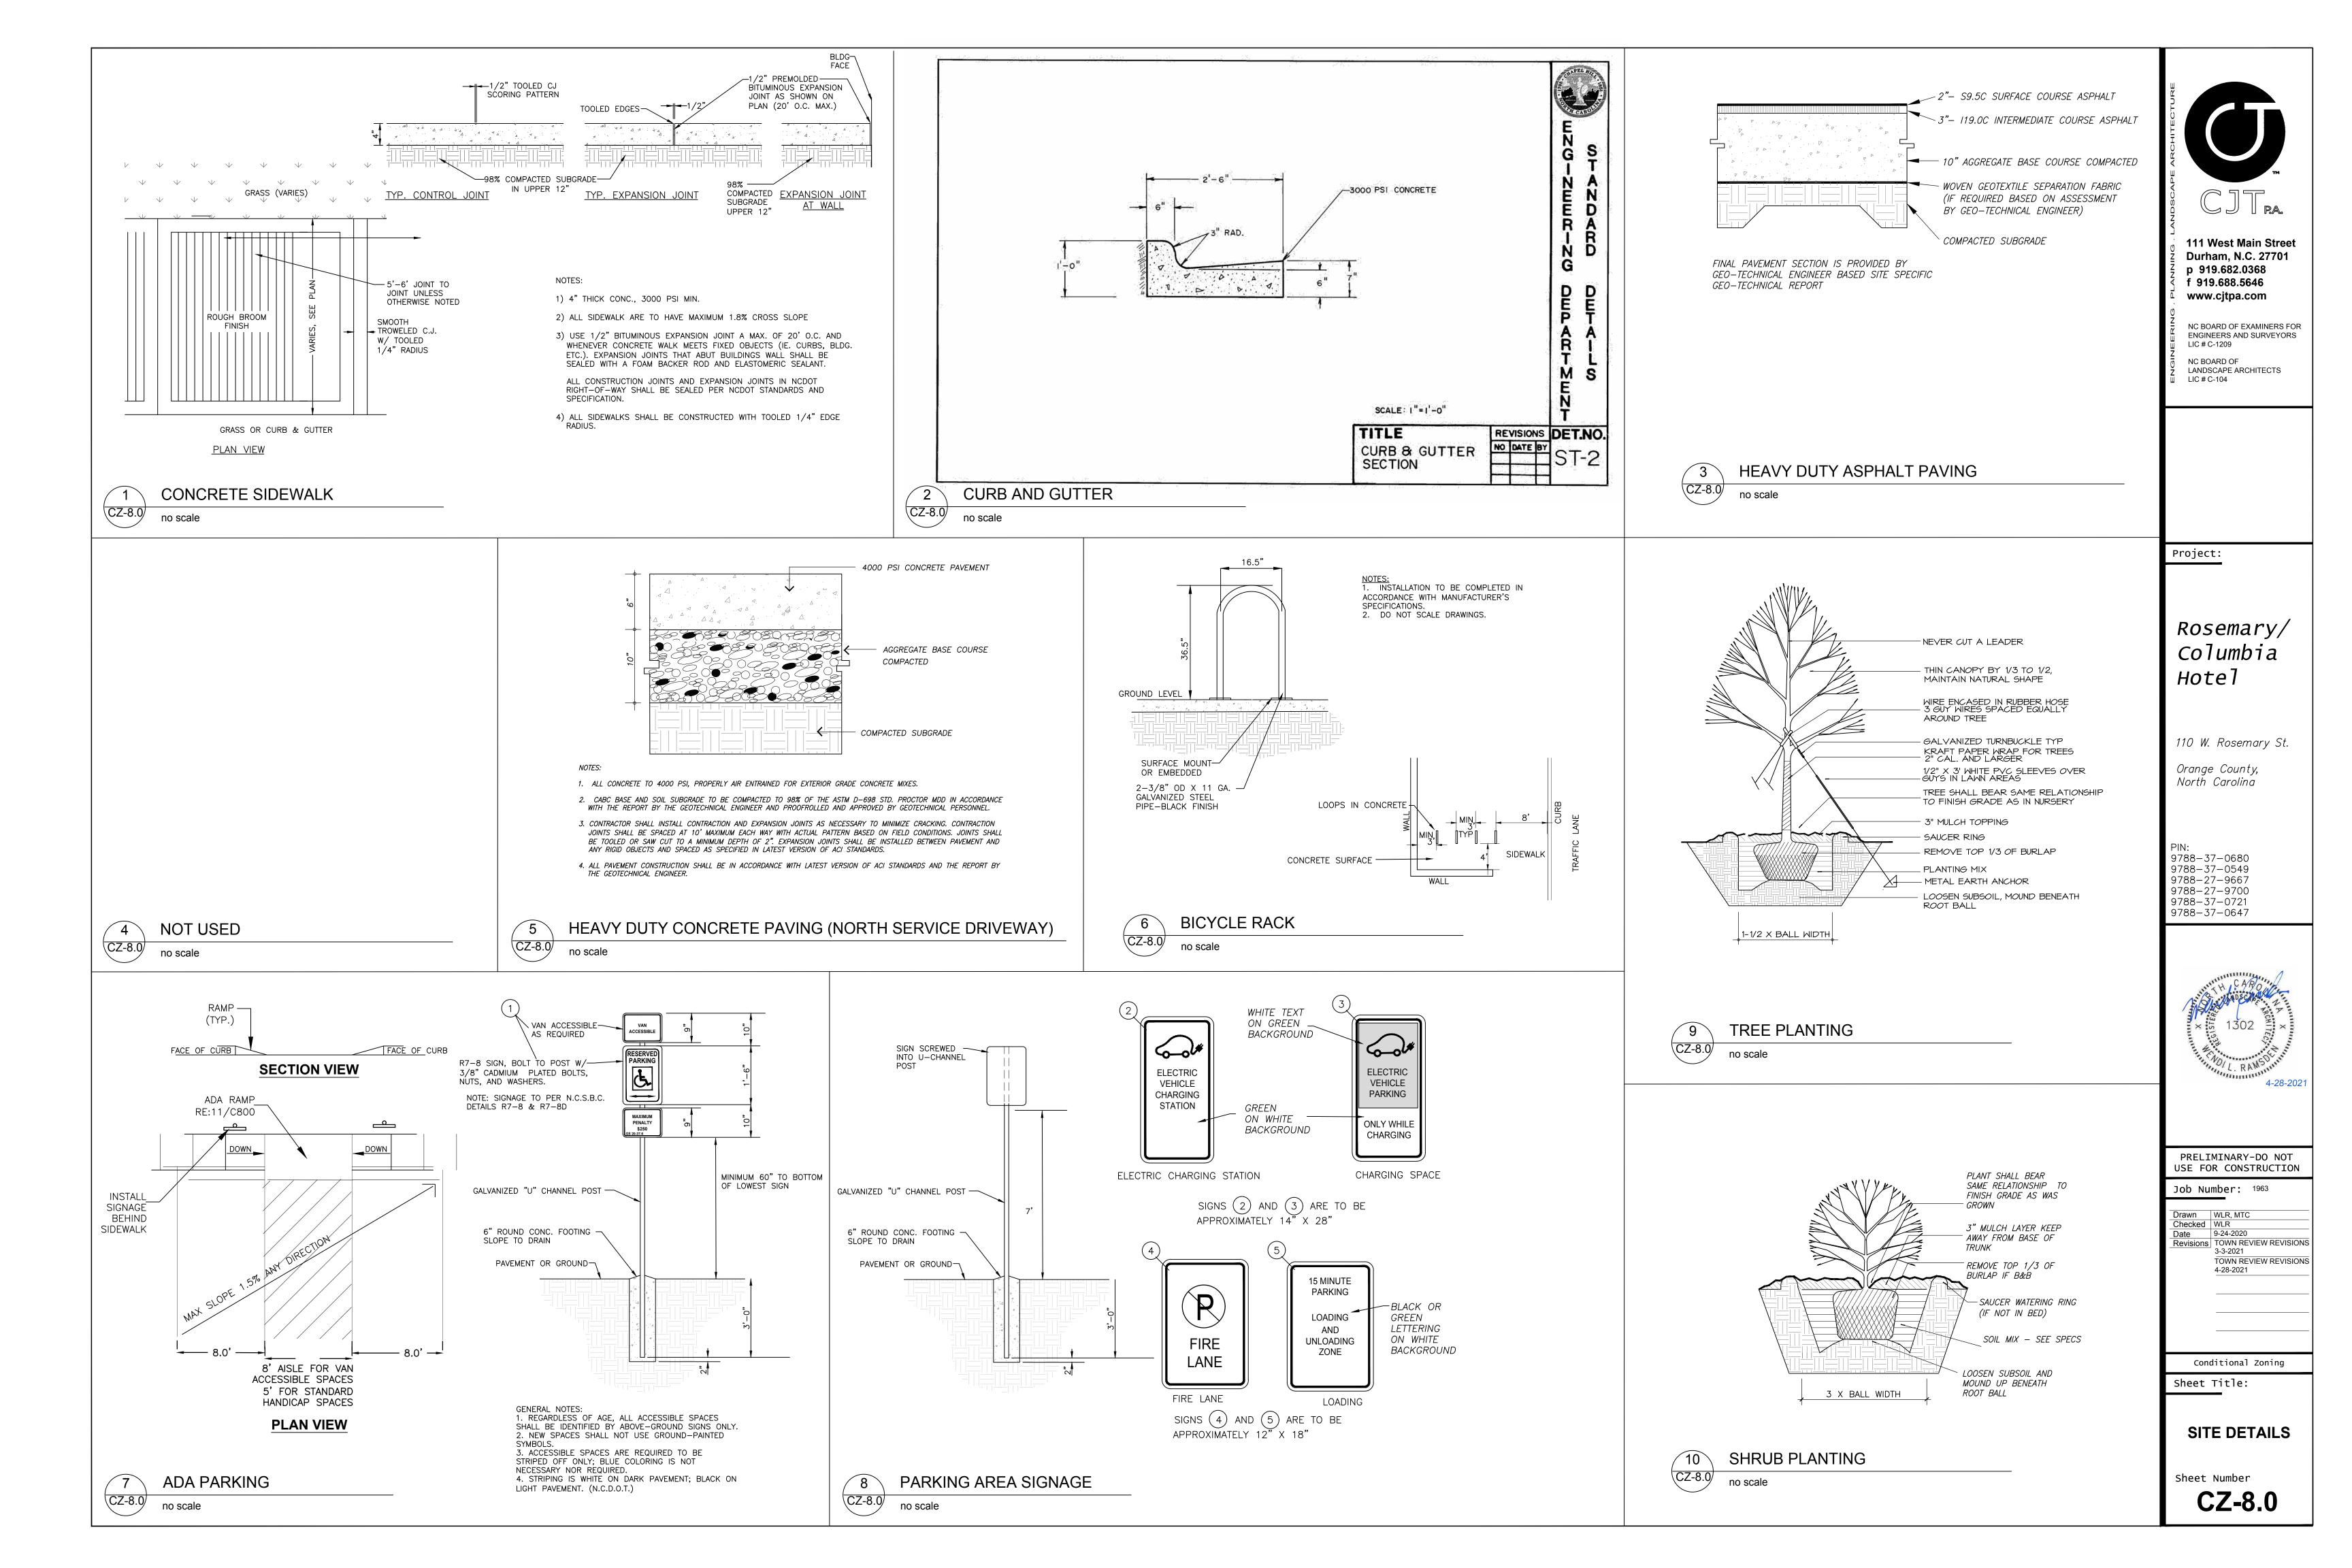

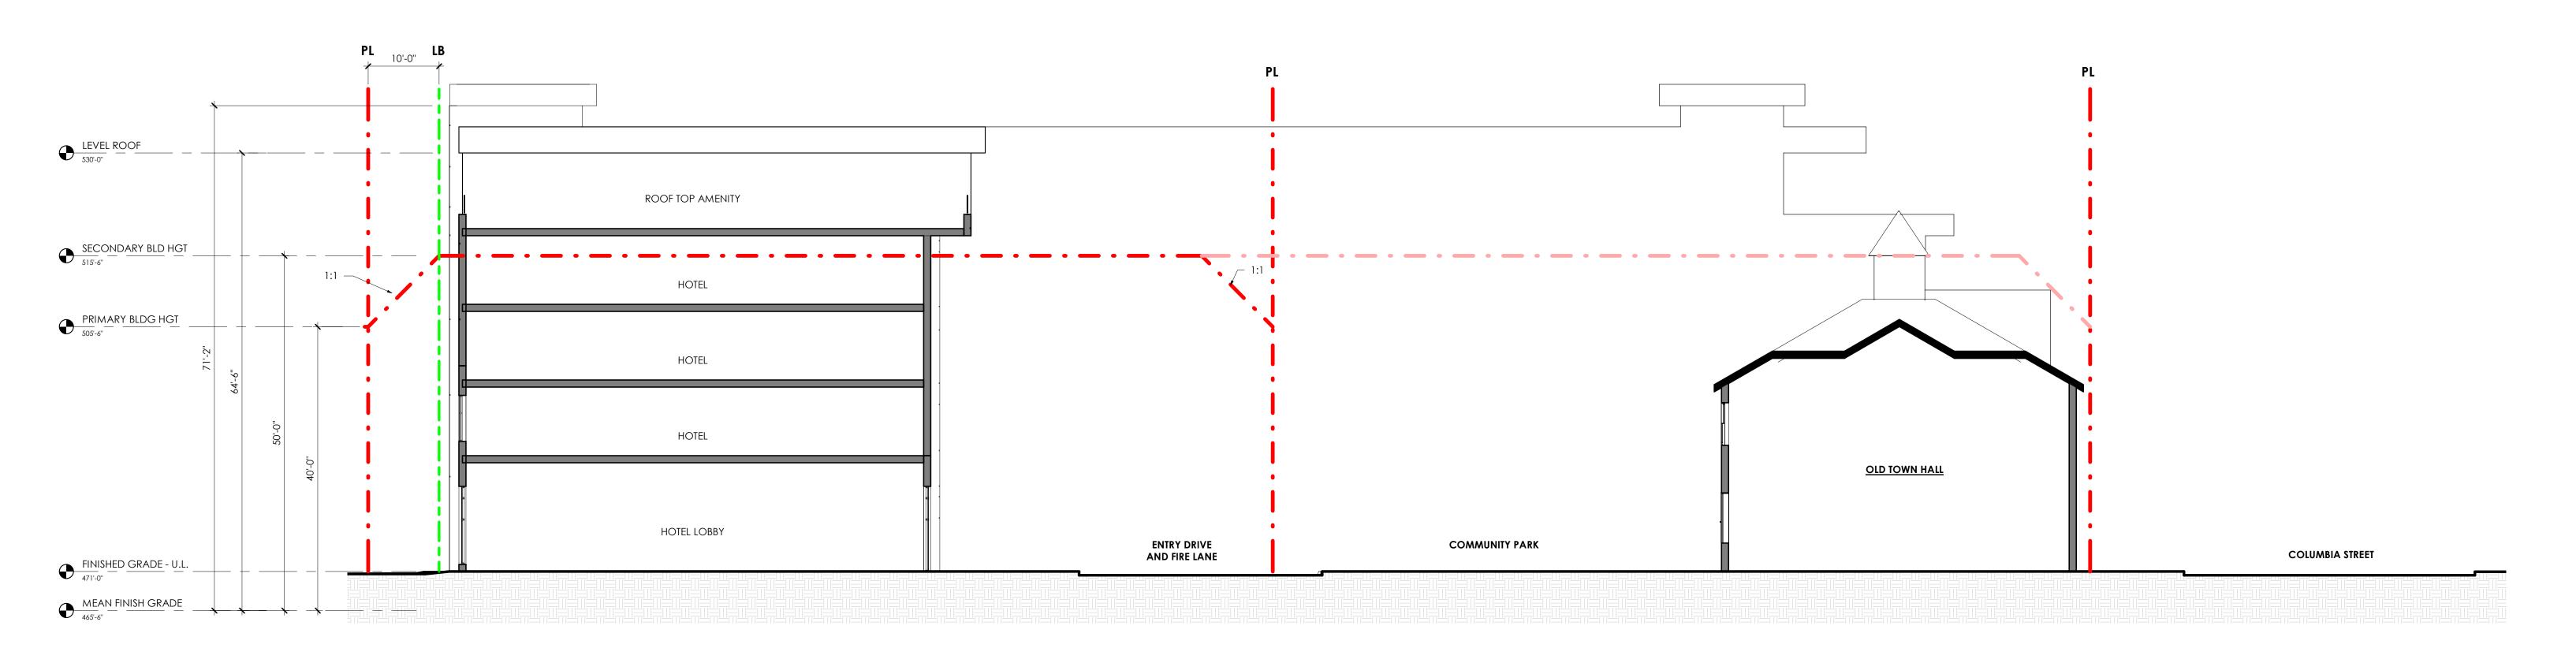

ROSEMARY STREET

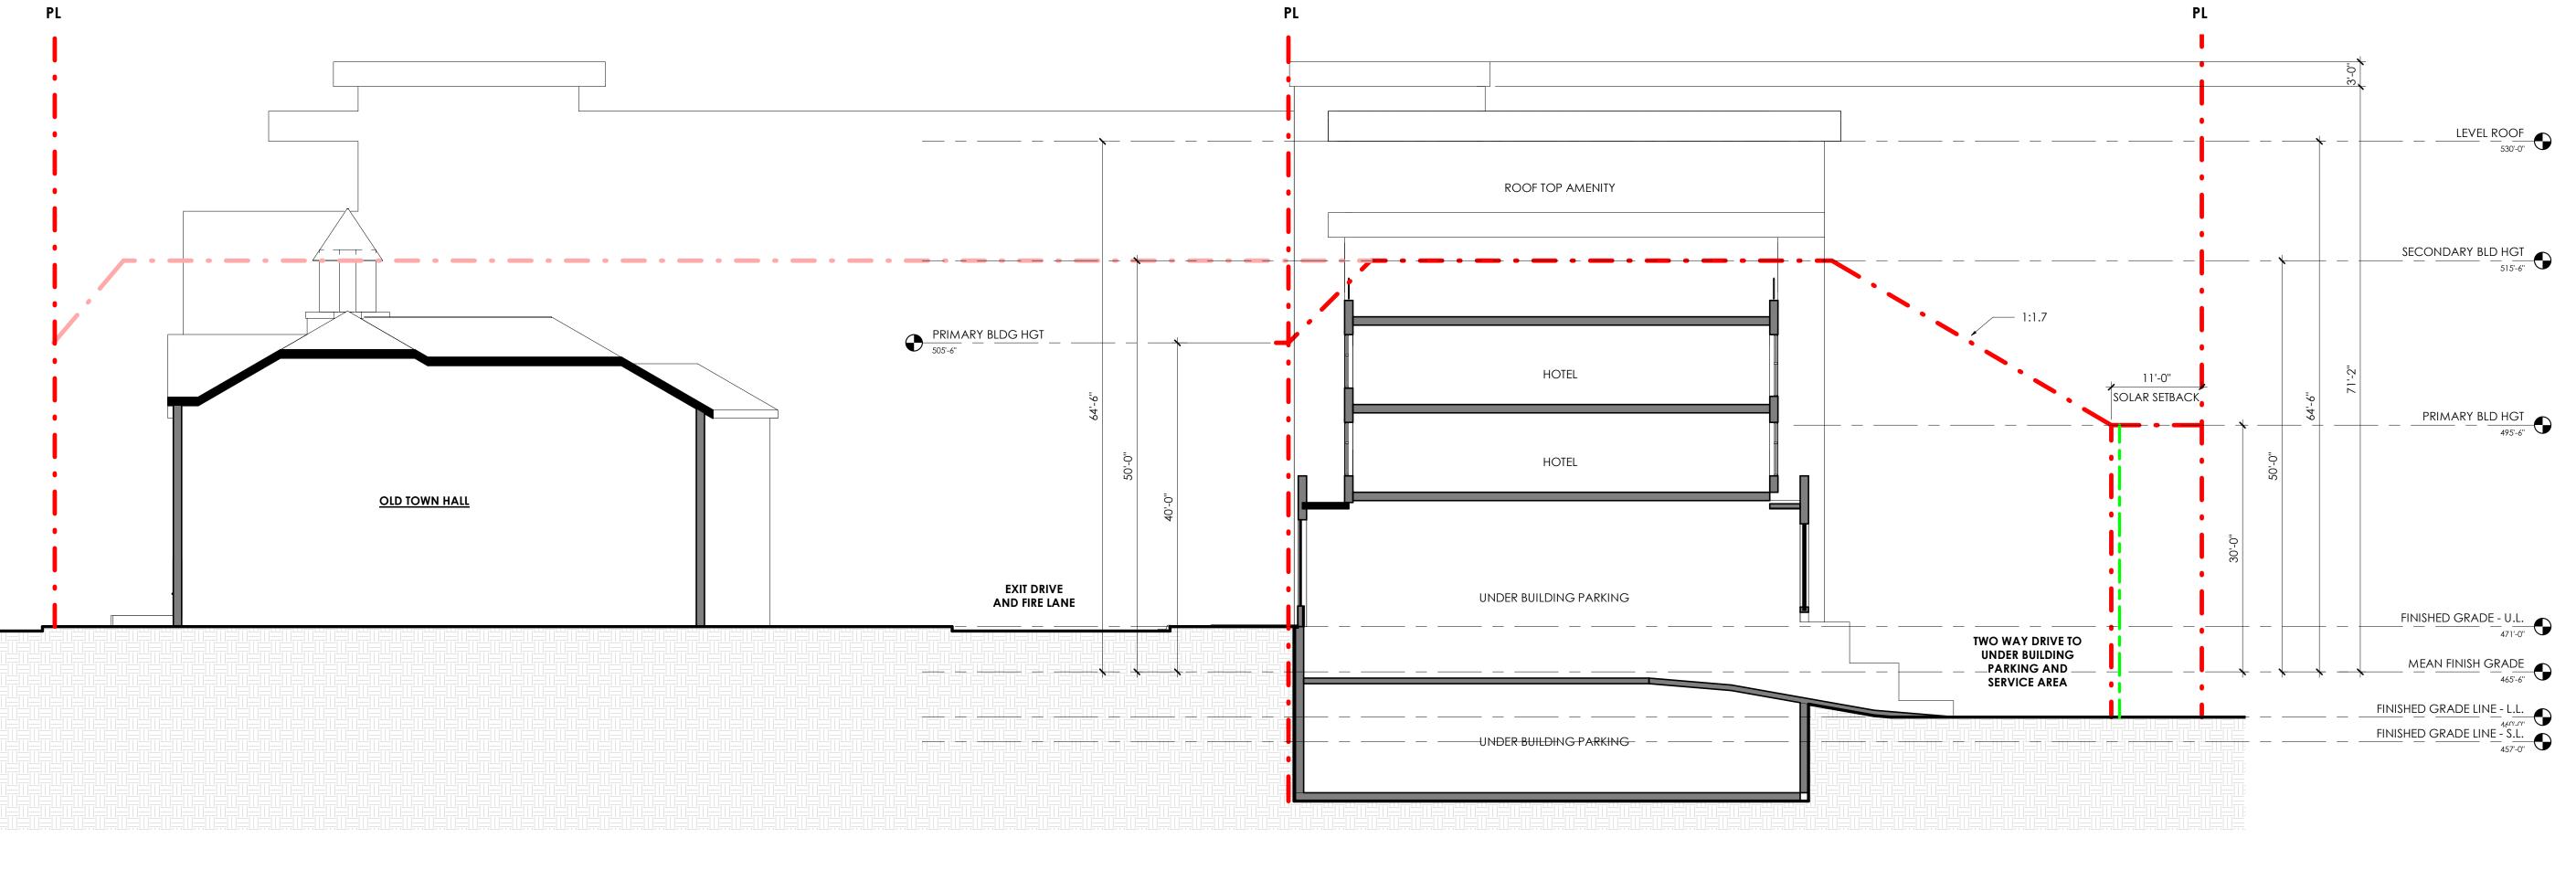

EAST ELEVATION - COLUMBIA WING 3/32" = 1'-0" 2



DURHAM, NC 27701 p 919.682.2870 www.mhaworks.com

ROSEMARY / COLUMBIA HOTEL



LANDSCAPE BUFFER (LB)

SOUTH ELEVATION - ROSEMARY WING 3/32" = 1'-0"

IN TC2 WITHIN NCD THE PRIMARY HEIGHT IS 40' ABOVE MEAN FINISH GRADE WITH A SECONDARY HEIGHT OF 50' EXCEPT WHERE ADJACENT TO "R" ZONING WHERE THE PRIMARY

-ASHEVILLE

THIS PROJECT PROPOSES TO BE WITHIN THE REQUIRED SOLAR OVERLAY OTHER THAN THE

PROVIDING IMPROVED AND CONTINUOUS SIDEWALKS ALONG ROSEMARY ST. EXISTING ROSEMARY ST LIGHTING IS ALREADY IN PLACE. ADDITIONAL LIGHTING WILL BE PROVIDED ON THE BUILDING FACADE TO CREATE A SAFE AND WELCOMING PEDESTRIAN INFRASTRUCTURE WILL BE SCREENED TO MINIMIZE VISIBILITY FROM THE PUBLIC. GUIDELINES RECOMMEND THE FOLLOWING FROM BACK OF CURB ON ROSEMARY ST. 5'

PROPOSES SUBSTANTIAL COMPLIANCE WITH THIS RECOMMENDATION OTHER THAN A PORTION OF THE BUILDING WHICH ENCROACHES INTO THE 5' SUPPLEMENTAL ZONE. ALL OPERATIONS DELIVERIES AND LOADING AREAS WILL BE MANAGED VIA BACK OF

PARKING IS PROPOSED TO BE STRUCTURED AND WILL BE SCREENED TO MINIMIZE VISIBILITY

ALL BUILDING ENTRIES ARE PROVIDED OFF OF PUBLIC STREETS OR PUBLIC AREAS. PEDESTRIAN SCALE SIGNAGE AND AMENITIES WILL BE CONSIDERED AND ENCOURAGED. VERTICAL BAYS, VARIETY IN THE UPPER CORNICE HEIGHTS AND VISUAL BREAKS IN THE

WHERE POSSIBLE, UTILITY SERVICES WILL BE LOCATED BELOW GROUND OR IN THE REAR OF THE PROJECT PROPOSES DEFINING AND ENCOURAGING PEDESTRIAN ACTIVITY ALONG THE THE PROJECT PROPOSES TO ACCENTUATE VISIBLE CORNERS TO CELEBRATE KEY BUILDING

ALL GLAZING AT GROUND LEVEL RETAIL, SERVICE, AND TRADE USES THAT FACE A PUBLIC SPACE WILL HAVE CLEAR GLASS ON AT LEAST 60% OF THEIR FACADE BETWEEN 3 FEET AND 8

PERPENDICULAR SIGNAGE AND PLANTERS AND OR LANDSCAPING WILL BE USED ALONG D. THE USE OF DIFFERENT PAVING TYPES WILL BE UTILIZED TO DELINIATE PUBLIC VS SEMI-

1. GROUND LEVEL GLAZING AROUND PUBLIC SPACES WITH BE CLEAR OR SPANDREL. 2. ALTHOUGH THE PROJECT DOES PROPOSE TO EXCEED THE HEIGHT LIMITS OUTLINED IN THE GUIDELINES AND THE ORDINANCE, THE BUILDING DOES NOT EXTEND TO THE SETBACK LINE WHERE ADJACENT TO A RESIDENTIAL USE. THIS ALLOWS FOR THE PROJECT TO MEET AND EXCEED THE REQUIRED LANDSCAPE BUFFERS ADJACENT TO RESIDENTIAL USE. THE PROJECT ALSO PROPOSES TO ELIMINATE THE NW CORNER OF THE TOP FLOOR TO ASSIST IN

B. THE PROJECT PROPOSES TO MEET ALL BUFFERS NOTED IN THE GUIDELINES AND REQUIRED BY ORDINANCE OTHER THAN THE NORTH BUFFER WHERE THE PROPERTY IS ADJACENT TO A LAW OFFICE ZONED OI-1. BASED ON PAST EXPERIENCE WITH PROJECTS IN TOWN AND UPON EXAMINATION OF SIMILAR DOWNTOWN (URBAN) CONDITIONS, THE PROJECT CONTENDS THAT AN ALTERNATE BUFFER AT THIS LOCATION SHOULD BE CONSIDERED AS TWO COMMERCIAL PROPERTIES ARE ADJACENT TO EACH OTHER. AT THIS LOCATION, POTENTIAL NUISANCES (NOISE, DUST, ODOR, GLARE OF LIGHTS) ARE MITIGATED THROUGH 4. AT THE COLUMBIA ST FRONTAGE, THE PROJECT PROPOSES AN ALTERNATE MINIMIZED

BUFFER TO THE REQUIRED 30' WIDE "D" LANDSCAPE BUFFER TO ALLOW FOR THE BUILDING TO ENGAGE THE STREETSCAPE IN A SIMILAR MANNER (ALBEIT NOT PROGRAMMED SPACE) 5. AS ILLUSTRATED IN THE SOLAR ELEVATION STUDIES, THE PROJECT PROPOSES TO MEET ALL

REQUIRED SOLAR SETBACKS DEFINED WITHIN THE GUIDELINES AND ORDINANCE OTHER THAN THE EXCEPTION OF THE BUILDING HEIGHT ENCROACHMENT OF THE 5[™] AND PARTIAL

(B)THE FOLLOWING FEATURES MAY PROJECT ABOVE THE BUILDING ENVELOPE DEFINED BY THE MAXIMUM HEIGHT LIMITATIONS AND ADDITIONAL SETBACK REQUIREMENTS CONTAINED IN RULES FOR INTERPRETATION OF TABLE 3.8-1, COLUMNS (F) AND (G), BELOW, PROVIDED THE TOWN MANAGER DETERMINES THAT SUCH FEATURES DO NOT SIGNIFICANTLY IMPAIR THE DEGREE OF SOLAR ACCESS PROVIDED ADJACENT PROPERTIES THROUGH APPLICATION OF

MONUMENTS, CUPOLAS, PARAPETS, DORMERS, CLOCK TOWERS OR DECORATIVE TOWERS WITH A FOOTPRINT NOT EXCEEDING TWENTY (20) PERCENT OF THE PRINCIPAL BUILDING, PROVIDED THE PROJECTION OF SUCH STRUCTURES ABOVE THE BUILDING

LIMITATION THAT DEFINES THE PORTION OF THE BUILDING NVELOPE PENETRATED BY SUCH


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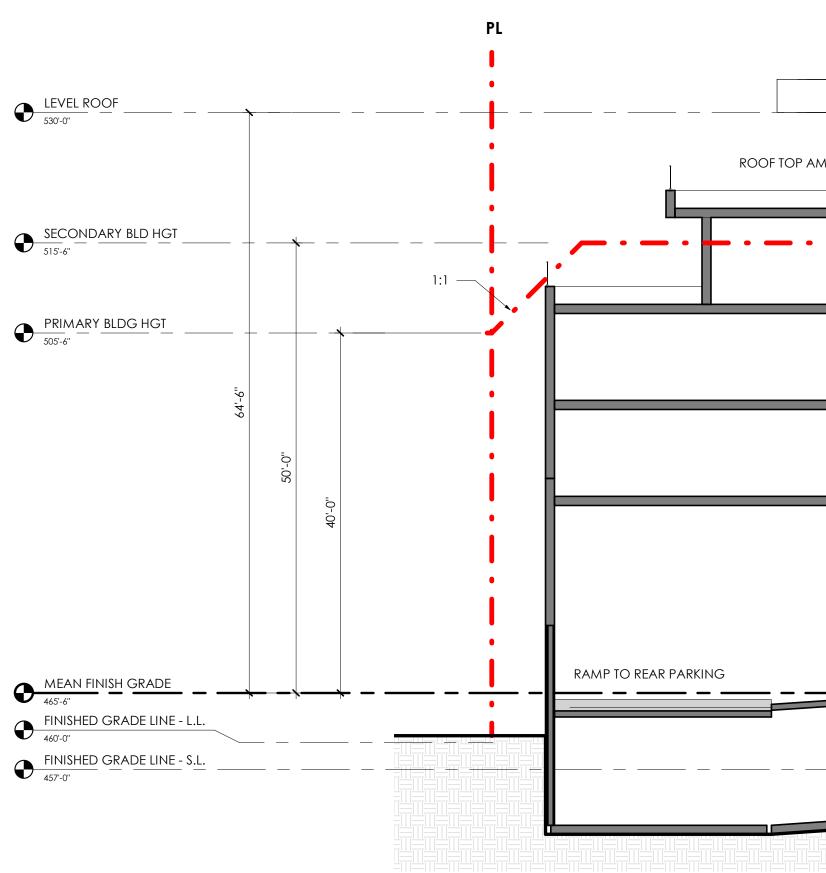


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HOTEL	
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HOTEL	
HOTEL LOBBY	

WEST ELEVATION - ROSEMARY WING 3/32" = 1'-0" (2)

LB


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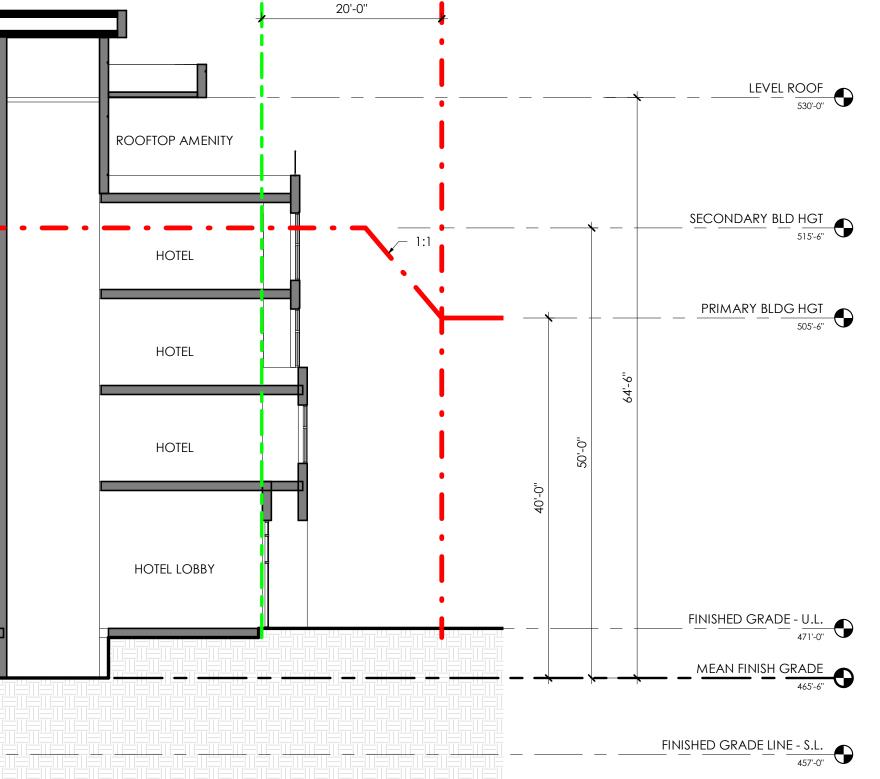
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GENERAL NOTE:

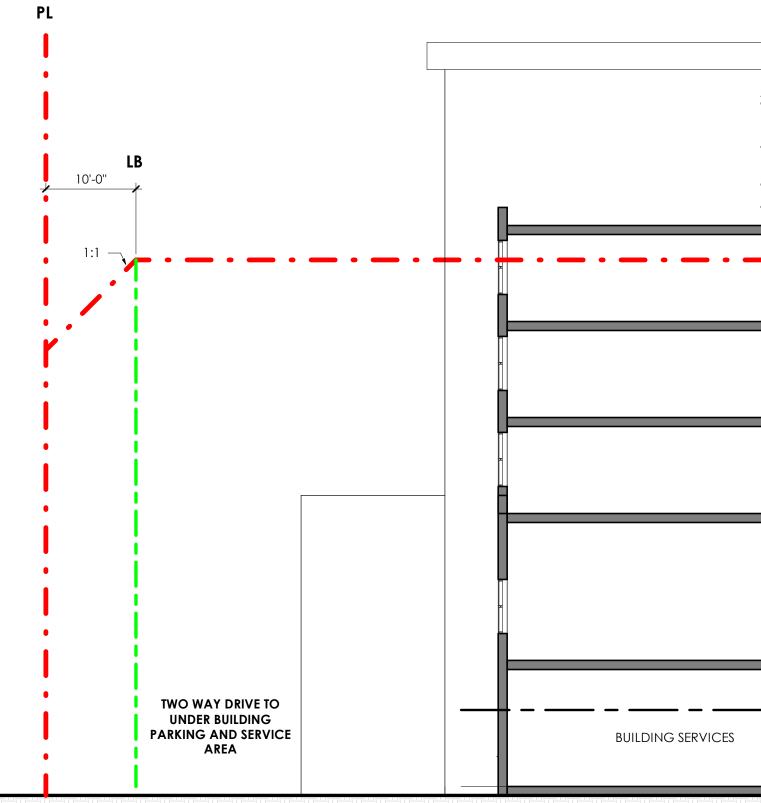ROSEMARY / COLUMBIA HOTEL



- PROPERTY LINE (PL) & SETBACKS / SOLAR SETBACKS (DIMENSIONAL MATRIX RESTRICTIONS)
- LANDSCAPE BUFFER (LB)



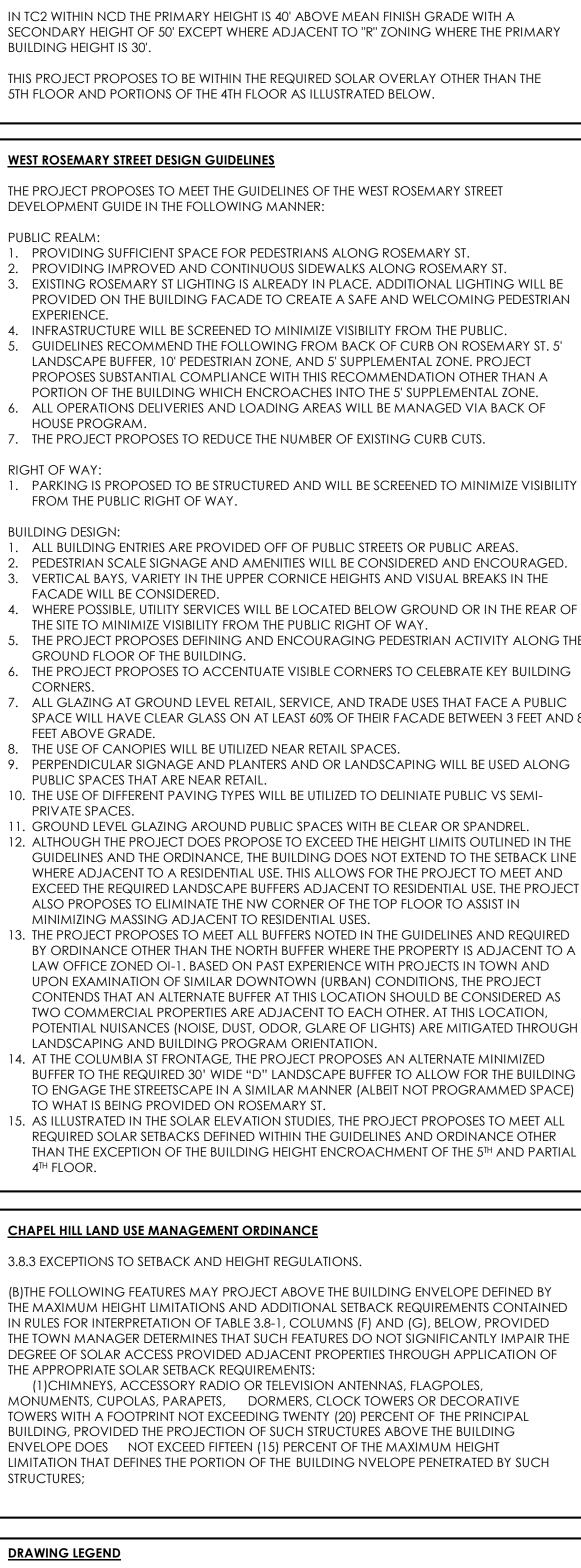



IN TC2 WITHIN NCD THE PRIMARY HEIGHT IS 40' ABOVE MEAN FINISH GRADE WITH A SECONDARY HEIGHT OF 50' EXCEPT WHERE ADJACENT TO "R" ZONING WHERE THE PRIMARY

-ASHEVILLE

THIS PROJECT PROPOSES TO BE WITHIN THE REQUIRED SOLAR OVERLAY OTHER THAN THE

PROVIDING IMPROVED AND CONTINUOUS SIDEWALKS ALONG ROSEMARY ST. EXISTING ROSEMARY ST LIGHTING IS ALREADY IN PLACE. ADDITIONAL LIGHTING WILL BE PROVIDED ON THE BUILDING FACADE TO CREATE A SAFE AND WELCOMING PEDESTRIAN INFRASTRUCTURE WILL BE SCREENED TO MINIMIZE VISIBILITY FROM THE PUBLIC. GUIDELINES RECOMMEND THE FOLLOWING FROM BACK OF CURB ON ROSEMARY ST. 5'

PROPOSES SUBSTANTIAL COMPLIANCE WITH THIS RECOMMENDATION OTHER THAN A PORTION OF THE BUILDING WHICH ENCROACHES INTO THE 5' SUPPLEMENTAL ZONE. ALL OPERATIONS DELIVERIES AND LOADING AREAS WILL BE MANAGED VIA BACK OF

PARKING IS PROPOSED TO BE STRUCTURED AND WILL BE SCREENED TO MINIMIZE VISIBILITY

ALL BUILDING ENTRIES ARE PROVIDED OFF OF PUBLIC STREETS OR PUBLIC AREAS. PEDESTRIAN SCALE SIGNAGE AND AMENITIES WILL BE CONSIDERED AND ENCOURAGED. VERTICAL BAYS, VARIETY IN THE UPPER CORNICE HEIGHTS AND VISUAL BREAKS IN THE

WHERE POSSIBLE, UTILITY SERVICES WILL BE LOCATED BELOW GROUND OR IN THE REAR OF THE PROJECT PROPOSES DEFINING AND ENCOURAGING PEDESTRIAN ACTIVITY ALONG THE . THE PROJECT PROPOSES TO ACCENTUATE VISIBLE CORNERS TO CELEBRATE KEY BUILDING

ALL GLAZING AT GROUND LEVEL RETAIL, SERVICE, AND TRADE USES THAT FACE A PUBLIC SPACE WILL HAVE CLEAR GLASS ON AT LEAST 60% OF THEIR FACADE BETWEEN 3 FEET AND 8

PERPENDICULAR SIGNAGE AND PLANTERS AND OR LANDSCAPING WILL BE USED ALONG D. THE USE OF DIFFERENT PAVING TYPES WILL BE UTILIZED TO DELINIATE PUBLIC VS SEMI-

. GROUND LEVEL GLAZING AROUND PUBLIC SPACES WITH BE CLEAR OR SPANDREL. 2. ALTHOUGH THE PROJECT DOES PROPOSE TO EXCEED THE HEIGHT LIMITS OUTLINED IN THE GUIDELINES AND THE ORDINANCE, THE BUILDING DOES NOT EXTEND TO THE SETBACK LINE WHERE ADJACENT TO A RESIDENTIAL USE. THIS ALLOWS FOR THE PROJECT TO MEET AND EXCEED THE REQUIRED LANDSCAPE BUFFERS ADJACENT TO RESIDENTIAL USE. THE PROJECT ALSO PROPOSES TO ELIMINATE THE NW CORNER OF THE TOP FLOOR TO ASSIST IN

BY ORDINANCE OTHER THAN THE NORTH BUFFER WHERE THE PROPERTY IS ADJACENT TO A LAW OFFICE ZONED OI-1. BASED ON PAST EXPERIENCE WITH PROJECTS IN TOWN AND UPON EXAMINATION OF SIMILAR DOWNTOWN (URBAN) CONDITIONS, THE PROJECT CONTENDS THAT AN ALTERNATE BUFFER AT THIS LOCATION SHOULD BE CONSIDERED AS TWO COMMERCIAL PROPERTIES ARE ADJACENT TO EACH OTHER. AT THIS LOCATION, POTENTIAL NUISANCES (NOISE, DUST, ODOR, GLARE OF LIGHTS) ARE MITIGATED THROUGH 4. AT THE COLUMBIA ST FRONTAGE, THE PROJECT PROPOSES AN ALTERNATE MINIMIZED

TO ENGAGE THE STREETSCAPE IN A SIMILAR MANNER (ALBEIT NOT PROGRAMMED SPACE) 5. AS ILLUSTRATED IN THE SOLAR ELEVATION STUDIES, THE PROJECT PROPOSES TO MEET ALL

(B)THE FOLLOWING FEATURES MAY PROJECT ABOVE THE BUILDING ENVELOPE DEFINED BY THE MAXIMUM HEIGHT LIMITATIONS AND ADDITIONAL SETBACK REQUIREMENTS CONTAINED IN RULES FOR INTERPRETATION OF TABLE 3.8-1, COLUMNS (F) AND (G), BELOW, PROVIDED THE TOWN MANAGER DETERMINES THAT SUCH FEATURES DO NOT SIGNIFICANTLY IMPAIR THE DEGREE OF SOLAR ACCESS PROVIDED ADJACENT PROPERTIES THROUGH APPLICATION OF

MONUMENTS, CUPOLAS, PARAPETS, DORMERS, CLOCK TOWERS OR DECORATIVE TOWERS WITH A FOOTPRINT NOT EXCEEDING TWENTY (20) PERCENT OF THE PRINCIPAL BUILDING, PROVIDED THE PROJECTION OF SUCH STRUCTURES ABOVE THE BUILDING

LIMITATION THAT DEFINES THE PORTION OF THE BUILDING NVELOPE PENETRATED BY SUCH


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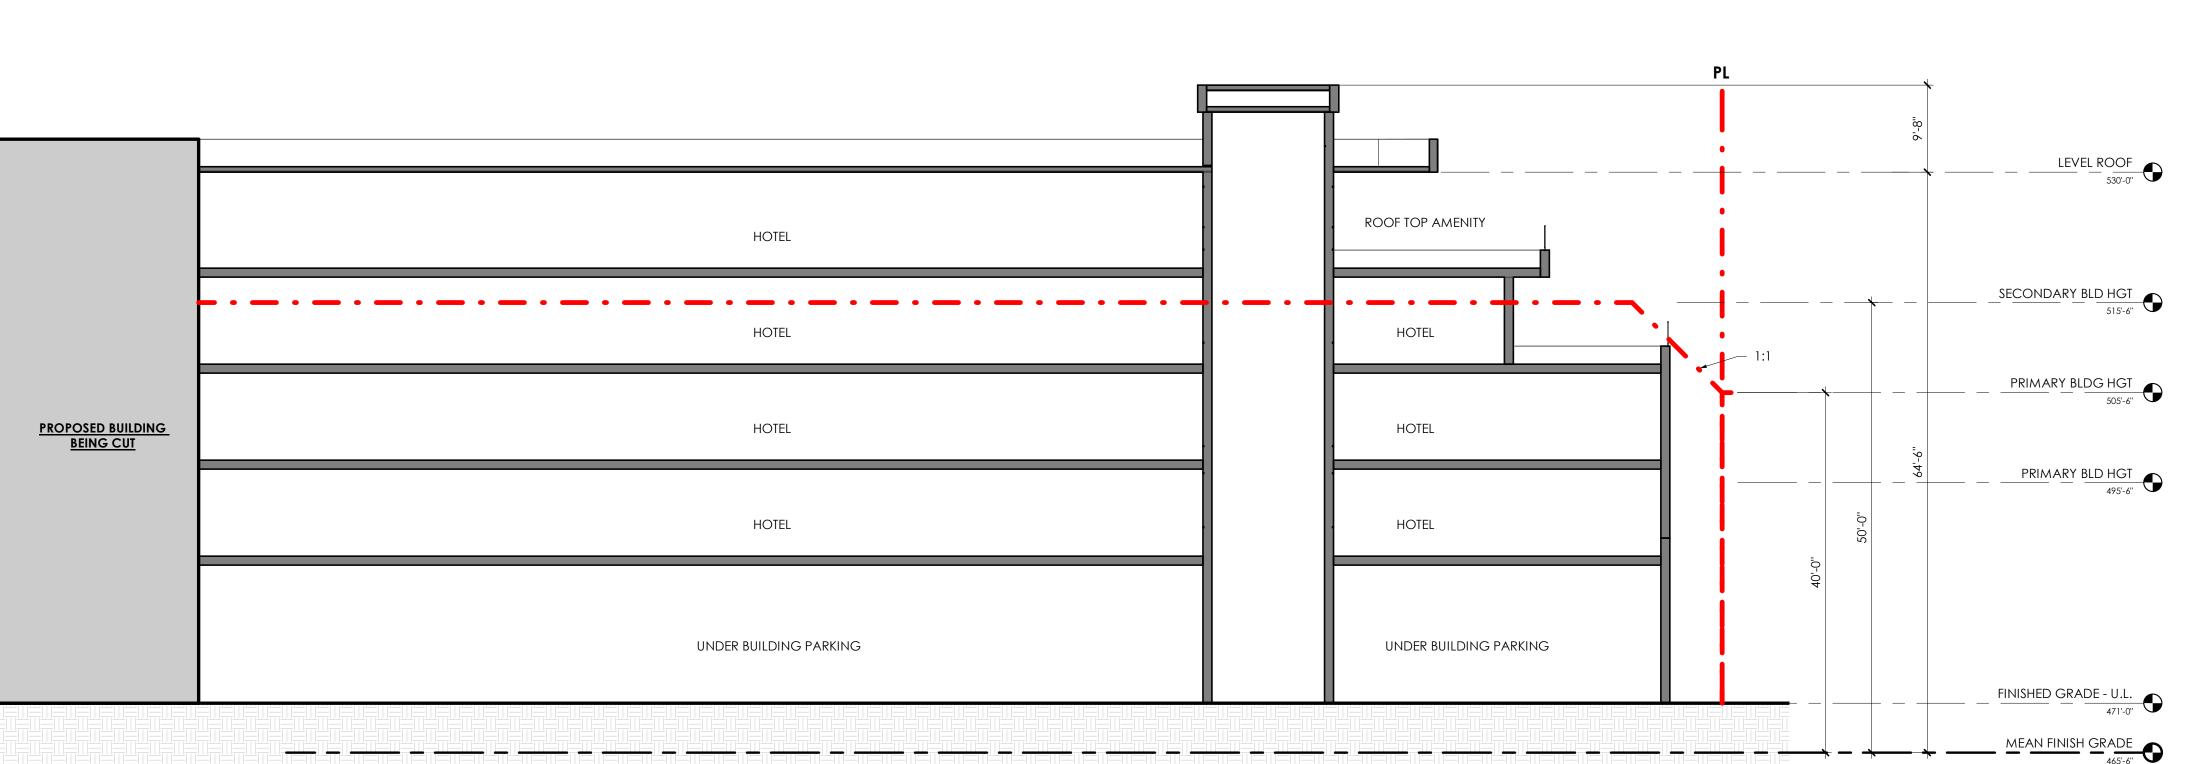


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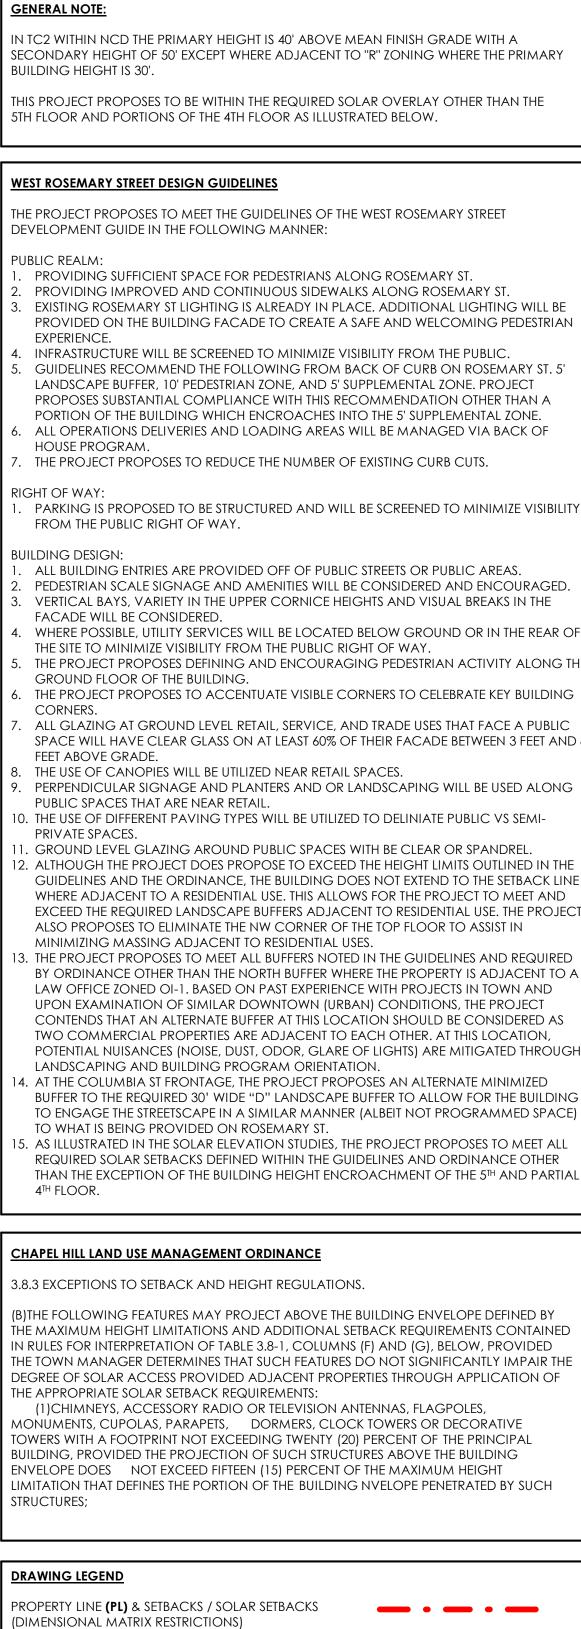






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ROSEMARY / COLUMBIA HOTEL

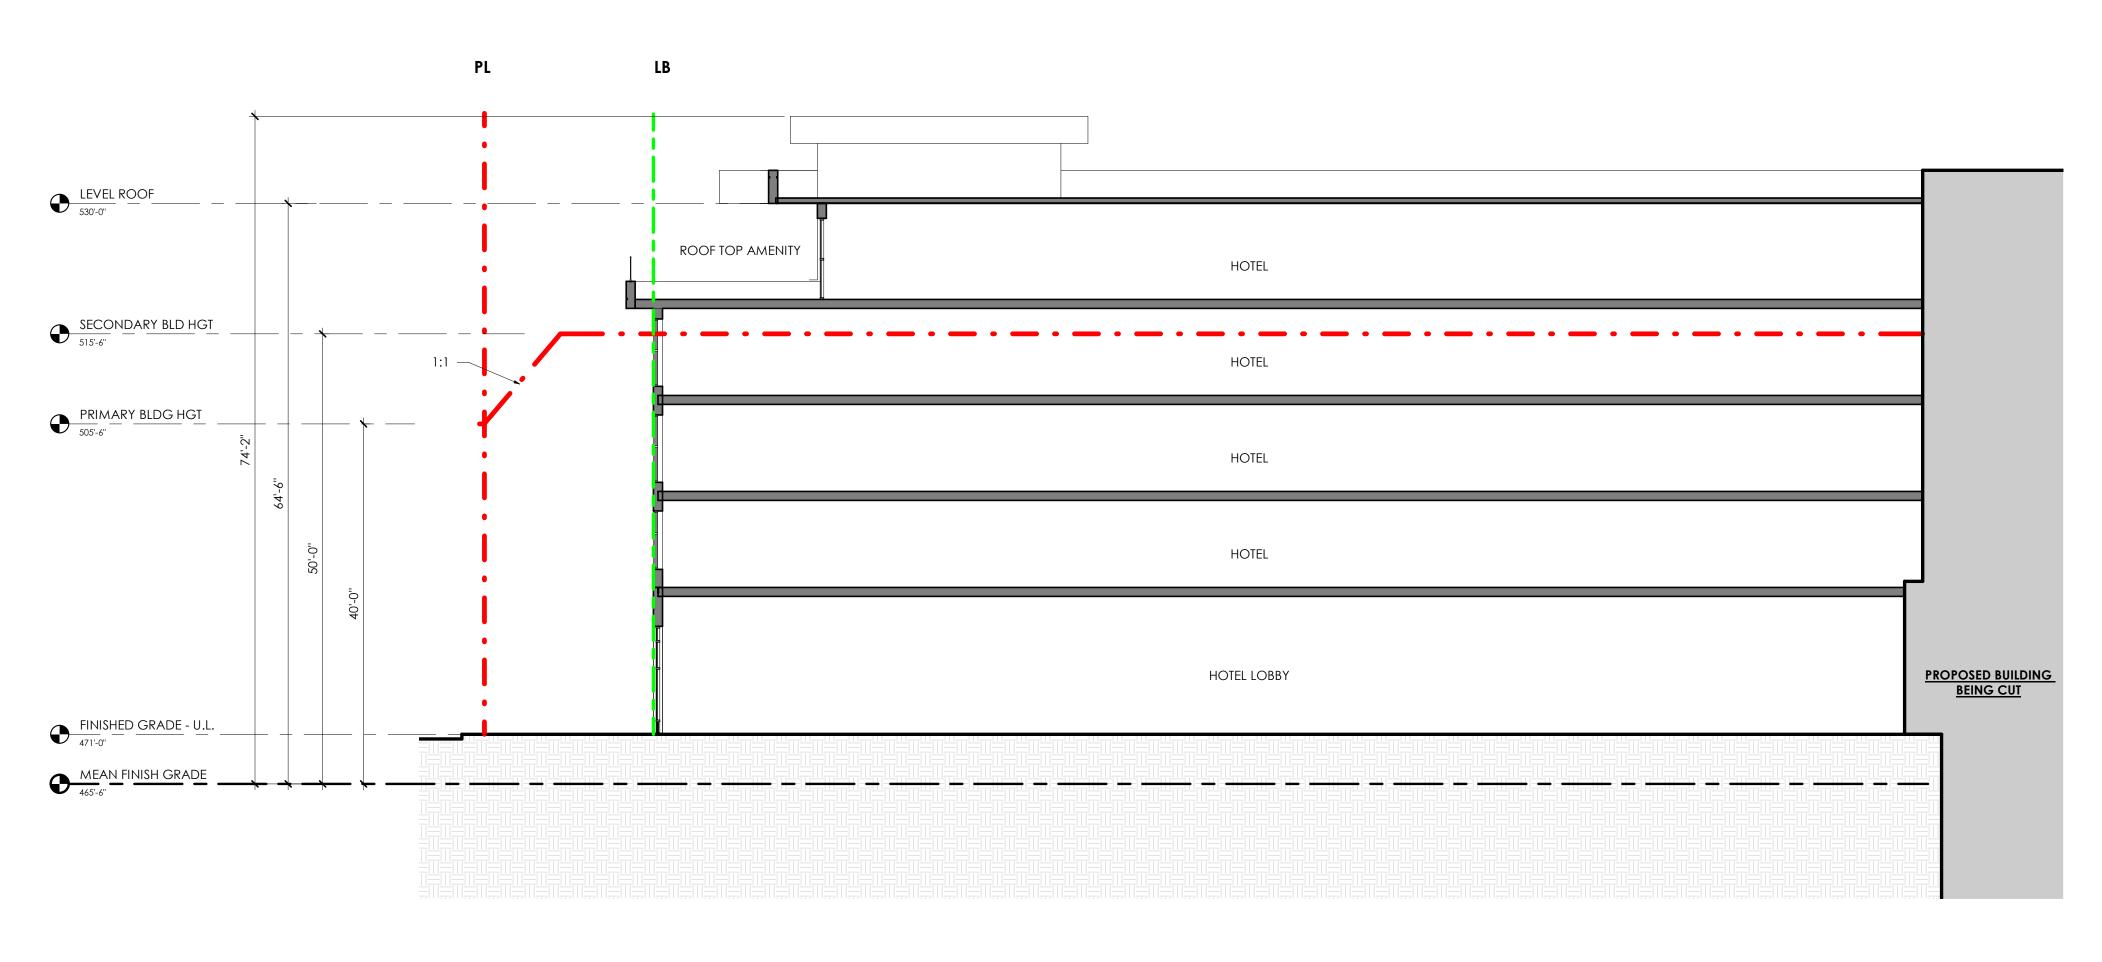

LANDSCAPE BUFFER (LB)

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