


### **KEYED NOTES:**


- 1 EXISTING CONCRETE LOADING DOCK TO REMAIN.
- EXISTING UNDERGROUND ELECTRIC SERVICE TO REMAIN.
- PROPOSED CONCRETE TO BE FLUSH WITH ADJACENT PAVEMENT.
- SAWCUT TO NEAREST JOINTS AND REMOVE CONCRETE PAVEMENT.
- PROPOSED CONCRETE SIDEWALK. CONTRACTOR SHALL MAINTAIN MAX 2.00% CROSS SLOPE. SEE DETAIL THIS SHEET.
- PROPOSED CROSSWALK MARKINGS BY LANDLORD. MATCH EXISTING IN COLOR AND WIDTH.
- PROPOSED 3" MIN. ROOF DRAIN TO BE CONNECTED TO EXISTING STORM DRAINAGE WAY. SEE DETAIL THIS SHEET.
- RE-GRADE ASPHALT AS NECESSARY TO CREATE FLUSH TRANSITION TO SIDEWALK
- EXISTING DOMESTIC WATER SERVICE METER VAULT AND BACKFLOW PREVENTER VAULT TO REMAIN.
- PROPOSED DUMPSTER. SEE ARCHITECTURAL PLANS FOR DETAILS.
- PROPOSED DUMPSTER ENCLOSURE PER CITY OF CHAPEL HILL STANDARDS. SEE STRUCTURAL AND ARCHITECTURAL PLANS FOR DETAILS.
- PROPOSED CANOPY. SEE ARCHITECTURAL PLANS FOR DETAILS.
- PROPOSED STRIPING FOR TRUCK GUIDANCE.
- PROPOSED STAIRS. SEE STRUCTURAL AND ARCHITECTURAL PLANS FOR DETAIS.
- PROPOSED BOLLARD (TYP. OF 2). SEE STRUCTURAL AND ARCHITECTURAL PLANS FOR DETAILS.
- PROPOSED 2" GAS SERVICE, GAS METER TO BE RELOCATED. PROVIDE MIN. 10" W.C. GAS PRESSURE.
- EXISTING FDC AND FIRE SERVICE TO REMAIN.
- EXISTING CATCH BASIN GRATE TO BE REPLACED. MATCH EXISTING SIZE AND LOCATION. EXISTING CATCH BASIN TO REMAIN.
- PROPOSED 4" MIN. SANITARY WITH BACKFLOW PREVENTOR TO BE CONNECTED TO EXISTING SEWER.
- PROPOSED CONCRETE LANDING. CONTRACTOR SHALL MAINTAIN MAX 2.00% CROSS SLOPE.
- PROPOSED CONCRETE TO BE FLUSH WITH ADJACENT CONCRETE.
- PROPOSED TELEPHONE LINE TO CONNECT TO EXISTING.
- EXISTING WATER METER VAULT TO REMAIN.

# **GENERAL NOTES:**

- A. ALL EXISTING UTILITIES, TOPOGRAPHY AND PROPERTY INFORMATION ARE APPROXIMATE AND MUST BE VERIFIED IN THE FIELD.
- CONTRACTOR IS RESPONSIBLE FOR LOCATING AND VERIFYING ALL EXISTING UNDERGROUND UTILITIES PRIOR TO CONSTRUCTION, AND IS RESPONSIBLE FOR ANY DAMAGE TO THEM DURING CONSTRUCTION.
- ALL CONSTRUCTION METHODS AND MATERIAL MUST CONFORM TO CURRENT STANDARDS AND SPECIFICATIONS OF THE FEDERAL, STATE, COUNTY, CITY OR LOCAL REQUIREMENTS, WHICHEVER HAS JURISDICTION.
- PROVIDE SMOOTH TRANSITION FROM NEWLY PAVED AREAS TO EXISTING PAVED AREAS AS NECESSARY. THE EXISTING EDGE OF PAVEMENT SHALL BE FREE OF ALL LOOSE DEBRIS AT ALL AREAS WHERE PROPOSED PAVEMENT MEETS EXISTING PAVEMENT. THE EDGE OF EXISTING ASPHALT PAVEMENT SHALL BE PROPERLY SEALED WITH A TACK COAT MATERIAL IN ALL AREAS WHERE NEW ASPHALT PAVEMENT IS INDICATED TO JOIN EXISTING.
- ALL PROPOSED SPOT ELEVATIONS SHOWN ARE TOP OF GRADE ELEVATIONS UNLESS OTHERWISE NOTED AND ARE FOR REFERENCE ONLY.
- CONTRACTOR TO VERIFY ALL EXISTING GRADES AND CONTACT ENGINEER PRIOR TO BEGINNING WORK IF DISCREPANCY IS FOUND. CONTRACTOR TO VERIFY ASSUMED FINISHED FLOOR ELEVATION PRIOR TO BEGINNING WORK.
- CONTRACTOR SHALL BE SOLELY RESPONSIBLE FOR AND TAKE ALL PRECAUTIONS NECESSARY TO AVOID DAMAGE TO ADJACENT PROPERTIES DURING THE CONSTRUCTION PHASES OF THIS PROJECT.
- REFER TO ARCHITECTURAL DRAWINGS FOR BUILDING DIMENSIONS AND ADDITIONAL INFORMATION.
  - THE CONTRACTOR SHALL NOTIFY ALL UTILITY COMPANIES 48 HOURS BEFORE CONSTRUCTION IS TO START, TO VERIFY IF ANY UTILITIES ARE PRESENT ON SITE. ALL VERIFICATIONS (LOCATION, SIZE AND DEPTH) SHALL BE MADE BY THE APPROPRIATE UTILITY COMPANIES. WHEN EXCAVATION IS AROUND OR OVER EXISTING UTILITIES, THE CONTRACTOR MUST NOTIFY THE UTILITY SO A REPRESENTATIVE OF THAT UTILITY COMPANY CAN BE PRESENT TO INSTRUCT AND OBSERVE DURING CONSTRUCTION.
- CONTRACTOR SHALL MAINTAIN A MINIMUM COVER OF 4' OVER PROPOSED WATER SERVICE.
- THERE SHALL BE A MINIMUM TEN-FOOT HORIZONTAL SEPARATION BETWEEN WATER TAPS, WATER SERVICES, PRIVATE WATER SYSTEMS, AND ANY SANITARY AND/OR STORM SEWER SYSTEMS. WHERE 10-FEET HORIZONTAL SEPARATION CANNOT BE OBTAINED, THE BOTTOM OF THE WATER LINE SHALL BE AT LEAST 18 INCHES ABOVE THE TOP OF THE SEWER.
- SEE PLUMBING PLANS FOR CONTINUATION OF WATER LINE INTO BUILDING.
- CONTRACTOR SHALL VERIFY THE EXISTING AND PROPOSED GRADES AND CONFIRM THAT THE PAVEMENT WILL MEET ALL ADA REQUIREMENTS WHERE APPLICABLE.


NOTE: CONTRACTOR SHALL VERIFY FINISHED FLOOR AND ALL EXISTING GRADES PRIOR TO BEGINNING CONSTRUCTION AND NOTIFY ARCHITECT IF ELEVATIONS AND SLOPES INDICATED ON PLAN CANNOT BE MET.

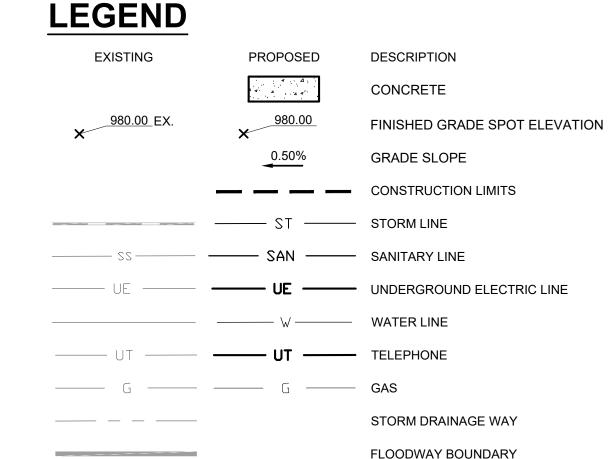

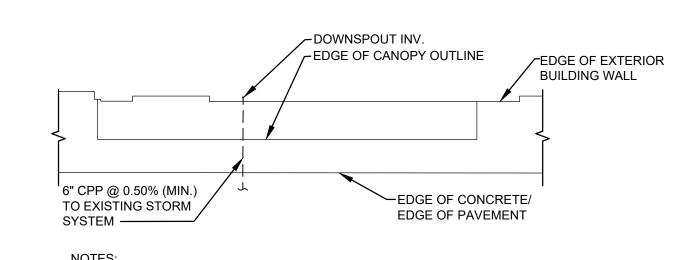

TYPICAL CANOPY UTILITY LOCATIONS

1. FOR REFERENCE ONLY. VERIFY WITH EXISTING CONDITIONS.

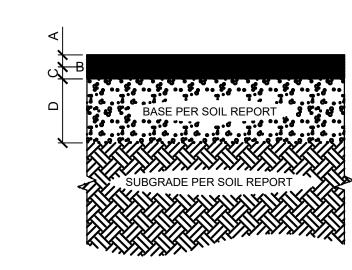

### **HEAVY DUTY PAVING**


- A = 2.0" ASPHALT CONCRETE (NCDOT SF 9.5S SURFACE COURSE)
- B = TACK COAT (0.05 GAL/S.Y.)
- C = 2.5" ASPHALT CONCRETE
- (NCDOT B25.0B, INTERMEDIATE COURSE) D = 8" OF AGGREGATE BASE
- COMPACTED TO 100% MOD (NCDOT ABC)

### 1. SUBGRADE COMPACTION: CBR= 5


- 2. BASE COURSE TO CONFORM TO NCDOT STANDARDS FOR BASE COURSE COMPACTED TO 100% OF THE MODIFIED PROCTOR (ASTM D-1557) MAXIMUM DRY DENSITY
- 3. ALL SUBGRADE AND PAVEMENT OPERATIONS AND MATERIALS SHALL MEET THE MINIMUM REQUIREMENTS OF THE CURRENT NCDOT SPECIFICATIONS





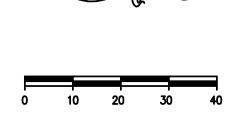


SCALE: 1"=20'

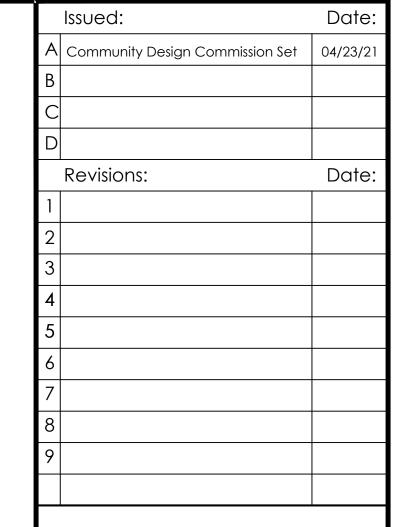

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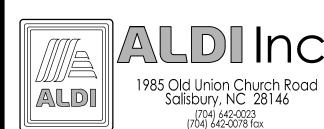
### ms consultants, inc. engineers, architects, planners

5444 Wade Park Blvd Raleigh, NC 27607-4299 phone 919.772.5565 fax 919.779.2308

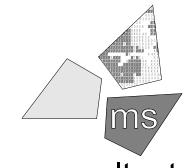DRAWN BY: BMT/MYG

REVIEWED BY:

PROFESSIONAL OF RECORD: CHARLES M. BUSCH No. 14751 EXP. DATE: 06/30/2021



ALDI Inc. Store #: TBD Chapel Hill, NC 1800 E Franklin St. Suite 13

Project Name & Location:

Chapel Hill, NC 27514


Drawing Name:

Site Plan

Prototype Rls. Project No. 02/05/21 40452-37


Type: VX.17 **ASP-101** 

Drawing No. Scale: As Noted |

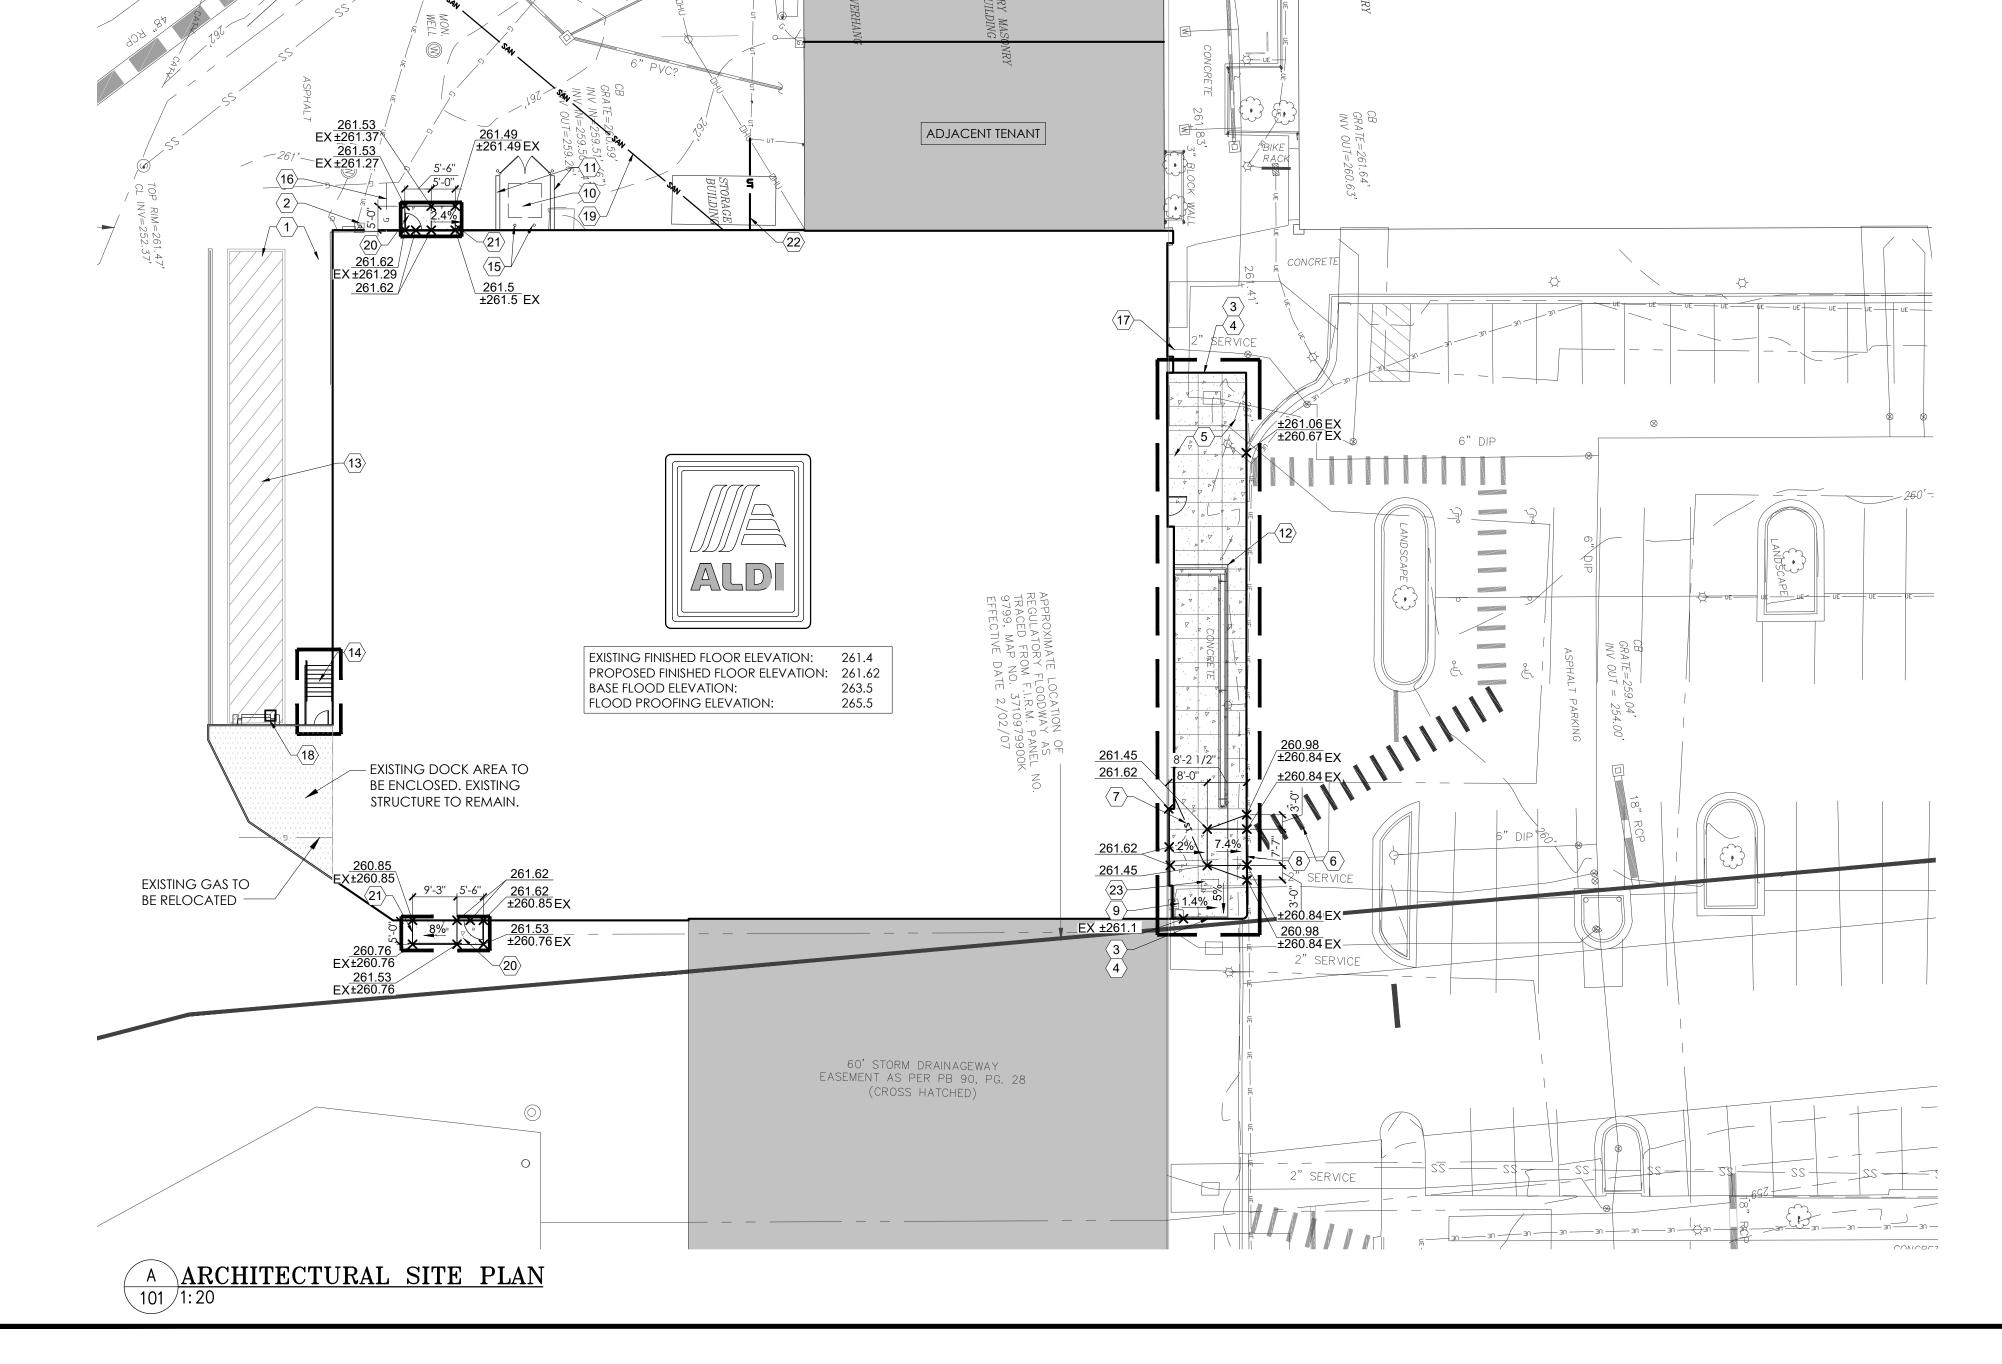

	AREA SUMM	ARY	
OCCUPANCY USE	ROOM NAME	CHAPEL HILL, NC SQUARE FOOTAGE	V7.0 ER PROTOTYPE SQUARE FOOTAGE
MERCANTILE (M)	SALES / VESTIBULE	12,642	12,541
	UNISEX 2	70	84
	UNISEX 1	79	76
	HALL	206	137
SUBTOTAL (MERCANTILE)		12,997	12,838
BUSINESS (B)	OFFICE	190	190
	BREAK ROOM	272	305
	ECOMMERCE	179	175
	CONFERENCE	138	
	TRAINING ROOM	94	
SUBTOTAL (BUSINESS)		873	670
STORAGE / STOCK (S-1)	BACKROOM	8,414	3,808
	COOLER	1,313	1,313
	FREEZER	648	648
SUBTOTAL (STORAGE / STOCK)		10,375	5,769
SUBTOTAL (OCCUPANCIES	•	24,245	19,277
EXTERIOR /INTERIOR WALLS	<u> </u>	1,285	1,165
BUILDING SQUARE FOOTAG	GE	25,530	20,442
EXTERIOR CANOPY		842	1,050
TOTAL SQUARE FOOTAGE	(INCLUDING CANOPY)	26,372	21,492


OPERATIONS DATA				
ITEM	CHAPEL HILL, NC	V7.0 ER PROTOTYPE		
LINEAR FOOTAGE OF BASE PRODUCE INCLUDED)	830'-10"	828'-10''		
ASSUMED PALLET STORAGE	82	74		
BUILDING DIMENSIONS	173'-10" x 143'-2"	119'-4" X 153'-4"		
SALES FLOOR DIMENSIONS	150'-8 1/4" x 89'-7 1/2"	74'-6" X 151'-1"		
LENGTH OF MULTI-DECK	120'	120'		
COOLER MILK DOORS	4	4		
COOLER GENERAL DOORS	12	12		
FREEZER GENERAL DOORS	16	16		
SPOT MERCHANDISERS	10	10		
CART STORAGE	(120) MODEL 563W	(135) MODEL 563W		

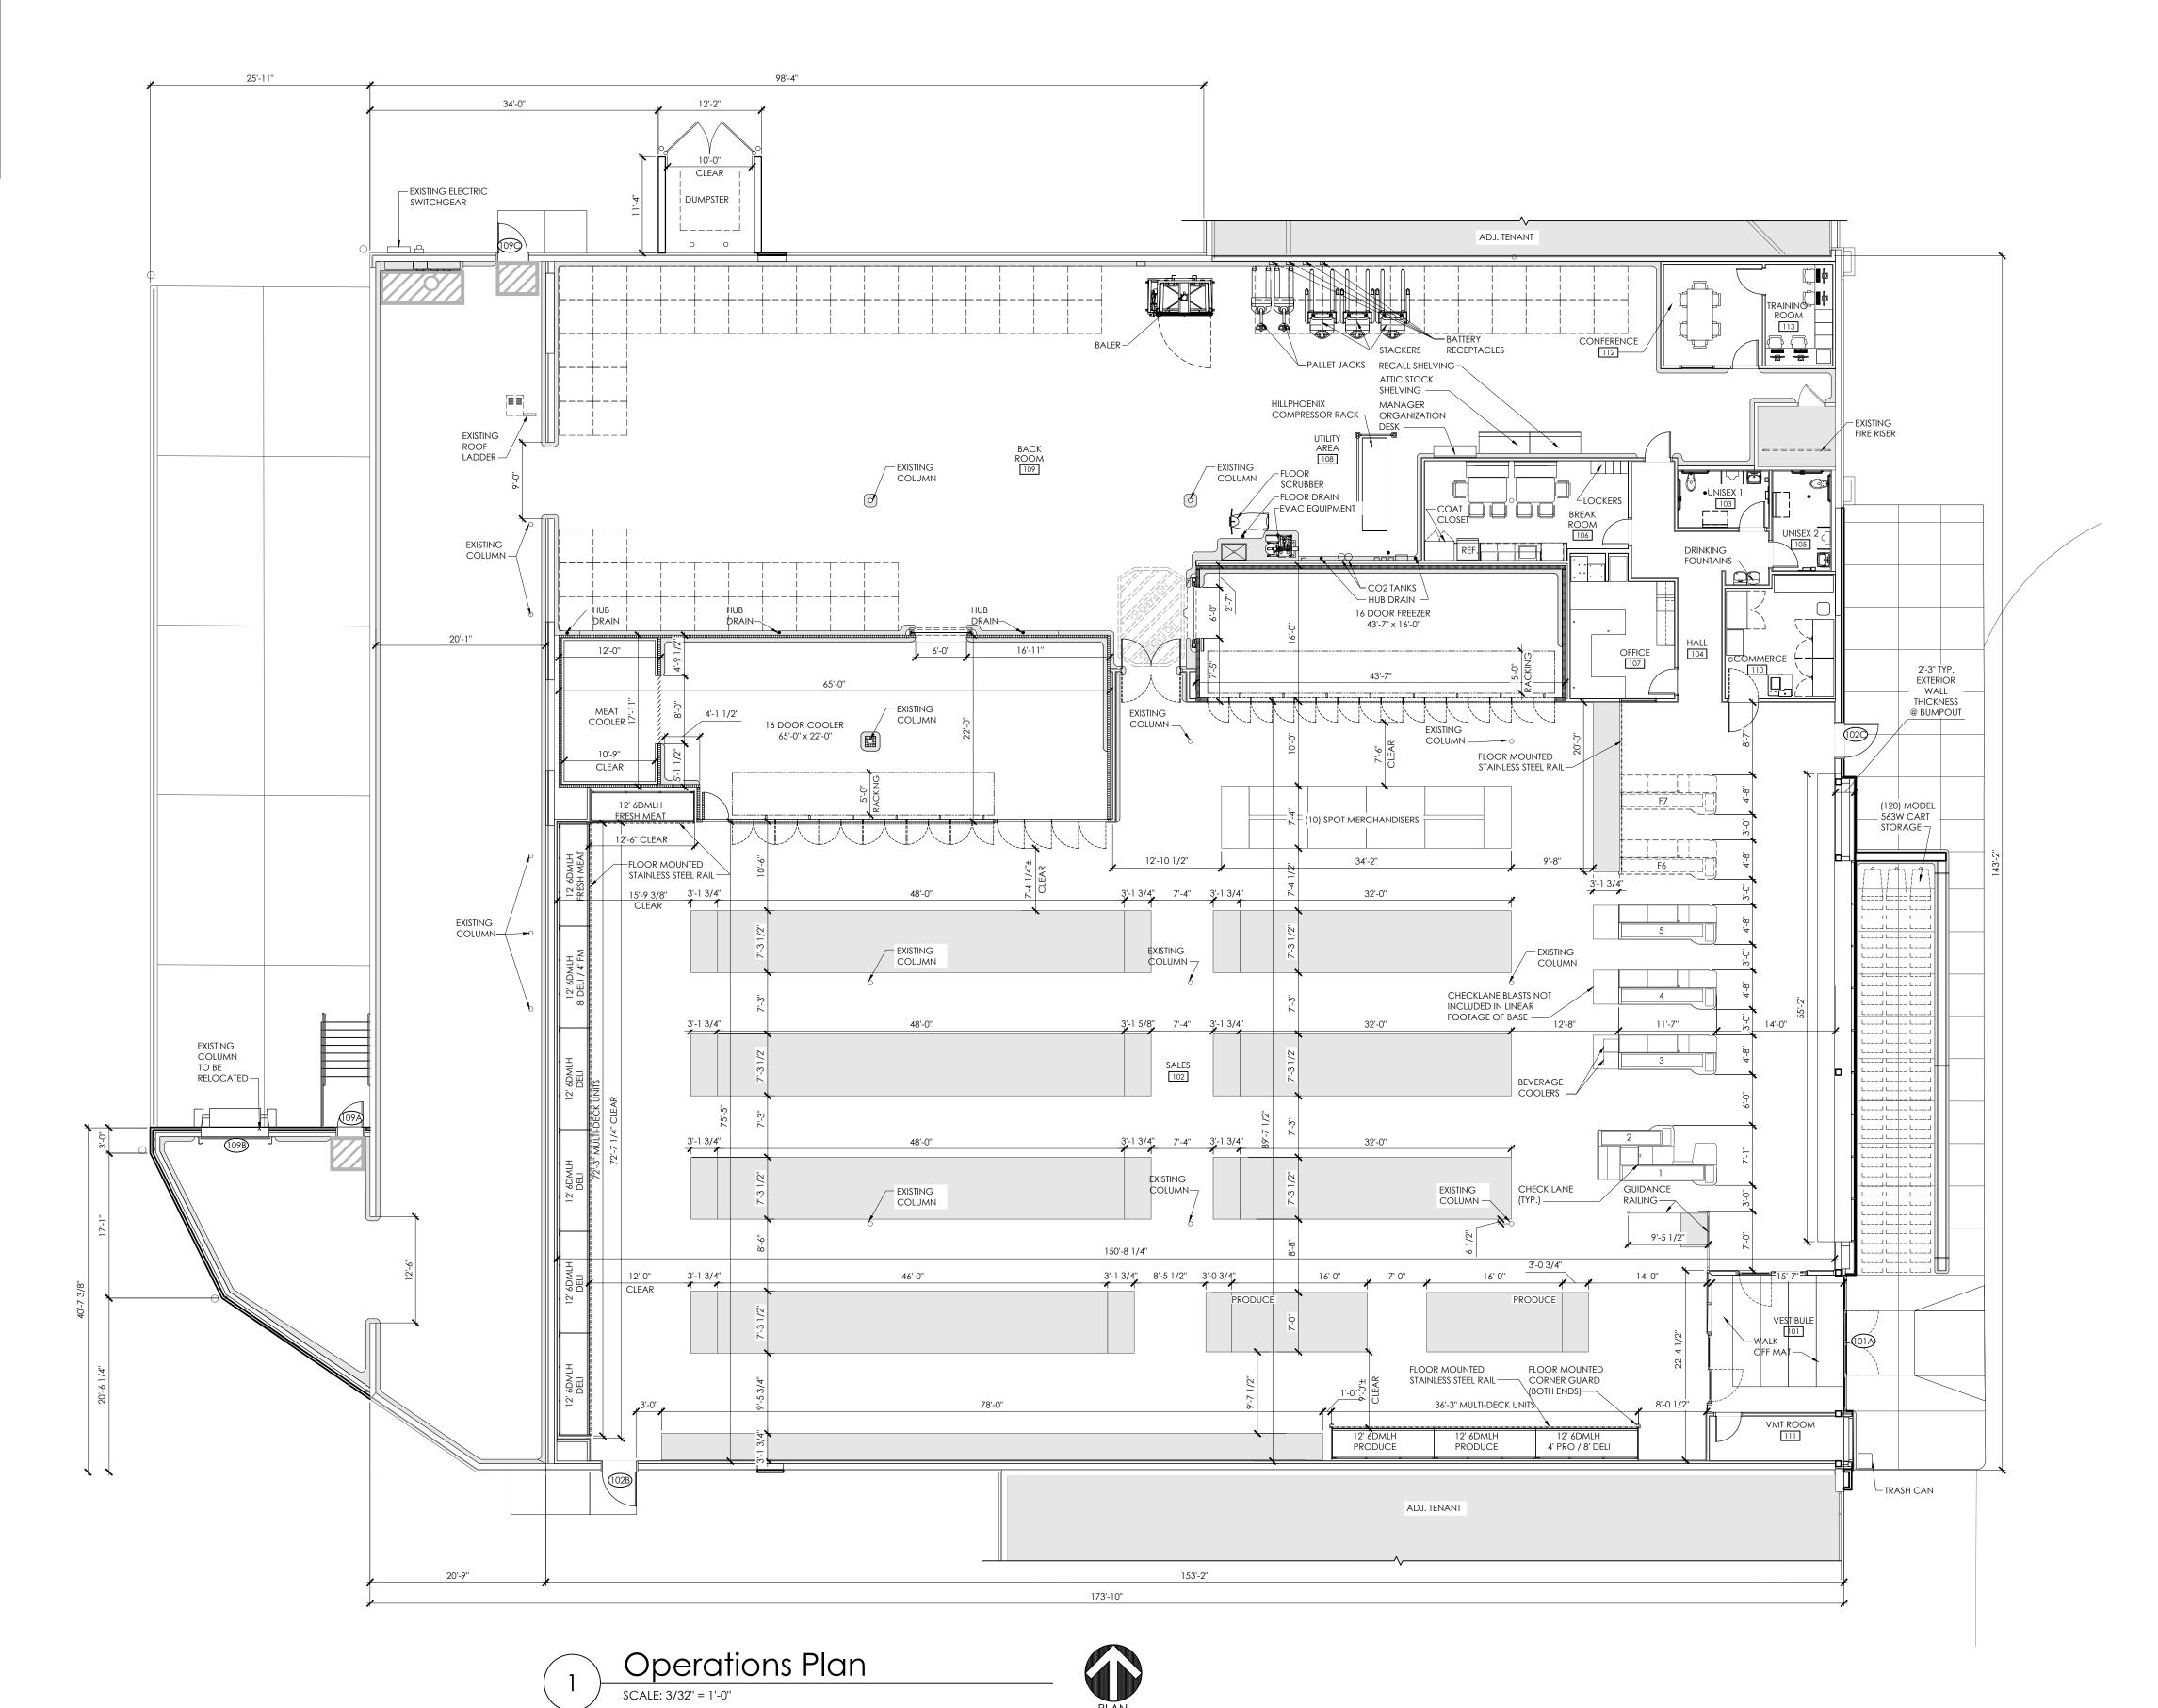

Issued: Community Design Commission Set | 04/23/21 Date: Revisions:

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#### DRAWN BY:

BMT/MYG REVIEWED BY:
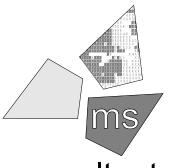
# Seal

PROFESSIONAL OF RECORD: CHARLES M. BUSCH No. 14751 EXP. DATE: 06/30/2021



1985 Old Union Church Road Salisbury, NC 28146 (704) 642-0023 (704) 642-0078 fax

# ALDI Inc. Store #: TBD Chapel Hill, NC 1800 E Franklin St. Suite 13

Chapel Hill, NC 27514

Project Name & Location:


# Operations Plan 119X184


Drawing Name: Prototype Rls.

Project No. 02/05/21 40452-37 Type: VX.17

A131

Scale: As Noted Drawing No.

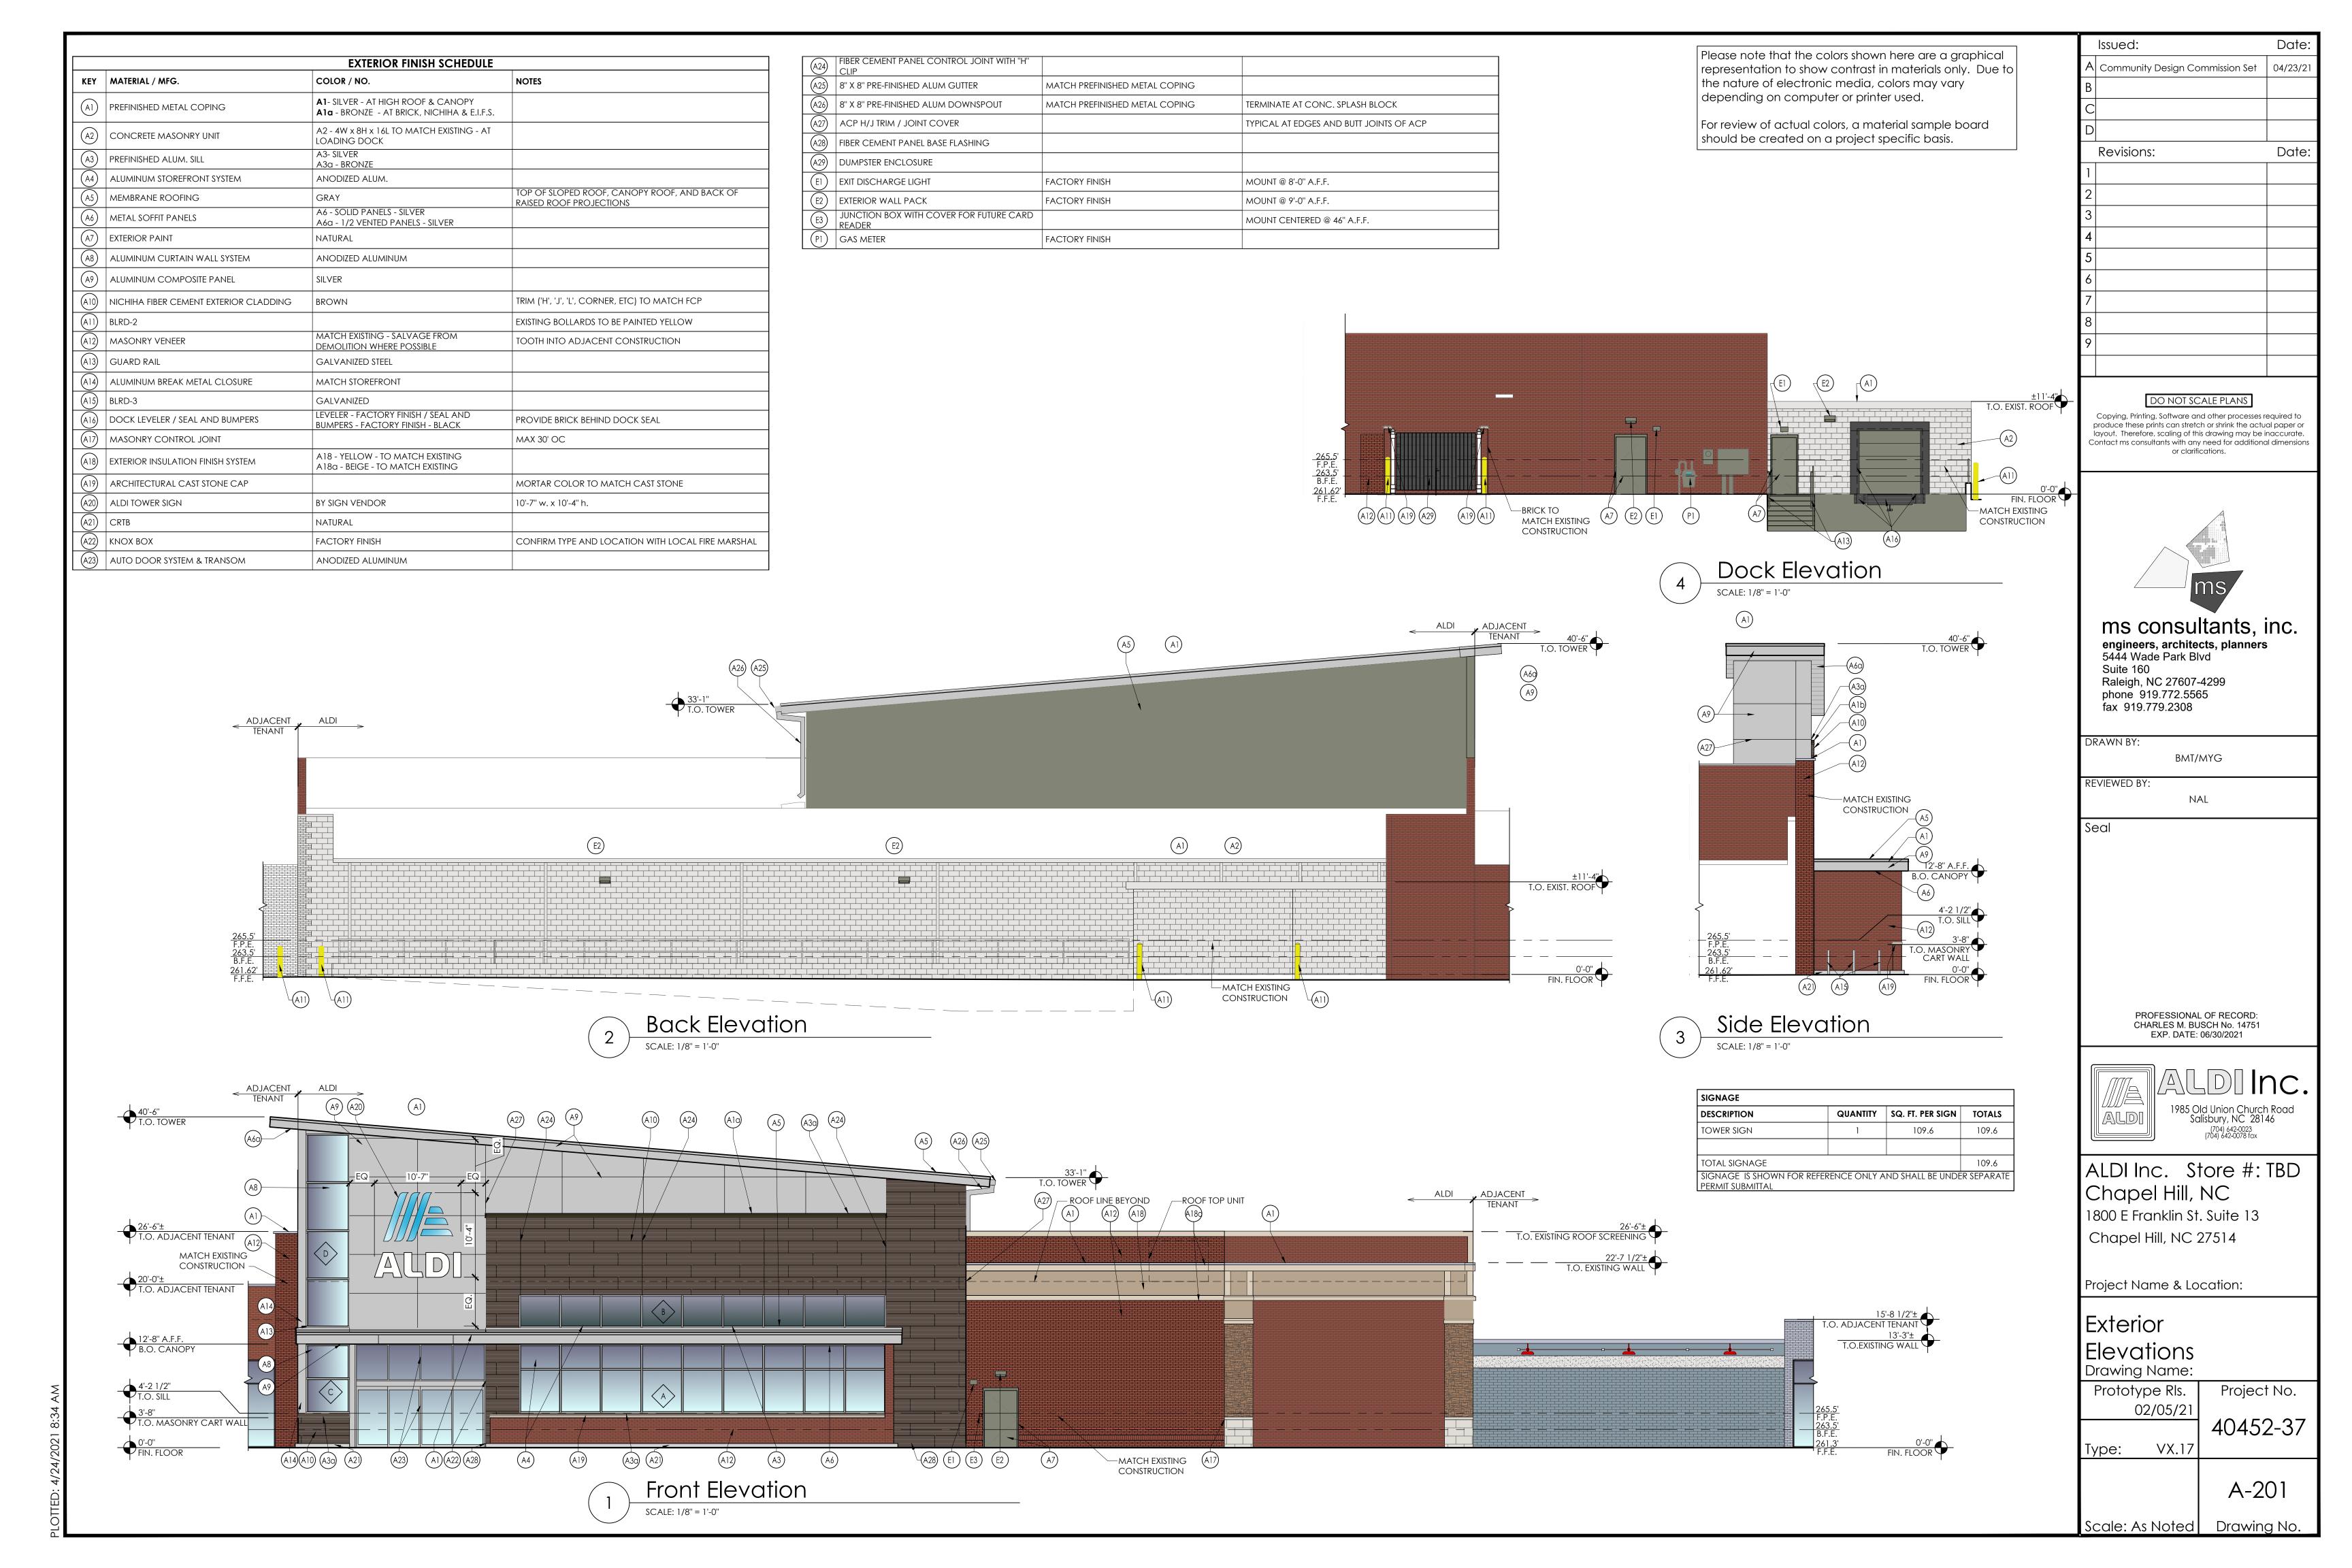

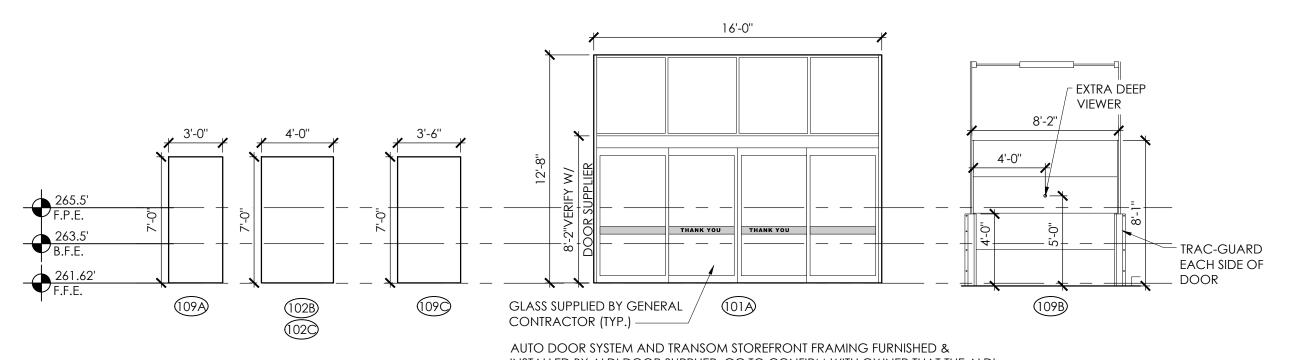

AUTO DOOR SYSTEM AND TRANSOM STOREFRONT FRAMING FURNISHED & INSTALLED BY ALDI DOOR SUPPLIER. GC TO CONFIRM WITH OWNER THAT THE ALDI AUTO DOOR SUPPLIER VERIFIES THE R.O. PRIOR TO THE FABRICATION OF THE DOORS

Door Elevations SCALE: 3/16" = 1'-0"


GL-2

GL-2

GL-2

GL-2

5'-4" VIF

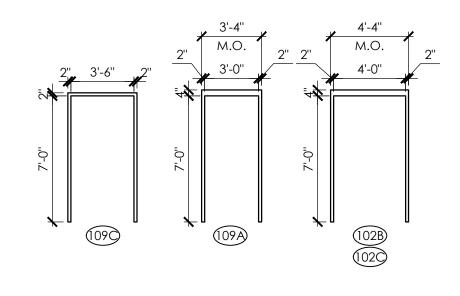

Frame Elevations

SCALE: 3/16" = 1'-0"

	DOOR HARDWARE				
DOOR	DOOR HARDWARE SET NO. 100				
DOC	DOOR NO. 101A; PROVIDED BY OWNER.				
ANOD	ANODIZED ALUMINUM DOOR AND FRAME				
	HARDWARE SET NO. <b>500</b>				
	OR NO. 102B; EGRESS TO HAVE TH	E FOLLOWING:			
	OW METAL DOOR AND FRAME				
No.	Item	Description	Manufacturer	Finish	
2	HINGES	FBB191(32D)-NRP	STANLEY HARDWARE (STH)	630	
1	HINGE	EWH8-626	DETEX	626	
1	THRESHOLD	896N	NATIONAL GUARD (NGP)	AL	
	EXIT/PANIC	V40xEAxLDxIC7x	DETEX 628	/20	
1		KSx48" - INCLUDES			
'		TRANSFORMER		020	
		PP-5152-3			
1	remote sounder	CS-2940S	DETEX	GREY	
1	CLOSER	8501-BF-AL	NORTON DOOR (NDC)	AL	
1	DRIP STRIP	16A	NATIONAL GUARD (NGP)	CLEAR ANOD AL	
1	STICK-ON GASKET	5060B	NATIONAL GUARD (NGP)	-	
1	DOOR SWEEP	9605A	NATIONAL GUARD (NGP)	CLEAR ANOD AL	
1	DOOR SHOE	153A	ZERO	AL	
1	LATCH GUARD	320-RKW	ROCKWOOD	US32D/60	

DOOR	HARDWARE SET NO. <b>600</b>			
	OR NO. 109A, 109C; BACKROOM	EGRESS TO HAVE THE	E FOLLOWING:	
HOLLOW METAL DOOR AND FRAME				
No.	Item	Description	Manufacturer	Finish
2	HINGES	FBB191(32D)-NRP	STANLEY HARDWARE (STH)	630
1	HINGE	EWH8-626	DETEX	626
1	THRESHOLD	896N	NATIONAL GUARD (NGP)	AL
1	exit/panic	V4009D2W628x(R HRorLHR)xEAx LDxIC7xIC7xKSx (36"or48") - INCLUDES TRANSFORMER PP-5152-3	DETEX	628
1	remote sounder	CS-2940S	DETEX	GREY
1	CLOSER W/ HOLD OPEN	1601H	NORTON DOOR (NDC)	AL
1	DRIP STRIP	16A	NATIONAL GUARD (NGP)	CLEAR ANOD AL
1	STICK-ON GASKET	5060B	NATIONAL GUARD (NGP)	-
1	DOOR SWEEP	9605A	NATIONAL GUARD (NGP)	CLEAR ANOD AL
1	DOOR VIEWER	698	IVES (IVS)	-
1	DOOR SHOE	153A	ZERO	AL
1	LATCH GUARD	320-RKW	ROCKWOOD	US32D/60

ALUMINUM FRAMING:

KEY DESCRIPTION

GL-S SPANDREL GLASS

GL-2

44'-11" VIF

AT CORNERS).

-EXTERIOR STOREFRONT: 2" X 4 1/2" THERMAL FRONT SET (SINGLE 45 DEGREE MULLION

-EXTERIOR VERTICAL MESSAGE TOWER: 2 1/2" X 6" THERMAL FRONT SET CURTAINWALI

ALL STOREFRONT DIMENSIONS TO BE VERIFIED IN FIELD AND ADJUSTED AS NEEDED.

-SPANDREL ABOVE CANOPY: 2" X 4-1/2" NON-THERMAL FRONT SET.

GL-2 LOW E, INSULATING GLASS (TEMPERED WHERE REQUIRED BY CODE)

ALL MULLIONS TO BE EQUAL SPACED U.N.O.


	CHARDWARE SET NO. <b>700</b>			
	DR NO. 102C; EGRESS TO HAVE TH	IE FOLLOWING:		
HOLLO	DW METAL DOOR AND FRAME			
No.	Item	Description	Manufacturer	Finish
2	HINGES	FBB191(32D)-NRP	STANLEY HARDWARE (STH)	630
1	HINGE	EWH8-626	DETEX	626
1	CYLINDER	AS REQUIRED	SCHLAGE (SCH)	626
1	THRESHOLD	896N	NATIONAL GUARD (NGP)	AL
1	EXIT/PANIC	V40xEAxLDxIC7x KSx48" - INCLUDES TRANSFORMER PP-5152-3	DETEX	628
1	DRIP STRIP	16A	NATIONAL GUARD (NGP)	CLEAR ANOD A
1	STICK-ON GASKET	5060B	NATIONAL GUARD (NGP)	-
1	DOOR SWEEP	9605A	NATIONAL GUARD (NGP)	CLEAR ANOD A
1	ELECTRONIC STRIKE	DS-24	DETEX	-
1	*DOOR OPERATOR	MAGIC FORCE	STANLEY	BZ
2	CARD READER	BY OTHERS		
	DOOR POSITION SWITCH	BY OTHERS		
	LOW VOLTAGE POWER SUPPLY	BY OTHERS		
1	32" H. PROTECTIVE PLATE	8400	IVES (IVS)	630
1	DOOR SHOE	153A	ZERO	AL
1	LATCH GUARD	320-RKW	ROCKWOOD	US32D/60

STOREFRONT -B TRANSOM AT

STOREFRONT -SACKING COUNTER

SACKING COUNTER

EGRESS BY CARD READER INSIDE SHUTS DOOR POSITION SWITCH. EGRESS WITHOUT CARD READER TRIGGERS ALARM. ENTRANCE BY CARD ACTIVATES DOOR OPERATOR (CAN BE OPENED WITH KEY OVERRIDE).
\*ALDI PROVIDED FURNISHED AND INSTALLED

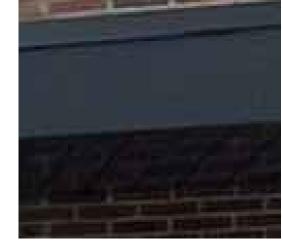

A1 - PREFINISHED METAL COPING;


SILVER

A1b - PREFINISHED METAL COPING;




A9 - ALUMINUM COMPOSITE PANEL; SILVER

A10 - FIBER CEMENT EXTERIOR CLADDING; BROWN

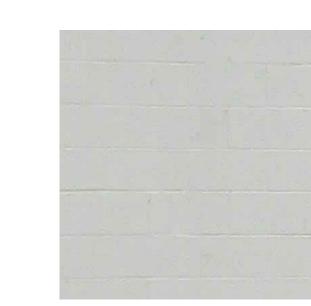

A2 - CONCRETE MASONRY UNIT; TO MATCH EXISTING

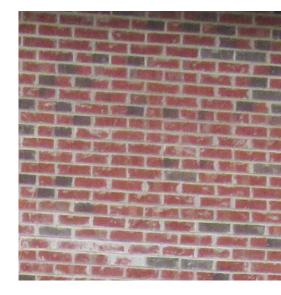

A12 - MASONRY VENEER; TO MATCH EXISTING





A4 - ALUMINUM STOREFRONT SYSTEM; ANODIZED







A18 - EXTERIOR INSULATION FINISH SYSTEM;



TO MATCH EXISTING



CURTAINWALL -VERTICAL MESSAGING TOWER (BELOW)

CURTAINWALL -

(D) VERTICAL MESSAGING

TOWER (ABOVE)

Material List


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Issued:

Date:

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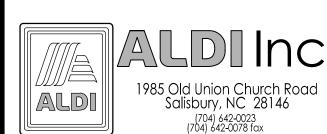
Suite 160 Raleigh, NC 27607-4299 phone 919.772.5565 fax 919.779.2308

DRAWN BY:	
	BMT/MYG

REVIEWED BY: NAL

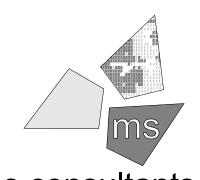Seal

PROFESSIONAL OF RECORD: CHARLES M. BUSCH No. 14751 EXP. DATE: 06/30/2021



ALDI Inc. Store #: TBD Chapel Hill, NC

1800 E Franklin St. Suite 13 Chapel Hill, NC 27514

Project Name & Location:

Door & Window Elevations Drawing Name:

Prototype Rls. Project No. 02/05/21 40452-37

Type: VX.17

A-202 Drawing No. Scale: As Noted