



**ORANGE COUNTY SOLID WASTE STANDARD PLAN NOTES (CONSTRUCTION WASTE):**

1. ALL EXISTING STRUCTURES 500 SQUARE FEET AND LARGER SHALL BE ASSESSED PRIOR TO THE ISSUANCE OF A DEMOLITION PERMIT TO ENSURE COMPLIANCE WITH THE COUNTY'S REGULATED RECYCLABLE MATERIALS ORDINANCE (RRMO) AND TO ASSESS THE POTENTIAL FOR DECONSTRUCTION AND/OR THE REUSE OF SALVAGEABLE MATERIALS. CONTACT THE ORANGE COUNTY SW ENFORCEMENT OFFICER AT 919-968-2788 TO ARRANGE FOR THE ASSESSMENT.
2. PURSUANT TO THE COUNTY'S RRMO, CLEAN WOOD WASTE, SCRAP METAL, AND CORRUGATED CARDBOARD PRESENT IN CONSTRUCTION OR DEMOLITION WASTE MUST BE RECYCLED.
3. PURSUANT TO THE COUNTY'S RRMO, ALL HAULERS OF MIXED CONSTRUCTION AND DEMOLITION WASTE WHICH INCLUDES ANY REGULATED RECYCLABLE MATERIALS SHALL BE LICENSED BY ORANGE COUNTY.
4. PRIOR TO ANY DEMOLITION OR CONSTRUCTION ACTIVITY ON THE SITE, THE APPLICANT SHALL HOLD A PRE-DEMOLITION/PRE-CONSTRUCTION CONFERENCE WITH SOLID WASTE STAFF. THIS MAY BE THE SAME PRE-CONSTRUCTION MEETING HELD WITH OTHER DEVELOPMENT/ENFORCEMENT OFFICIALS.
5. THE PRESENCE OF ANY ASBESTOS CONTAINING MATERIALS (ACM) AND/OR OTHER HAZARDOUS MATERIALS SHALL BE HANDLED IN ACCORDANCE WITH ANY AND ALL LOCAL, STATE, AND FEDERAL REGULATIONS AND GUIDELINES.

**LANDSCAPE PROTECTION NOTES:**

1. PLAN SHOWS RARE AND SPECIMEN TREES IN ACCORDANCE WITH THE ORDINANCE THAT WAS IN EFFECT AT THE TIME OF APPROVAL.
2. LANDSCAPING ON EAST SIDE OF SITE ALONG THE ALTERNATIVE BUFFER SHALL BE COORDINATED TO PRESERVE EXISTING TREES AS MUCH AS POSSIBLE. PROPOSED PLANTINGS IN BUFFER MAY ENCRoACH BEYOND "TREE PROTECTION" FENCE. CONFLICTS BETWEEN PROPOSED PLANTINGS AND EXISTING TREES SHALL BE BROUGHT TO THE ATTENTION OF THE LANDSCAPE ARCHITECT FOR REMEDIATION.
3. ALL IRRIGATION SYSTEMS SHALL BE EQUIPPED WITH AUTOMATIC CONTROLLERS THAT ACTIVATE THE SYSTEM ACCORDING TO A DESIRED FREQUENCY AND DURATION, AND SHALL ALSO BE EQUIPPED WITH RAIN OR SOIL MOISTURE SENSORS THAT WILL PREVENT IRRIGATION DURING PERIODS OF RAINFALL OR WHEN THERE IS SUFFICIENT MOISTURE IN THE GROUND FOR PLANT HEALTH AND SURVIVAL IN ACCORDANCE WITH THE LOCAL GOVERNMENT WATER CONSERVATION ORDINANCES.

**PAVEMENT MARKING/SIGNAGE NOTES:**

1. ALL SIGNAGE SHALL BE COORDINATED WITH THE TOWN OF CHAPEL HILL.
2. ALL SIGNAGE SHALL MEET MUTCD STANDARDS AND SPECIFICATIONS.
3. ALL SIGNAGE SHALL MEET NCDOT PEDESTRIAN SAFETY SPECIFICATIONS.
4. ALL CONSTRUCTION SHALL CONFORM TO THE LATEST NORTH CAROLINA DEPARTMENT OF TRANSPORTATION (NCDOT) AND/OR TOWN OF CHAPEL HILL STANDARDS AND SPECIFICATIONS.
5. ALL SIGNS SHALL BE PRISMATIC AND ADHERE TO THE MINIMAL RETROREFLECTIVITY STANDARDS FOUND IN THE LATEST VERSION OF THE MUTCD.
6. ALL PAVEMENT MARKINGS ON PUBLIC STREETS SHALL BE THERMOPLASTIC AND ARE TO BE PLACED PER NCDOT STANDARDS (REFERENCE 2012 NCDOT DETAILS (1205.01-1205.12)
7. SIGN DESIGNS FOR STREET NAME SIGNS SHALL BE APPROVED BY TRANSPORTATION/ENGINEERING DEPARTMENT STAFF TO ENSURE COMPLIANCE WITH MUTCD SPECIFICATIONS. DESIGNS MUST BE APPROVED BY TOWN STAFF PRIOR TO ACCEPTANCE OF STREETS OR ISSUANCE OF 1ST CO.
8. ALL STREET NAME SIGNS SHALL CONFORM TO THE LATEST EDITION OF THE MUTCD INCLUDING MIXED CASE LETTERING, PROPPER LETTER HEIGHTS, AND RETROREFLECTIVITY.

**GENERAL NOTES:**

1. CONTRACTOR TO NOTIFY SURROUNDING PROPERTIES 7 DAYS PRIOR TO STARTING CONSTRUCTION.
2. CONTRACTOR TO PROVIDE NOTICE TO THE TOWN OF CHAPEL HILL REGARDING SPECIFIC DATES FOR ANY NECESSARY ROAD CLOSURES AND LANE REDUCTIONS.
3. GENERAL CONTRACTOR TO COORDINATE WITH SPECIFIC PROPERTIES AFFECTED BY THE PROPOSED ROAD CLOSURES IF REQUIRED TO ENSURE CONTINUOUS ACCESS TO THE AFFECTED PROPERTIES.
4. SETBACKS ARE PROPOSED UNDER THE PLANNED DEVELOPMENT HOUSING PROVISION OF THE LUMO AND ARE NOTED ON THIS SHEET.
5. ALL PARKING SHOWN SPACE MARKINGS SHALL BE PER THE TOWN OF CHAPEL HILL CODE FOR PARKING LOTS.
6. MINIMUM CORNER CLEARANCES FROM THE CURBLINE OF INTERSECTING STREETS SHALL BE AT LEAST 20' FROM THE POINT OF TANGENCY. NO DRIVEWAYS OR PARKING SPACES SHALL ENCRoACH ON THIS MINIMUM CORNER CLEARANCE.
7. WITHIN THE SIGHT DISTANCE TRIANGLES SHOWN, NO OBSTRUCTION BETWEEN 7' AND 8' IN HEIGHT ABOVE THE CURB LINE ELEVATION SHALL BE LOCATED IN WHOLE OR IN PART. OBSTRUCTIONS INCLUDE BUT ARE NOT LIMITED TO ANY BERM, FOLIAGE, FENCE, WALL, SIGN, OR PARKED VEHICLE.
8. ALL CONSTRUCTION SHALL CONFORM TO THE LATEST TOWN OF CHAPEL HILL, NCDOT AND OWASA STANDARDS AND SPECIFICATIONS.
9. ALL DIMENSIONS SHOWN ON SITE PLAN ARE TO FACE OF CURB UNLESS OTHERWISE NOTED.
10. OCCUPATIONAL SAFETY AND HEALTH ADMINISTRATION (OSHA) STANDARDS FOR EXCAVATIONS; FINAL RULE 29CFR 1910.126, SUBPART 1910.126 APPLIES TO EXCAVATIONS EXCEEDING FIVE (5) FEET IN DEPTH. EXCAVATION EXCEEDING TWENTY (20) FEET IN DEPTH REQUIRES THE DESIGN OF A TRENCH SAFETY SYSTEM BY A REGISTERED PROFESSIONAL ENGINEER, PROVIDED BY CONTRACTOR RESPONSIBLE FOR EXCAVATION.
11. EQUIPMENT AND PRODUCTS OTHER THAN THOSE SPECIFIED MAY BE USED PROVIDED APPROVAL HAS BEEN OBTAINED FROM THE OWNER IN WRITING PRIOR TO ORDERING OR INSTALLATION. THE CONTRACTOR SHALL WAIVE ANY CLAIM FOR ADDITIONAL COST RELATED TO THE SUBSTITUTION OF ALTERNATE EQUIPMENT.
12. CONTRACTOR SHALL MAINTAIN AN "AS-BUILT" SET OF DRAWINGS TO RECORD THE EXACT LOCATION OF ALL PIPING PRIOR TO CONCEALMENT. DRAWINGS SHALL BE GIVEN TO THE OWNER UPON COMPLETION OF THE PROJECT WITH A COPY OF THE TRANSMITTAL LETTER TO THE ENGINEER.
13. CONTRACTOR IS RESPONSIBLE FOR COORDINATING CONSTRUCTION ACTIVITIES WITH THE APPROPRIATE UTILITY COMPANIES FOR ANY REQUIRED RELOCATION (I.E. POWER POLES, TELEPHONE PEDESTALS, WATER METERS, ETC.).
14. PRIOR TO STARTING CONSTRUCTION, THE GENERAL CONTRACTOR SHALL SCHEDULE AND HOLD A PRE-CONSTRUCTION CONFERENCE WITH THE TOWN OF CHAPEL HILL ENGINEERING DEPARTMENT, ORANGE COUNTY SOIL AND EROSION CONTROL ENGINEER, ENGINEER, AND OWNER/REPRESENTATIVE.
15. ALL DIMENSIONS AND GRADES SHOWN ON THE PLANS SHALL BE FIELD VERIFIED BY THE CONTRACTOR PRIOR TO CONSTRUCTION. CONTRACTOR SHALL NOTIFY THE ENGINEER IF ANY DISCREPANCIES EXIST PRIOR TO PROCEEDING WITH CONSTRUCTION FOR NECESSARY PLAN OR GRADE CHANGES. NO EXTRA COMPENSATION SHALL BE PAID TO CONTRACTOR FOR ANY WORK DONE DUE TO DIMENSIONS OR GRADES SHOWN INCORRECTLY ON THESE PLANS IF SUCH NOTIFICATION HAS NOT BEEN GIVEN.
16. ALL STREET NAME SIGNS SHALL CONFORM TO THE LATEST EDITION OF THE MUTCD INCLUDING MIXED CASE LETTERING, PROPER LETTER HEIGHTS, AND RETROREFLECTIVITY.
17. ALL ASPHALT EDGES SHALL BE SAW CUT TO PROVIDE A GOOD LONGITUDINAL JOINT. MILL 1.5 FEET AT 1.5 INCHES DEEP MINIMUM TO PROVIDE A LONGITUDINAL LAP JOINT FOR FINAL SURFACE LAYER. NO MILLING SHALL BE LEFT FOR A PERIOD OF TIME GREATER THAN 48 HOURS BEFORE A STREET IS TO BE REPAVED/RESURFACED.
18. SEPARATE BUILDING PERMITS ARE REQUIRED FOR RETAINING WALLS, DUMPSTER ENCLOSURES, MONUMENTS, SIGNS, OR OTHER ACCESSORY STRUCTURES OR ELEMENTS.
19. EXISTING UTILITIES AND STRUCTURES SHOWN, BOTH UNDERGROUND AND ABOVE GROUND, ARE BASED ON A FIELD SURVEY AND THE BEST AVAILABLE RECORD DRAWINGS. THE CONTRACTOR SHALL VERIFY FIELD CONDITIONS PRIOR TO BEGINNING RELATED CONSTRUCTION. ANY DISCREPANCIES SHALL BE REPORTED TO THE OWNER'S REPRESENTATIVE IMMEDIATELY.
20. THE CONTRACTOR SHALL BE RESPONSIBLE FOR THE LOCATION AND/OR RELOCATION OF ALL EXISTING UTILITIES IN COORDINATION WITH THE APPROPRIATE UTILITY, AGENCY, OR COMPANY.
21. EXISTING CONTOURS ARE BASED ON SURVEY COMPLETED BY TIMMONS. EXISTING UTILITIES SHOWN ARE BASED ON SURVEY AND THE BEST AVAILABLE RECORDS. THE CONTRACTOR, HOWEVER, SHALL VERIFY CONDITIONS PRIOR TO BEGINNING CONSTRUCTION. ANY DISCREPANCIES BETWEEN ACTUAL FIELD CONDITIONS AND THE PLANS SHALL BE REPORTED TO THE ENGINEER IMMEDIATELY. FOR NECESSARY PLAN OR GRADE CHANGES, NO EXTRA COMPENSATION SHALL BE PAID TO CONTRACTOR FOR ANY WORK DONE DUE TO DIMENSIONS OR GRADES SHOWN INCORRECTLY ON THESE PLANS IF SUCH NOTIFICATION HAS NOT BEEN GIVEN.
22. EXISTING IMPROVEMENTS DAMAGED DURING CONSTRUCTION SHALL BE REPLACED/RESTORED TO THEIR ORIGINAL CONDITION OR TO THE SATISFACTION OF THE OWNER BY THE CONTRACTOR RESPONSIBLE FOR THE DAMAGE.
23. A SINGLE ELECTRICAL SERVICE SHALL BE PROVIDED TO SERVE EACH STRUCTURE WITH THE EXCEPTION OF THE FIRE PUMP.
24. MECHANICAL EQUIPMENT MUST BE PLACED AT OR ABOVE THE BASE FLOOD ELEVATION PLUS 2 FEET.
25. A ZONE FOR FIRE DEPARTMENT LADDERS AND FIREFIGHTING OPERATIONS MUST BE PROVIDED, REQUIRING ALL LINES TO BE BURIED SURROUNDING STRUCTURES.
26. BACK WASH WATER FROM THE POOL SHALL DISCHARGE INTO THE SANITARY SEWER SYSTEM, NOT STORM SEWER, AND SHALL NOT EXCEED 50 GALLONS PER MINUTE.
27. CONTRACTOR TO CONTACT THE CHAPEL HILL STORMWATER MANAGEMENT DIVISION AT 919-969-7246 TO SCHEDULE SITE INSPECTION AT LEAST TEN (10) DAYS IN ADVANCE OF REQUESTING THE CERTIFICATE OF OCCUPANCY.
28. IMPROVEMENTS, STRUCTURES, FIXTURES, SIGNS, TABLES, CHAIRS, PLANTERS, OR ANY OTHER OBJECT SHALL NOT BE PLACED IN SIDEWALK AREAS FOR ANY PERIOD OF TIME.
29. FLOOR DRAINS FROM THE ROOFED PARKING AREA AND HVAC CONDENSATE SHALL NOT BE CONNECTED TO THE STORM SEWER SYSTEM.
30. ANY ROOF DRAINS OR OTHER PLUMBING INTENDED TO DISCHARGE TO THE STORM SEWER SYSTEM NOT SHOWN ON THE APPROVED PLANS ARE NOT APPROVED. ANY DISCHARGE DIRECTED TO THE STORM SEWER SYSTEM THAT IS NOT APPROVED WILL NEED TO APPROVAL FROM THE TOWN OF CHAPEL HILL STORMWATER MANAGEMENT DIVISION.

31. THE NORTH CAROLINA DEPARTMENT OF INSURANCE SHALL REVIEW AND APPROVE ANY PROJECTS LISTED IN TABLE 104.1 OF THE NORTH CAROLINA ADMINISTRATION AND POLICIES CODE BEFORE THE TOWN OF CHAPEL HILL WILL BEGIN ITS BUILDING PERMIT REVIEW.
32. A SINGLE ELECTRICAL SERVICE SHALL BE PROVIDED TO SERVE THE STRUCTURE WITH THE EXCEPTION OF THE FIRE PUMP, IN ACCORDANCE WITH ARTICLE 230.2(A) OF THE 2017 NORTH CAROLINA ELECTRICAL CODE.
33. CURB AND GUTTER AND ATLEAST THE FIRST LIFT OF ASPHALT FOR THE ROADS MUST BE PLACED PRIOR TO THE START OF CONSTRUCTION.
34. PRIOR TO THE ISSUANCE OF A CERTIFICATE OF OCCUPANCY, THE APPLICANT SHALL PROVIDE THE MINIMUM REQUIRED HANDICAPPED PARKING SPACES AND DESIGN ALL HANDICAPPED PARKING SPACES, RAMPS, CROSSWALKS, AND ASSOCIATED INFRASTRUCTURE ACCORDING TO THE AMERICANS WITH DISABILITIES ACT STANDARDS, NORTH CAROLINA BUILDING CODE, AMERICAN NATIONAL STANDARDS INSTITUTE (ANSI) CODE, AND TOWN STANDARD.
- A. THE NUMBER OF PARKING SPACES SHALL COMPLY WITH NCBC 2018 SECTION 1106.1, 1 PER 6 COMPLIANT SPACES OR PORTION THEREOF MUST BE VAN ACCESSIBLE. NO SLOPE SHALL EXCEED 2% IN ANY DIRECTION. SIGNAGE SHALL BE PLACED IN ACCORDANCE WITH NCBC 2018 REQUIREMENTS, MUTCD AND ACC A 117.1.
  - B. CURB CUTS AND ACCESSIBLE ROUTES PER ICC A117.1 2009 EDITION, CROSS SLOPE LIMITED TO 2%. CALL TOWN OF CHAPEL HILL BUILDING INSPECTIONS OFFICE FOR INSPECTION PRIOR TO PLACEMENT OF CONCRETE.
  - C. SLOPES GREATER THAN 5% REQUIRES CONSTRUCTION AS A RAMP.
35. FINAL LOCATION OF GAS LINE INSTALLED BY DOMINION ENERGY TO BE VERIFIED IN FIELD PRIOR TO THE INSTALLATION OF ANY FURNISHINGS REQUIRING GAS CONNECTIONS, INCLUDING BUT NOT LIMITED TO FIRE PITS, FIRE TABLES AND OUTDOOR GRILLING STATIONS. CONTRACTOR SHALL COORDINATE WITH DOMINION ENERGY, LANDSCAPE ARCHITECT, ARCHITECT AND OWNER FOR CONNECTIONS TO GAS LINE. CONNECTIONS TO BE PROVIDED BY A LICENSED GAS FITTER/TECHNICIAN AND SHALL CONFIRM TO ALL LOCAL AND STATE REGULATIONS.

**GRADING & STORM DRAINAGE NOTES:**

1. CONTRACTOR SHALL NOTIFY NC 811 (1-800-632-4949) AT LEAST 3 FULL BUSINESS DAYS PRIOR TO BEGINNING CONSTRUCTION OR EXCAVATION TO HAVE EXISTING UTILITIES LOCATED. CONTRACTOR TO CONTACT ANY LOCAL UTILITIES THAT PROVIDE THEIR OWN LOCATOR SERVICES INDEPENDENT OF NC 811. REPORT ANY DISCREPANCIES TO THE ENGINEER IMMEDIATELY.
2. PRIOR TO STARTING CONSTRUCTION, THE CONTRACTOR SHALL HOLD A PRE-CONSTRUCTION CONFERENCE WITH THE ORANGE COUNTY SOIL AND EROSION CONTROL OFFICER, TOWN OF CHAPEL HILL STORM WATER MANAGEMENT DIVISION, AND OWNER'S REP/ENGINEER.
3. CONTRACTOR TO CONTACT MICHAEL WRIGHT WITH THE TOWN OF CHAPEL HILL AT 919-969-5084 TO POST EROSION CONTROL BOND PRIOR TO ANY LAND DISTURBANCE.
4. GRADING AND CONTOURS ARE BASED ON NORTH AMERICAN VERTICAL DATUM 88 (NAVDD88).
5. SOIL UNDER BUILDINGS AND PAVED AREAS SHALL BE APPROVED, PLACED AND COMPACTED AS RECOMMENDED BY THE GEOTECHNICAL ENGINEER AND SHOULD MEET OR EXCEED TOWN OF CHAPEL HILL STANDARDS.
6. GRADING IN AREAS DESIGNATED AS "ACCESSIBLE" SHALL COMPLY WITH ALL FEDERAL AND LOCAL ACCESSIBILITY RULES AND GUIDELINES. EVEN THOUGH PLANS MAY NOT SHOW ALL SPOT ELEVATIONS IN THESE REGIONS, IT IS THE RESPONSIBILITY OF THE CONTRACTOR TO ASSURE THAT THE AREAS ARE GRADED TO AMERICAN DISABILITY ACT (ADA) COMPLIANT SPECIFICATIONS.
7. IT IS THE RESPONSIBILITY OF THE CONTRACTOR TO IDENTIFY AREAS WHERE SPILL CURB IS NECESSARY TO CONVEY RUNOFF TO THE NEAREST CATCH BASIN OR DRAIN INLET. THE OWNER AND/OR ENGINEER SHALL NOT BE HELD RESPONSIBLE FOR CURBING INSTALLED PRIOR TO PAVING THAT DOES NOT DRAIN PROPERLY.
8. ALL PROPOSED INLETS, CATCH BASINS, AND DROP INLETS SHALL BE PROTECTED BY EROSION CONTROL MEASURES AS SHOWN AND SPECIFIED ON THE EROSION CONTROL PLAN
9. THE CURB INLETS AND YARD INLETS SHALL BE CONSTRUCTED IN THE LOCATIONS SHOWN UNLESS OTHERWISE DIRECTED BY THE ENGINEER. THE CONTRACTOR IS RESPONSIBLE FOR REPORTING ANY DISCREPANCIES IN THE CATCH BASIN ELEVATIONS OR THE PROPOSED PIPE SLOPES TO THE ENGINEER. THE CONTRACTOR IS ALSO RESPONSIBLE TO REPORT ANY CONFLICTS BETWEEN ANY UTILITY, STORM DRAIN LINE, WATER LINE, SEWER LINE OR ANY OTHER PROPOSED OR EXISTING STRUCTURE TO THE ENGINEER.
10. THE CONTRACTOR SHALL PROVIDE POSITIVE DRAINAGE AWAY FROM ALL BUILDING FOUNDATIONS. THE CONTRACTOR SHALL FIELD VERIFY GRADES SURROUNDING ALL BUILDINGS PRIOR TO GRADING ACTIVITIES AND REPORT ANY DISCREPANCIES TO THE ENGINEER IMMEDIATELY.
11. PIPE SPECIFIED AS RCP MAY BE SUBSTITUTED IF APPROVED BY THE TOWN OF CHAPEL HILL WITH APPROVED MATERIALS PER THE TOWN OF CHAPEL HILL STANDARDS AND SPECIFICATIONS OUTSIDE OF PUBLIC RIGHT OF WAY AND EASEMENTS. ALL BEDDING FOR ALTERNATE MATERIALS SHALL CONFORM TO NCDOT, ASHSTO AND ASTM SPECIFICATIONS.
12. THE MINIMUM PIPE SIZE WITHIN A PUBLIC RIGHT-OF-WAY IS 15".
13. FOR ALL PIPE OUTLETS 60" AND GREATER (SINGLE) AND 36" (MULTI COATED) CHAIN LINK FENCE HEADWALLS/ENDWALLS SHALL BE USED AND A 4" HIGH BLACK POLY COATED CHAIN LINK FENCE PLACED OVER THE WALL.
14. FOR NPDES PERMIT COMPLIANCE: ALL SLOPES 3:1 AND STEEPER MUST BE STABILIZED WITHIN 7 DAYS, ALL OTHER AREAS MUST BE STABILIZED WITHIN 14 DAYS.
15. ALL STORM PIPE SPECIFIED AS REINFORCED CONCRETE (RCP) SHALL BE MINIMUM CLASS III PIPE.
16. ALL STORM PIPE SHALL BE LAID AT LEAST 10' HORIZONTALLY OR 18" VERTICALLY FROM ANY WATER MAIN AND 24" VERTICALLY FROM ANY SEWER MAIN. REFER TO NCAC O2T RULES FOR EXEMPTIONS.
17. GEOTEXTILE FABRIC OR APPROVED EQUIVALENT ARE REQUIRED AT ALL DISSIPATOR PADS.

**FIRE DEPARTMENT NOTES:**

1. SITE SHALL COMPLY WITH THE LATEST NATIONAL BUILDING AND FIRE CODES.
2. FUNCTIONAL FIRE PROTECTION SHALL BE PROVIDED PRIOR TO THE ARRIVAL OF COMBUSTIBLE MATERIALS ON THE SITE.
3. FIRE ACCESS ROUTE SHALL HAVE A MINIMUM RADIUS OF 28' (FACE OF CURB) TO ALLOW FIRE APPARATUS ACCESS THROUGH SITE (IFC 503.2.4).
4. ANY GATES ACROSS FIRE APPARATUS ACCESS ROADS SHALL BE A MINIMUM WIDTH OF 20', BE OF SWINGING OR SLIDING TYPE AND HAVE AN EMERGENCY MEANS OF OPERATION. ALL GATES IN FIRE TRUCK APPARATUS ACCESS ROUTES SHALL BE OPERABLE BY EITHER FORCIBLE ENTRY OR KEVED AND MUST BE CAPABLE OF BEING OPERATED MY ONE PERSON. ALL GATES IN FIRE TRUCK APPARATUS ACCESS ROUTES SHALL BE INSTALLED AND MAINTAINED ACCORDING TO UL1375 AND ASTM F2200.
5. ALL PORTIONS OF THE FIRST FLOOR OF THE BUILDING MUST BE WITHIN 150' OF THE FIRE ACCESS ROUTE (IFC 503.1.1)
6. BUILDING ADDRESSES SHALL BE PLACED ON BOTH SIDES OF THE BUILDING ON A CLEARLY VISIBLE PLACARD FOR LOCATION PURPOSES.
7. ALL FIRE TRUCK ACCESSIBLE ROUTES SHALL BE RATED FOR 80,000 LB AND HAVE A MINIMUM CLEAR WIDTH OF 26' (IFC 503.2.1).
8. FIRE RISER ROOM SHALL BE EQUIPPED WITH AN EXTERNAL LOCK BOX.
9. RISER ROOM SHALL HAVE ADEQUATE DRAINAGE FOR EMERGENCY RPD DISCHARGE.
10. PRIVATE FIRE SERVICE MAINS AND APPURTENANCES SHALL BE INSTALLED IN ACCORDANCE WITH NFPA 24, NC FPC 507.2.1.
11. ALL CONSTRUCTION AND DEMOLITION CONDUCTED SHALL BE IN COMPLIANCE WITH THE CURRENT EDITION OF CHAPTER 14 OF THE NC FPC.
12. OPEN BURNING OF TREES, LIMBS, STUMPS, AND CONSTRUCTION DEBRIS ASSOCIATED WITH THIS DEVELOPMENT IS PROHIBITED.
13. DURING CONSTRUCTION, VEHICLE ACCESS FOR FIRE FIGHTING SHALL BE PROVIDED. TEMPORARY STREET SIGNS SHALL BE INSTALLED AT EACH STREET INTERSECTION WHEN CONSTRUCTION ALLOWS PASSAGE OF VEHICLES. SIGNS SHALL BE OF AN APPROVED SIZE, WEATHER RESISTANCE AND MAINTAINED UNTIL REPLACED BY PERMANENT SIGNS.
14. THE OWNER/DEVELOPER SHALL DESIGNATE ONE PERSON TO BE THE FIRE PREVENTION PROGRAM SUPERINTENDENT WHO SHALL BE RESPONSIBLE FOR ENFORCING CHAPTER 14 OF THE NCFPC AND THE ON-SITE FIRE PREVENTION PROGRAM AND ENSURE THAT IT IS CARRIED OUT THROUGH COMPLETION OF THE PROJECT.

**RETAINING WALL NOTES**

1. THE RETAINING WALL ALIGNMENT SHOWN ON THESE PLANS DEPICTS THE LOCATION OF THE FRONT FACE OF THE RETAINING WALL AT THE TOP OF THE WALL. THE CONTRACTOR IS RESPONSIBLE FOR ENSURING RETAINING WALLS ARE NOT LOCATED IN ANY STREAM BUFFERS, AND THEIR CONSTRUCTION DOES NOT ENCRoACH INTO ANY ADJACENT PROPERTIES DUE TO ANY BATTER INCORPORATED IN THE DESIGN OF THE WALLS.
2. RETAINING WALLS ARE TO BE DESIGN-BUILD PROJECTS BY THE CONTRACTOR. IT SHALL BE THE CONTRACTOR'S RESPONSIBILITY TO OBTAIN FINAL CONSTRUCTION DRAWINGS FROM A REGISTERED ENGINEER AND GAIN ALL REQUIRED PERMITS NECESSARY FOR THE CONSTRUCTION OF THE RETAINING WALLS.
3. RETAINING WALLS SHALL BE ASSUMED TO BE BACKFILLED WITH OFF-SITE BORROW MATERIAL OR PROCESSED FILL, UNLESS THE CONTRACTOR CAN PROVIDE TO THE OWNER WITH CONFIRMATION FROM THE GEOTECHNICAL ENGINEER AND THE RETAINING WALL DESIGNER, THAT READILY AVAILABLE ON-SITE SOILS CAN BE USED.
4. THE TOP AND BOTTOM OF WALL ELEVATIONS SHOWN ON THESE PLANS IDENTIFY FINISHED GRADE ELEVATIONS ONLY. THE EXTENT THAT THE RETAINING WALL WILL BE EXTENDED BELOW GRADE TO THE FOOTING OR ABOVE GRADE TO THE TOP OF THE CAP BLOCK COURSE SHALL BE IDENTIFIED ON THE RETAINING WALL CONSTRUCTION DRAWINGS.
5. ALL RETAINING WALLS OVER 30" HIGH SHALL HAVE A SAFETY FENCE (DESIGN BY OTHERS).
6. ANY PART OF ANY RETAINING WALL THAT EXTENDS INTO THE RIGHT-OF-WAY WILL REQUIRE AN ENCROACHMENT AGREEMENT. ENCROACHMENT AGREEMENTS FOR RETAINING WALLS SHALL BE APPROVED PRIOR TO CONSTRUCTION DRAWING APPROVAL.
7. ANY TIEBACK SYSTEMS FOR THE RETAINING WALLS SHALL NOT BE ALLOWED WITHIN PUBLIC RIGHT-OF-WAY.
8. STORMWATER RUN-OFF SHALL BE DIRECTED AWAY FROM RETAINING WALLS. ANY RUN-OFF FLOWING TO AND OVER A RETAINING WALL SHALL BE KEPT TO AN ABSOLUTE MINIMUM AND BROUGHT TO THE ATTENTION OF THE WALL DESIGNER PRIOR TO THEIR DESIGN.

**ORANGE WATER AND SEWER AUTHORITY UTILITY NOTES:**

1. STANDARDS AND SPECIFICATIONS - ALL CONSTRUCTION SHALL BE IN ACCORDANCE WITH OWASA STANDARDS AND SPECIFICATIONS LATEST REVISED EDITION.
2. PRECONSTRUCTION CONFERENCE - A PRECONSTRUCTION CONFERENCE WITH THE OWASA CONSTRUCTION INSPECTOR IS REQUIRED BEFORE BEGINNING ANY UTILITY CONSTRUCTION.
3. PROJECT ACCEPTANCE - IN ADDITION TO A FINAL INSPECTION APPROVED BY THE OWASA CONSTRUCTION INSPECTOR, THE FOLLOWING DOCUMENTS MUST BE RECEIVED AND APPROVED BY OWASA BEFORE ACCEPTANCE OF THE PROJECT AND THE SETTING OF METERS:
  - ENGINEER'S CERTIFICATION OF PUBLIC SEWER - ORIGINAL DOCUMENT
  - ENGINEER'S CERTIFICATION OF PUBLIC WATER - ORIGINAL DOCUMENT
  - ASSET LETTER - ORIGINAL DOCUMENT
  - LETTER OF DEDICATION - ORIGINAL DOCUMENT
  - AS BUILT DRAWINGS (INCLUDING 1"=100' SCALE SITE PLAN) AS BUILTS OF SEWER CONSTRUCTION SUBJECT TO REVIEW AND APPROVAL BY NCDENR DIVISION OF WATER QUALITY.
  - MANHOLE DATA SHEETS
  - RECORDED PLAT
  - ORIGINAL RECORDED WATER AND SEWER DEEDS OF EASEMENT - PREPARED USING OWASA'S STANDARD FORM.
4. SEWER STATEMENT - SEWER LINES UNDER CONSTRUCTION SHALL BE PLUGGED WITH A MECHANICAL PLUG AT THE FIRST MANHOLE UPSTREAM FROM THE POINT OF CONNECTION. PLUG SHALL BE PLACED IN THE OUTLET CONNECTION AND SECURED WITH STEEL CABLE. PLUG SHALL REMAIN IN PLACE UNTIL ACCEPTANCE OF LINES BY OWASA. WATER, STONE, DIRT, OR ANY OTHER DEBRIS SHALL NOT BE ALLOWED TO ENTER THE OWASA SANITARY SEWER SYSTEM DURING FLUSHING OPERATIONS OR AT ANY OTHER TIME. CONSTRUCTION TAKING PLACE IN THE VICINITY OF ANY EXISTING OWASA SEWER LINES OR MANHOLES SHALL NOT CAUSE ANY INFLOW OF SURFACE WATER OR DEBRIS TO ENTER THE REMAIN ACCESSIBLE AT ALL TIMES. THE OWNER AND/OR CONTRACTOR SHALL BE RESPONSIBLE FOR ANY DAMAGES INCURRED TO THE OWASA SANITARY SEWER SYSTEM AND FINES IMPOSED BY THE STATE OF NORTH CAROLINA DIVISION OF WATER QUALITY DUE TO SEWER SPILLS OR OVERFLOWS.
5. SEWER SERVICES - SEWER SERVICES LOCATED WITHIN PUBLIC RIGHT-OF-WAY OR OWASA SEWER EASEMENTS MUST BE CONSTRUCTED OF DUCTILE IRON PIPE FROM THE TAP UP TO AND INCLUDING THE FIRST CLEAN-OUT. EXCEPT FOR DEAD END MANHOLES, ALL 4" INCH SEWER SERVICES MUST BE TAPPED INTO THE SEWER MAIN. ALL 6" SERVICES MUST BE CONNECTED TO A MANHOLE. CLEANOUTS SHALL BE SPACED NO MORE THAN 75 FEET APART. CLEANOUTS LOCATED IN PAVEMENT AREAS SHALL BE HEAVY DUTY TRAFFIC RATED CONSTRUCTION.
6. BLOCKING AND RODDING - RETAINER GLANDS TO BE USED ON ALL MECHANICAL JOINTS IN ADDITION TO RODDING AND BLOCKING.
7. EXISTING VALVES - CONTRACTOR RESPONSIBLE FOR VERIFYING THAT EXISTING VALVE AT THE POINT OF CONNECTION TO THE OWASA SYSTEM IS ADEQUATE FOR PERFORMING AND PASSING HYDROSTATIC PRESSURE AND LEAKAGE TEST. CONTRACTOR, AT HIS EXPENSE, MAY OPTIONALLY REPLACE VALVE OR INSTALL A NEW VALVE FOR THE PURPOSE OF PERFORMING A PRESSURE TEST FOR NEW MAIN INSTALLATION. IF CONTRACTOR ELECTS TO PRESSURE TEST AGAINST EXISTING VALVE, CONTRACTOR ACCEPTS RESPONSIBILITY FOR ENSURING PASSING PRESSURE TEST IN ACCORDANCE WITH OWASA REQUIREMENTS. IN ANY CASE, NO CLAIM WHATSOEVER SHALL BE MADE AGAINST OWASA FOR FAILURE OF PRESSURE TEST. EXISTING WATER VALVES SHALL BE OPERATED BY OWASA PERSONNEL ONLY. VALVES THAT SEPARATE PURITY APPROVED WATER AND UNAPPROVED WATER ARE TO REMAIN CLOSED AT ALL TIMES. VALVES MAY BE TEMPORARILY OPENED FOR LOADING AND FLUSHING BY THE OWASA INSPECTOR ONLY.
8. DECHLORINATION REQUIREMENTS - THE CONTRACTOR SHALL BE RESPONSIBLE FOR NEUTRALIZATION OF CHLORINATED WATER AT THE POINT OF DISCHARGE FROM THE MAIN BEING TESTED. THIS SHALL OCCUR FOLLOWING CHLORINATED TO DISINFECT A MAIN OR ANY OTHER TIME WHEN ELEVATED LEVELS OF CHLORINE COULD POTENTIALLY BE DISCHARGED INTO THE ENVIRONMENT BY THE CONTRACTOR. AT THE TIME THE DISINFECTION AND PURITY TESTING PROCEDURES ARE DISCUSSED WITH THE OWASA CONSTRUCTION INSPECTOR, THE PROCEDURE FOR DECHLORINATION WILL BE COVERED. ABSOLUTELY NO FLUSHING, DISINFECTION, OR PURITY SAMPLING IS TO TAKE PLACE WITHOUT PRIOR APPROVAL OF A SAMPLING PLAN BY THE OWASA INSPECTOR.
9. DEWATERING OF THE POOL SHALL NOT DISCHARGE INTO STORM SYSTEM UNLESS DE-CHLORINATED PRIOR TO DEWATERING.
10. PLEASE BE ADVISED THAT OWASA APPROVAL OF THIS PROJECT IS FOR COMPLIANCE WITH OWASA POLICIES, STANDARDS, AND SPECIFICATIONS ONLY. ALL OTHER MATTERS PERTAINING TO THIS PROJECT ARE THE RESPONSIBILITY OF THE DESIGN ENGINEER. OWASA APPROVAL DOES NOT PRECLUDE THE DEVELOPER, PROJECT ENGINEER, CONTRACTOR, OR OTHER AGENTS OR PARTIES ACTING ON THEIR BEHALF FROM FULL COMPLIANCE WITH OWASA CURRENT STANDARDS, SPECIFICATIONS, AND PROCEDURES OR FROM COMPLYING WITH ANY AND ALL STATUTES, RULES, REGULATIONS, AND ORDINANCES WHICH MAY BE IMPOSED BY OTHER GOVERNMENT AGENCIES (LOCAL, STATE, AND FEDERAL) WHICH MAY HAVE JURISDICTION. VIOLATIONS WILL RESULT IN THE OWASA PROJECT APPROVAL BEING RESCINDED.
11. CONTACT NC 811 (811 or 1-800-632-4949) AND OWASA (919-968-4421) AT LEAST 3 FULL BUSINESS DAYS PRIOR TO ANY EXCAVATION OR CONSTRUCTION TO HAVE EXISTING UTILITIES LOCATED.
12. DISCHARGE FROM THIS PROJECT MUST BE IN COMPLIANCE WITH THE OWASA SEWER USE ORDINANCE. A GREASE INTERCEPTOR SHALL BE PROVIDED WHEN IN THE OPINION OF OWASA IT IS NECESSARY FOR THE PROPER HANDLING OF WASTEWATER CONTAINING EXCESSIVE AMOUNTS OF GREASE. ALL INTERCEPTION UNITS MUST BE OF THE TYPE AND CAPACITY WHICH IS CERTIFIED BY THE PROJECT ENGINEER AS MEETING THE REQUIREMENTS OF OWASA.
13. BACKFLOW PREVENTION WILL BE REQUIRED IN ACCORDANCE WITH OWASA CROSS-CONNECTION CONTROL ORDINANCE AND MANUAL.
14. DOMESTIC SERVICE TO INCLUDE REDUCED PRESSURE BACKFLOW PREVENTION ASSEMBLY.
15. FIRE SERVICE TO INCLUDE RPDA BACKFLOW DEVICE.
16. FIRE PROTECTION SYSTEMS - PRESSURE TESTING, CHLORINATION, AND PURITY TESTING SHALL BE COMPLETED BEFORE THE INSTALLATION OF THE RPDA UNIT.
17. REMOTE READ-OUT DEVICES - RPDA AND RP2 DEVICES LOCATED INSIDE BUILDINGS MUST BE EQUIPPED WITH AN AMM METER TO BE PURCHASED FROM OWASA AND INSTALLED BY THE CONTRACTOR. CONTACT THE OWASA CONSTRUCTION INSPECTOR FOR DETAILS OF THIS INSTALLATION.
18. FOR FIRE SERVICE BACKFLOW DEVICES, USE A DOUBLE CHECK DETECTOR, REDUCED PRESSURE ZONE ASSEMBLY MEETING THE STANDARDS OF THE OWASA CROSS CONNECTION CONTROL ORDINANCE AND MANUAL. INSTALL THE DEVICE IN AN INTERNAL RISER ROOM WITH EXTERNAL ACCESS. CLEARANCES SHALL COMPLY WITH THE OWASA CROSS CONNECTION CONTROL ORDINANCES AND MANUAL. ACCESS TO RISER ROOM FROM OUTSIDE SHALL INCLUDE PROVISIONS FOR THE FIRE DEPARTMENT SUCH AS A KNOX BOX.
19. ALL BUILDINGS WITH FIRE SUPPRESSION LINES MUST HAVE BACKFLOW DEVICES LOCATED INSIDE THE BUILDING IN AN ABOVE GROUND LOCATION ADJACENT TO THE OUTSIDE WALL WHERE THE WATERLINE ENTERS THE BUILDING.
20. FOR IRRIGATION SERVICE BACKFLOW DEVICE, USE A REDUCED PRESSURE ZONE ASSEMBLY MEETING THE STANDARDS OF THE OWASA CROSS CONNECTION CONTROL ORDINANCE AND MANUAL. INSTALL THE IRRIGATION DEVICE INSIDE AN ABOVE GROUND HOT BOX.
21. UNDERGROUND VAULTS FOR METERS SHALL BE DRAINED BY PVC SCHEDULE 40 DRAINS TO DAYLIGHT INTO SLOPES. CONNECTION TO STORM STRUCTURES IS ONLY ALLOWED WITH THE CONSENT OF OWASA. DRAIN SIZES SHALL BE 2" DIAMETER FOR METERS OR DEVICES LESS THAN 2" AND SHALL BE 4" DIAMETER FOR DEVICES OVER 2".
22. CONNECTION OF SANITARY SEWER SERVICE TO AN EXISTING MANHOLE SHALL COMPLY WITH OWASA STANDARDS, INCLUDING: CORE DRILL FOR OPENING INTO MANHOLE AND INSTALL WITH FLEXIBLE BOOT. IF PAVEMENT CUT IS REQUIRED, CONTRACTOR SHALL PATCH PAVEMENT IN ACCORDANCE WITH TOWN OF CHAPEL HILL STANDARDS AND PROPER GEOTECHNICAL INFORMATION FOR SOIL LOADING.
23. IF HYDRAULIC ELEVATORS ARE USED THE SUMP MUST BE PLUMBED TO SANITARY SEWER LINES.
24. FIRE HYDRANTS MUST BE FULLY FUNCTIONAL AND PHYSICALLY APPROVED BY OWASA BEFORE COMBUSTIBLE MATERIALS CAN BE BROUGHT ON TO THE SITE.



phone 919. 361. 5000  
fax 919. 361. 2269  
license number: C-0293, C-187

www.mcadamsco.com

**CLIENT**

TRINSC RESIDENTIAL GROUP  
110 CORCORAN STREET, 5TH FLOOR  
DURHAM, NORTH CAROLINA, 27701  
PHONE: 919. 884. 7395

**AURA**  
CONDITIONAL ZONING PERMIT  
NORTH ESTES DRIVE  
CHAPEL HILL, NORTH CAROLINA, 27516



**REVISIONS**

NO.	DATE	REVISION DESCRIPTION
1	11.13.2020	REVISED PER 1ST CZP COMMENTS
2	12.18.2020	REVISED PER 2ND CZP COMMENTS
3	01.29.2021	REVISED PER 3RD CZP COMMENTS

**PLAN INFORMATION**

PROJECT NO. TRG-20000  
FILENAME TRG20000-N1  
CHECKED BY ZNB  
DRAWN BY CJJ  
SCALE N/A  
DATE 09.24.2020

**SHEET**

**PROJECT NOTES**

**CO.00**



**Know what's below.  
Call before you dig.**

**CONTRACTOR SHALL NOTIFY "NC811" (811) OR (1-800-632-4949) AT LEAST 3 FULL BUSINESS DAYS PRIOR TO BEGINNING CONSTRUCTION OR EXCAVATION TO HAVE EXISTING UTILITIES LOCATED. CONTRACTOR SHALL CONTACT ANY LOCAL UTILITIES THAT PROVIDE THEIR OWN LOCATOR SERVICES INDEPENDENT OF "NC811". REPORT ANY DISCREPANCIES TO THE ENGINEER IMMEDIATELY.**



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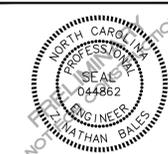
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fax 919. 361. 2269  
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110 CORCORAN STREET, 5TH FLOOR  
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**PLAN INFORMATION**

PROJECT NO. TRG-20000  
FILENAME TRG20000-AM1  
CHECKED BY ZNB  
DRAWN BY CJJ  
SCALE 1"=200'  
DATE 09.24.2020

**SHEET**

**AREA MAP**



**C0.01**

**GENERAL NOTES**

- PIN'S AND PROPERTY INFORMATION FROM CHAPEL HILL/ORANGE COUNTY GIS.
- BOUNDARY FROM SURVEY BY THE JOHN R. McADAMS COMPANY COMPLETED 07/08/2020.

**LEGEND**

- 1,000' REQUIRED NOTIFICATION BOUNDARY
- PROJECT AREA
- ZONING DISTRICT LINE

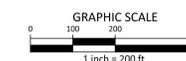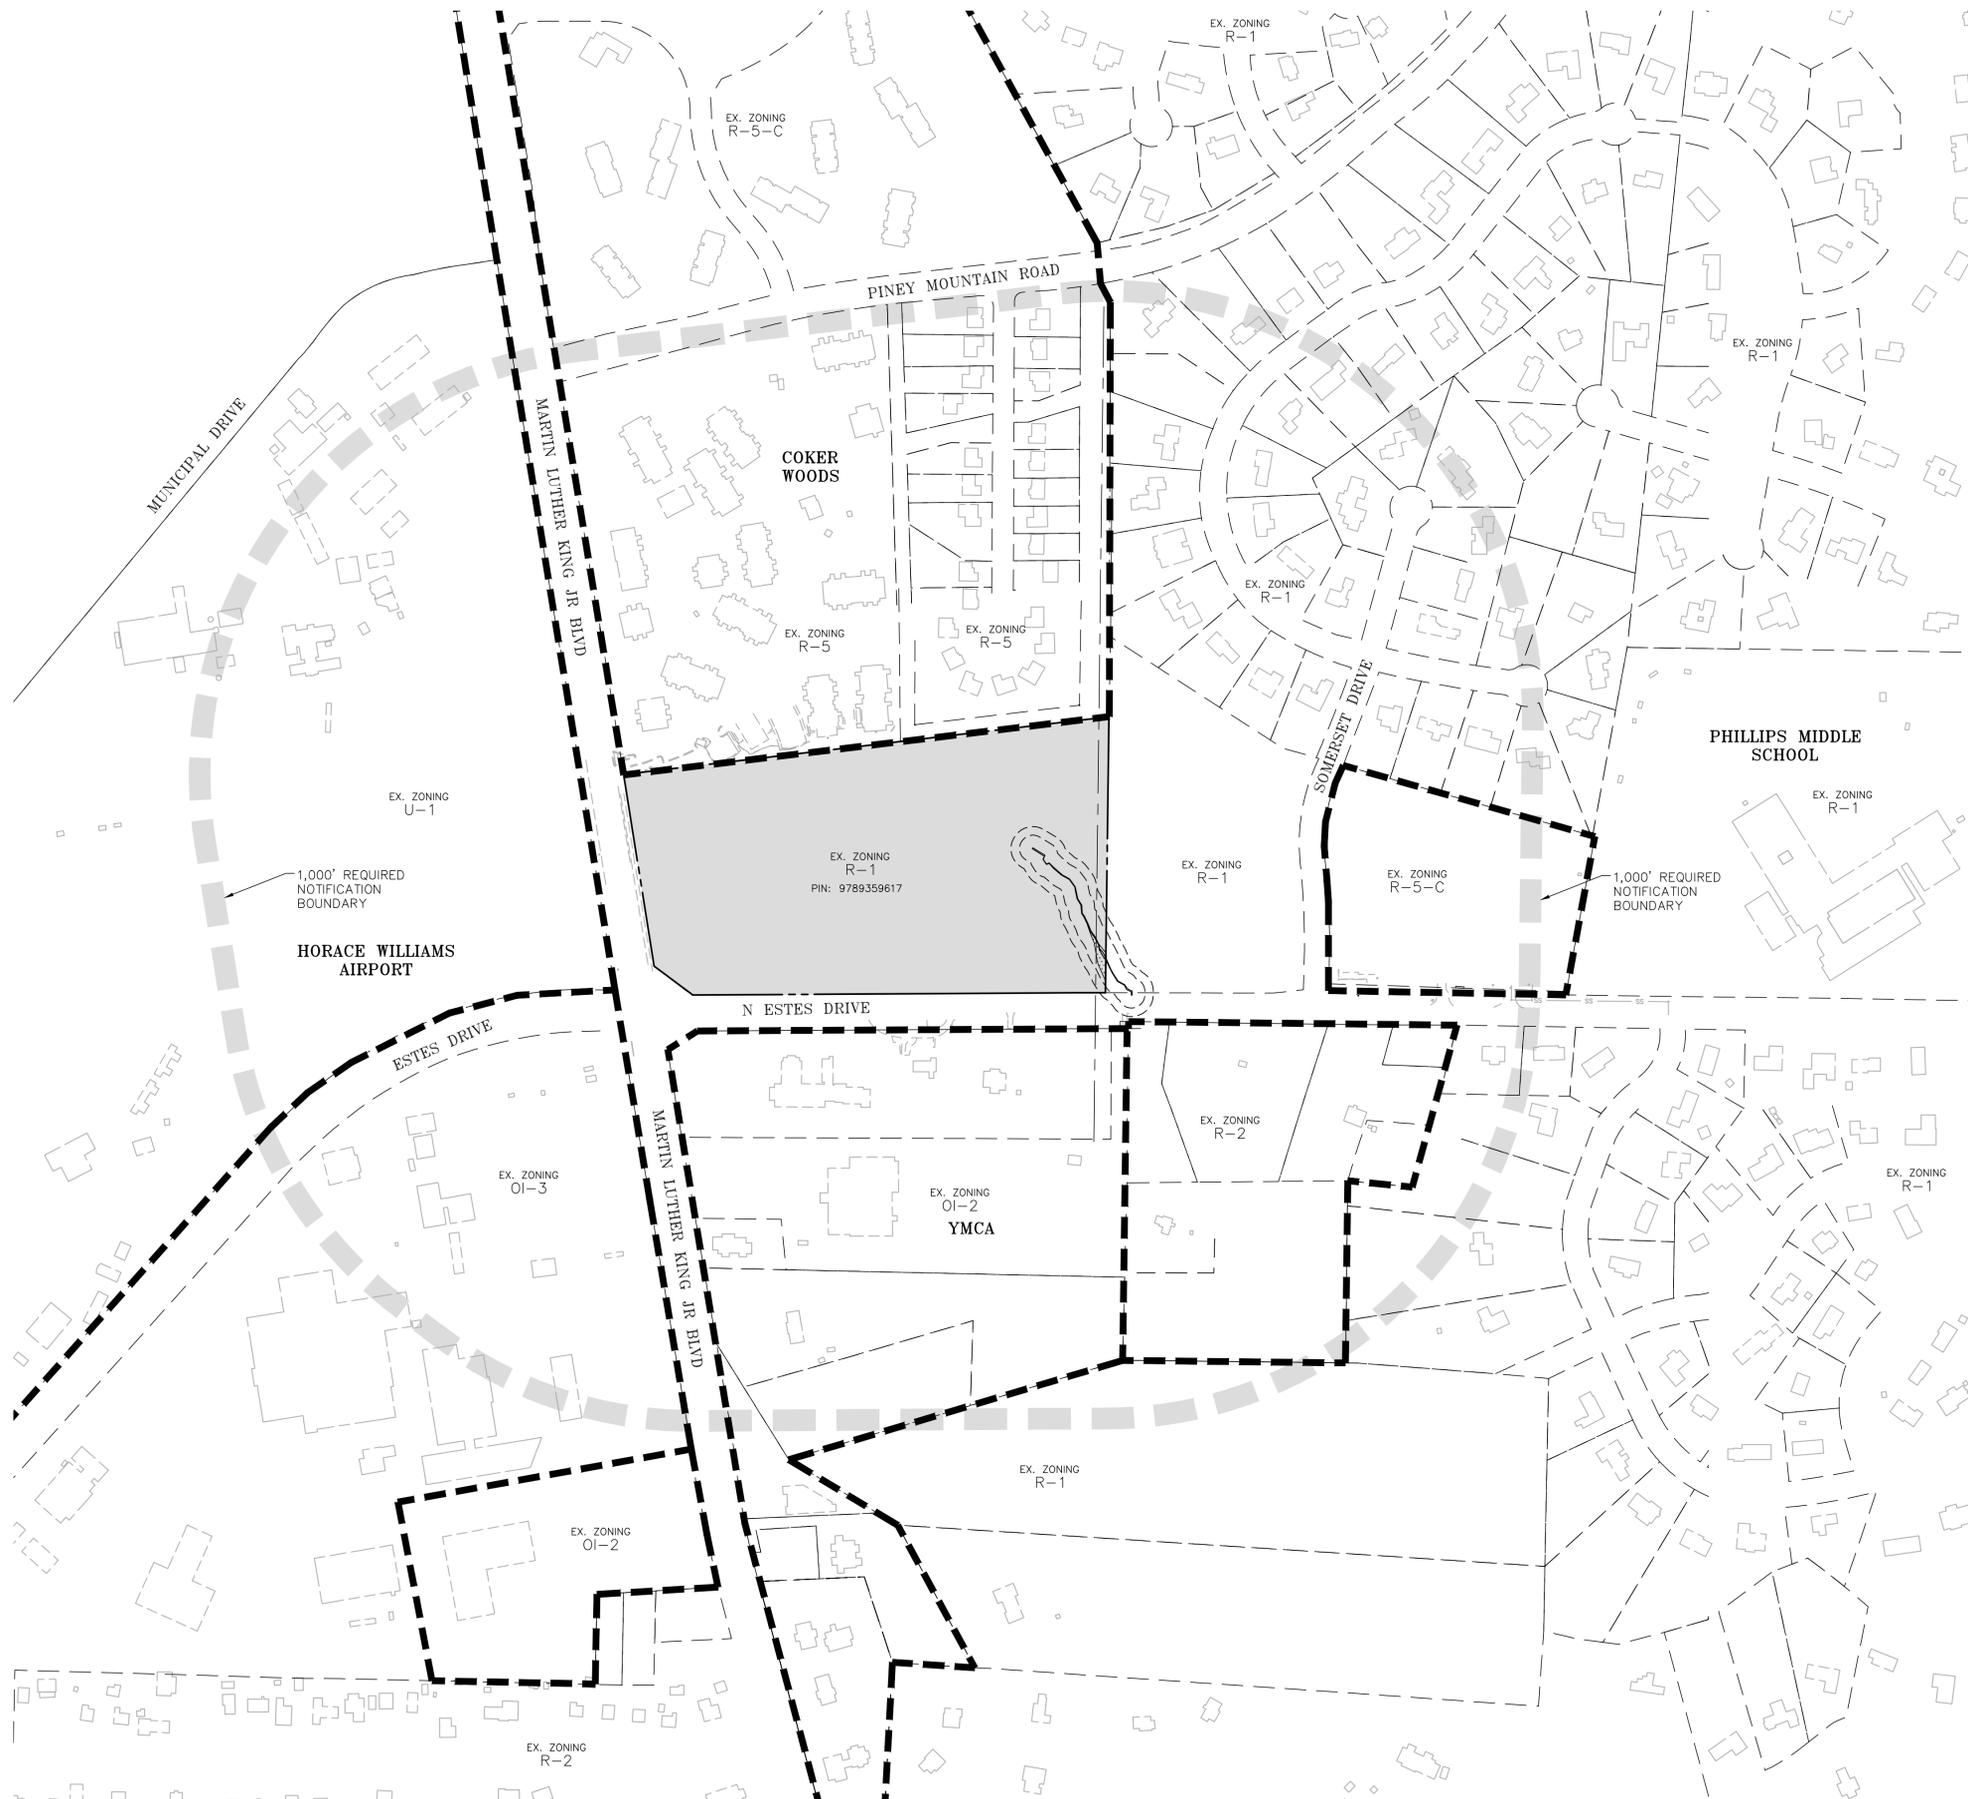

PRELIMINARY DRAWING - NOT RELEASED FOR CONSTRUCTION

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Durham, NC 27713


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fax 919.361.2269  
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**LEGEND**

- PROPERTY BOUNDARY
- ADJOINING PARCEL SHAPEFILE
- WOODLINE
- LANDSCAPED AREA
- OU --- OVERHEAD UTILITY
- FO --- FIBER OPTIC LINE
- G --- GAS LINE
- W --- WATER LINE
- UE --- UNDERGROUND ELECTRIC
- WOOD FENCE
- CHAIN LINK FENCE
- JORDAN LAKE RIPARIAN BUFFER
- TRANSMISSION RIGHT OF WAY
- OWASA EASEMENT
- REBAR FOUND
- IRON PIPE FOUND
- IRON PIPE SET
- CONCRETE MONUMENT FOUND
- SANITARY SEWER MANHOLE
- SANITARY SEWER CLEANOUT
- STORM CATCH BASIN
- UTILITY POLE
- GUY WIRE
- LIGHT POLE
- SIGN
- FIBER OPTIC MARKER
- FIBER OPTIC HANDHOLE
- FIBER OPTIC BOX
- COMMUNICATIONS VAULT
- TRAFFIC HANDHOLE
- TRAFFIC SIGNAL BOX
- ELECTRIC METER
- WATER VALVE
- WATER MANHOLE
- WATER METER
- HYDRANT
- GAS VALVE
- GAS TEST STATION
- MAILBOX
- ELECTRIC TRANSFORMER
- IRRIGATION CONTROL VALVE
- TEMPORARY BENCHMARK

**LINE TABLE**

LINE	BEARING	DISTANCE
L1	N 09°09'58" W	40.09'


- SURVEY NOTES**
1. THIS EXISTING CONDITIONS SURVEY WAS COMPLETED ON JULY 8, 2020.
  2. BEARINGS AND COORDINATES SHOWN ON THE PLAT ARE BASED ON NORTH CAROLINA STATE PLANE GRID NAD 83 (2011) ADJUSTMENT UNLESS NOTED OTHERWISE.
  3. ALL DISTANCES ARE HORIZONTAL GROUND DISTANCES UNLESS NOTED OTHERWISE.
  4. VERTICAL DATUM IS NAVD 88 BASED ON WOODS BARCLAY AND TEN #601.
  5. AREAS SHOWN ON THIS MAP COMPUTED BY THE COORDINATE METHOD.
  6. PROPERTY OWNER INFORMATION OBTAINED FROM ORANGE COUNTY GIS.
  7. THE SUBJECT PROPERTIES ARE **NOT** LOCATED IN A SPECIAL FLOOD HAZARD ZONE. THEY ARE LOCATED IN ZONE "X" AS DEFINED BY F.E.M.A. F.I.R.M. COMMUNITY PANEL #3710978900J, DATED FEBRUARY 2, 2007.

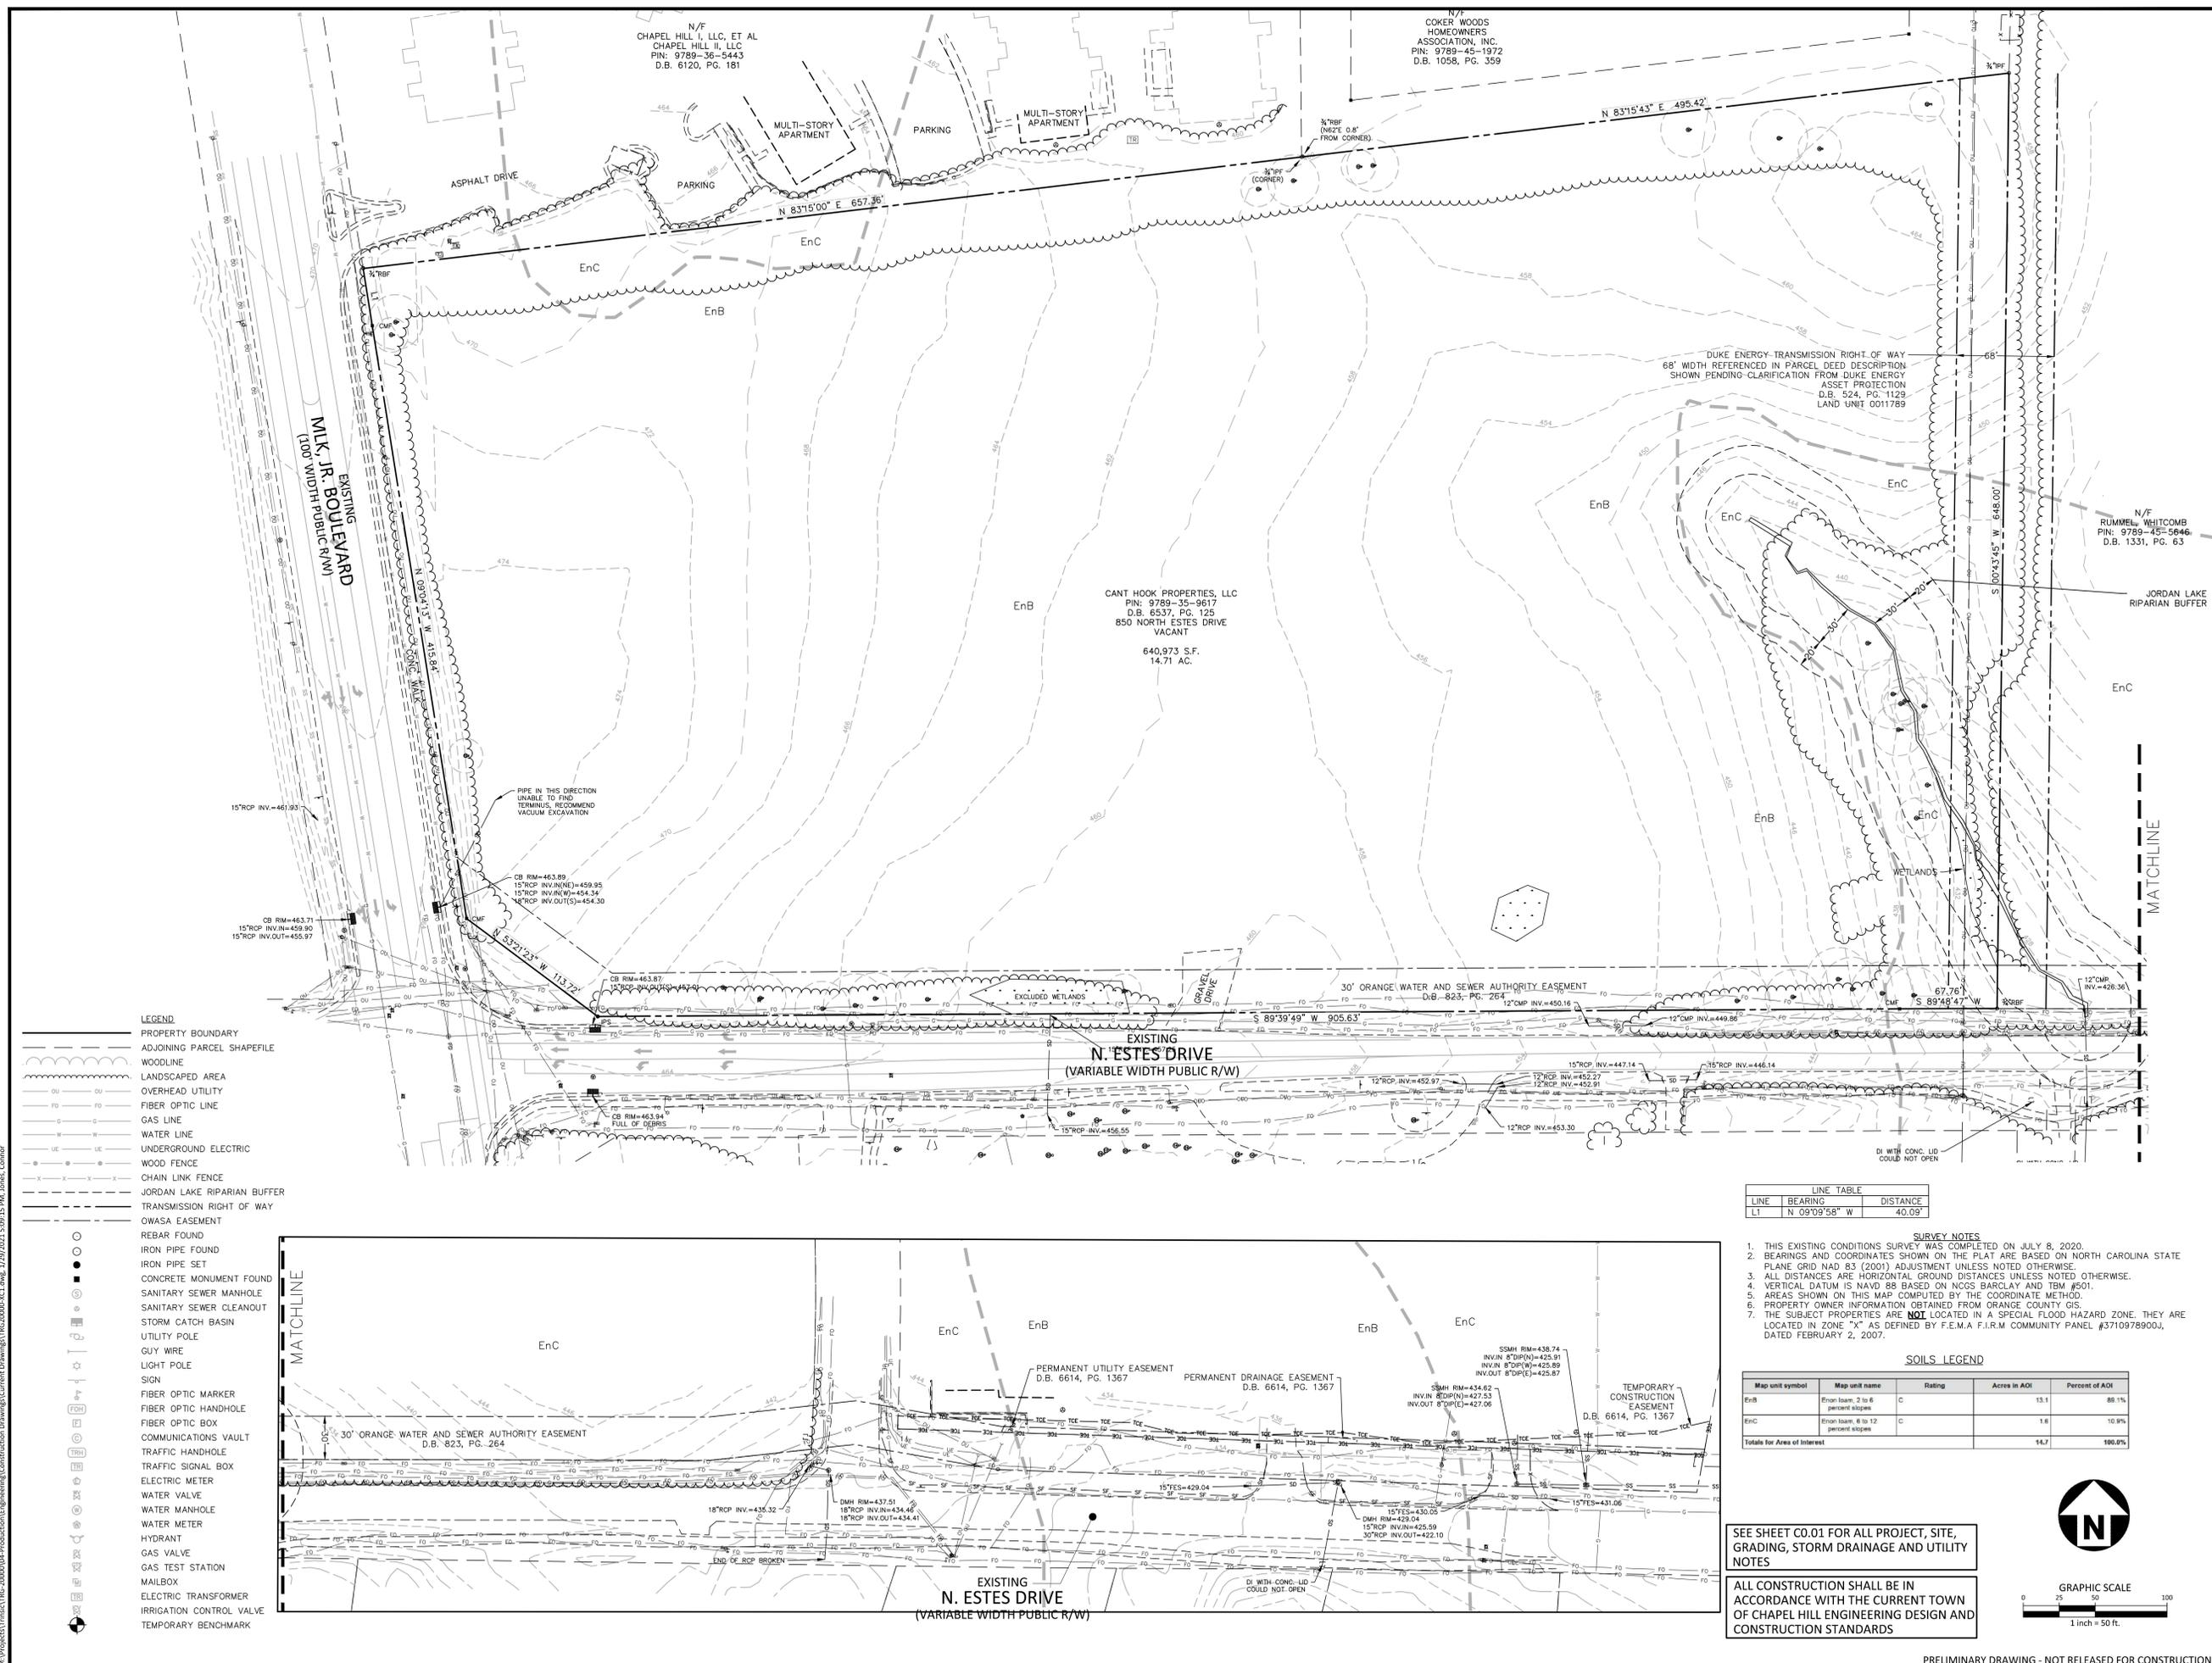**SOILS LEGEND**

Map unit symbol	Map unit name	Rating	Acres in AOI	Percent of AOI
EnB	Enon loam, 2 to 6 percent slopes	C	13.1	85.1%
EnC	Enon loam, 8 to 12 percent slopes	C	1.6	10.9%
Totals for Area of Interest			14.7	100.0%

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3	01.29.2021	REVISED PER 3RD CPZ COMMENTS

**PLAN INFORMATION**

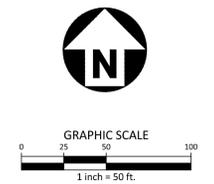PROJECT NO. TRG-20000  
FILENAME TRG20000-XC1  
CHECKED BY ZNB  
DRAWN BY CJJ  
SCALE 1"=50'  
DATE 09.24.2020

**EXISTING CONDITIONS**

**C1.00**

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**McADAMS**

The John R. McAdams Company, Inc.  
2905 Meridian Parkway  
Durham, NC 27713

phone 919. 361. 5000  
fax 919. 361. 2269  
license number: C-0293, C-187

www.mcadamsco.com

**CLIENT**

TRINIS RESIDENTIAL GROUP  
110 CORCORAN STREET, 5TH FLOOR  
DURHAM, NORTH CAROLINA, 27701  
PHONE: 919. 884. 7395

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3	01.29.2021	REVISED PER 3RD CZP COMMENTS


**PLAN INFORMATION**

PROJECT NO. TRG-20000  
FILENAME TRG20000-SS1  
CHECKED BY ZNB  
DRAWN BY CJJ  
SCALE 1"=50'  
DATE 09.24.2020

**SHEET**

**STEEP SLOPES PLAN**

**C1.01**

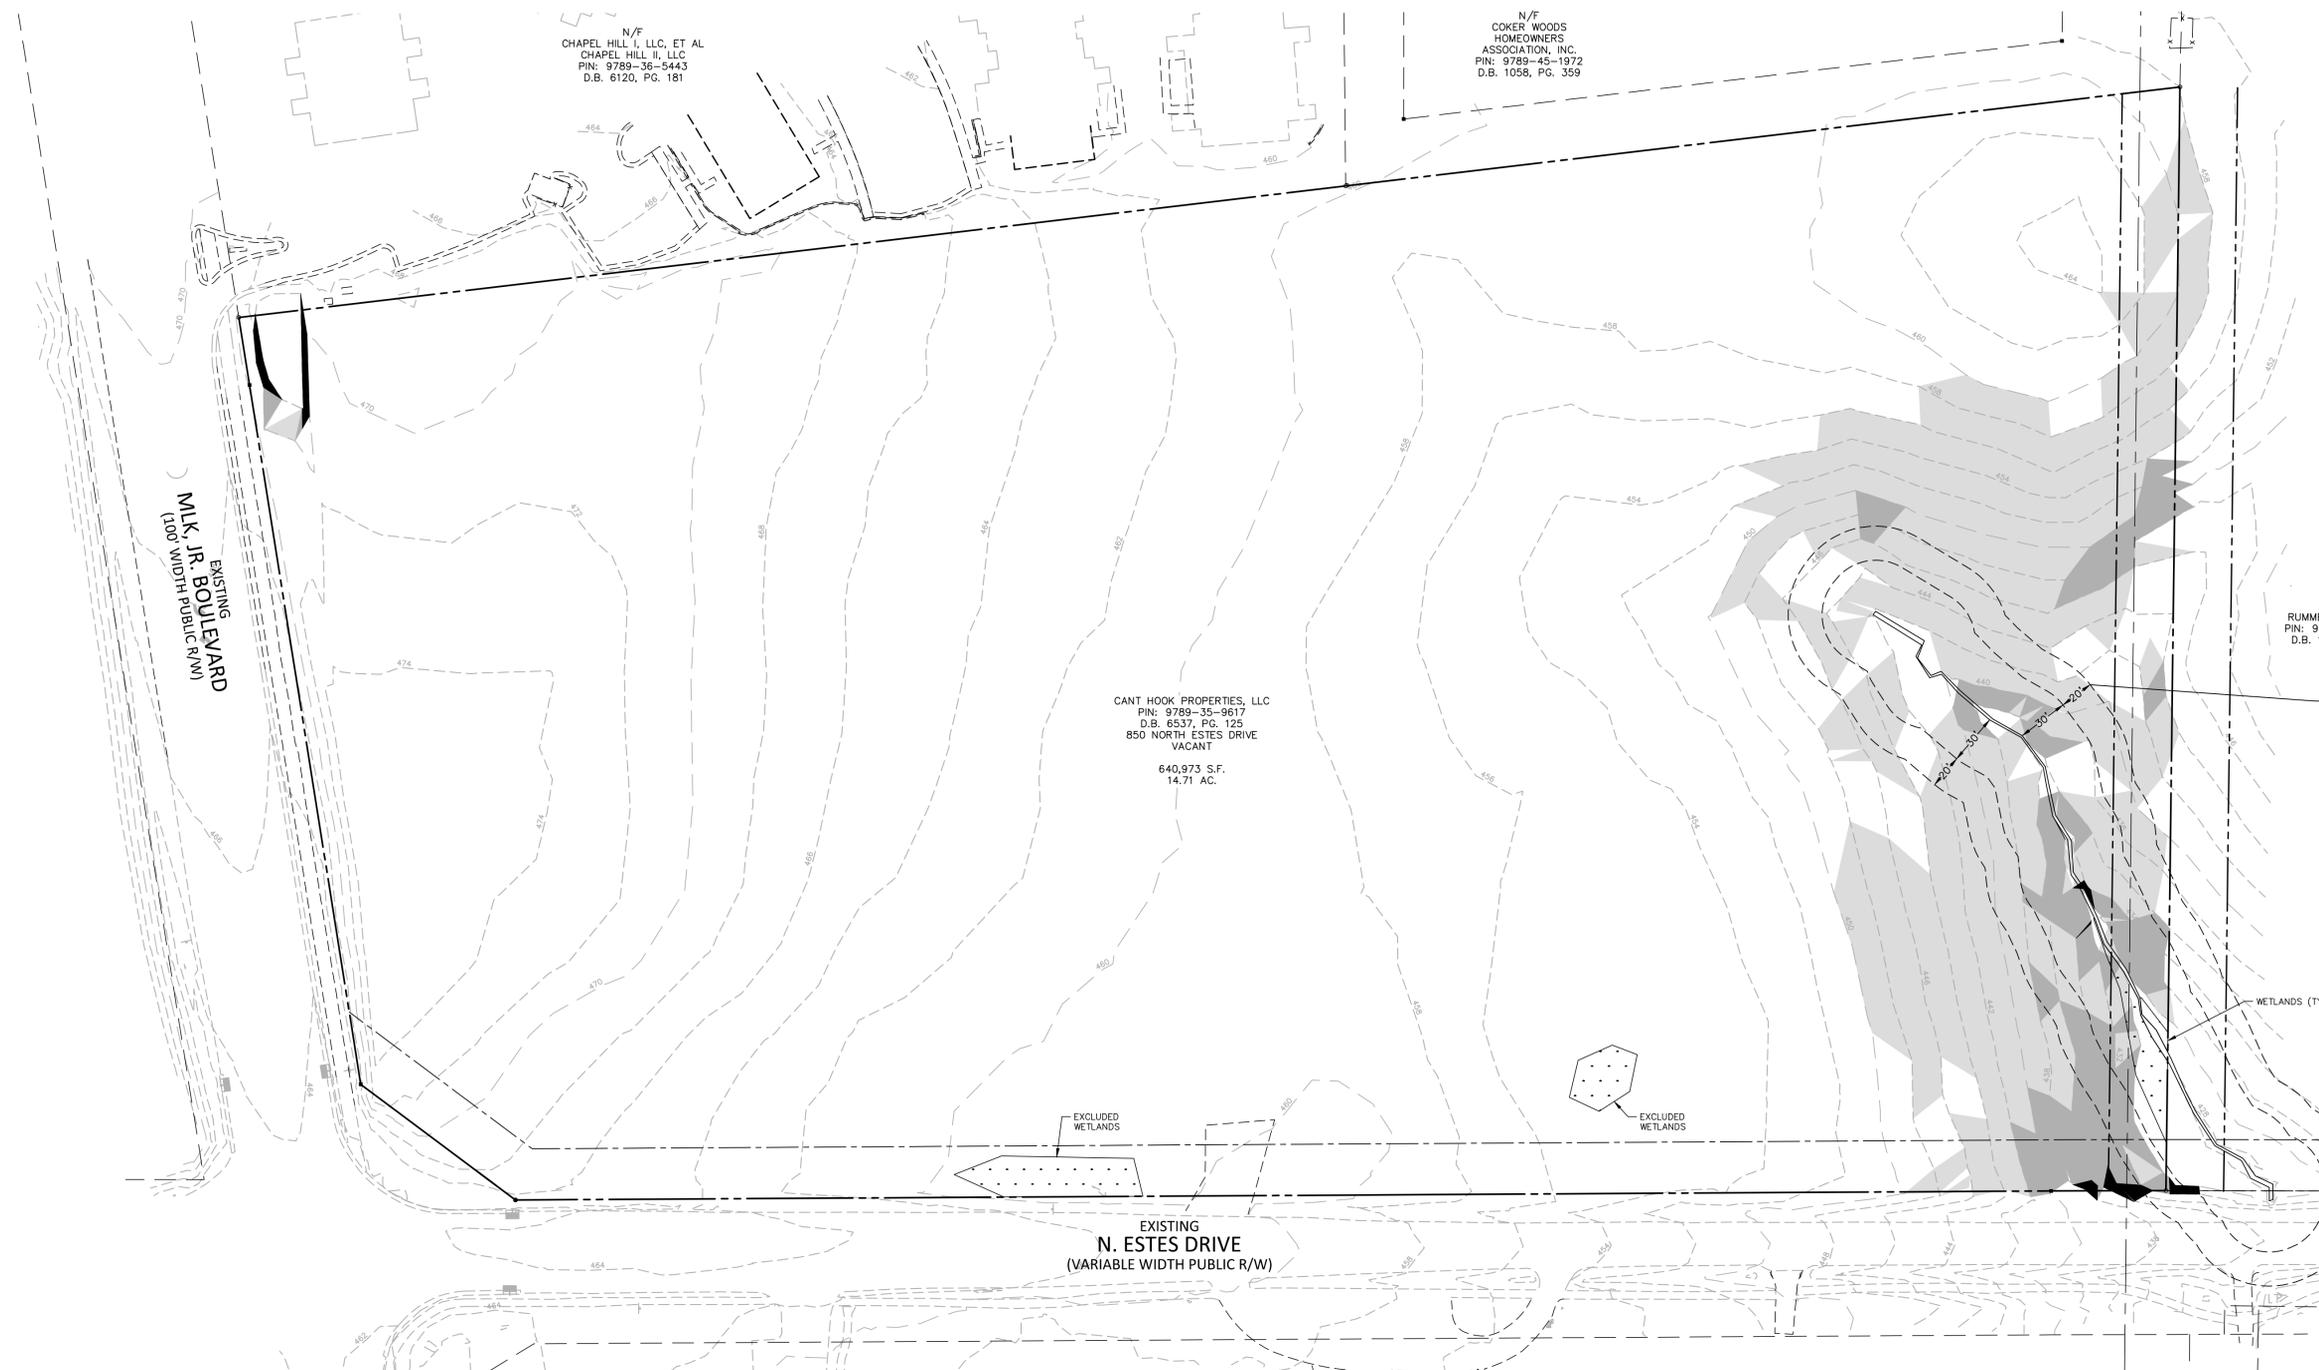


**STEEP SLOPE LEGEND**

- SLOPES 0% - 10% (12.37AC)
- SLOPES 10% - 15% (1.74AC)
- SLOPES 15% - 25% (0.42AC)
- SLOPES >25% (0.18AC)

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2905 Meridian Parkway  
Durham, NC 27713

phone 919. 361. 5000  
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PLAN INFORMATION

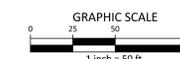PROJECT NO. TRG-20000  
 FILENAME TRG20000-OAS1  
 CHECKED BY ZNB  
 DRAWN BY CJJ  
 SCALE 1"=50'  
 DATE 09.24.2020


SHEET

OVERALL SITE PLAN

C2.00

SITE LEGEND

- SIGNAGE
- YARD LIGHTS
- LIGHT POLE
- POWER POLE
- TRAFFIC DIRECTIONAL ARROW
- ACCESSIBLE PARKING STALL
- VAN ACCESSIBLE PARKING STALL
- PARKING SPACE COUNT
- ACCESSIBLE RAMPS
- PROPERTY LINE
- RIGHT-OF-WAY LINE
- EASEMENT LINE

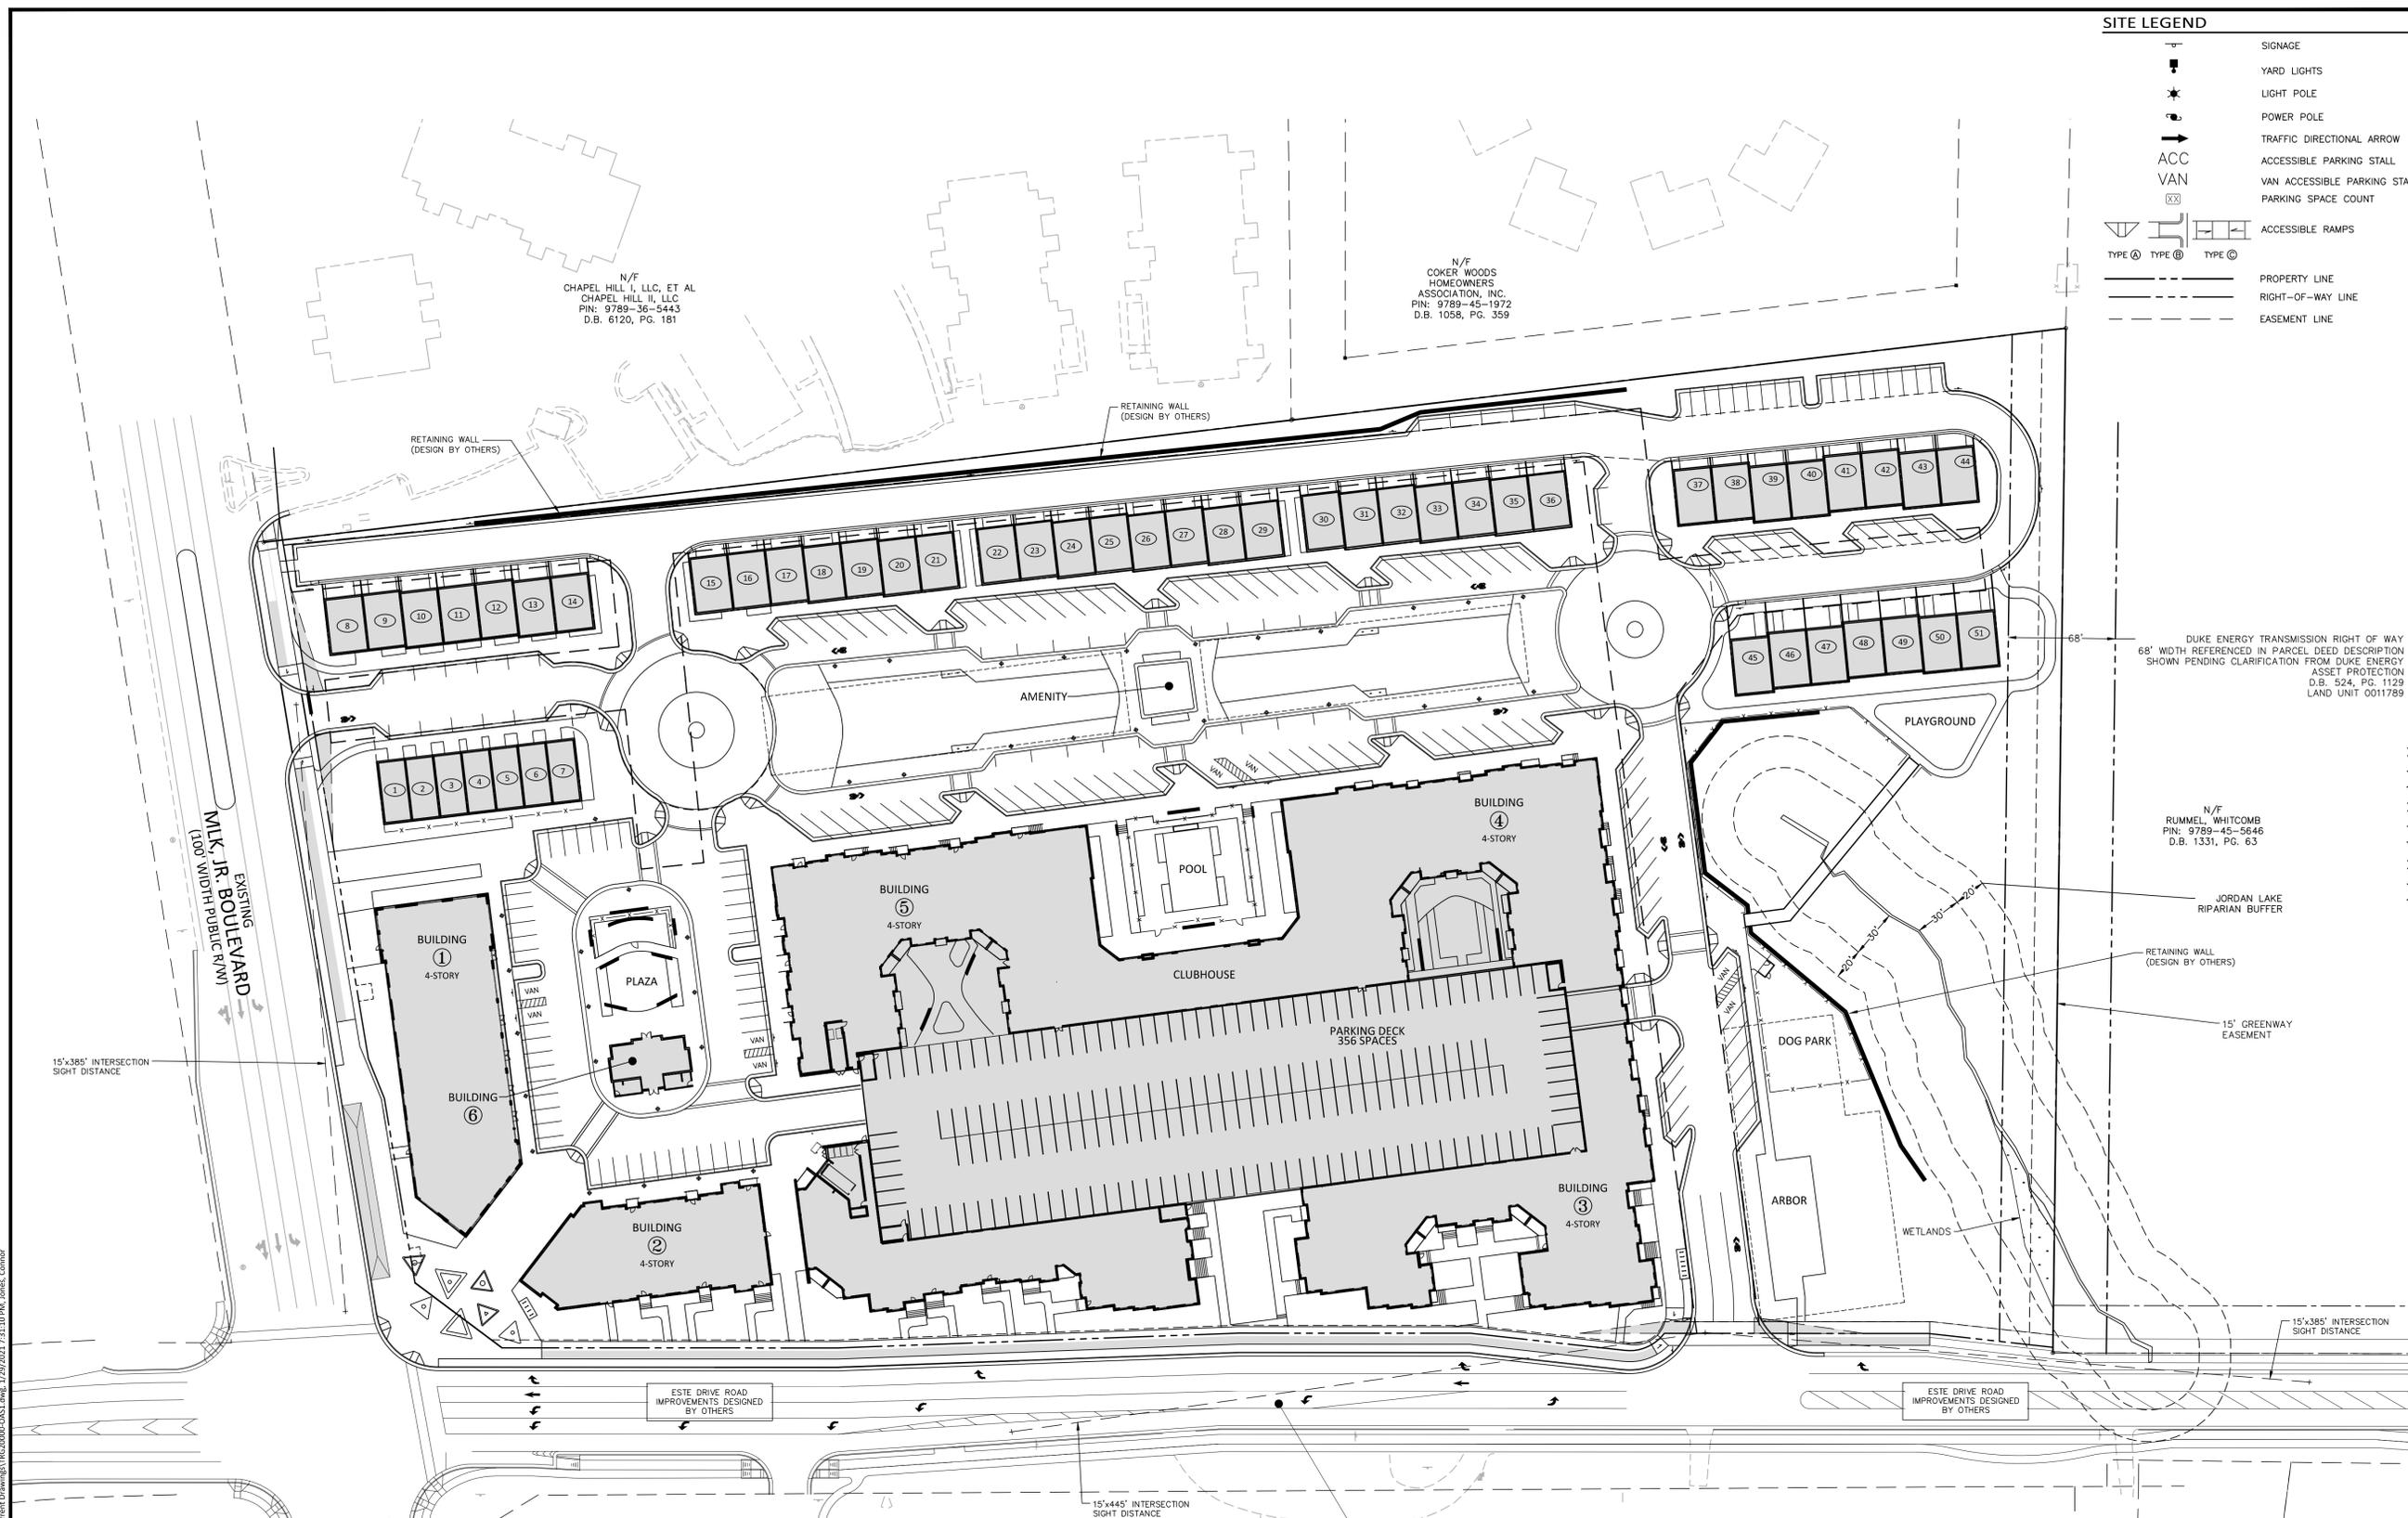


**McADAMS**  
**AASHTO INTERSECTION SIGHT DISTANCE SUMMARY**  
**STOP SIGN CONTROL - LEFT & RIGHT TURNS FROM MINOR STREET (PASSENGER CAR)**  
 Project Name: Aura Date: 9/24/2020  
 Project Number: TRG-20000 Calculated By: MRO

No.	Minor Street Name	Major Street Name	Design Speed of Major Street (mph)	Approach grade of minor street (%)	Number of Lanes to Cross (Left Turn)	Left Turn		Right Turn	
						Turn Time Gap (sec.)	Intersection Sight Distance (ft.) <sup>1</sup>	Turn Time Gap (sec.)	Intersection Sight Distance (ft.) <sup>2</sup>
1	Stewart Blvd	North Estes Drive	40	-3.00	1	7.5	445	6.5	385
2	Aura Park Drive	MLK Jr Blvd	40	-1.50	N/A	-	-	6.5	385

1) Signalized Intersections do not require left turn sight distance.  
 2) Right-in / Right-out intersections do not require left turn sight distance.

\* Intersection Sight Distance from Formula 9-1 from AASHTO Geometric Design of Highways and Streets, 2004

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N/F  
CHAPEL HILL II, LLC, ET AL  
CHAPEL HILL II, LLC  
PIN: 9789-36-5443  
D.B. 6120, PG. 181

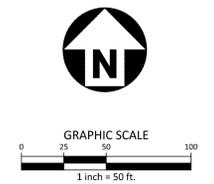**SITE LEGEND**

-  SIGNAGE
-  YARD LIGHTS
-  LIGHT POLE
-  POWER POLE
-  TRAFFIC DIRECTIONAL ARROW
-  ACCESSIBLE PARKING STALL
-  VAN ACCESSIBLE PARKING STALL
-  PARKING SPACE COUNT
-  ACCESSIBLE RAMPS
-  ACCESSIBLE ROUTE
-  PHASE LINE
-  PROPERTY LINE
-  RIGHT-OF-WAY LINE
-  LOT LINE
-  EASEMENT LINE
-  CENTERLINE
-  HEAVY DUTY ASPHALT PAVEMENT
-  HEAVY DUTY CONCRETE PAVEMENT



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**PLAN INFORMATION**

PROJECT NO. TRG-20000  
FILENAME TRG20000-S1  
CHECKED BY ZNB  
DRAWN BY CJJ  
SCALE 1"=30'  
DATE 09.24.2020

**SHEET**


**SITE PLAN - AREA A**

**C2.01**


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ALL STRIPING AND SYMBOLS TO BE PER MUTCD STANDARDS AND SPECIFICATIONS



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 CHECKED BY ZNB  
 DRAWN BY CJJ  
 SCALE 1"=30'  
 DATE 09.24.2020

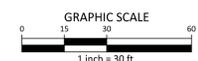**SHEET**

SITE PLAN - AREA B

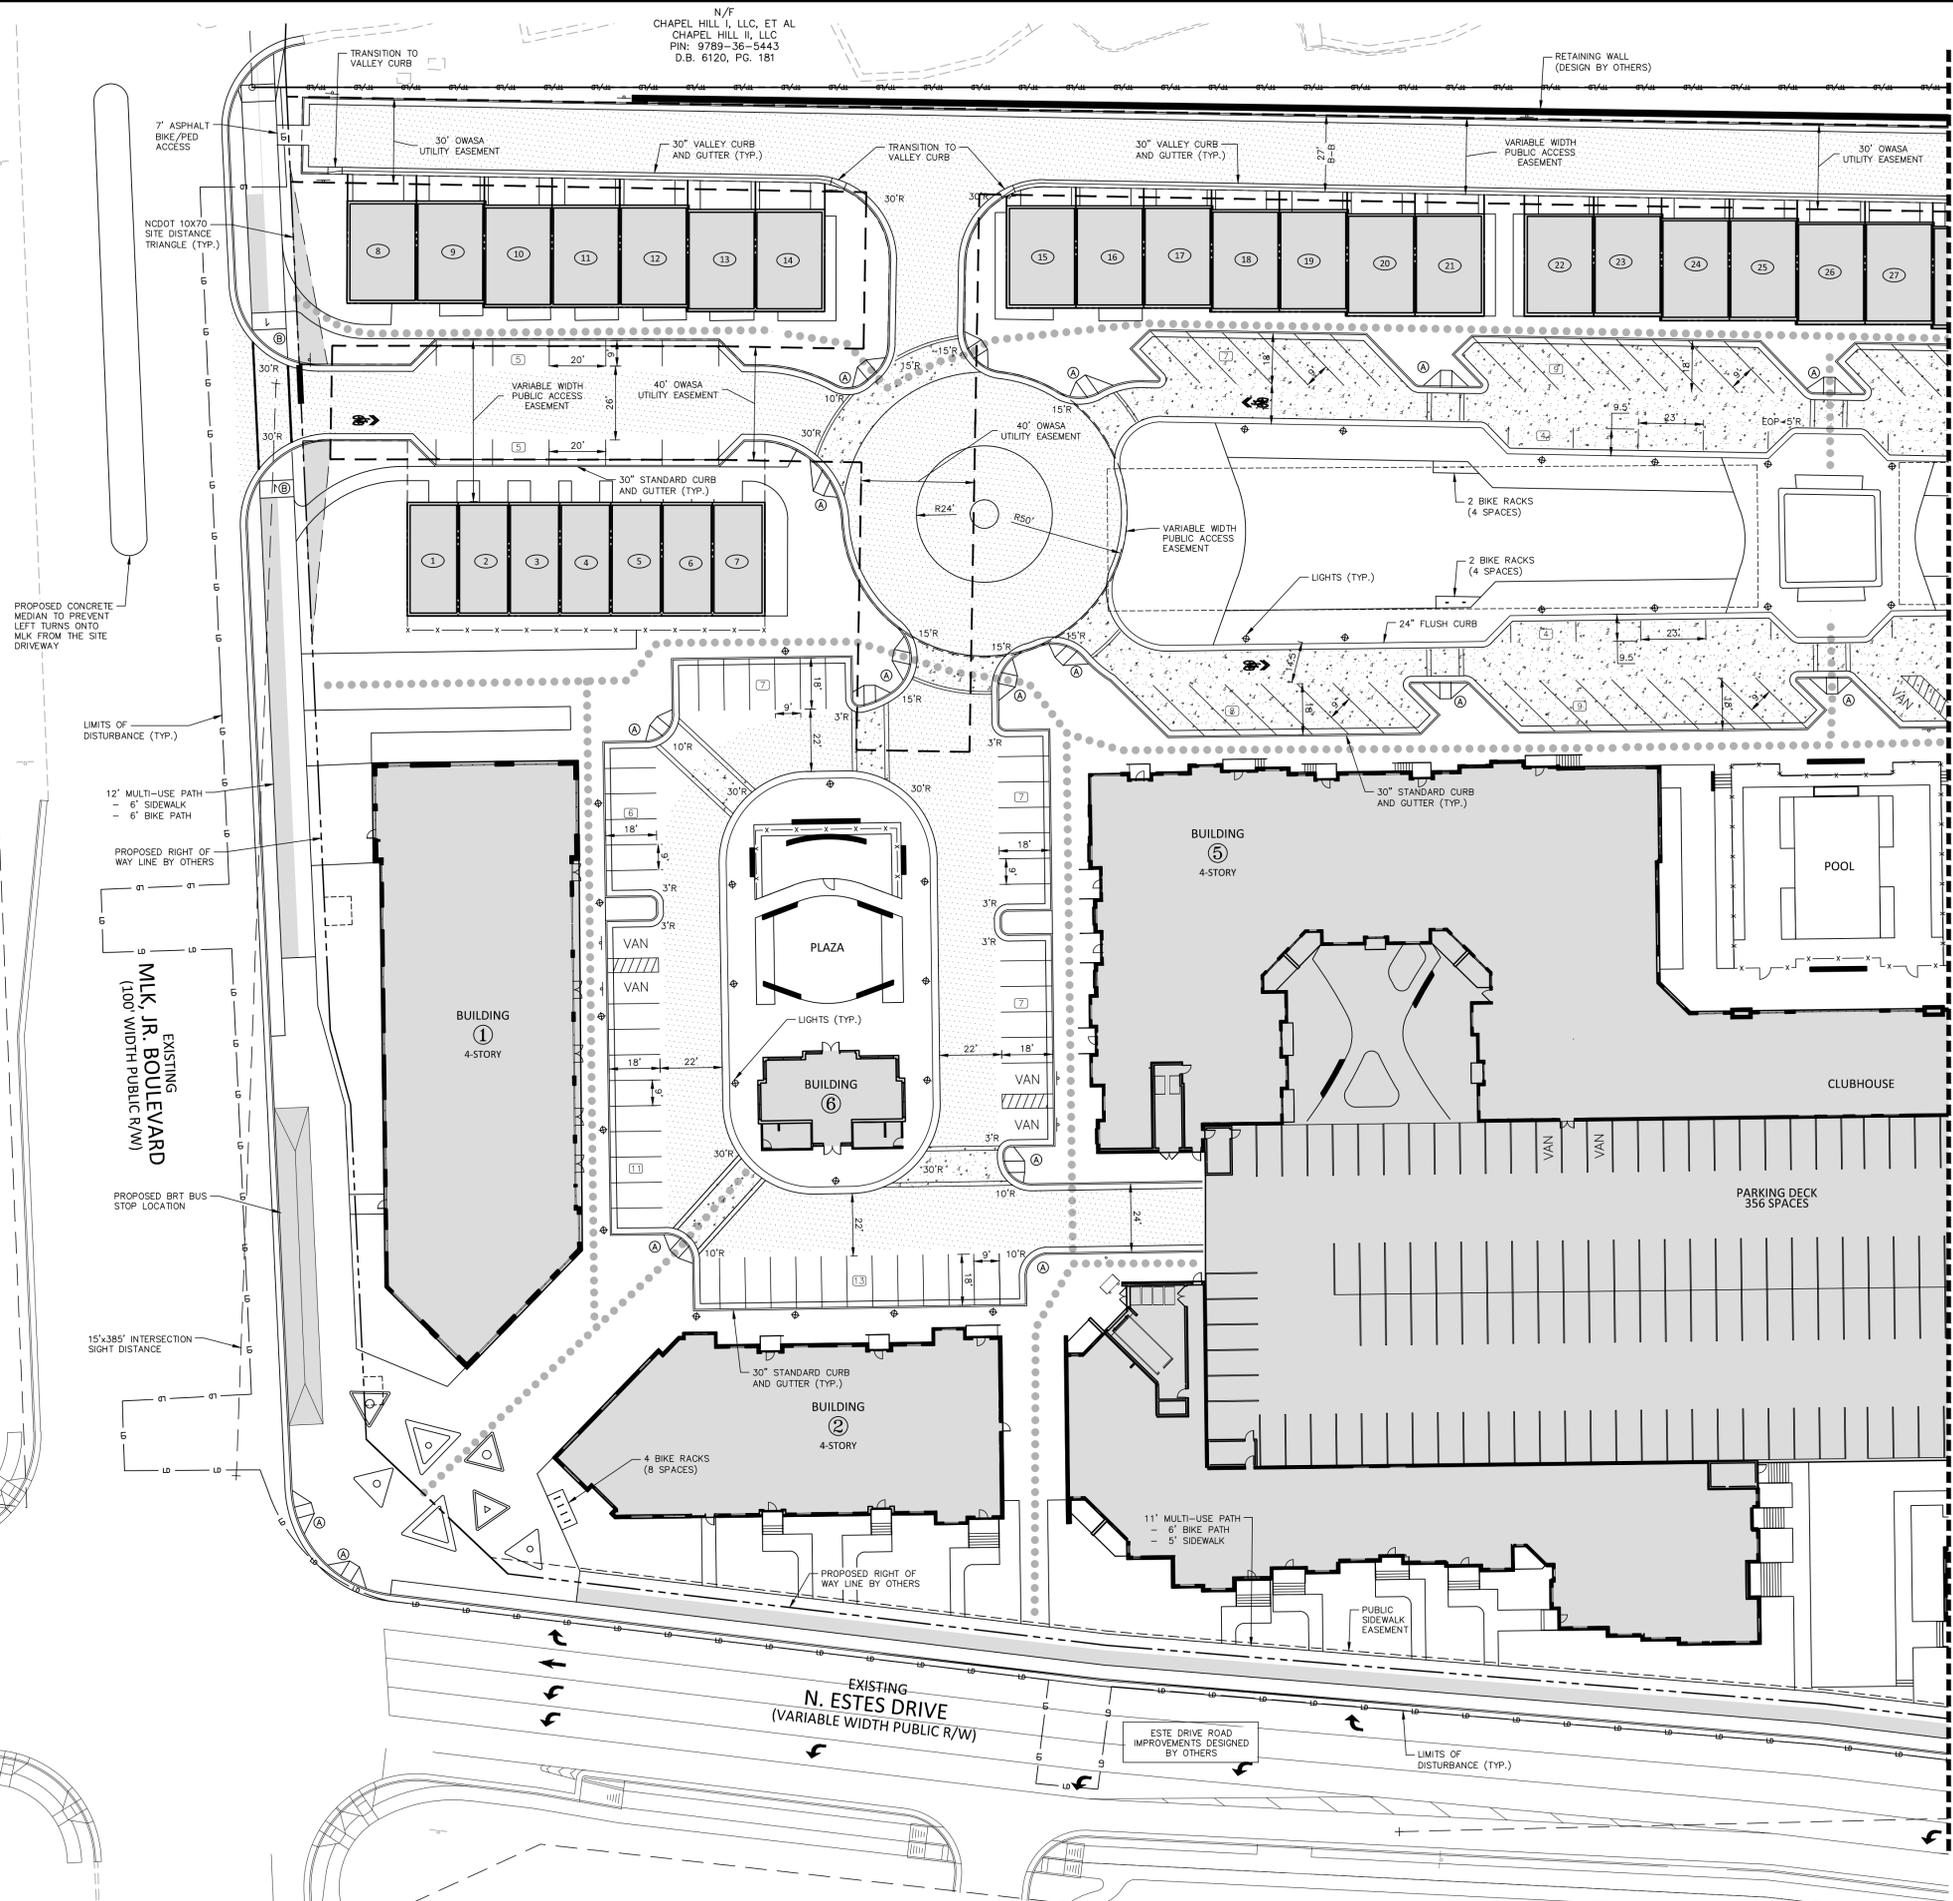
**C2.02**

**SITE LEGEND**

- SIGNAGE
- YARD LIGHTS
- LIGHT POLE
- POWER POLE
- TRAFFIC DIRECTIONAL ARROW
- ACCESSIBLE PARKING STALL
- VAN ACCESSIBLE PARKING STALL
- PARKING SPACE COUNT
- ACCESSIBLE RAMPS
- ACCESSIBLE ROUTE
- PHASE LINE
- PROPERTY LINE
- RIGHT-OF-WAY LINE
- LOT LINE
- EASEMENT LINE
- CENTERLINE
- HEAVY DUTY ASPHALT PAVEMENT
- HEAVY DUTY CONCRETE PAVEMENT

GRAPHIC SCALE  
 0 15 30 60  
 1 inch = 30 ft.

PRELIMINARY DRAWING - NOT RELEASED FOR CONSTRUCTION

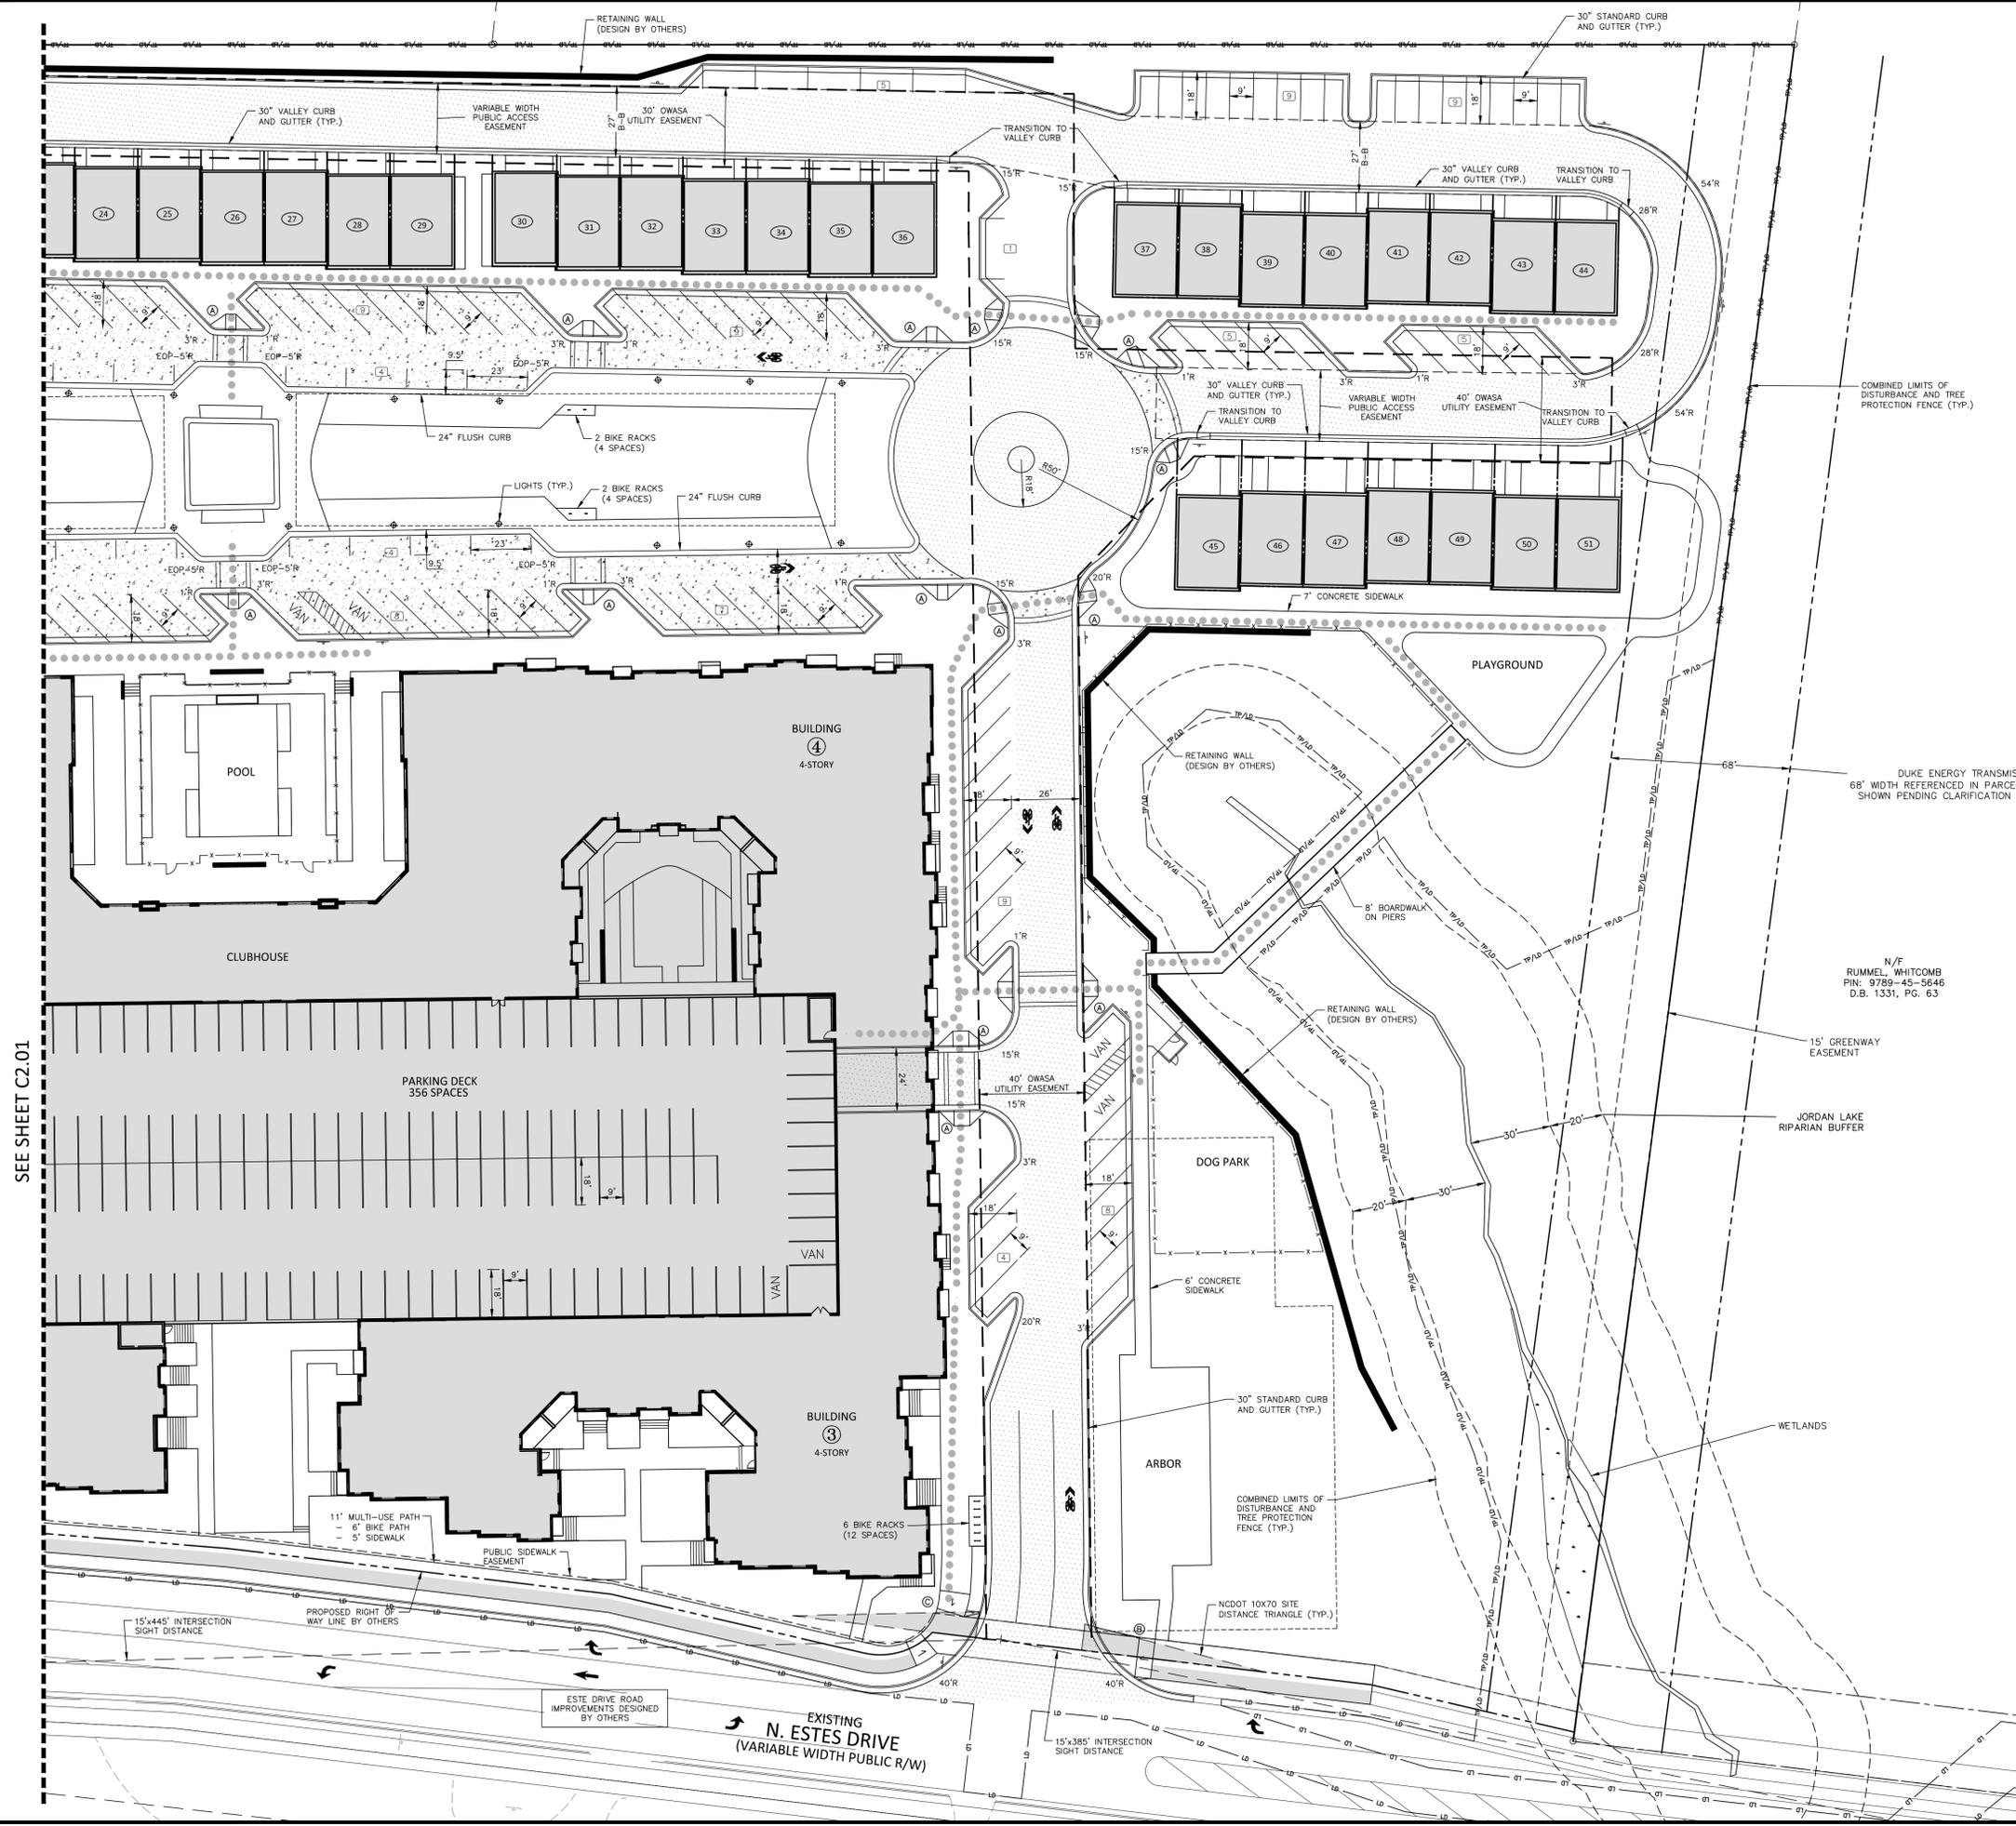

SEE SHEET C2.01

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**PLAN INFORMATION**

PROJECT NO. TRG-20000  
FILENAME TRG20000-SWST1  
CHECKED BY ZNB  
DRAWN BY CJJ  
SCALE 1"=50'  
DATE 09.24.2020

**SHEET**

**SOLID WASTE PLAN**


**C2.10**

**RECYCLING NOTES**

1. APPLICANT ELECTS TO HAVE PUBLIC RECYCLING FOR TOWNHOMES AND PRIVATE RECYCLING FOR THE REMAINDER OF THE SITE. THIS IS SUBJECT TO CHANGE IF THE APPLICANT DEEMS IT NECESSARY. THE DETAILS OF THESE PLANS WILL BE FURTHER ELABORATED IN THE ZCP STAGE AND WORKED THROUGH WITH ORANGE COUNTY OFFICIALS.
2. APPLICANT MUST REQUIRE AT THE LEAST THE SAME LEVEL OF SERVICE (CURRENT OR FUTURE) TO ITS RESIDENTS AS THAT PROVIDED BY ORANGE COUNTY.
3. COUNTY FEES FOR RECYCLING AND WASTE MANAGEMENT ASSOCIATED WITH THIS PROJECT/PROPERTY WILL NOT BE WAIVED.
4. APPLICANT AGREES TO ENTER INTO A SERVICE AGREEMENT WITH A PRIVATE RECYCLING COLLECTION CONTRACTOR THAT IS ACCEPTABLE TO ORANGE COUNTY. FURTHER, THE AGREEMENT SHALL PROVIDE FOR THE COLLECTION AND RECYCLING OF CORRUGATED CARDBOARD IN ADDITION TO THE OTHER CO-MINGLED RECYCLABLES AND AN EXECUTED COPY OF THE AGREEMENT SHALL BE PROVIDED TO AND APPROVED BY ORANGE COUNTY PRIOR TO APPROVAL OF FINAL CONSTRUCTION PLANS FOR THE PROPERTY/PROJECT.

**SOLID WASTE AND RECYCLING NOTES:**

1. ALL EXISTING STRUCTURES 500 SQUARE FEET AND LARGER IN SIZE SHALL BE ASSESSED PRIOR TO DEMOLITION TO ENSURE COMPLIANCE WITH THE COUNTY'S REGULATED RECYCLABLE MATERIALS ORDINANCE (RRMO) AND TO ASSESS THE POTENTIAL FOR DE-CONSTRUCTION AND/OR THE RE-USE OF SALVAGEABLE MATERIALS.
2. BY ORANGE COUNTY ORDINANCE, CLEAN WOOD WASTE, SCRAP METAL, AND CORRUGATED CARDBOARD PRESENT IN CONSTRUCTION OR DEMOLITION WASTE MUST BE RECYCLED.
3. BY ORANGE COUNTY ORDINANCE, ALL HAULERS OF MIXED CONSTRUCTION AND DEMOLITION WASTE THAT INCLUDES ANY REGULATED RECYCLABLE MATERIALS SHALL BE LICENSED BY ORANGE COUNTY.
4. PRIOR TO ANY DEMOLITION OR CONSTRUCTION ACTIVITY ON THE SITE THE APPLICANT SHALL HOLD A PRE-DEMOLITION/PRE-CONSTRUCTION CONFERENCE WITH THE SOLID WASTE STAFF (919-968-2788); THIS MAY BE THE SAME PRE-CONSTRUCTION MEETING HELD WITH OTHER DEVELOPMENT/ENFORCEMENT OFFICIALS.
5. THE PRESENCE OF ANY ASBESTOS CONTAINING MATERIALS (ACM) AND/OR OTHER HAZARDOUS MATERIALS IN CONSTRUCTION AND DEMOLITION WASTE SHALL BE HANDLED IN ACCORDANCE WITH ANY AND ALL LOCAL, STATE, AND FEDERAL REGULATIONS AND GUIDELINES.
6. IF ANY VEHICLES ARE PARKED IN THE REFUSE OR RECYCLABLES COLLECTION VEHICLE ACCESS AREA, THE CONTAINERS WILL NOT RECEIVE SERVICE UNTIL THE NEXT SCHEDULED COLLECTION DAY.
7. TRASH WILL BE PLACED IN SEPARATE DUMPSTERS AND COLLECTED BY A PRIVATE WASTE COLLECTION CONTRACTOR.
8. ALL CONSTRUCTION WASTE MATERIALS CONTAINING REGULATED RECYCLABLE MATERIALS (SEE NOTE 2 ABOVE) SHALL BE RECYCLED PURSUANT TO THE ORANGE COUNTY REGULATED RECYCLABLE MATERIALS ORDINANCE (RRMO). CONTRACTORS SHALL RETAIN PICKUP SLIPS TO RECORD/VALIDATE RECYCLING AS MAY BE REQUIRED FOR ENVIRONMENTAL CREDITS.
9. THE OWNER, OR THEIR DESIGNEE, SHALL BE RESPONSIBLE FOR MAINTAINING A FIRE WATCH DURING CONSTRUCTION AND DEMOLITION WHERE MATERIALS SUBJECT TO SPONTANEOUS COMBUSTION OR OTHER HAZARDOUS CONSTRUCTION OR DEMOLITION IS OCCURRING.
10. ALL CONSTRUCTION AND DEMOLITION SHALL BE CONDUCTED IN COMPLIANCE WITH THE CURRENT EDITION OF CHAPTER 14 OF THE NC FPC.
11. ANY GATE DESIGN SHALL INCLUDE GATE RETAINERS.
12. THERE WILL BE ROOM IN THE DUMPSTER ENCLOSURES OR ADJACENT TO COMPACTOR AREAS DESIGNATED FOR RECYCLING BINS AS APPROVED BY THE ORANGE COUNTY SOLID WASTE DEPARTMENT.
13. ITEMS TO BE RECYCLED WILL INCLUDE ALL MATERIALS ACCEPTED BY ORANGE COUNTY SOLID WASTE (INCLUDED BUT NOT LIMITED TO:)
  - 13.1.1. GLASS (CLEAR, BROWN AND GREEN)
  - 13.1.2. PLASTIC
  - 13.1.3. NEWSPAPERS, MAGAZINES AND OTHER PAPER
  - 13.1.4. METAL CANS
  - 13.1.5. CARDBOARD
14. ADEQUATE SITE LIGHTING SHALL BE PROVIDED IN/AROUND THE SOLID WASTE STORAGE AREAS.
15. HEAVY DUTY ASPHALT AND CONCRETE SECTIONS ARE PROVIDED ON SHEET C8.00. THESE SECTIONS APPLY UNLESS AN APPROVED GEOTECHNICAL ENGINEER HAS DESIGN SPECIFIC FOR THIS PROJECT

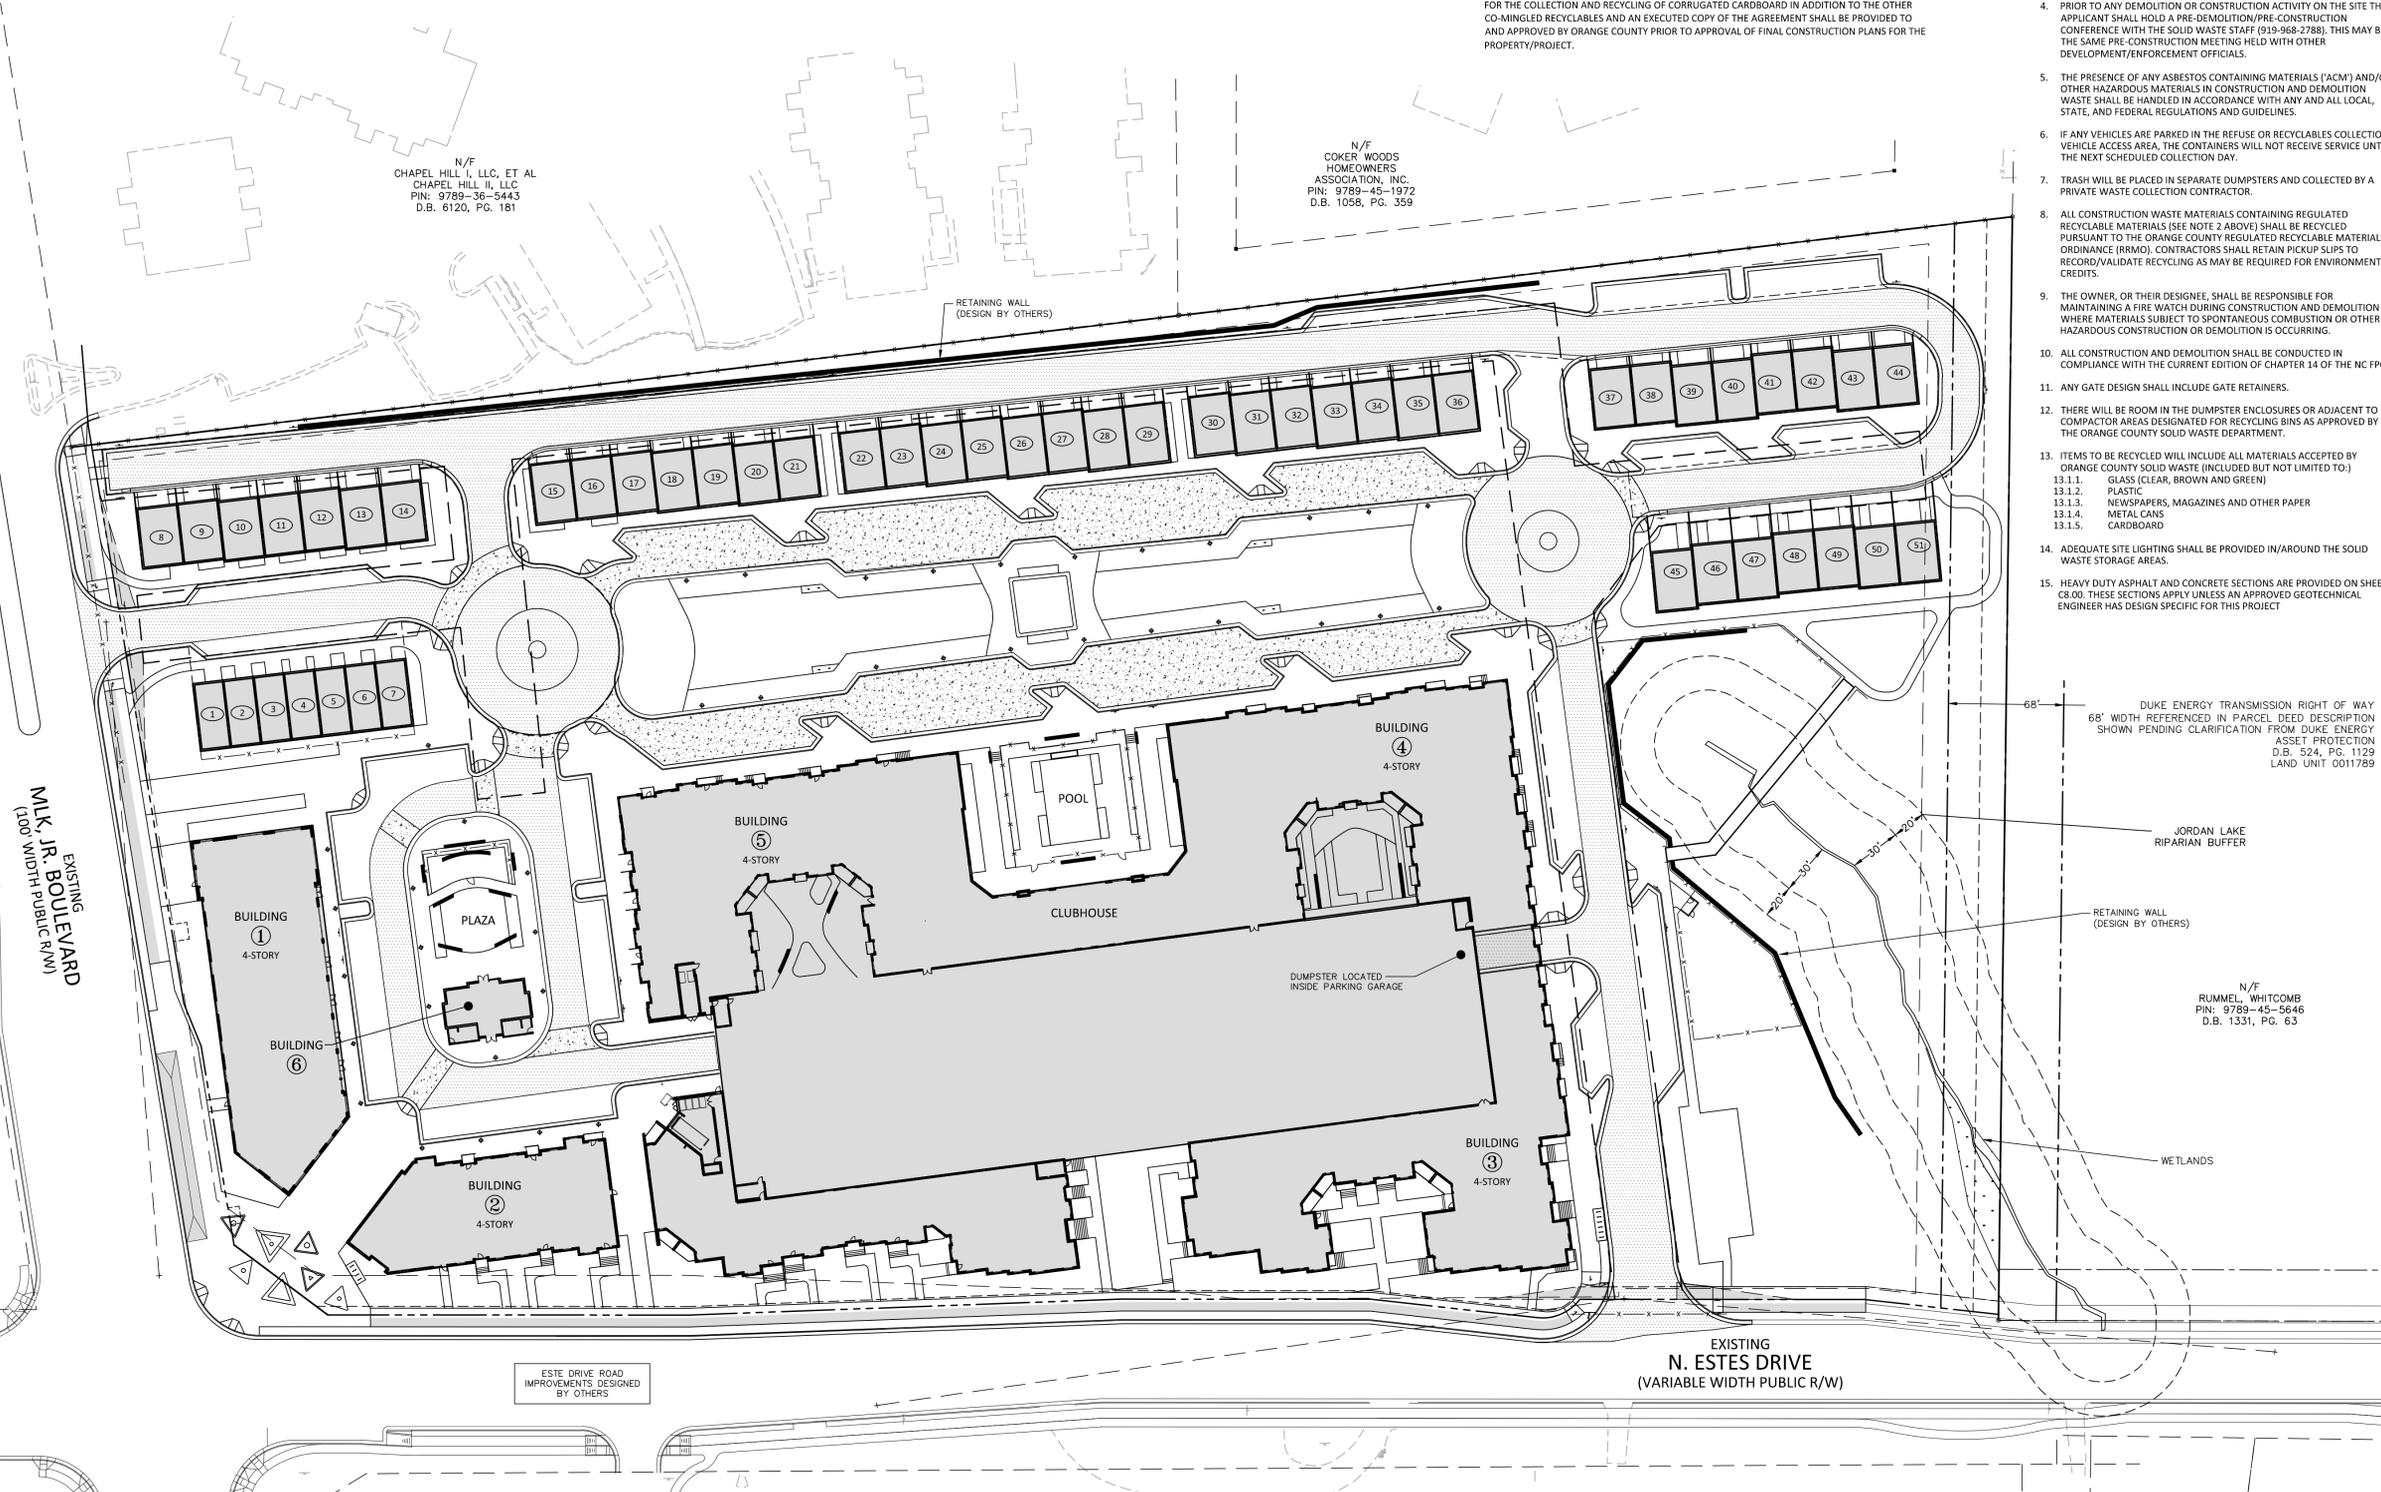


**PAVEMENT LEGEND**

- HEAVY DUTY ASPHALT PAVEMENT
- HEAVY DUTY CONCRETE PAVEMENT

NOTE: SEE SECTIONS ON DETAIL SHEET

SEE SHEET C0.01 FOR ALL PROJECT, SITE, GRADING, STORM DRAINAGE AND UTILITY NOTES

ALL CONSTRUCTION SHALL BE IN ACCORDANCE WITH THE CURRENT TOWN OF CHAPEL HILL ENGINEERING DESIGN AND CONSTRUCTION STANDARDS

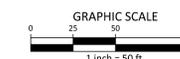

PRELIMINARY DRAWING - NOT RELEASED FOR CONSTRUCTION

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**McADAMS**

The John R. McAdams Company, Inc.  
2905 Meridian Parkway  
Durham, NC 27713

phone 919. 361. 5000  
fax 919. 361. 2269  
license number: C-0293, C-187

www.mcadamsco.com

**CLIENT**

TRINISC RESIDENTIAL GROUP  
110 CORCORAN STREET, 5TH FLOOR  
DURHAM, NORTH CAROLINA, 27701  
PHONE: 919. 884. 7395

**SITE LEGEND**

	SIGNAGE
	YARD LIGHTS
	LIGHT POLE
	POWER POLE
	TRAFFIC DIRECTIONAL ARROW
	ACCESSIBLE PARKING STALL
	VAN ACCESSIBLE PARKING STALL
	PARKING SPACE COUNT
	ACCESSIBLE RAMPS
	TYPE A
	TYPE B
	TYPE C
	ACCESSIBLE ROUTE
	PHASE LINE
	PROPERTY LINE
	RIGHT-OF-WAY LINE
	LOT LINE
	EASEMENT LINE
	CENTERLINE

**GENERAL NOTES:**

1. OUTER PATH IS TRUCK OVERHANG, INNER PATH IS TIRE TRACKING


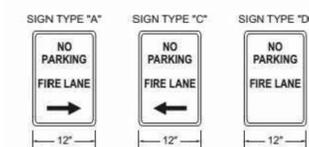


FIGURE D103.6  
FIRE LANE SIGNS

SEE SHEET C2.02

EXISTING  
MLK, JR. BOULEVARD  
(100' WIDTH PUBLIC R/W)

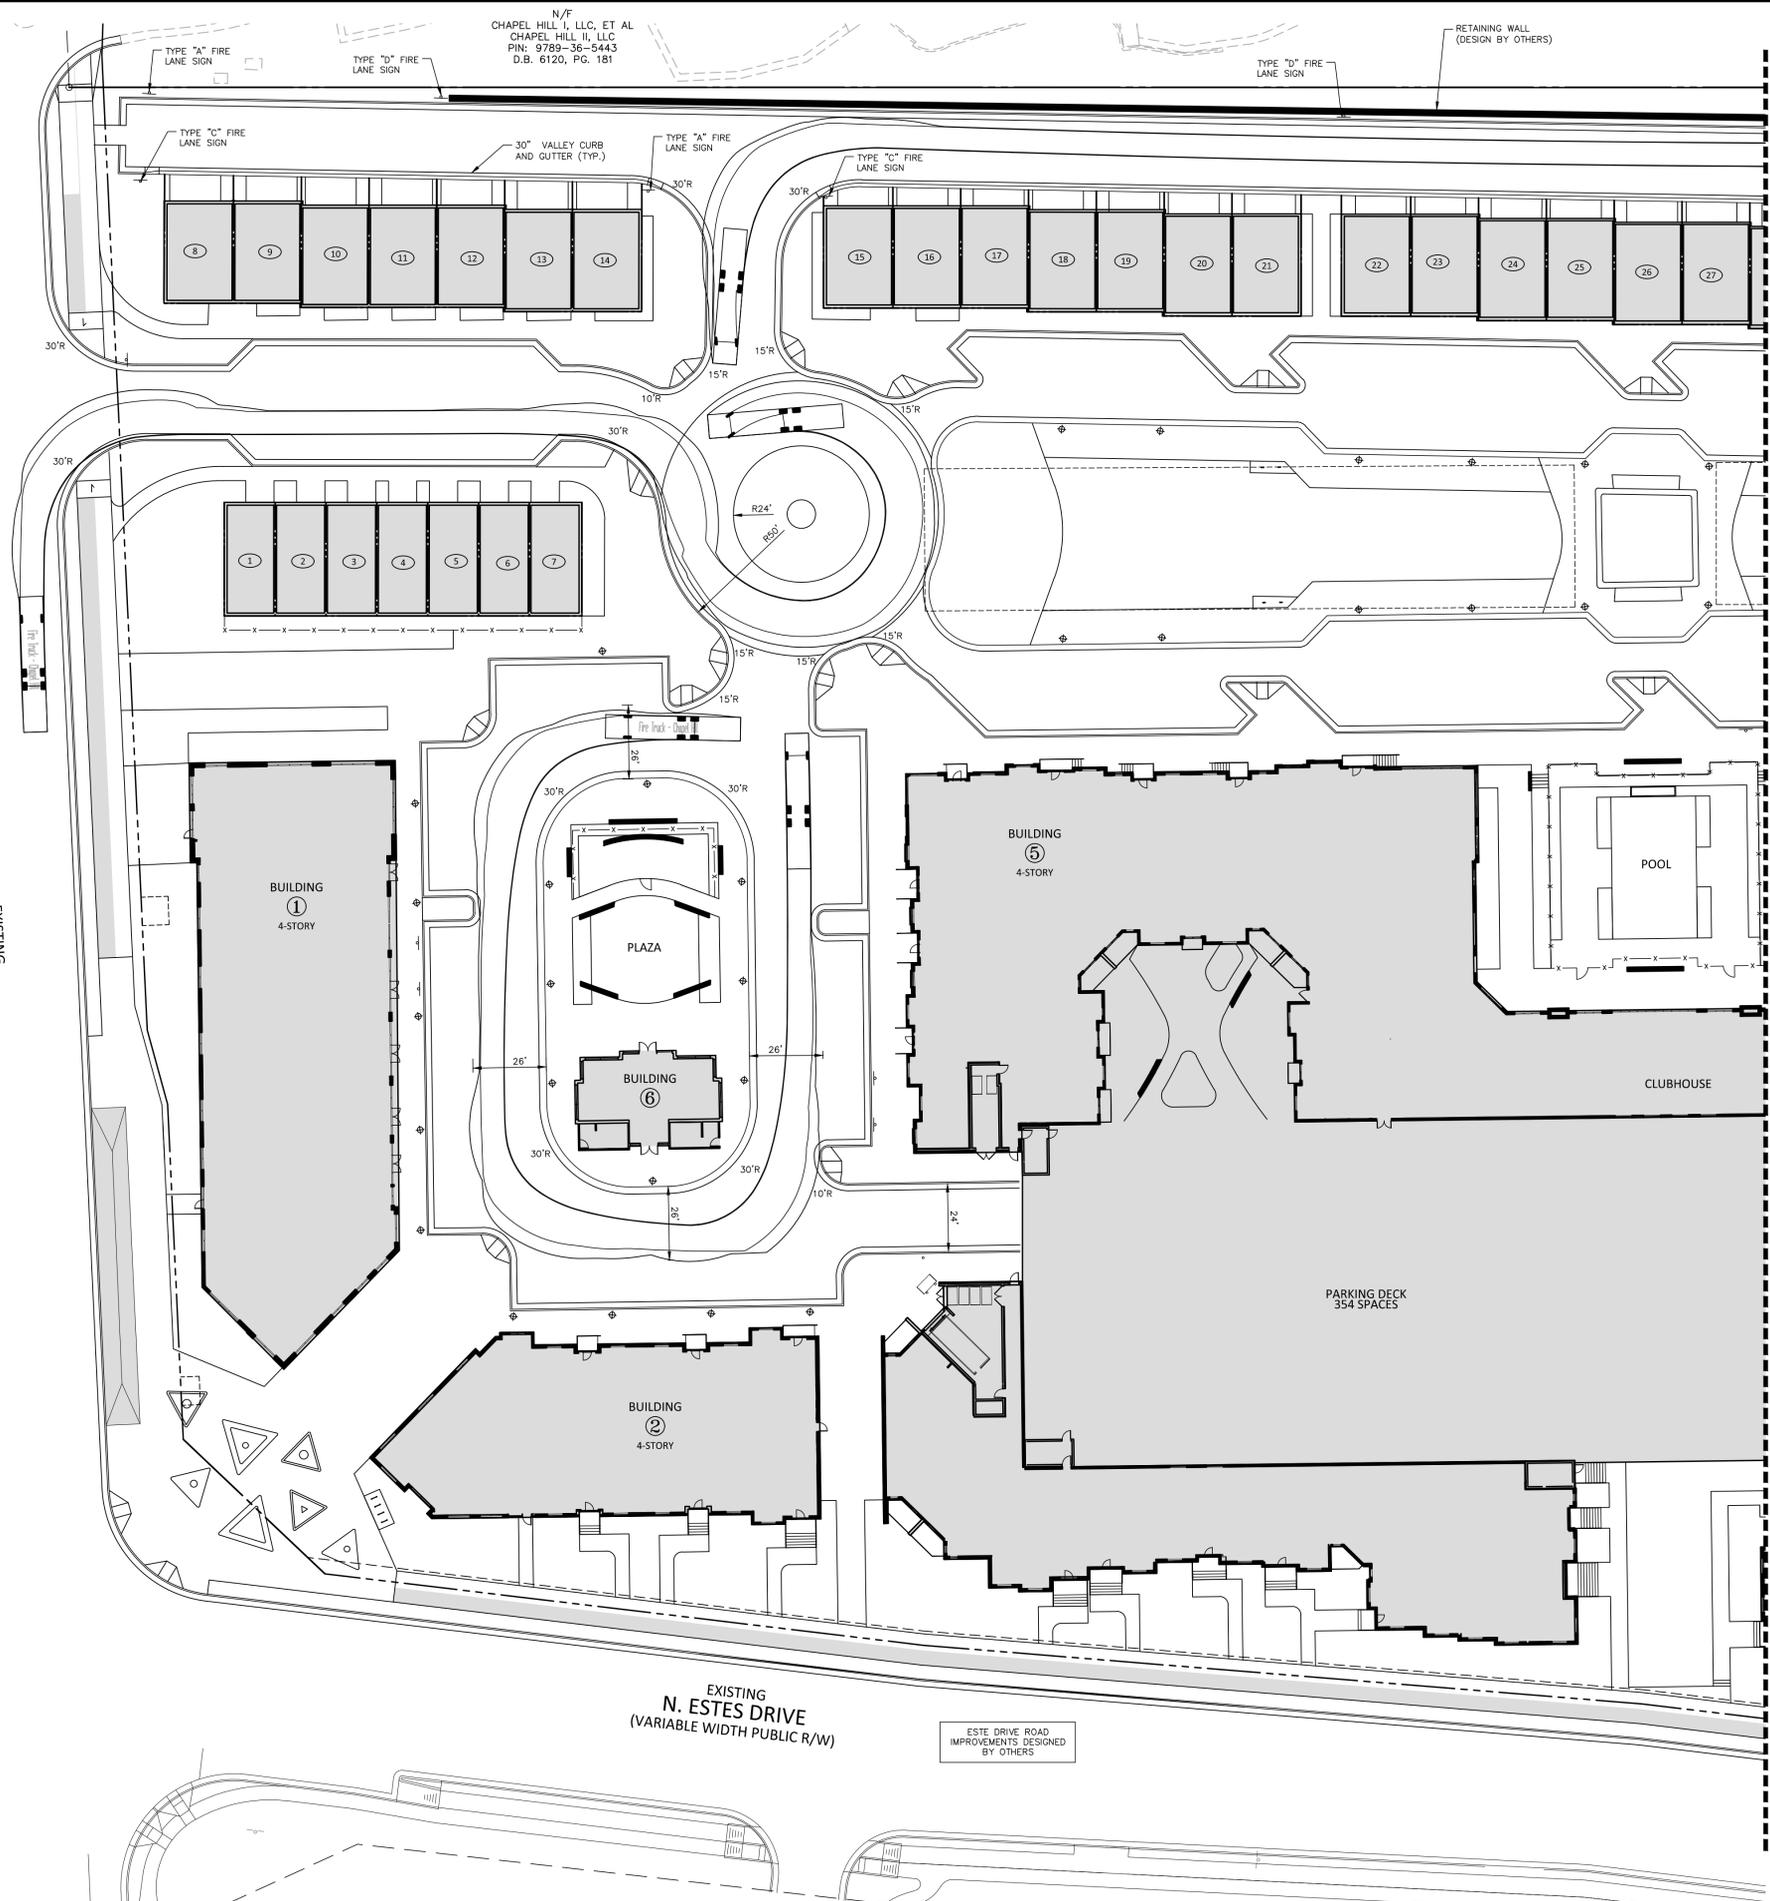

N/F  
CHAPEL HILL I, LLC, ET AL  
CHAPEL HILL II, LLC  
PIN: 9789-36-5443  
D.B. 6120, PG. 181

RETAINING WALL  
(DESIGN BY OTHERS)

BUILDING ⑤  
4-STORY

BUILDING ①  
4-STORY

BUILDING ⑥  
PLAZA

BUILDING ②  
4-STORY


POOL

CLUBHOUSE

PARKING DECK  
354 SPACES

EXISTING  
N. ESTES DRIVE  
(VARIABLE WIDTH PUBLIC R/W)

ESTE DRIVE ROAD  
IMPROVEMENTS DESIGNED  
BY OTHERS

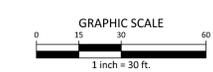

PRELIMINARY DRAWING - NOT RELEASED FOR CONSTRUCTION

**AURA**  
CONDITIONAL ZONING PERMIT  
NORTH ESTES DRIVE  
CHAPEL HILL, NORTH CAROLINA, 27516



**REVISIONS**

NO.	DATE	REVISION DESCRIPTION
1	11.13.2020	REVISED PER 1ST CZP COMMENTS
2	12.18.2020	REVISED PER 2ND CZP COMMENTS
3	01.29.2021	REVISED PER 3RD CZP COMMENTS

**PLAN INFORMATION**

PROJECT NO.	TRG-20000
FILENAME	TRG20000-AT1
CHECKED BY	ZNB
DRAWN BY	CJ
SCALE	1"=30'
DATE	09.24.2020

**SHEET**

**FIRE/WASTE VEHICLE  
TRACKING - AREA A  
C2.11**

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CONDITIONAL ZONING PERMIT  
NORTH ESTES DRIVE  
CHAPEL HILL, NORTH CAROLINA, 27516




**SITE LEGEND**

	SIGNAGE
	YARD LIGHTS
	LIGHT POLE
	POWER POLE
	TRAFFIC DIRECTIONAL ARROW
	ACCESSIBLE PARKING STALL
	VAN ACCESSIBLE PARKING STALL
	PARKING SPACE COUNT
	ACCESSIBLE RAMPS
	ACCESSIBLE ROUTE
	PHASE LINE
	PROPERTY LINE
	RIGHT-OF-WAY LINE
	LOT LINE
	EASEMENT LINE
	CENTERLINE

**GENERAL NOTES:**

- OUTER PATH IS TRUCK OVERHANG, INNER PATH IS TIRE TRACKING

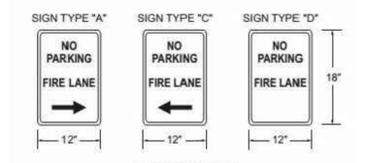

DUKE ENERGY TRANSMISSION RIGHT OF WAY  
68' WIDTH REFERENCED IN PARCEL DEED DESCRIPTION  
SHOWN PENDING CLARIFICATION FROM DUKE ENERGY  
ASSET PROTECTION  
D.B. 524, PG. 1129  
LAND UNIT 0011789


N/F  
RUMMEL, WHITCOMB  
PIN: 9789-45-5646  
D.B. 1331, PG. 63

JORDAN LAKE  
RIPARIAN BUFFER

WETLANDS

SEE SHEET C0.01 FOR ALL PROJECT, SITE,  
GRADING, STORM DRAINAGE AND UTILITY  
NOTES


ALL CONSTRUCTION SHALL BE IN  
ACCORDANCE WITH THE CURRENT TOWN  
OF CHAPEL HILL ENGINEERING DESIGN AND  
CONSTRUCTION STANDARDS

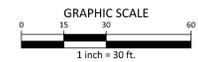

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SEE SHEET C2.01

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**REVISIONS**

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2	12.18.2020	REVISED PER 2ND CZP COMMENTS
3	01.29.2021	REVISED PER 3RD CZP COMMENTS

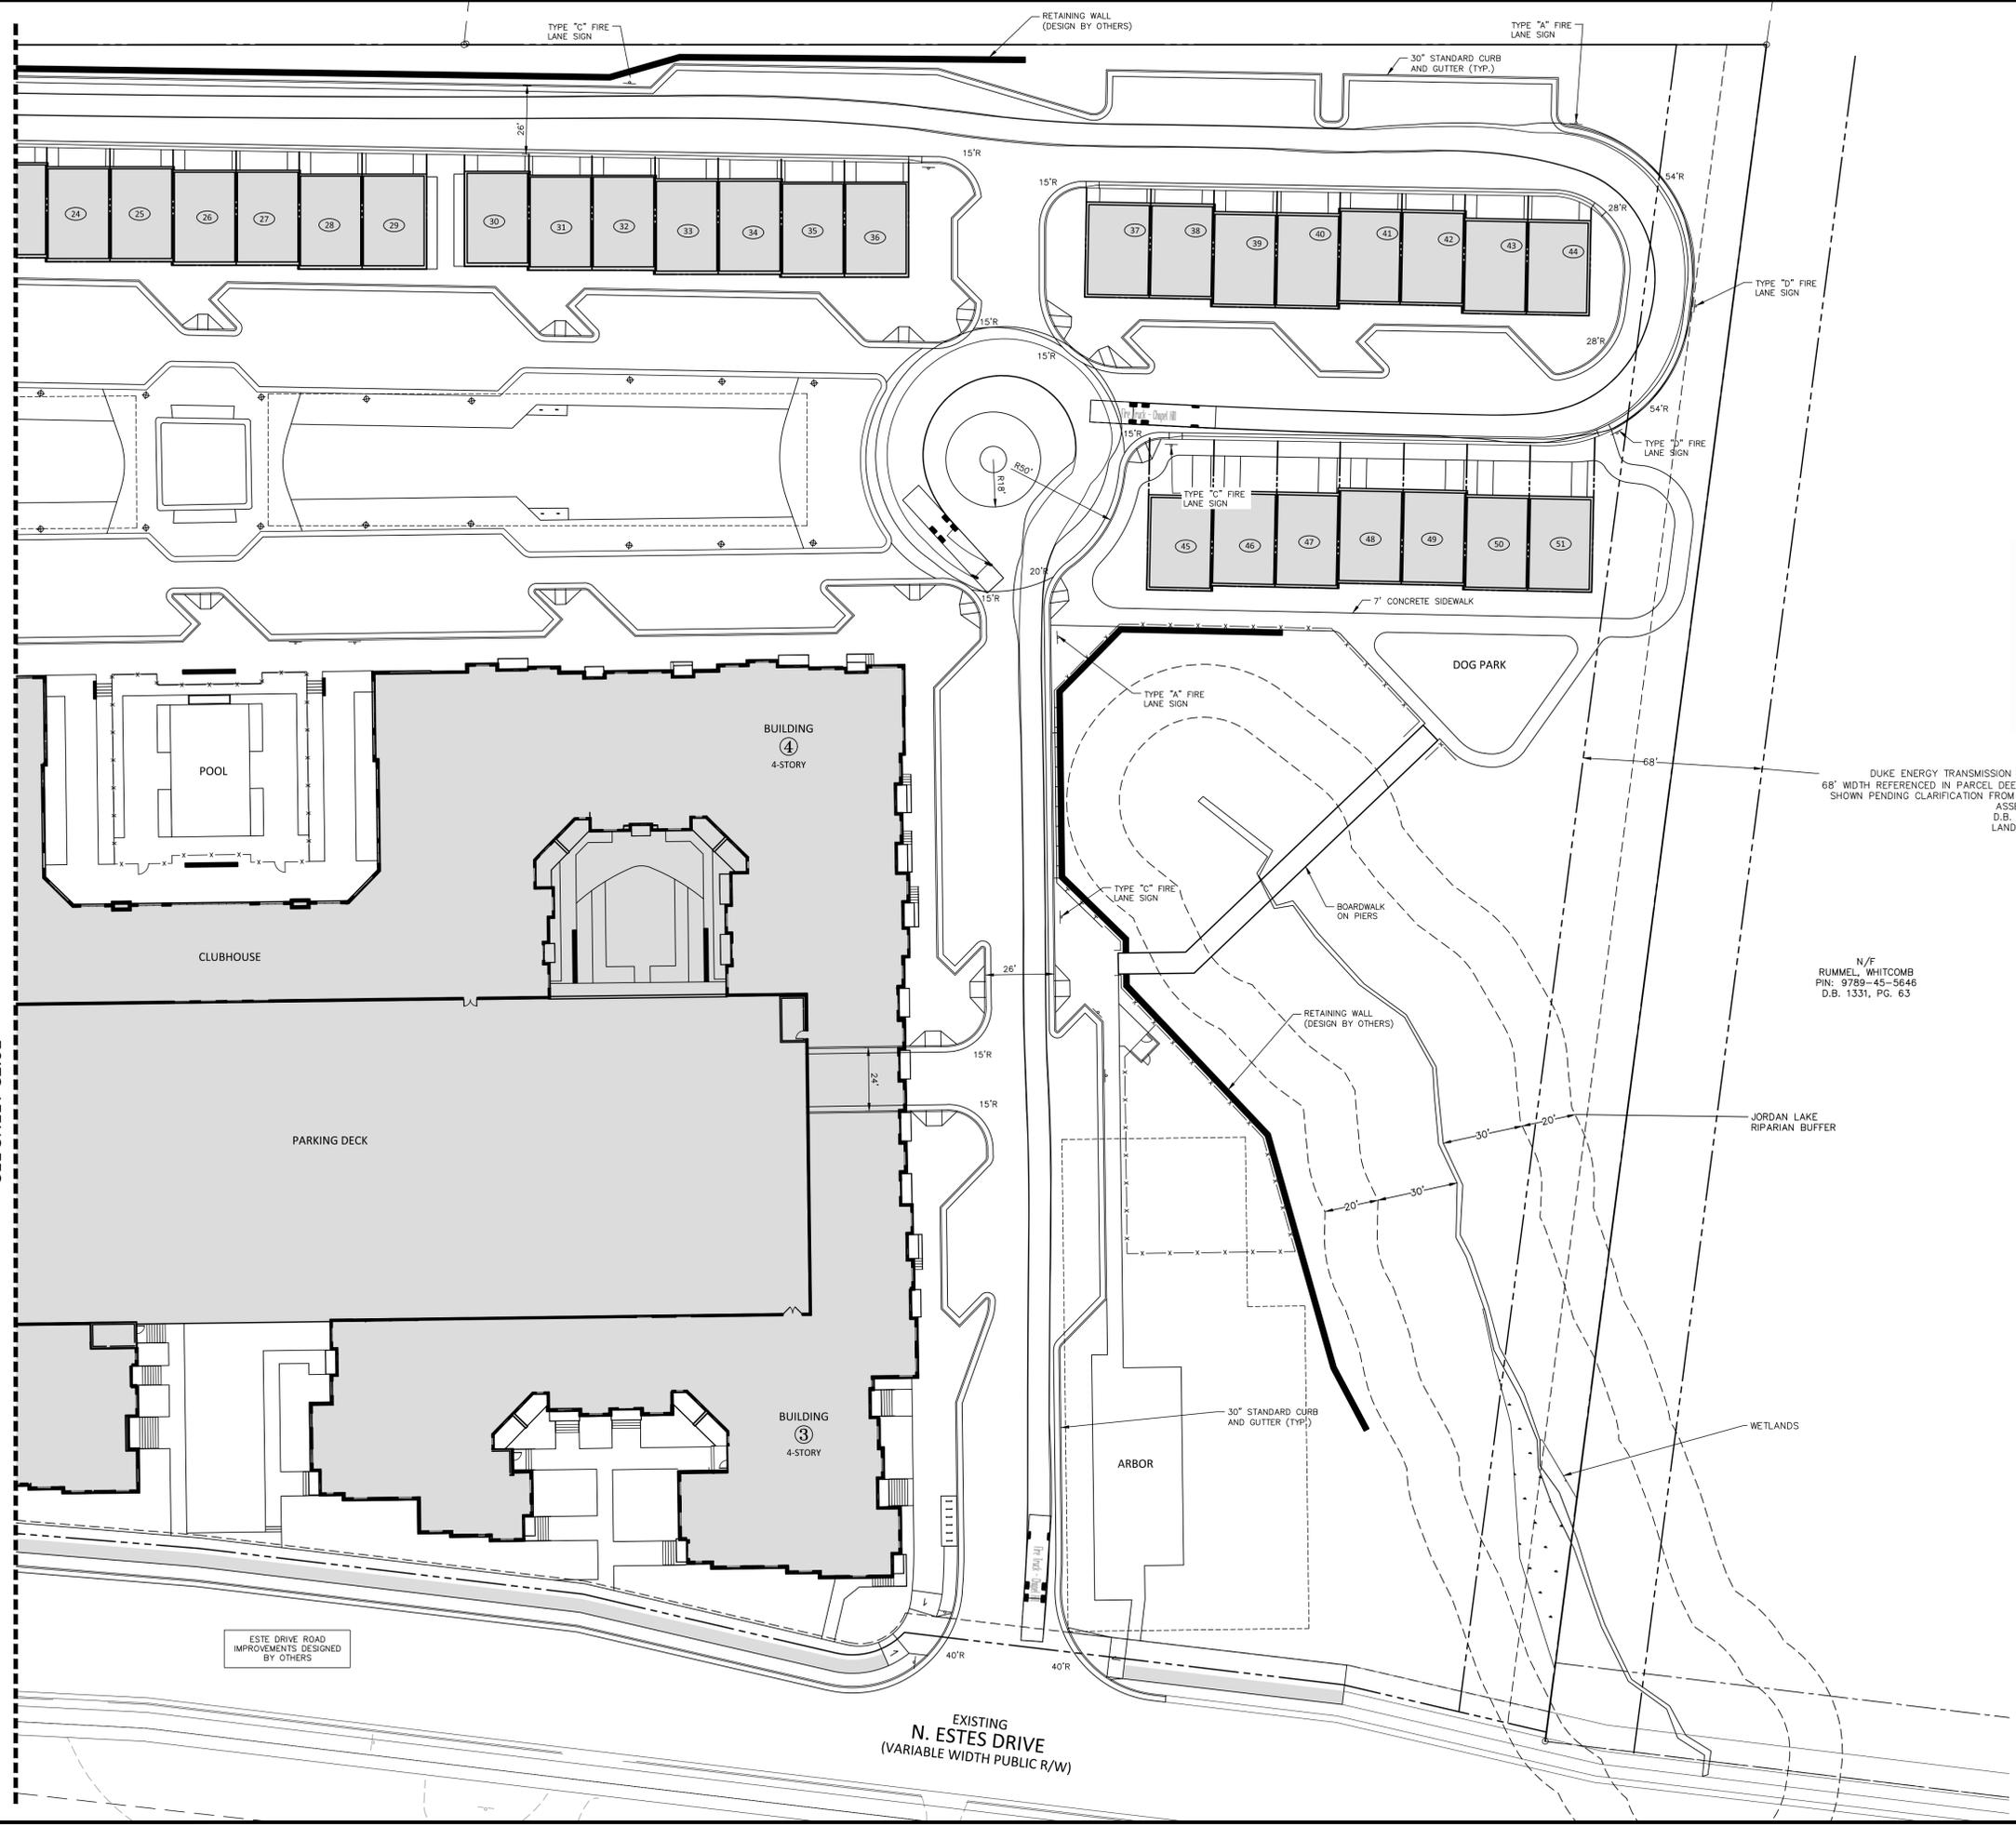**PLAN INFORMATION**

PROJECT NO.	TRG-20000
FILENAME	TRG20000-AT1
CHECKED BY	ZNB
DRAWN BY	CJ
SCALE	1"=30'
DATE	09.24.2020

**FIRE/WASTE VEHICLE TRACKING - AREA B**

**C2.12**



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**AURA**  
CONDITIONAL ZONING PERMIT  
NORTH ESTES DRIVE  
CHAPEL HILL, NORTH CAROLINA, 27516



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3	01.29.2021	REVISED PER 3RD CZP COMMENTS

**PLAN INFORMATION**

PROJECT NO. TRG-20000  
 FILENAME TRG20000-OAG1  
 CHECKED BY ZNB  
 DRAWN BY CJJ  
 SCALE 1"=50'  
 DATE 09.24.2020


**SHEET**

**OVERALL GRADING PLAN**

**C3.00**

**GRADING LEGEND**

- FLARED END SECTION
- ENDWALL SECTION
- CATCH BASIN
- DROP INLET
- STORM SERVICE INLET
- STORM SERVICE ROOF-RAIN
- JUNCTION BOX
- DRAINAGE FLOW ARROW
- LINE BREAK SYMBOL
- TOP & BOTTOM CURB ELEVATIONS
- TOP OF WALL ELEVATION
- BOTTOM OF WALL ELEVATION  
(NOTE: BOTTOM OF WALL IS GROUND ELEVATION NOT WALL FOUNDATION)
- SPOT ELEVATION
- STORM DRAINAGE
- STORM SERVICE LINE
- ROOF DRAIN, 8" ADS  
NON-PERFORATED TUBING OR  
EQUAL 1.0% MIN. SLOPE 3" MIN.  
COVER PVC SCHEDULE 40 IN  
TRAFFIC AREAS
- TREE PROTECTION FENCE
- LIMITS OF DISTURBANCE
- WOODED AREA
- MAJOR CONTOUR
- MINOR CONTOUR
- EXISTING MAJOR CONTOUR
- EXISTING MINOR CONTOUR
- EASEMENT LINE
- ACCESSIBLE PARKING AREA  
(2% MAX. SLOPE IN ALL DIRECTIONS)

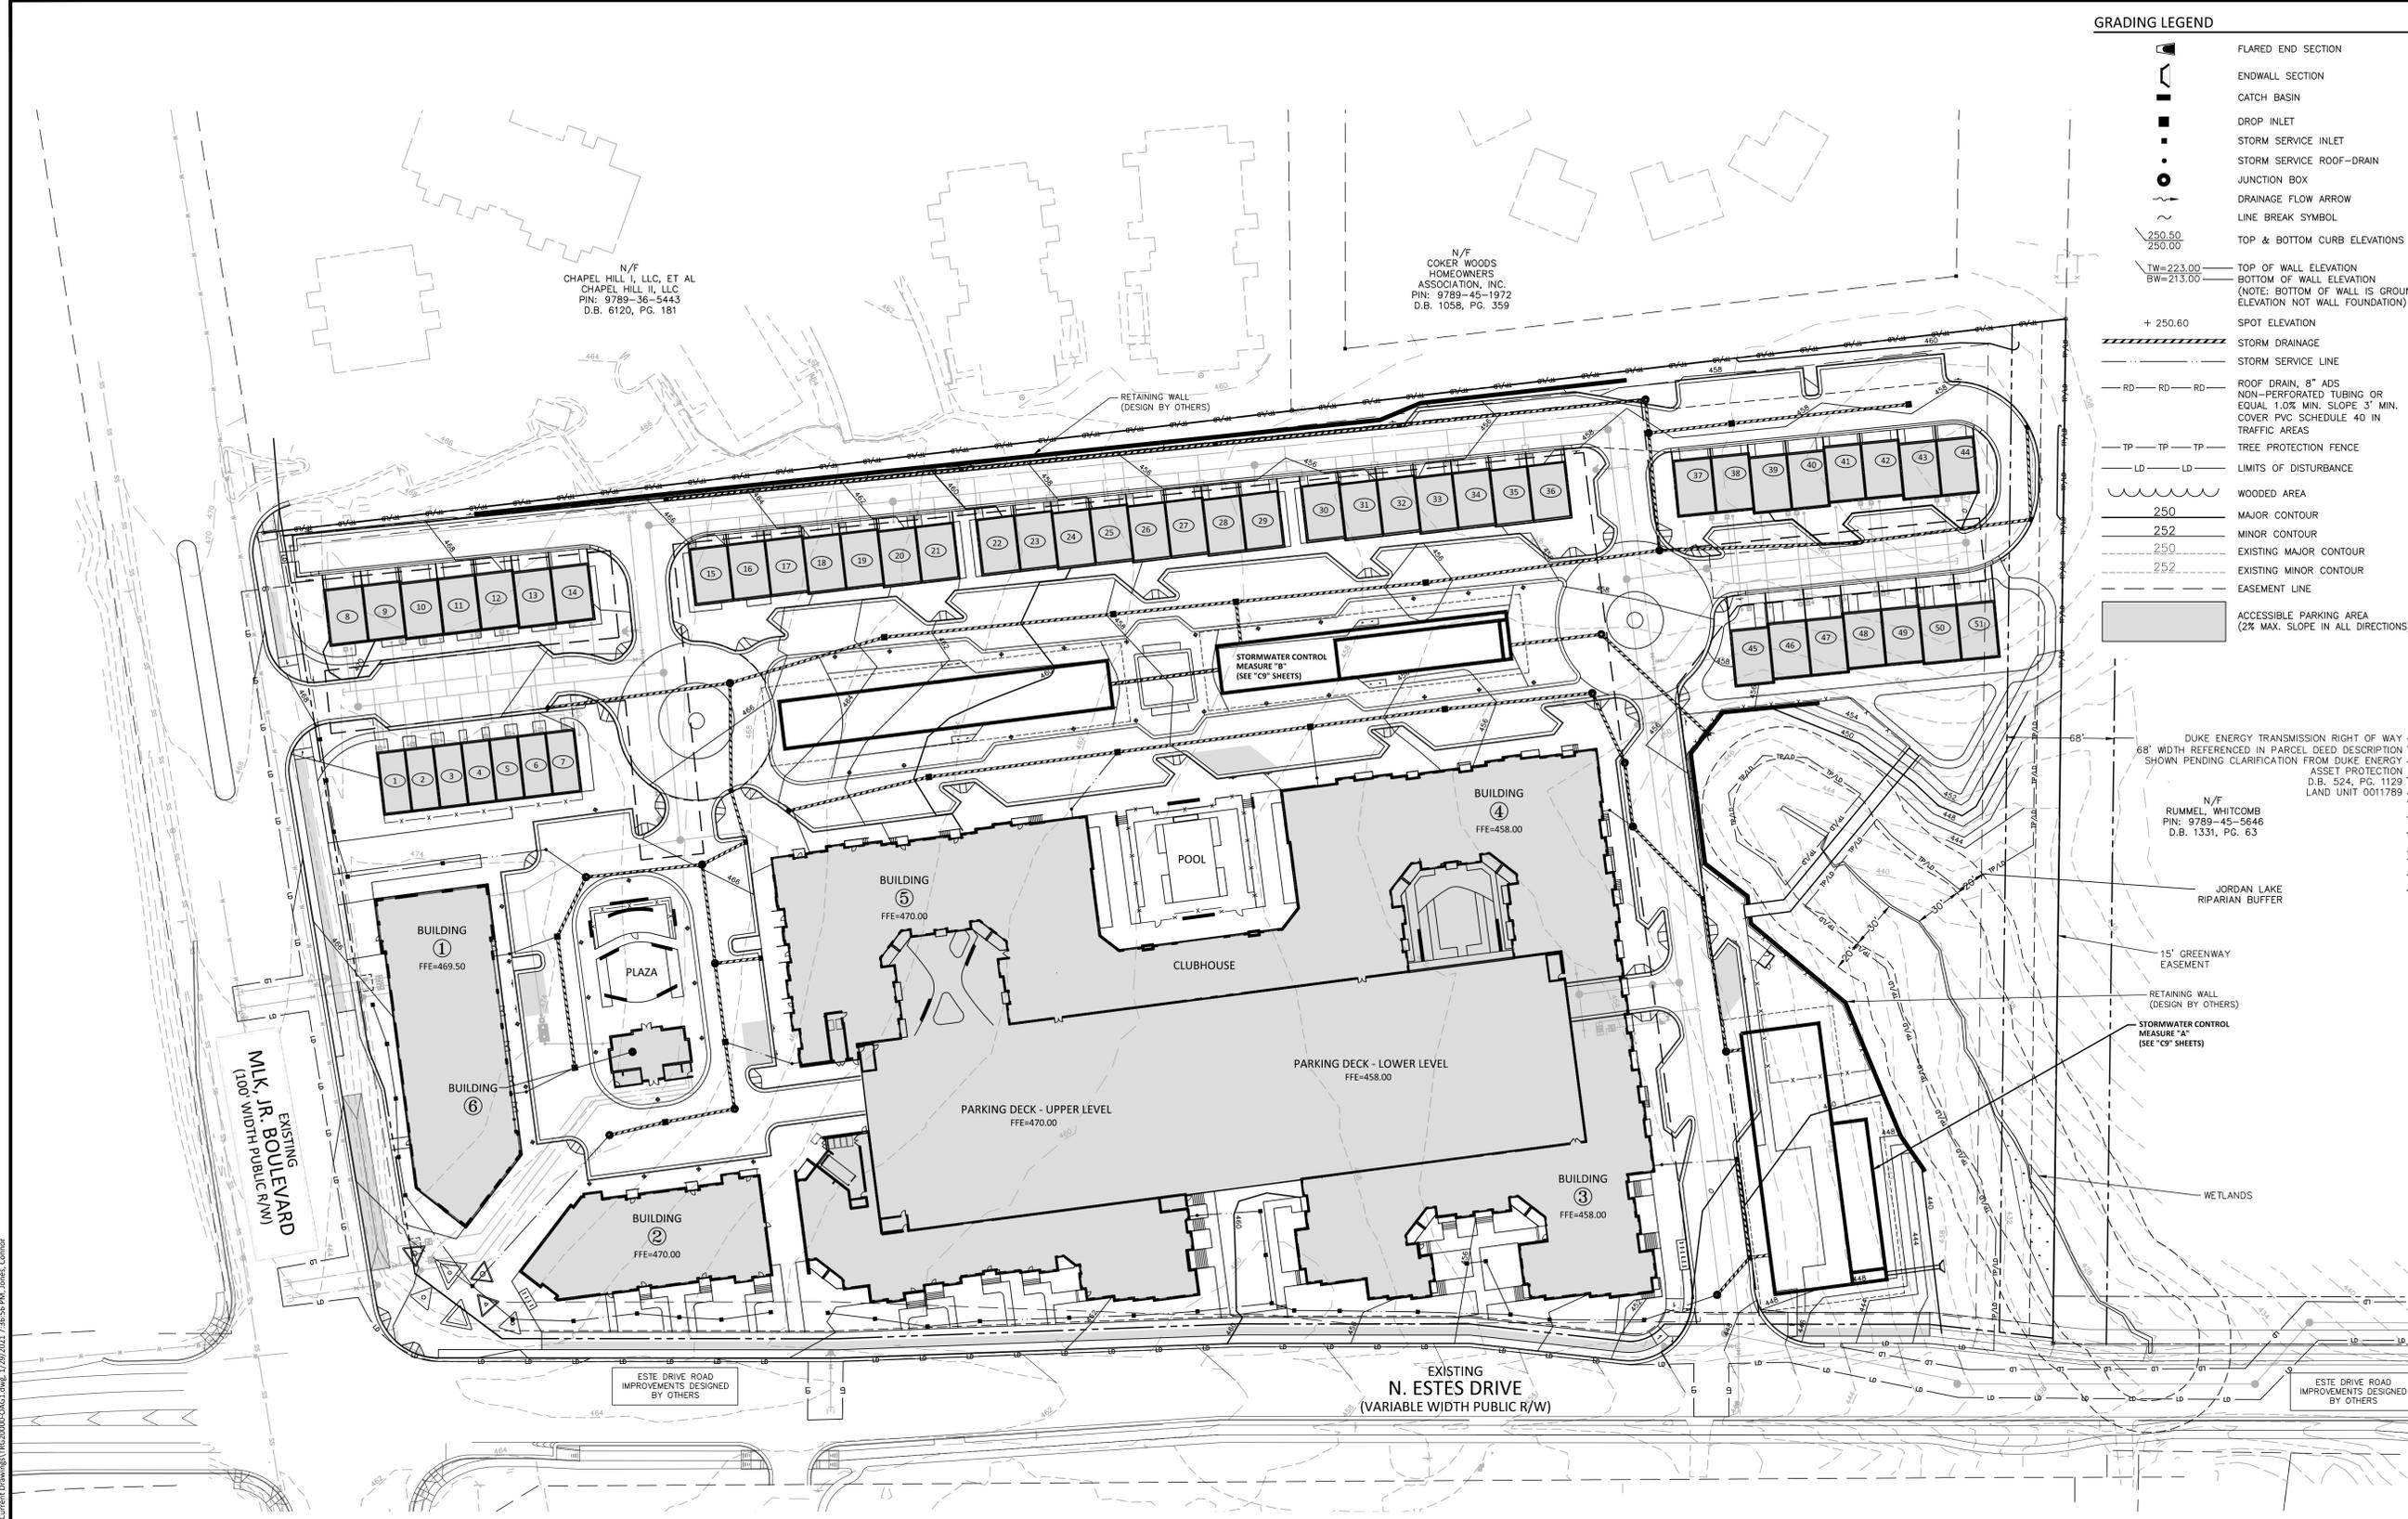


**GENERAL NOTES:**

- THE LANDSCAPE AREAS FRONTING ESTES ROAD AND MLK BLVD WILL BE GRADED TOWARDS THE SITE TO CAPTURE STORMWATER RUNOFF WHERE POSSIBLE AND AS NECESSARY TO MEET STORMWATER TREATMENT REQUIREMENTS.

SEE SHEET C0.01 FOR ALL PROJECT, SITE,  
 GRADING, STORM DRAINAGE AND UTILITY  
 NOTES

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 OF CHAPEL HILL ENGINEERING DESIGN AND  
 CONSTRUCTION STANDARDS

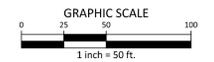

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2905 Meridian Parkway  
Durham, NC 27713

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fax 919. 361. 2269  
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PHONE: 919. 884. 7395

**AURA**  
CONDITIONAL ZONING PERMIT  
NORTH ESTES DRIVE  
CHAPEL HILL, NORTH CAROLINA, 27516



**GRADING LEGEND**

- FLARED END SECTION
- ENDWALL SECTION
- CATCH BASIN
- DROP INLET
- STORM SERVICE INLET
- STORM SERVICE ROOF-RAIN
- JUNCTION BOX
- DRAINAGE FLOW ARROW
- LINE BREAK SYMBOL
- TOP & BOTTOM CURB ELEVATIONS
- TOP OF WALL ELEVATION
- BOTTOM OF WALL ELEVATION  
(NOTE: BOTTOM OF WALL IS GROUND ELEVATION NOT WALL FOUNDATION)
- SPOT ELEVATION
- STORM DRAINAGE
- STORM SERVICE LINE
- ROOF DRAIN, 8" ADS  
NON-PERFORATED TUBING OR  
EQUAL 1.0% MIN. SLOPE 3" MIN.  
COVER PVC SCHEDULE 40 IN  
TRAFFIC AREAS
- TREE PROTECTION FENCE
- LIMITS OF DISTURBANCE
- WOODED AREA
- MAJOR CONTOUR
- MINOR CONTOUR
- EXISTING MAJOR CONTOUR
- EXISTING MINOR CONTOUR
- EASEMENT LINE
- ACCESSIBLE PARKING AREA  
(2% MAX. SLOPE IN ALL DIRECTIONS)


SEE SHEET C3.02

**GENERAL NOTES:**

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**PLAN INFORMATION**

PROJECT NO. TRG-20000  
 FILENAME TRG20000-G1  
 CHECKED BY ZNB  
 DRAWN BY CJJ  
 SCALE 1"=30'  
 DATE 09.24.2020

**SHEET**

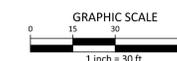**GRADING PLAN - AREA A**

**C3.01**

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