324 ROSEMARY MIXED-USE

PROPERTY 3: AMITY STATION LLC

10,890 SF / 0.25 AC

PARKING OFF-STREET

318 W. ROSEMARY ST.

CHAPEL HILL, NC 27516

9788179085

CAPE FEAR

PROPERTY 4: AMITY STATION LLC

2,614 SF / 0.06 AC

PRIVATE ROAD

CHAPEL HILL, NC

TC-2

AMITY CT.

CAPE FEAR

BUSINESS: MIN. 200 SF

N/A (TOWN CENTER)

 $4 \times 0.8 = 0.8$ CLASS II SPACES

1 / 375 SF FLOOR AREA (200 / 375 = 1 MAX)

9788170111

324 W. ROSEMARY STREET, CHAPEL HILL, NORTH CAROLINA

PROPERTY2:
AMITY STATION LLC

6,149 SF / 0.14 AC

CHAPEL HILL , NC 27516

9788270263

AMITY CT.

CAPE FEAR


PROJECT TEAM:

ARCHITECT

MHA WORKS 501 WASHINGTON ST. DURHAM, NC 27701 P: 919-682-2870 JMARTINSON@MHAWORKS.COM **CIVIL ENGINEER** COULTER JEWELL THAMES PA 111 WEST MAIN STREET DURHAM, NC, 27701 P: 919.682.0368 PROYSTER@CJTPA.COM

VICINITY MAP

LANDSCAPE ARCHITECT COULTER JEWELL THAMES PA 111 WEST MAIN STREET DURHAM, NC, 27701 P: 919.682.0368 JANDERSON@CJTPA.COM

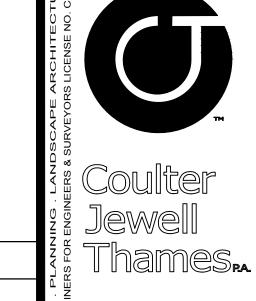

111 West Main Street **Durham, N.C. 27701** p 919.682.0368 f 919.688.5646 www.cjtpa.com

Project:

324 ROSEMARY MIXED-USE

324 W ROSEMARY ST. CHAPEL HILL, NC 27516

ORANGE COUNTY NORTH CAROLINA

PIN: 9788178053

COVER SHEET C100 AREA MAP

PROJECT NOTES

OF PENONNI DATED JANUARY, 2014.

HILL STANDARDS AND SPECIFICATIONS.

-THERE ARE EXISTING TRANSIT STOPS ALONG ROSEMARY.

C101

LIST OF SHEETS

EXISTING CONDITIONS & TREE PROTECTION PLAN DEMOLITION & CONSTRUCTION MANAGEMENT PLAN

- TOPOGRAPHIC INFORMATION BASED ON SURVEY BY PHILIP POST & ASSOC. A DIVISION

-ALL CONSTRUCTION SHALL BE DONE IN ACCORDANCE WITH ALL TOWN OF CHAPEL

C200 SITE LAYOUT PLAN C201 EASEMENT EXHIBIT

C300 GRADING AND STORM DRAINAGE PLAN

EROSION CONTROL PLAN C400 UTILITY AND LIGHTING PLAN

LANDSCAPE & STREETSCAPE PLAN C600 SITE DETAILS

C700 EROSION CONTROL PLAN C701 **EROSION CONTROL DETAILS** 318.AS1 BUILDING MASSING SECTION

> PRELIMINARY NOT FOR CONSTRUCTION

Job Number: 1663

Checked JSA 03.17.2017 Revisions 02.19.2020 COMMENTS 04.24..2020 COMMENTS

SITE PLAN Sheet Title:

Sheet Number

COVER SHEET

OVERALL SITE MAP PROPERTY 5: AMITY STATION LLC 9788178503 28,314 SF / 0.65 AC **BUSINESS-CONCVENIENCE** 322 & 324 W. ROSEMARY ST. 7516 CHAPEL HILL, NC 27516 CAPE FEAR

9.494 SF / 0.22 AC 1,668 SF / 0.04 AC 11,162 SF / 0.26 AC 9,494 SF / 0.22 AC 1,116.2 SF / 0.02 AC 1,668 SF / 0.04 AC 12,278.2 SF / 0.28 AC 39,638 SF / 0.91 AC SITE AREA IN 100 YEAR FLOODPLAIN N/A SECONDARY: PRIMARY: **DWELLING UNITS: 7 OR MORE** BUSINESS

BUILDING INFORMATION

(INCLUDES FLOODWAY)

PROJECT DATA

AMITY STATION LLC 9788178220

44,867 SF / 1.03 AC

1,2,3,4,5,6&7 AMITY CT.

CHAPEL HILL, NC 27516

CAPE FEAR

DWELLING UNITS; 7 OR MORE PRIVATE ROAD

EXISTING SITE INFORMATION

SITE/PROJECT ADDRESS

PROPOSED SITE INFORMATION

NET LAND AREA:

GROSS LAND AREA:

CSA (10% NLA)

DISTURBED AREA:

PROPOSED USE:

ZONING INFORMATION EXISTING ZONING

USE GROUP

RIVER BASIN

R-3

TOTAL

TOTAL

ACREAGE

EXISTING USE

EXISTING BUILDING SIZE: 6,037 SF (BREADMEN'S)

PROPOSED BUILDING SIZE: TOTAL BUILDING SIZE: 19,999 SF

FLOOR AREA RATIO:

TOTAL

EXISTING:

TC-2

1.97 x 10,610.2 SF GLA = 20,902.09 SF

MIXED USE BUILDING USE: RESIDENTIAL MAX. 20 UNITS

BUSINESS MIN. 200 SF

20 UNITS / 0.28 GLA = 71 UNITS PER ACRE

VEHICULAR PARKING SPACES **DWELLING UNITS: MAX. 20 UNITS** N/A (TOWN CENTER) MINIMUM:

 $1.67 / DWELLING UNIT (1.67 \times 20 = 33 MAX)$

MAXIMUM:

PROPOSED: 14 SPACES TOTAL VEHICULAR PARKING SPACES: 1 ADA SPACE

4 COMPACT SPACES 9 REGULAR SPACES 14 TOTAL PARKING SPACES

MIN. 8 CLASS I SPACES

BICYCLE PARKING SPACES REQUIRED:

DWELLING UNITS: MAX. 20 UNITS BUSINESS: MIN. 200 SF 1 / 4 UNITS = 5 SPACES MIN. 4; 2 ADD'L / 2,500 SF FLOOR AREA = 4 SPACES $4 \times 0.8 = 3.2$ CLASS I SPACES $5 \times 0.9 = 4.5$ CLASS I SPACES

 $5 \times 0.1 = 0.5$ CLASS II SPACES

4.5 + 3.2 = 7.7 ≈ 8 CLASS I SPACES REQUIRED TOTAL $0.5 + 0.8 = 1.3 \approx 1$ CLASS II SPACE REQUIRED TOTAL

MIN. 1 CLASS II SPACES

IMPERVIOUS SURFACE

PROPOSED:

EXISTING: 10,409 SF / 0.24 AC 9,777 SF / 0.22 AC IMPERVIOUS PROPOSED: TOTAL IMPERVIOUS SURFACE: 9,777 SF / 0.22 AC TREE CANOPY COVERAGE N/A (TOWN CENTER) TOWN OF CHAPEL HILL NOTES 1. A FIRE FLOW REPORT SHALL BE SUBMITTED TO THE TOWN FOR REVIEW AND APPROVAL PRIOR TO ISSUANCE OF A ZCP.

2. P.E. CERTIFICATION: PRIOR TO THE ISSUANCE OF A CERTIFICATE OF OCCUPANCY FOR ANY PHASE, THE APPLICANT SHALL PROVIDE A CERTIFICATION, SIGNED AND SEALED BY A NORTH CAROLINA-LICENSED PROFESSIONAL ENGINEER, THAT THE STORMWATER MANAGEMENT FACILITY IS CONSTRUCTED IN ACCORDANCE WITH THE APPROVED PLANS AND SPECIFICATIONS.

AS-BUILT PLANS: PRIOR TO THE ISSUANCE OF A CERTIFICATE OF OCCUPANCY, THE APPLICANT SHALL PROVIDE CERTIFIED AS-BUILT PLANS FOR BUILDING FOOTPRINTS, PARKING LOTS, STREET IMPROVEMENTS, STORM DRAINAGE SYSTEMS AND STORMWATER MANAGEMENT STRUCTURES, AND ALL OTHER IMPERVIOUS SURFACES, AND A TALLY OF THE CONSTRUCTED IMPERVIOUS AREA. THE AS-BUILT PLANS SHOULD BE IN DXF BINARY FORMAT USING STATE PLANE

4. ANY RETAINING WALLS OVER FIVE (5) FEET HIGH SHALL BE PERMITTED SEPARATELY FROM THE BUILDING(S) AND MUST BE SIGNED BY A DESIGN PROFESSIONAL.

5. PROVIDE ONSITE PARKING FOR INSPECTORS AT EACH BUILDING FOR THE DURATION OF THE CONSTRUCTION PROJECT.

6. PROVIDE A TIRE WASH FOR TRUCKS ONSITE BEFORE THEY HIT THE MAIN ROADS.

7. CURB AND GUTTER AND AT LEAST THE FIRST LIFT OF ASPHALT FOR THE ROADS MUST BE DOWN AHEAD OF CONSTRUCTION.

10. A SEPARATE SUBMITTAL AND PERMIT WILL BE REQUIRED FOR ANY SIGNAGE ON THE BUILDING OR GROUND MOUNTED SIGNS

8. A SINGLE ELECTRICAL SERVICE SHALL BE PROVIDED TO SERVE THE STRUCTURE WITH THE EXCEPTION OF THE FIRE PUMP. ARTICLE 230.2 (A) 2017 EDITION OF NORTH CAROLINA ELECTRIC CODE.

PRIOR TO ISSUANCE OF A CERTIFICATE OF OCCUPANCY, THE APPLICANT SHALL PROVIDE THE MINIMUM REQUIRED HANDICAPPED PARKING SPACES AND DESIGN ALL HANDICAPPED PARKING SPACES, RAMPS, AND CROSSWALKS, AND ASSOCIATED INFRASTRUCTURE ACCORDING TO AMERICANS WITH DISABILITIES ACT STANDARDS, NORTH CAROLINA BUILDING CODE, AMERICAN NATIONAL STANDARDS INSTITUTE (ANSI)

• PARKING - NUMBER OF SPACES TO COMPLY WITH NCBC 2018 SECTION 1106.1, 1 PER 6 COMPLIANT SPACES OR PORTION THEREOF MUST BE VAN ACCESSIBLE, NO SLOPE TO EXCEED 2% IN ANY DIRECTION. SIGNAGE PER NC REQUIREMENTS, MUT-CD AND ICC A 117.1.

• CURB CUTS AND ACCESSIBLE ROUTES PER ICC A117.1 2009 ED. CROSS SLOPE LIMITED TO 2%, CALL FOR INSPECTION BEFORE PLACEMENT OF CONCRETE.

• SLOPE GREATER THAN 5% REQUIRES CONSTRUCTION AS A RAMP.

11. ALL CONSTRUCTION AND DEMOLITION CONDUCTED SHALL BE IN COMPLIANCE OF THE CURRENT EDITION OF THE NC FIRE CODE. 2018 NCFC CHAPTER 33

RESOURCE CONSERVATION NOTES

THERE ARE NO MAPPED STREAMS OR ASSOCIATED STREAM BUFFERS LOCATED ON SITE. A DETERMINATION WAS COMPLETED BY CHAPEL HILL PUBLIC WORKS.


THE SITE IS NOT AFFECTED BY A MAPPED FLOODPLAIN ACCORDING TO FIRM MAPS 3710978800 J (FEBRUARY 2, 2007).

THERE ARE NO AREAS OF STEEP SLOPES GREATER THAN 15% LOCATED ON SITE.

THE TREE SURVEY SHOWS ALL 18" CAL. OR LARGER TREES ON THE EXISTING CONDITIONS PLAN.

THERE ARE NO MAPPED WETLANDS ONSITE.

TREE PROTECTION: REFER TO SHEET C102 AND C500.

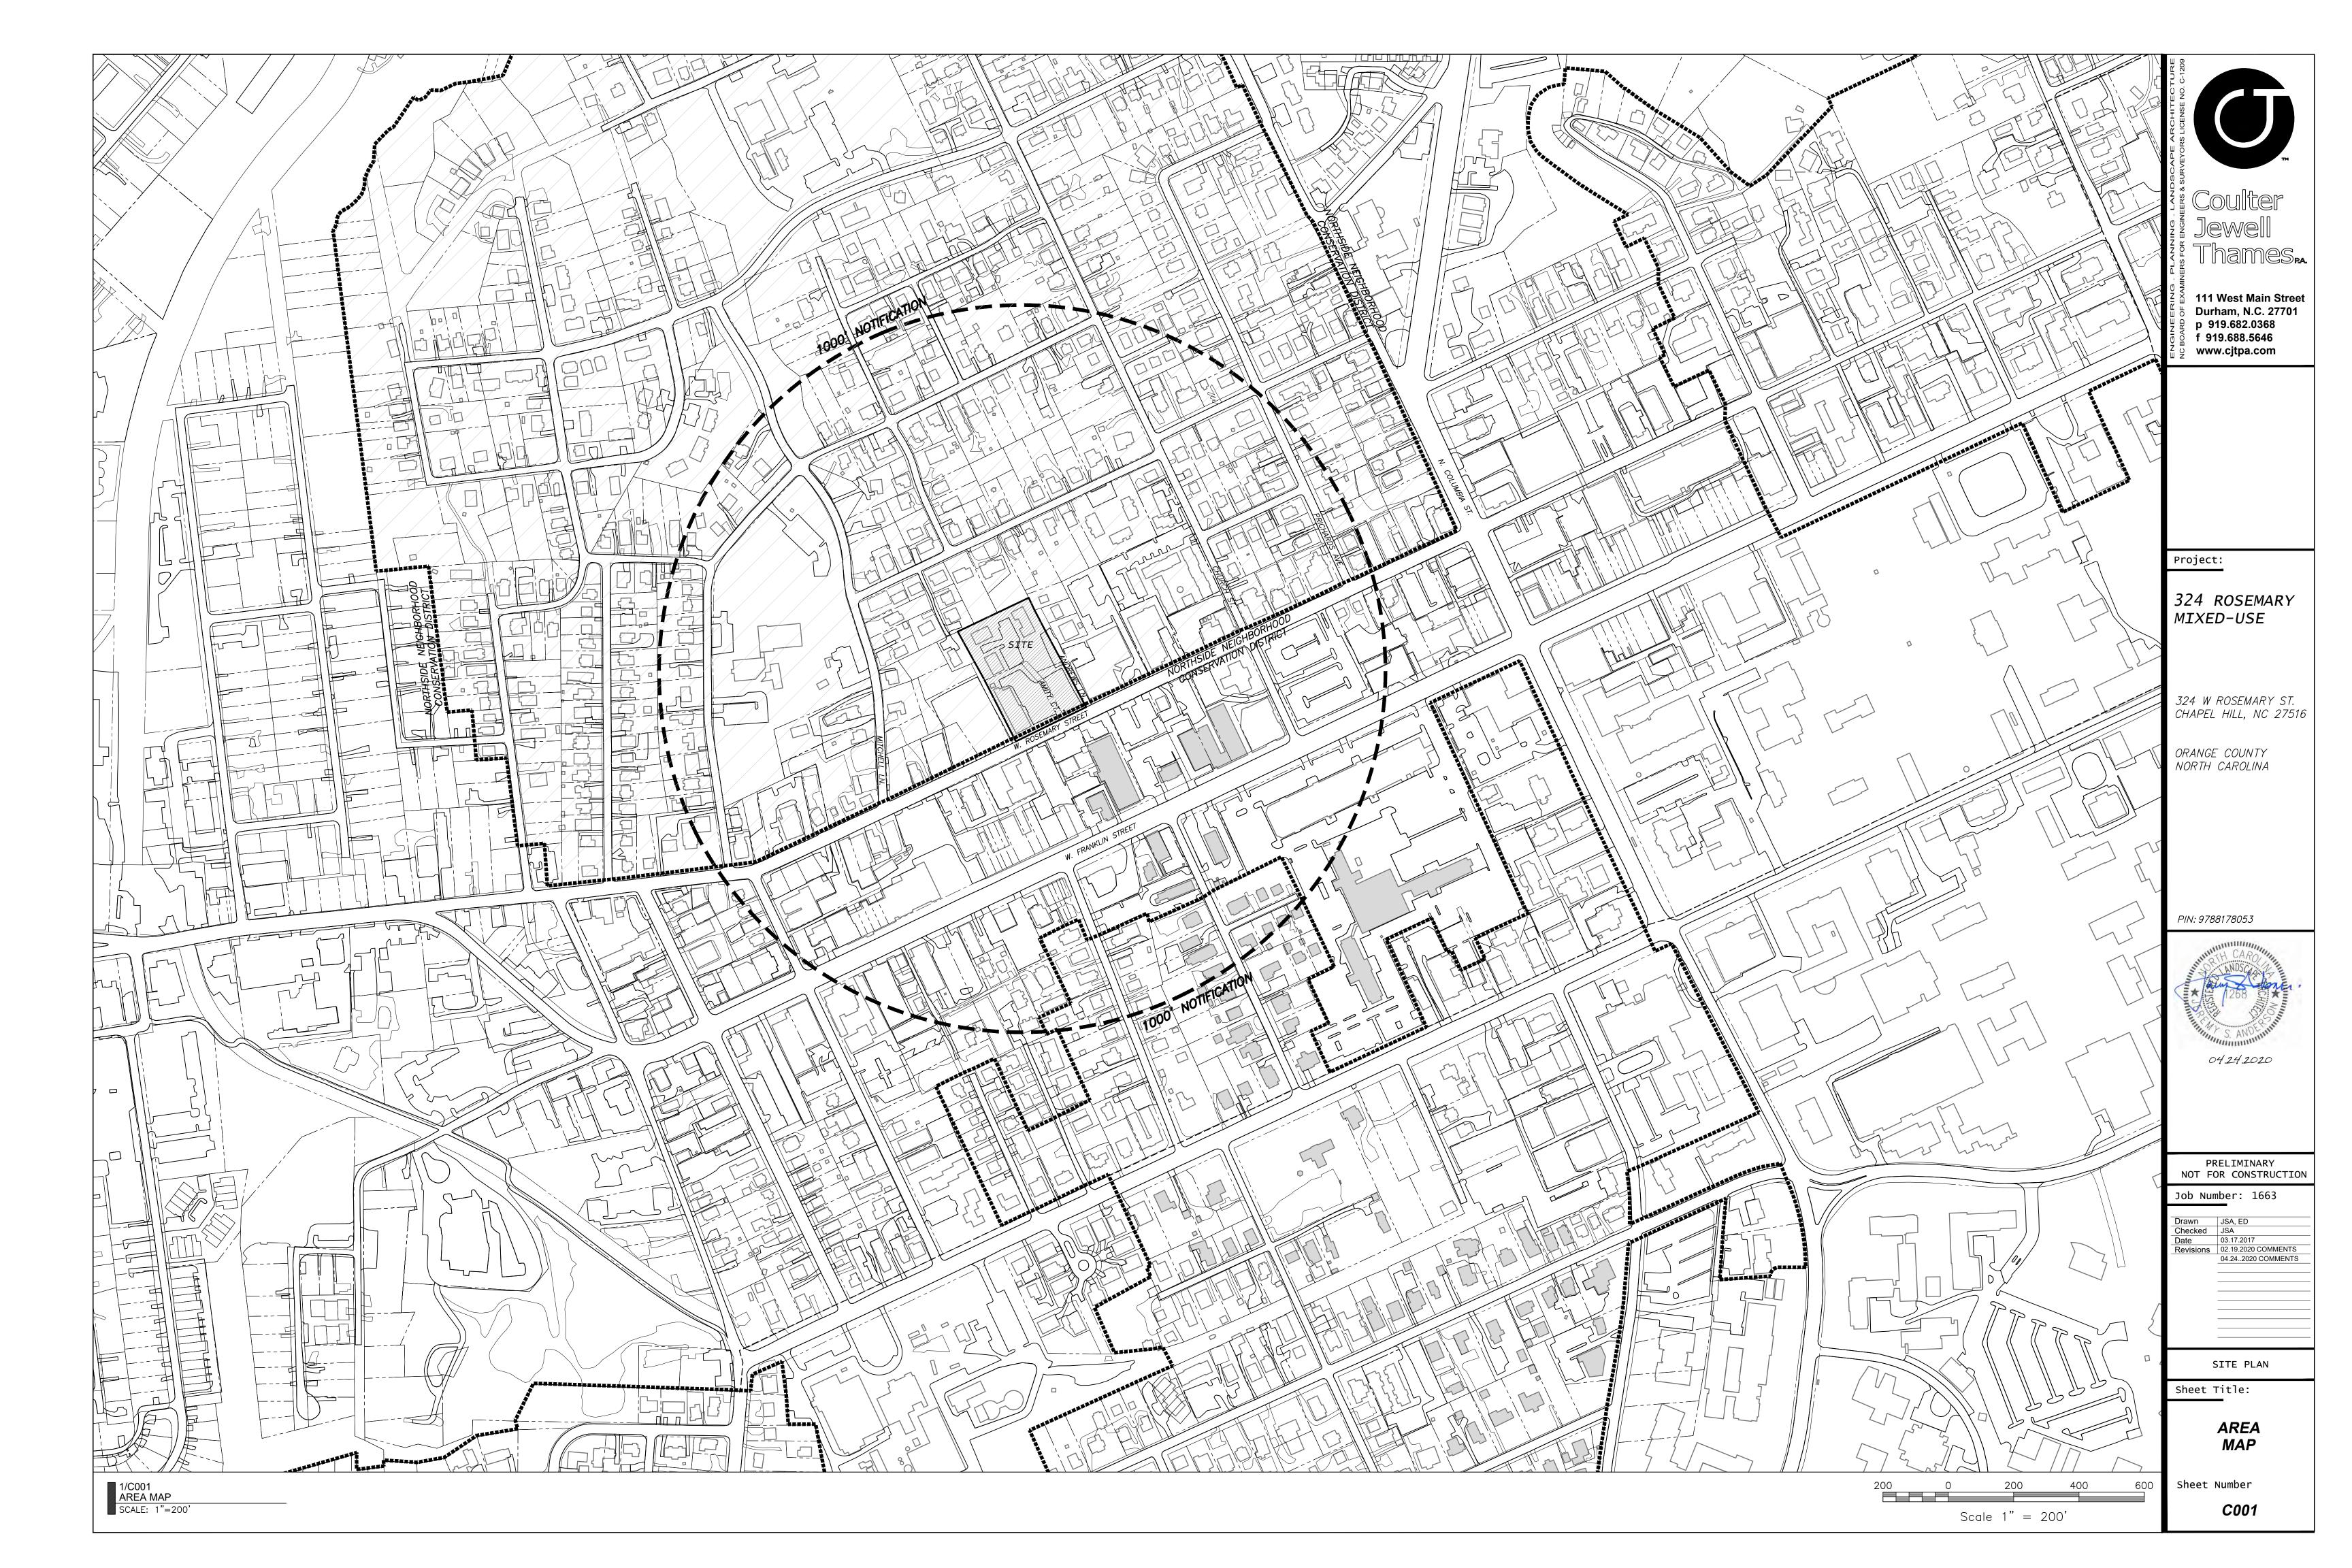



demolition notes

- 1. ENSURE ALL EROSION CONTROL MEASURES ARE IN PLACE AND IN WORKING ORDER PRIOR TO THE START OF ANY DEMOLITION AND CONSTRUCTION. 2. SEE SITE PLAN SHEET C101 FOR LAYOUT DIMENSIONS OF EXTENT OF DEMOLISHED AREAS.
- ARE TO BE CLEAN, STRAIGHT AND NEAT. 3. UTILITIES: SEE UTILITY PLAN C400. CONTRACTOR TO COORDINATE WITH UTILITY COMPANIES FOR LOCATION, REMOVAL AND RELOCATION OF ANY UTILITIES. CONTRACTOR RESPONSIBLE FOR DETERMINING EXTENT AND LOCATION OF UTILITIES. THIS MAY INCLUDE CONTACTING "NO-CUTS" TO HELP LOCATE SOME UTILITIES. 4. CONTRACTOR TO ADJUST ALL MANHOLES, VALVES, JUNCTION BOXES, CATCH BASINS, CLEAN-OUTS,
- ETC., AS NECESSARY TO ACCOMMODATE NEW LAYOUT AND GRADES. 5. CONTRACTOR RESPONSIBLE FOR OBTAINING ANY PERMITS FOR WORK IN THE NCDOT AND TOWN OF CHAPEL HILL RIGHTS OF WAY. ANY DAMAGED INFRASTRUCTURE IN THE RIGHT OF WAY CAUSED BY CONSTRUCTION ACTIVITIES MUST BE REPAIRED TO TOWN OF CHAPEL HILL STANDARDS. THIS INCLUDES, BUT IS NOT LIMITED TO UTILITIES, SIDEWALKS, CURB AND GUTTER, ASPHALT.

PAVED AREAS NOT INDICATED TO BE DEMOLISHED, ARE TO REMAIN. ALL CONCRETE SAW CUTS

- 6. CONTRACTOR RESPONSIBLE FOR REMOVING EVERYTHING WITHIN THE CLEARING LIMITS AND OFF-SITE WORK ZONE INCLUDING TREES, STUMPS, TRASH, FENCING, OR BUILDING MATERIALS. 7. CONTRACTOR TO USE CAUTION WORKING AROUND AND NEAR EXISTING STORM, WATER AND
- SEWER. CONTRACTOR RESPONSIBLE FOR DAMAGE TO EXISTING UTILITIES. 8. ABANDONMENT OF WATER SERVICES SHALL INCLUDE EXCAVATING DOWN TO CORPORATION, TURNING IT OFF AND CUTTING SERVICE LINE FREE FROM CORPORATION. THE METER, IF PRESENT,
- SHALL BE RETURNED TO OWASA. 9. ABANDONMENT OF SANITARY SEWER SERVICE LINES SHALL CONSIST OF PLUGGING THE LATERAL AT THE RIGHT—OF—WAY LINE.
- 10. ALL PAVEMENT PATCHING SHALL BE PERFORMED PER CITY SPECIFICATIONS AND STANDARDS. 11. A DECONSTRUCTION ASSESSMENT WILL BE REQUIRED BEFORE A DEMOLITION PERMIT WILL BE
- ISSUED FOR THE EXISTING 2 STORY STRUCTURE. 12. BY ORANGE COUNTY ORDINANCE, CLEAN WOOD WASTE, SCRAP METAL AND CORRUGATED CARDBOARD, ALL PRESENT IN CONSTRUCTION WASTE, MUST BE RECYCLED.
- 13. BY ORANGE COUNTY ORDINANCE, ALL HAULERS OF CONSTRUCTION WASTE MUST BE PROPERLY 14. PRIOR TO ANY DEMOLITION OR CONSTRUCTION ACTIVITY ON THE SITE THE APPLICANT WILL HOLD
- A PRE-DEMOLITION/PRE-CONSTRUCTION CONFERENCE WITH THE COUNTY'S SOLID WASTE STAFF. THIS MAY BE THE SAME MEETING HELD WITH OTHER DEVELOPMENT OFFICIALS.
- 15. THE PRESENCE OF ANY ASBESTOS CONTAINING MATERIAL ('ACM') OR OTHER HAZARDOUS MATERIALS IN CONSTRUCTION AND DEMOLITION WASTE SHALL BE HANDLED IN ACCORDANCE WITH ANY AND ALL LOCAL, STATE, AND FEDERAL REGULATIONS AND GUIDELINES.

 16. A DEMO PERMIT IS REQUIRED TO REMOVE EXISTING BUILDINGS.

Thames

Durham, N.C. 27701 p 919.682.0368 f 919.688.5646 www.cjtpa.com


111 West Main Street

Project:

324 ROSEMARY MIXED-USE

324 W ROSEMARY ST. CHAPEL HILL, NC 27516

ORANGE COUNTY NORTH CAROLINA

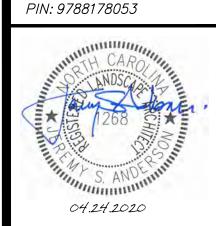

PRELIMINARY NOT FOR CONSTRUCTION

Job Number: 1663

Checked JSA
 Date
 03.17.2017

 Revisions
 02.19.2020 COMMENTS
 04.24..2020 COMMENTS

SITE PLAN Sheet Title:

EXISTING CONDITIONS, **DEMOLITION & REE PROTECTION** Sheet Number

Scale 1" = 20'

____ ss_____ ss_____ ss_____ ss____

~~~ × ----- × ----\_\_\_\_\_ UE-----\_\_\_\_\_ ит\_\_\_\_

LECEND

Water Meter

Hot Box

Utility Pole

| LEGEND                 |               |                                                      |             |  |
|------------------------|---------------|------------------------------------------------------|-------------|--|
| Water Valve            | $\otimes$     | Light Pole                                           | oLP         |  |
| Curb Inlet/Catch Basin |               | Sewer Cleanout                                       | OC0         |  |
| Mail Box               | MB            | Flared End Section                                   |             |  |
| Traffic Signal Box     | ☐ TSB         | Gas Valve                                            | ⊗ GV        |  |
| Electric Transformer   |               | Existing Iron Pipe (3/4" unless noted)               |             |  |
| Electric Junction Box  | E             | 1/2" Iron Pipe Set                                   | O IPS       |  |
| Gas Meter              | G             | Existing PK Nail                                     | ● PK        |  |
| Sanitary Sewer Manhole |               | PK Nail Set                                          | PKS         |  |
| Storm Sewer Manhole    | ©<br>®<br>®   | Computed Point                                       | Δ           |  |
| Telephone Manhole      | <b>®</b>      | Concrete Monument                                    | $\boxtimes$ |  |
| Electric Manhole       | <b>@</b>      | Tree Line                                            | ······      |  |
| Sign                   | <del>-0</del> | Fence×                                               | x x x x     |  |
| Telephone Pedestal     | ∑ TEL         | Underground Electric — u<br>Underground Telephone— v | E           |  |
| Fire Hydrant           | •             | Gas Line                                             | GAS GAS     |  |
| Post Indicator Valve   | ○ PIV         | Water Line ——<br>Overhead Utilities ——               | w           |  |
| Water Manhole          | <b>(W)</b>    | 01 0                                                 | ssss        |  |


 $H\!B$ 

b

Sanitary Sewer

Guard Rail

Building Wall

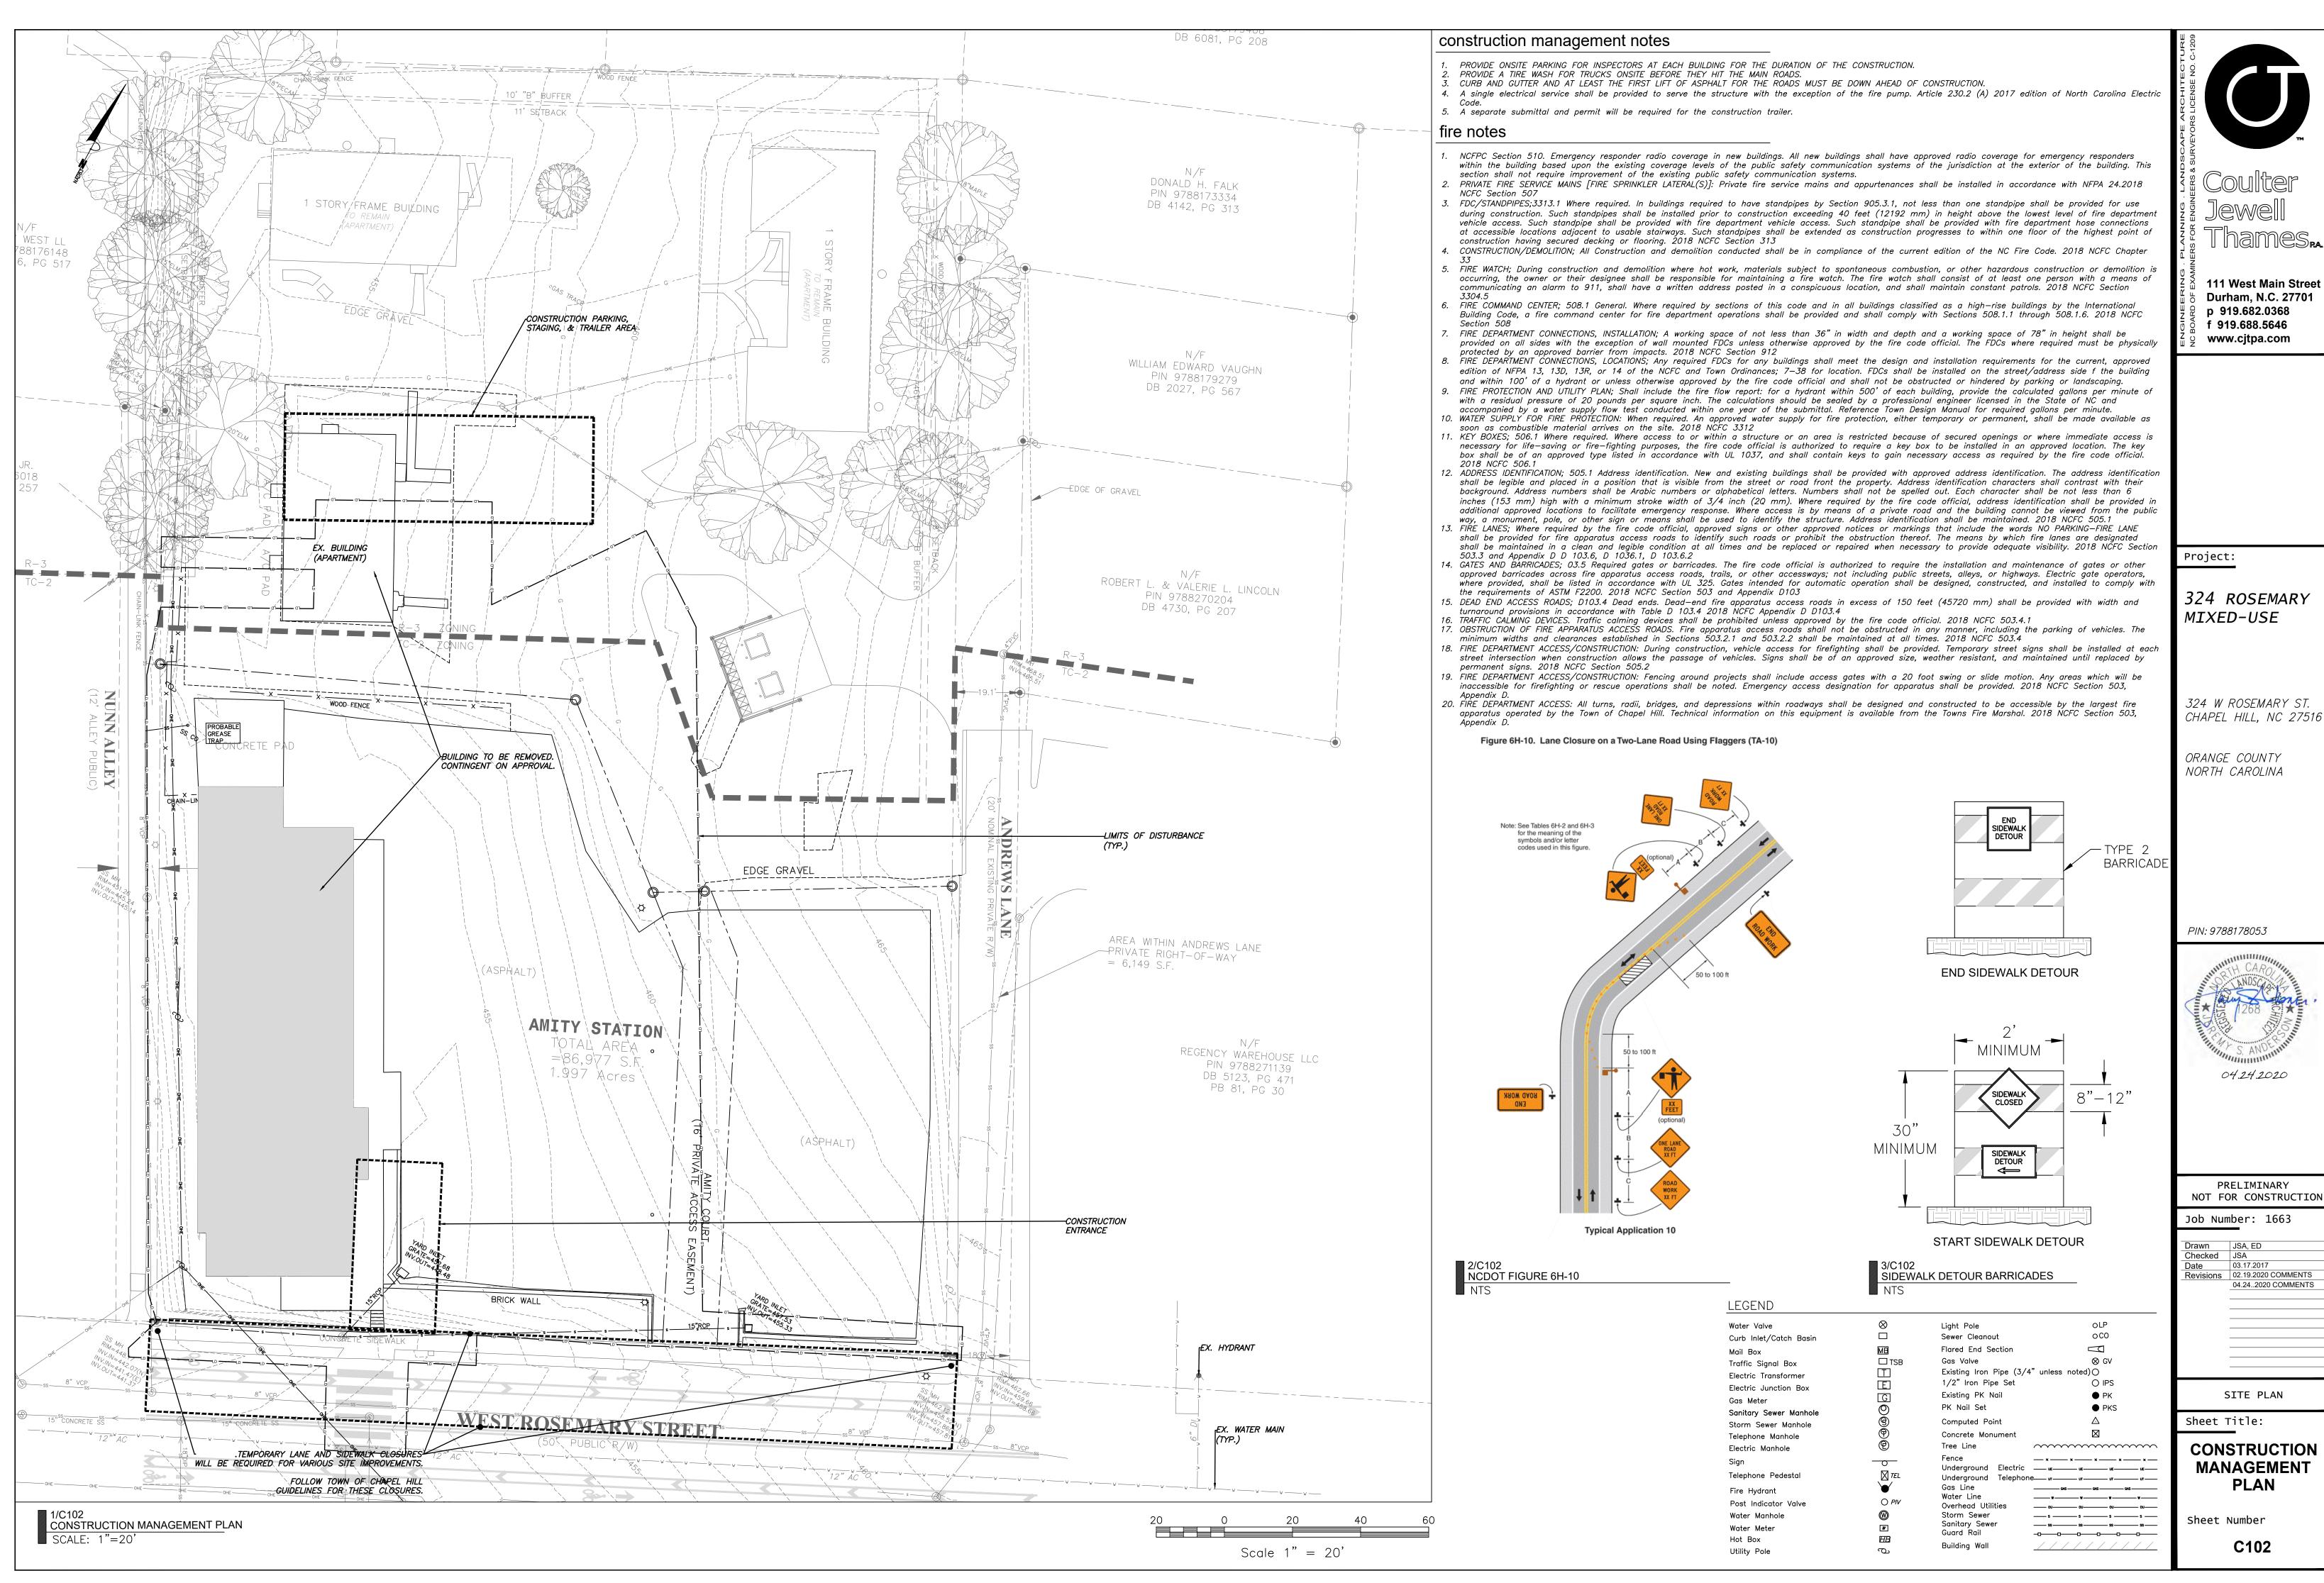


111 West Main Street

324 ROSEMARY

324 W ROSEMARY ST.




Revisions 02.19.2020 COMMENTS 04.24..2020 COMMENTS

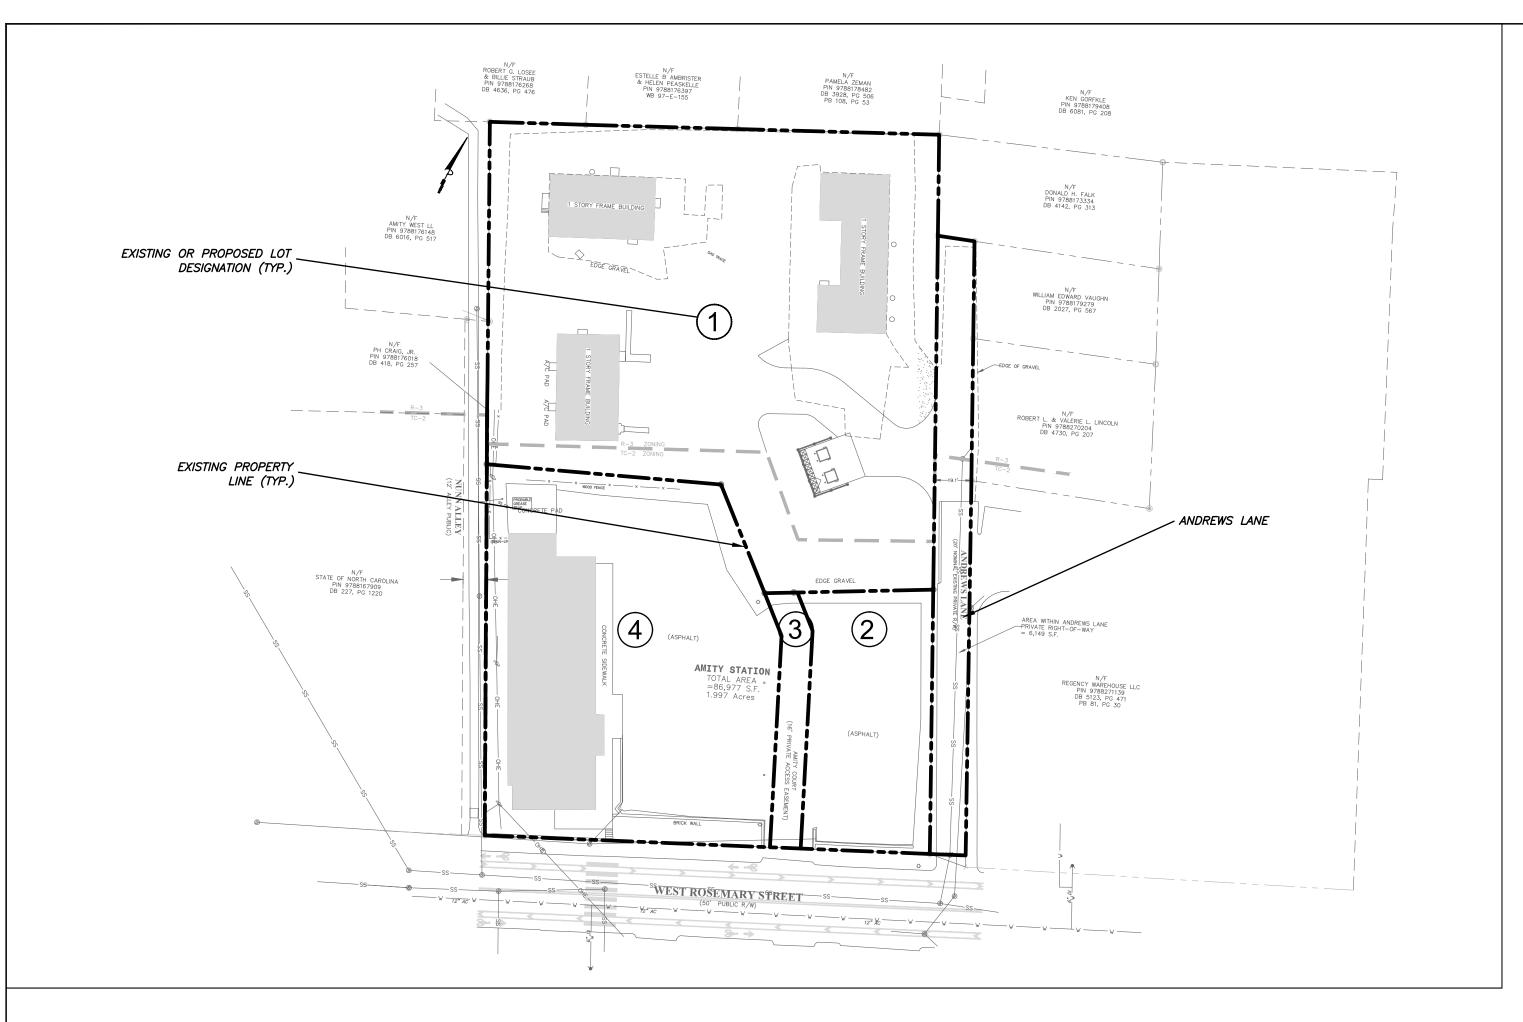

1/C103 EXISTING LOT CONFIGURATION (4 lots + Andrews Lane) SCALE: 1"=50'

ANCH PRINCETO IN CONTROL IN CONTR

2/C103 SUBDIVISION CONFIGURATION (6 lots total) SCALE: 1"=50'

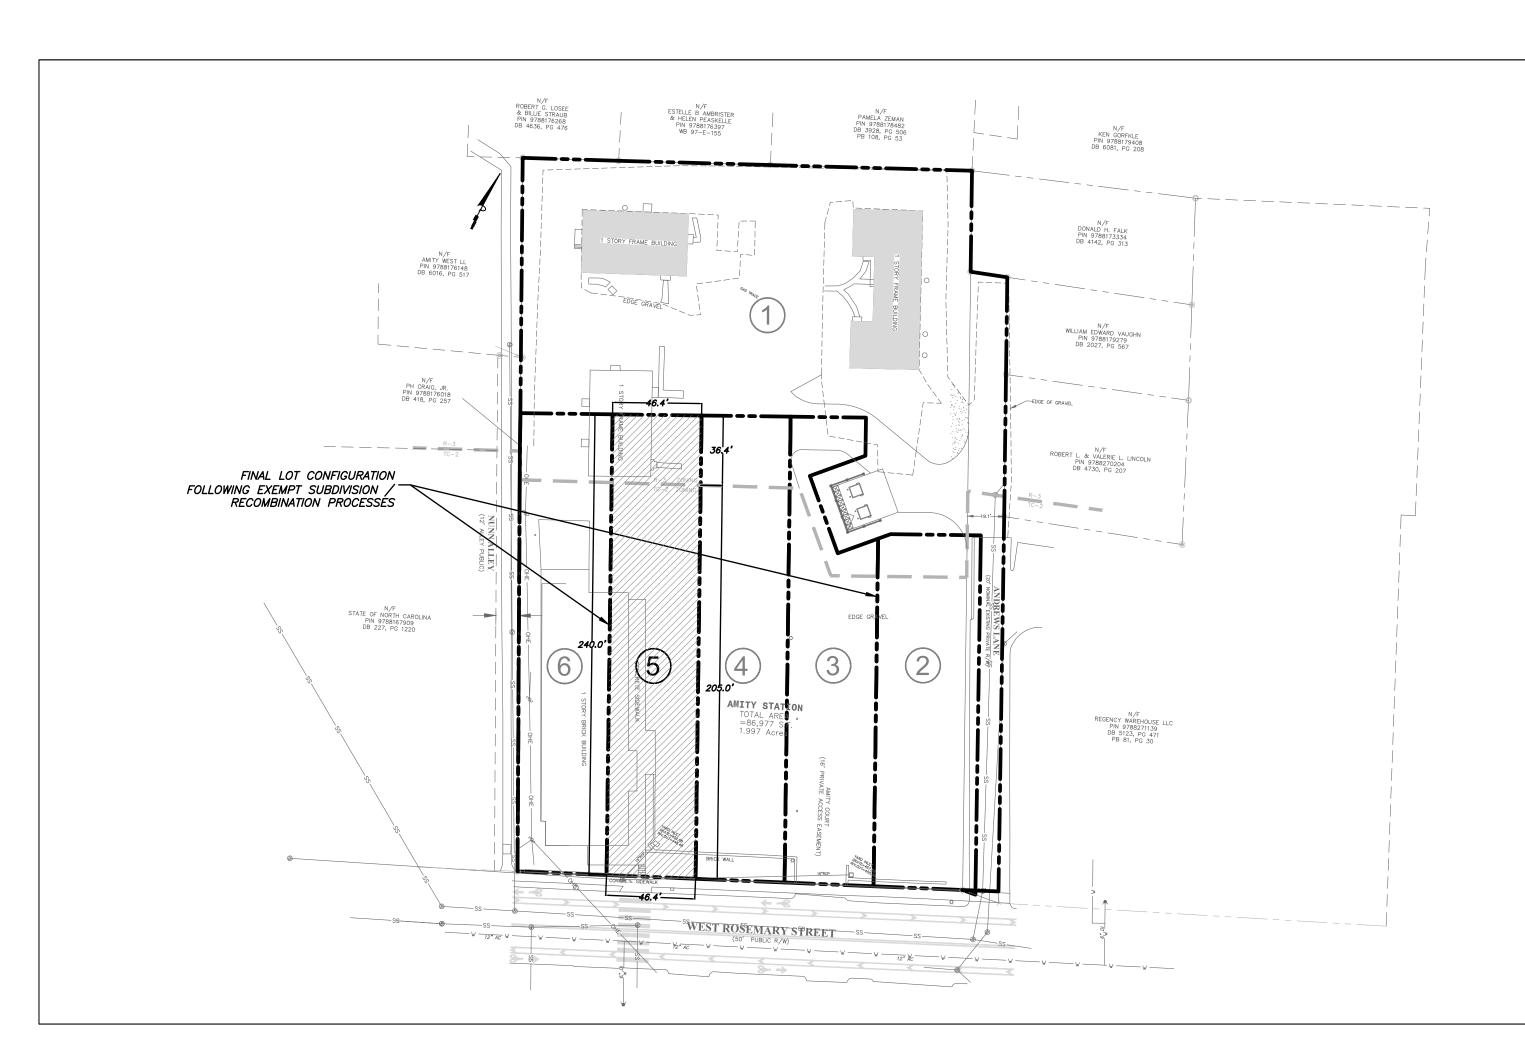

3/C103
FINAL LOT CONFIGURATION FOR 324 ROSEMARY

SCALE: 1"=50'

MINNERS FOR ENGINEERS & SURVEYORS LICENSE NO.

111 West Main Street

b Durham, N.C. 27701
p 919.682.0368
f 919.688.5646

www.cjtpa.com


Project:

324 ROSEMARY MIXED-USE

324 W ROSEMARY ST. CHAPEL HILL, NC 27516

ORANGE COUNTY NORTH CAROLINA

PIN: 9788178053

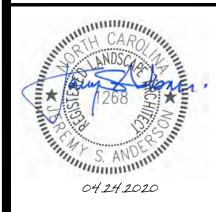

PRELIMINARY NOT FOR CONSTRUCTION

Job Number: 1663

 Drawn
 JSA, ED

 Checked
 JSA

 Date
 03.17.2017

 Revisions
 02.19.2020 COMMENTS

 04.24..2020 COMMENTS


SITE PLAN

Sheet Title:

EXISTING LOTS RECOMBINATION

Sheet Number

C103

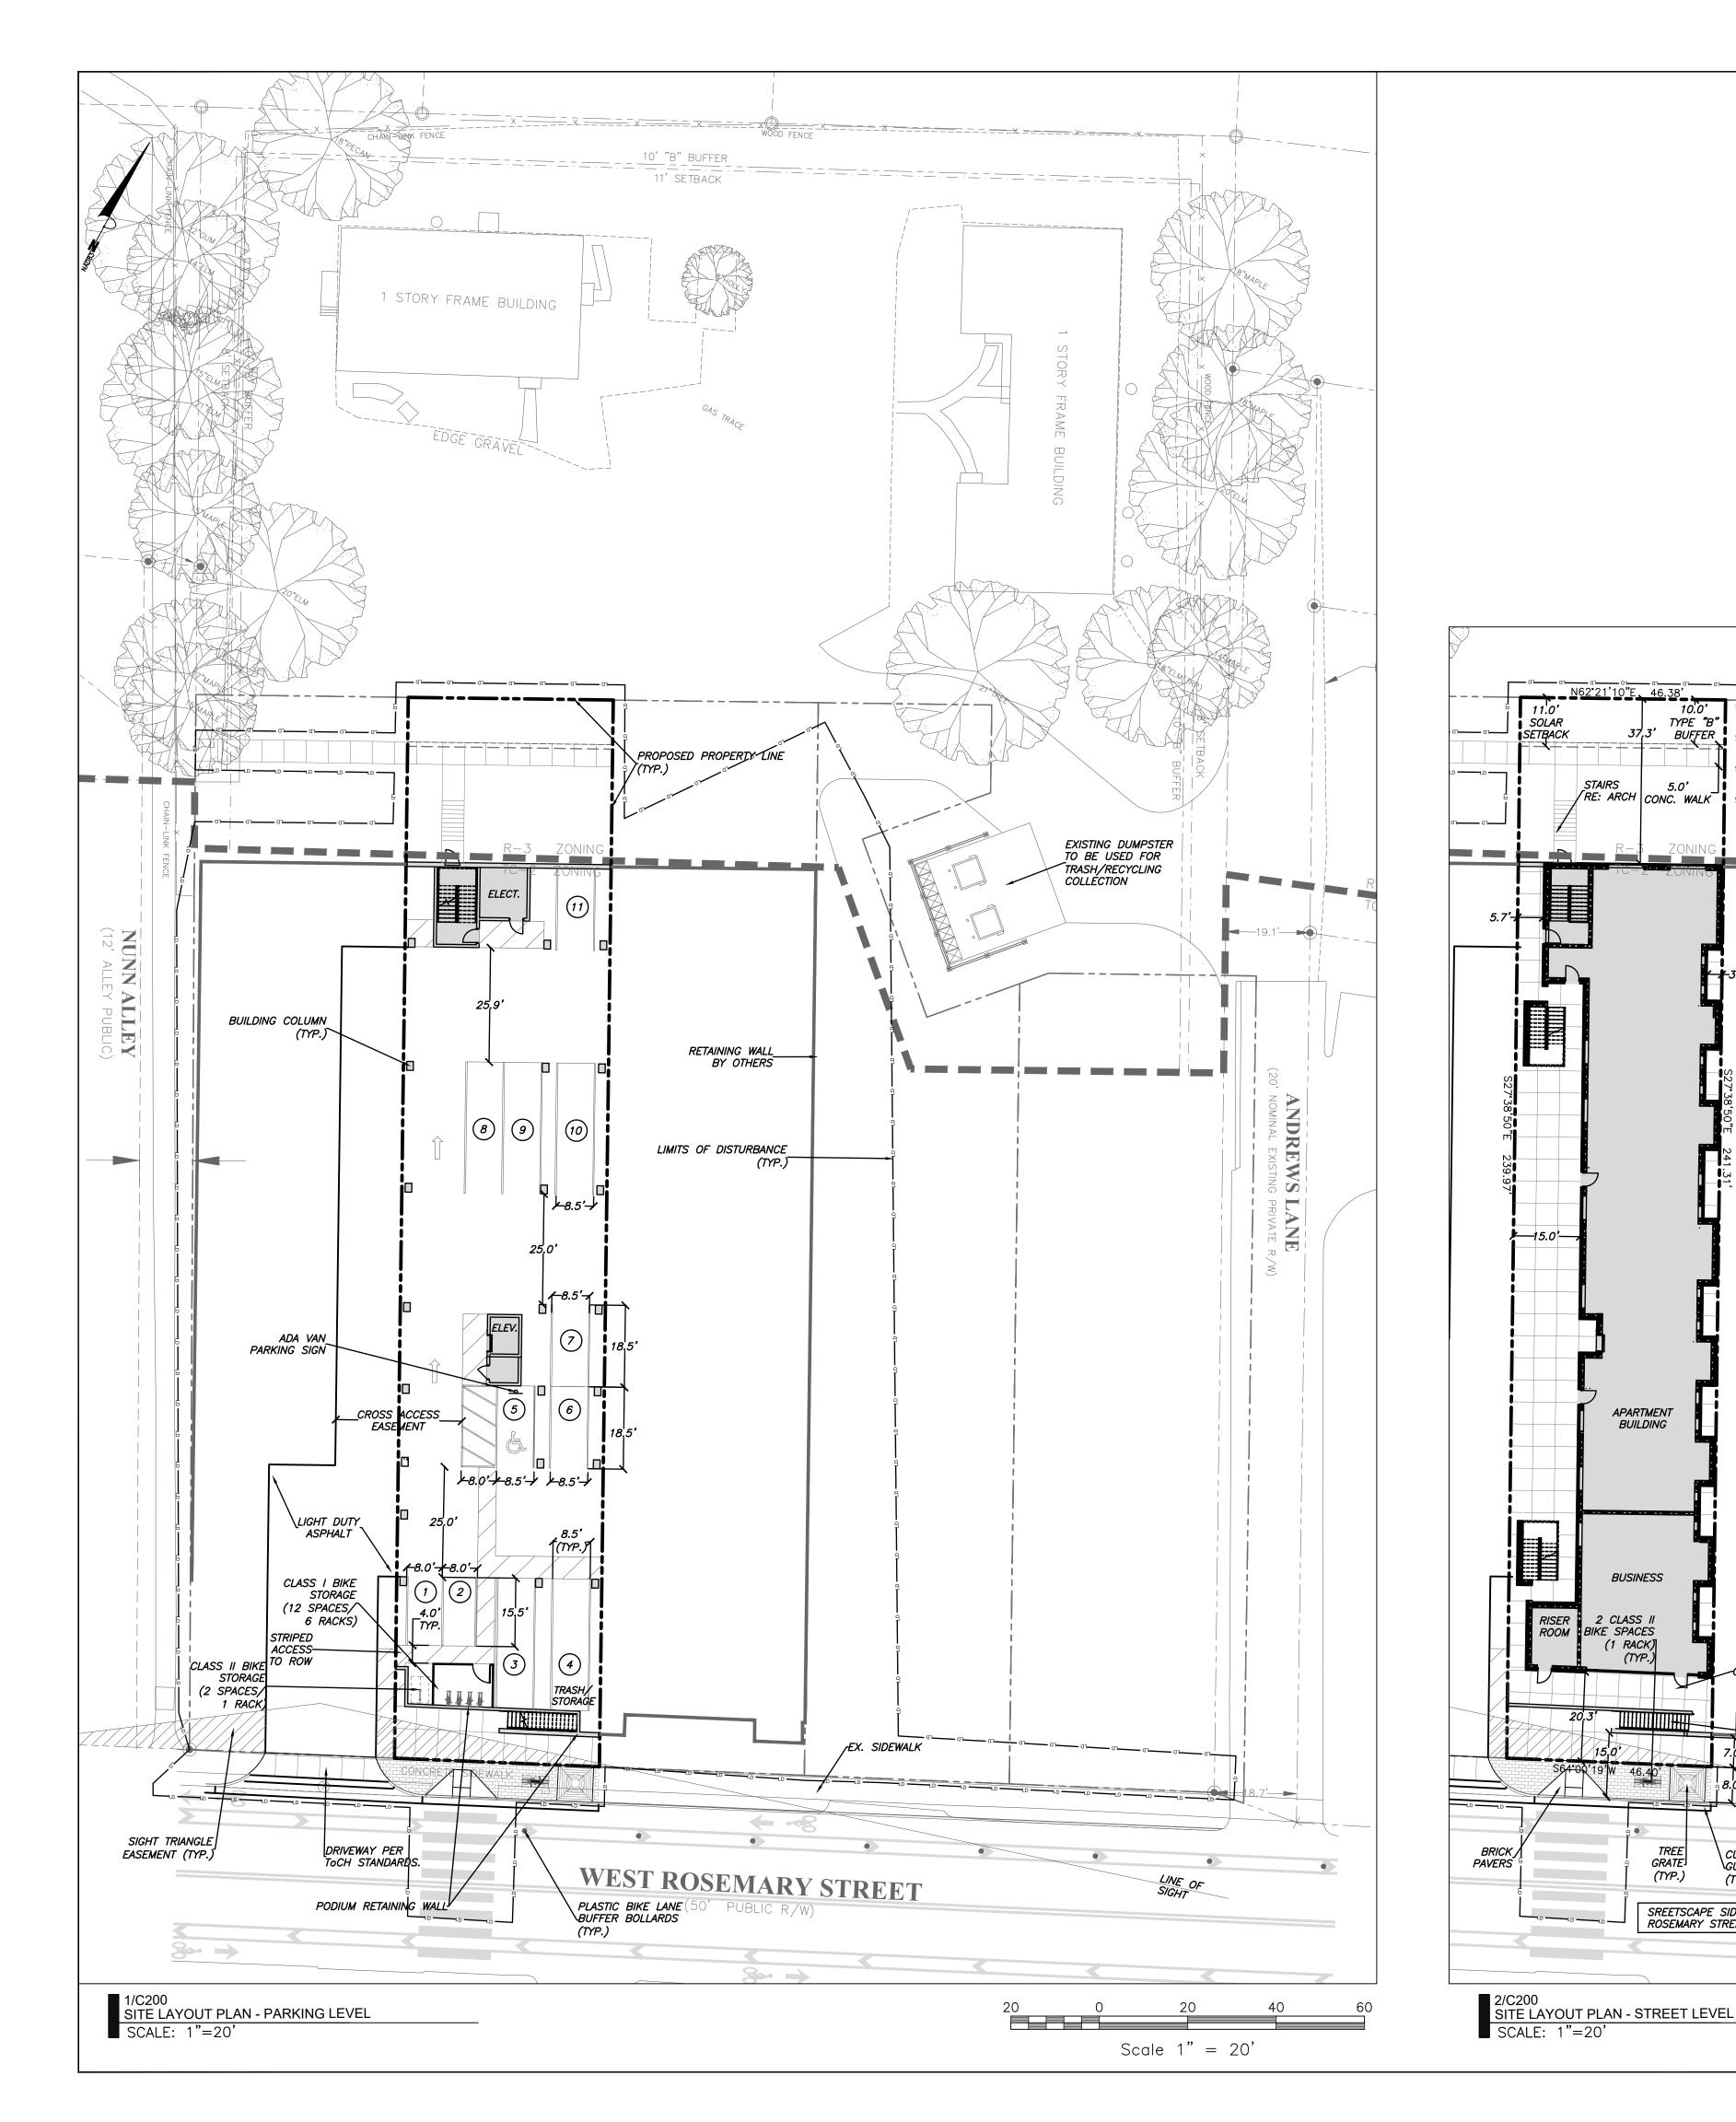

### site plan notes

- 1. ALL ANGLES ARE 90 DEGREES UNLESS OTHERWISE NOTED. 2. DIMENSIONS TO BUILDING WALL ARE TO FACE OF WALL AT FINISH GRADE. DIMENSIONS TO CURB ARE TO FACE OF CURB.
- 3. LAY OUT IMPROVEMENTS FOR THE CIVIL ENGINEER'S OR LANDSCAPE ARCHITECT'S REVIEW PRIOR TO BEGINNING CONSTRUCTION.
- 4. REFERENCE ARCHITECTURAL DRAWINGS FOR BUILDING LAYOUT INFORMATION. ADA PARKING SPACES SHALL BE SIGNED WITH TYPE R7-8 OR R7-8A RESERVED PARKING SIGN AND R7-8D MAXIMUM FINE SIGN PER GS 20-37.6 OF THE NORTH CAROLINA HANDICAP CODE. ADA RAMPS SHALL HAVE RAMP SURFACES COVERED
- WITH DETECTABLE WARNING PATTERN PER ADA STANDARDS. 6. REFERENCE EXISTING CONDITION / DEMOLITION PLAN SHEETS C100 FOR EXTENT OF DEMOLITION AND REMOVAL OF CURB AND GUTTER, DRIVEWAYS, PAVEMENT, BOLLARDS, WALKWAYS, UTILITIES, AND VEGETATION.
- 7. BY ORANGE COUNTY ORDINANCE, CLEAN WOOD WASTE, SCRAP METAL AND CORRUGATED CARDBOARD, ALL PRESENT IN CONSTRUCTION WASTE, MUST BE RECYCLED.
- 8. BY ORANGE COUNTY ORDINANCE, ALL HAULERS OF CONSTRUCTION WASTE MUST BE PROPERLY LICENSED.
- 9. PRIOR TO ANY DEMOLITION OR CONSTRUCTION ACTIVITY ON THE SITE THE APPLICANT WILL HOLD A PRE-DEMOLITION/PRE-CONSTRUCTION CONFERENCE WITH THE COUNTY'S SOLID WASTE STAFF. THIS MAY BE THE SAME MEETING HELD WITH OTHER DEVELOPMENT OFFICIALS.
- 10. THE PRESENCE OF ANY ASBESTOS CONTAINING MATERIAL ('ACM') OR OTHER HAZARDOUS MATERIALS IN CONSTRUCTION AND DEMOLITION WASTE SHALL BE HANDLED IN ACCORDANCE WITH ANY AND ALL LOCAL, STATE, AND FEDERAL REGULATIONS AND GUIDELINES. 11. MASONRY WALLS WILL NOT BE REPAIRED BY THE TOWN RESULTING FROM MAINTENANCE ON
- TOWN OF CHAPEL HILL AND OWASA MAINTAINED UTILITIES. 12. TRASH AND RECYCLING WILL BE HANDLED VIA PRIVATE COLLECTION IN A SHARED OFFSITE
- 13. PUBLIC RECYCLING WAIVER:
- APPLICANT ELECTS TO PROVIDE RECYCLING SERVICES TO RESIDENTS/TENANTS OF THIS PROPERTY IN LIEU OF BUILDING A RECYCLING STATION CONSTRUCTED TO ORANGE COUNTY SPECIFICATIONS. THE SITE WILL NOT RECEIVE PUBLIC RECYCLING COLLECTION NOW OR IN THE FUTURE UNLESS SUCH A RECYCLING STATION IS CONSTRUCTED OR CONTINGENCY FOR SUCH A STATION IS INCLUDED ON THE DEVELOPMENT PLANS.
- APPLICANT MUST REQUIRE AT LEAST THE SAME LEVEL OF SERVICE (CURRENT OR FUTURE)
- TO ITS RESIDENTS AS THAT PROVIDED BY ORANGE COUNTY. COUNTY FEES FOR RECYCLING AND WASTE MANAGEMENT ASSOCIATED WITH THIS
- PROJECT/PROPERTY WILL NOT BE WAIVED. APPLICANT AGREES TO ENTER INTO A SERVICE AGREEMENT WITH A PRIVATE SOLID WASTE/RECYCLING COLLECTION CONTRACTOR THAT IS ACCEPTABLE TO ORANGE COUNTY. FURTHER, THE AGREEMENT SHALL PROVIDE FOR THE COLLECTION AND RECYCLING OF CORRUGATED CARDBOARD IN ADDITION TO THE OTHER CO- MINGLED RECYCLABLES AND AN EXECUTED COPY OF THE AGREEMENT SHALL BE PROVIDED TO AND APPROVED BY ORANGE COUNTY PRIOR TO APPROVAL OF FINAL CONSTRUCTION PLANS FOR THE PROPERTY/PROJECT.

#### site accessibility notes

MUT-CD AND ICC A 117.1.

TYPE "B"

" BUFFER

RE: ARCH CONC. WALK

**APARTMENT** 

BUILDING

BUSINESS

CONC. WALK

STAIRS RE: ARCH

*CURB AND* →

 $\GUTTER$ 

(TYP.)

SREETSCAPE SIDEWALK PER

ROSEMARY STREETSCAPE PLAN.

*GRATE* J

(TYP.)

2 CLASS II BIKE SPACES (1 RACK)

- 1. ALL PUBLIC SITE ELEMENTS MUST COMPLY WITH NCBC 2018 CH 11 AND ICC A 117.1. 2. ACCESSIBLE PARKING PER NCBC SECT 1106.1; 1 PER 6 COMPLIANT SPACES MUST BE VAN ACCESSIBLE, NO SLOPE EXCEEDING 2% IN ANY DIRECTION. SIGNAGE PER NC REQUIREMENTS AND ICC A 117.1.
- 3. CROSS SLOPE ON ACCESSIBLE ROUTES CANNOT EXCEED 2%. SLOPE IN EXCESS OF 5% CONSTITUTES A RAMP, REQUIRING HAND RAILS, GUARDS AND EDGE PROTECTION PER CODE. CROSS SLOPE ON ACCESSIBLE PARKING AND LOADING AREAS NOT TO EXCEED 2%, CALL FOR INSPECTION BEFORE PLACEMENT OF ANY CONCRETE. ALL PUBLIC ACCESS SITE FEATURES MUST MEET ICC/ANSI A117.1.
- 4. ACCESSIBILITY REQUIREMENTS: THAT PRIOR TO ISSUANCE OF A CERTIFICATE OF OCCUPANCY, THE APPLICANT SHALL PROVIDE THE MINIMUM REQUIRED HANDICAPPED PARKING SPACES AND DESIGN ALL HANDICAPPED PARKING SPACES, RAMPS, AND CROSSWALKS, AND ASSOCIATED INFRASTRUCTURE ACCORDING TO AMERICANS WITH DISABILITIES ACT STANDARDS, NORTH CAROLINA BUILDING CODE, AMERICAN NATIONAL STANDARDS INSTITUTE (ANSI) CODE, AND TOWN STANDARD.
  - PARKING NUMBER OF SPACES TO COMPLY WITH NCBC 2018 SECTION 1106.1, 1 PER 6 COMPLIANT SPACES OR PORTION THEREOF MUST BE VAN ACCESSIBLE, NO SLOPE TO EXCEED 2% IN ANY DIRECTION. SIGNAGE PER NC REQUIREMENTS,
  - CURB CUTS AND ACCESSIBLE ROUTES PER ICC A117.1 2009 ED. CROSS SLOPE LIMITED TO 2%, CALL FOR INSPECTION BEFORE PLACEMENT OF CONCRETE. • SLOPE GREATER THAN 5% REQUIRES CONSTRUCTION AS A RAMP.

#### fire notes

- ALL PUBLIC SITE ELEMENTS MUST COMPLY WITH NCBC 2018 CH 11 AND ICC A 117.1. ACCESSIBLE PARKING PER NCBC SECT 1106.1; 1 PER 6 COMPLIANT SPACES MUST BE VAN ACCESSIBLE, NO SLOPE EXCEEDING 2% IN ANY DIRECTION. SIGNAGE PER NC REQUIREMENTS AND ICC A 117.1.
- CROSS SLOPE ON ACCESSIBLE ROUTES CANNOT EXCEED 2%. SLOPE IN EXCESS OF 5% CONSTITUTES A RAMP, REQUIRING HAND RAILS, GUARDS AND EDGE PROTECTION PER CODE. CROSS SLOPE ON ACCESSIBLE PARKING AND LOADING AREAS NOT TO EXCEED 2%, CALL FOR INSPECTION BEFORE PLACEMENT OF ANY CONCRETE. ALL PUBLIC ACCESS SITE FEATURES MUST MEET ICC/ANSI A117.1.
- 4. ACCESSIBILITY REQUIREMENTS: THAT PRIOR TO ISSUANCE OF A CERTIFICATE OF OCCUPANCY, THE APPLICANT SHALL PROVIDE THE MINIMUM REQUIRED HANDICAPPED PARKING SPACES AND DESIGN ALL HANDICAPPED PARKING SPACES, RAMPS, AND CROSSWALKS, AND ASSOCIATED INFRASTRUCTURE ACCORDING TO AMERICANS WITH DISABILITIES ACT STANDARDS, NORTH CAROLINA BUILDING CODE, AMERICAN NATIONAL

STANDARDS INSTITUTE (ANSI) CODE, AND TOWN STANDARD.

- PARKING NUMBER OF SPACES TO COMPLY WITH NCBC 2018 SECTION 1106.1, PER 6 COMPLIANT SPACES OR PORTION THEREOF MUST BE VAN ACCESSIBLE, NO SLOPE TO EXCEED 2% IN ANY DIRECTION. SIGNAGE PER NC REQUIREMENTS, MUT-CD AND ICC A 117.1.
- CURB CUTS AND ACCESSIBLE ROUTES PER ICC A117.1 2009 ED. CROSS SLOPE LIMITED TO 2%, CALL FOR INSPECTION BEFORE PLACEMENT OF CONCRETE. • SLOPE GREATER THAN 5% REQUIRES CONSTRUCTION AS A RAMP.

111 West Main Street Durham, N.C. 27701 p 919.682.0368 f 919.688.5646 www.cjtpa.com

Project:

322 ROSEMARY MIXED-USE

322 W ROSEMARY ST. CHAPEL HILL, NC 27516

ORANGE COUNTY NORTH CAROLINA

PIN: 9788178053



04.24.2020

PRELIMINARY NOT FOR CONSTRUCTION

Job Number: 1663

Checked JSA Date 03.17.2017

Revisions 02.19.2020 COMMENTS 04.24..2020 COMMENTS

SITE PLAN

Sheet Title:

LAYOUT **PLAN** 

Sheet Number

LEGEND

Water Valve Sewer Cleanout Curb Inlet/Catch Basin Flared End Section Gas Valve  $\square$  TSB Traffic Signal Box Existing Iron Pipe (3/4" unless noted) Electric Transformer 1/2" Iron Pipe Set E Electric Junction Box Existing PK Nail Gas Meter PK Nail Set Sanitary Sewer Manhole Computed Point Storm Sewer Manhole Concrete Monument Telephone Manhole Tree Line Electric Manhole Underground Electric — uE—— uE—— uE—— uE— 

Telephone Pedestal Fire Hydrant Post Indicator Valve Water Meter

Hot Box

Utility Pole


\_\_\_\_\_ GAS \_\_\_\_\_ GAS \_\_\_\_\_ Water Line \_\_\_\_w\_\_\_w\_\_\_w\_\_\_\_w\_\_\_ Overhead Utilities Storm Sewer Sanitary Sewer Building Wall

\_\_\_\_\_ OU\_\_\_\_\_ OU\_\_\_\_\_ OU\_\_\_\_\_ \_\_\_\_\_ ss\_\_\_\_\_ ss\_\_\_\_\_ ss\_\_\_\_ <del>-0-0-0-0-0--</del>

0C0

O IPS

⊗ GV

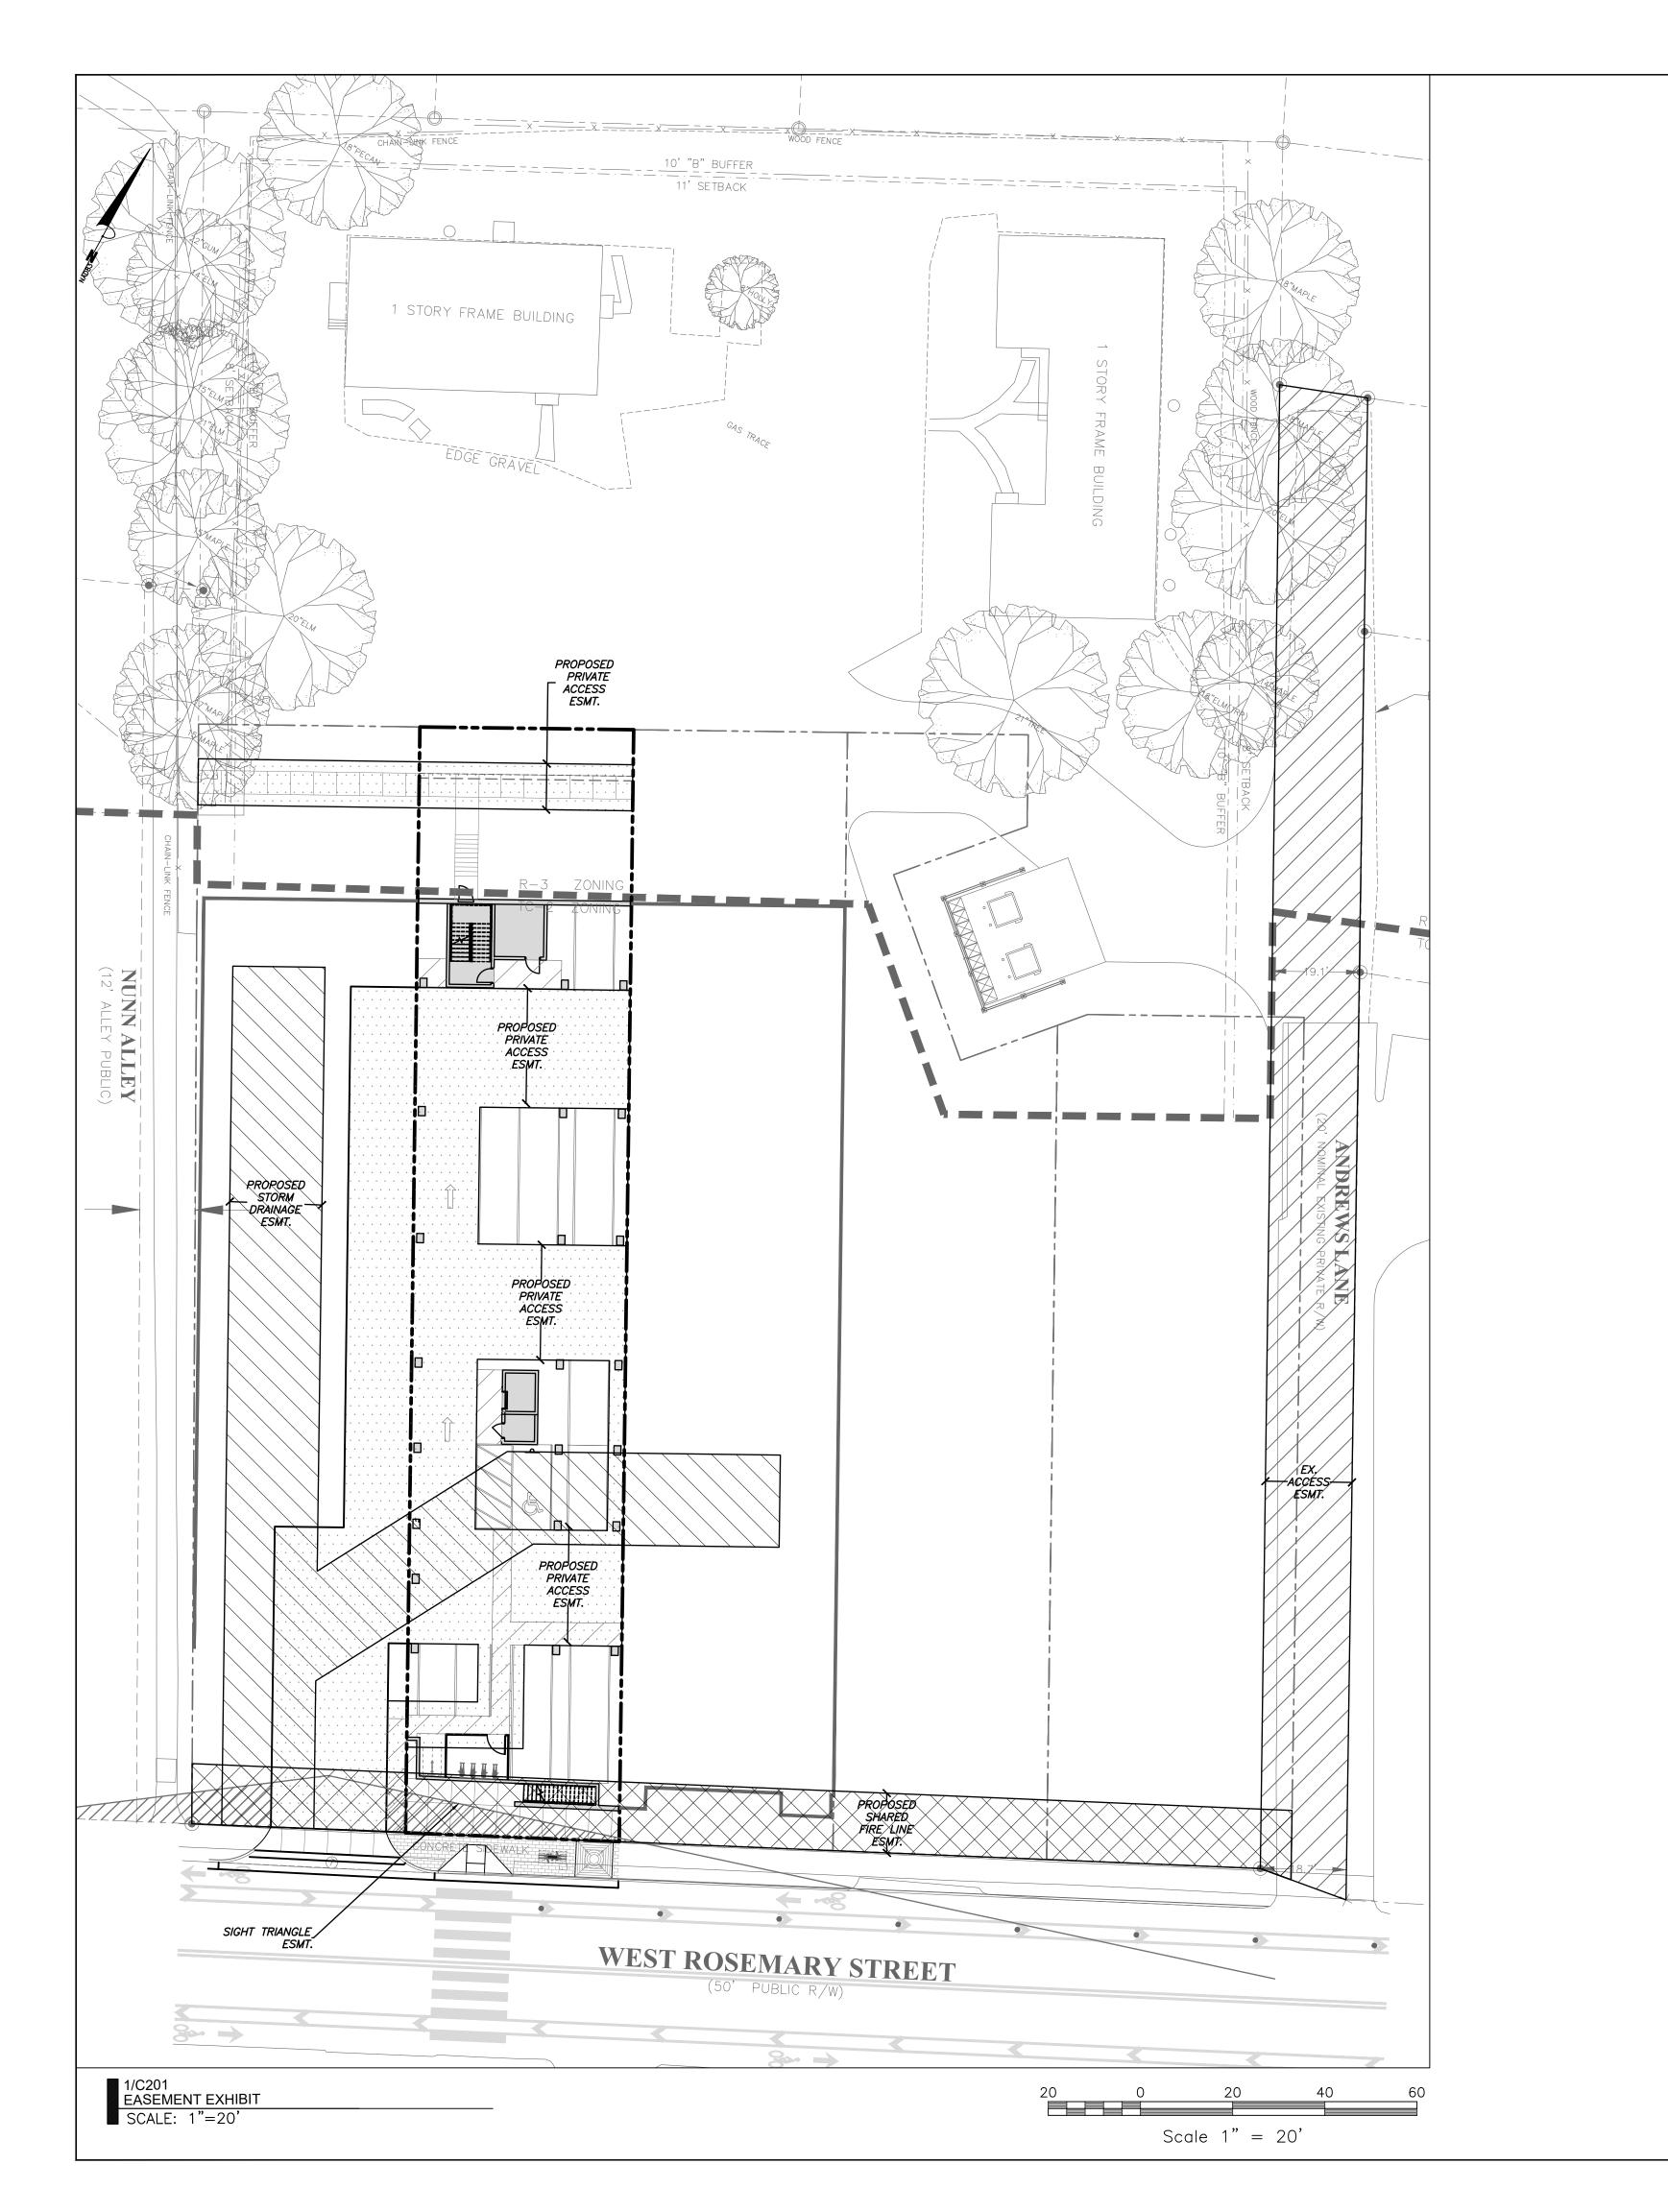



b Durham, N.C. 27701
p 919.682.0368
f 919.688.5646 www.cjtpa.com

111 West Main Street


Project:

322 ROSEMARY MIXED-USE

322 W ROSEMARY ST. CHAPEL HILL, NC 27516

ORANGE COUNTY NORTH CAROLINA

PIN: 9788178053

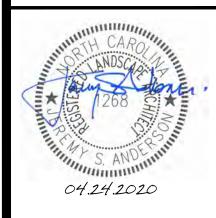

PRELIMINARY NOT FOR CONSTRUCTION

Job Number: 1663

 Drawn
 JSA, ED

 Checked
 JSA

 Date
 03.17.2017

 Revisions
 02.19.2020 COMMENTS

 04.24..2020 COMMENTS

LEGEND

Water Valve

Gas Meter

Curb Inlet/Catch Basin

Traffic Signal Box

Electric Transformer

Electric Junction Box

Sanitary Sewer Manhole

Storm Sewer Manhole

Telephone Manhole

Telephone Pedestal

Post Indicator Valve

Fire Hydrant

Water Manhole

Water Meter

Utility Pole

Hot Box

Electric Manhole

Light Pole

Gas Valve

Sewer Cleanout

Flared End Section

1/2" Iron Pipe Set

Existing PK Nail

Computed Point

Concrete Monument

PK Nail Set

Tree Line

Water Line

Overhead Utilities

Storm Sewer

Sanitary Sewer

Building Wall

Fence

Existing Iron Pipe (3/4" unless noted)

Underground Electric — ue—— ue—— ue—— ue—

000

⊗ GV

O IPS

PK

PKS

\_\_\_\_\_ GAS \_\_\_\_\_ GAS \_\_\_\_\_

\_\_\_\_\_w\_\_\_w\_\_\_\_w\_\_\_\_\_w\_\_\_

\_\_\_\_ ou\_\_\_\_ ou\_\_\_\_ ou\_\_\_\_

\_\_\_\_s \_\_\_\_s \_\_\_\_s \_\_\_\_

----- ss------- ss------- ss------

\_\_\_\_\_

TSB
TSB
G


HB

SITE PLAN

Sheet Title:

**EASEMENT EXHIBIT** 

Sheet Number C201

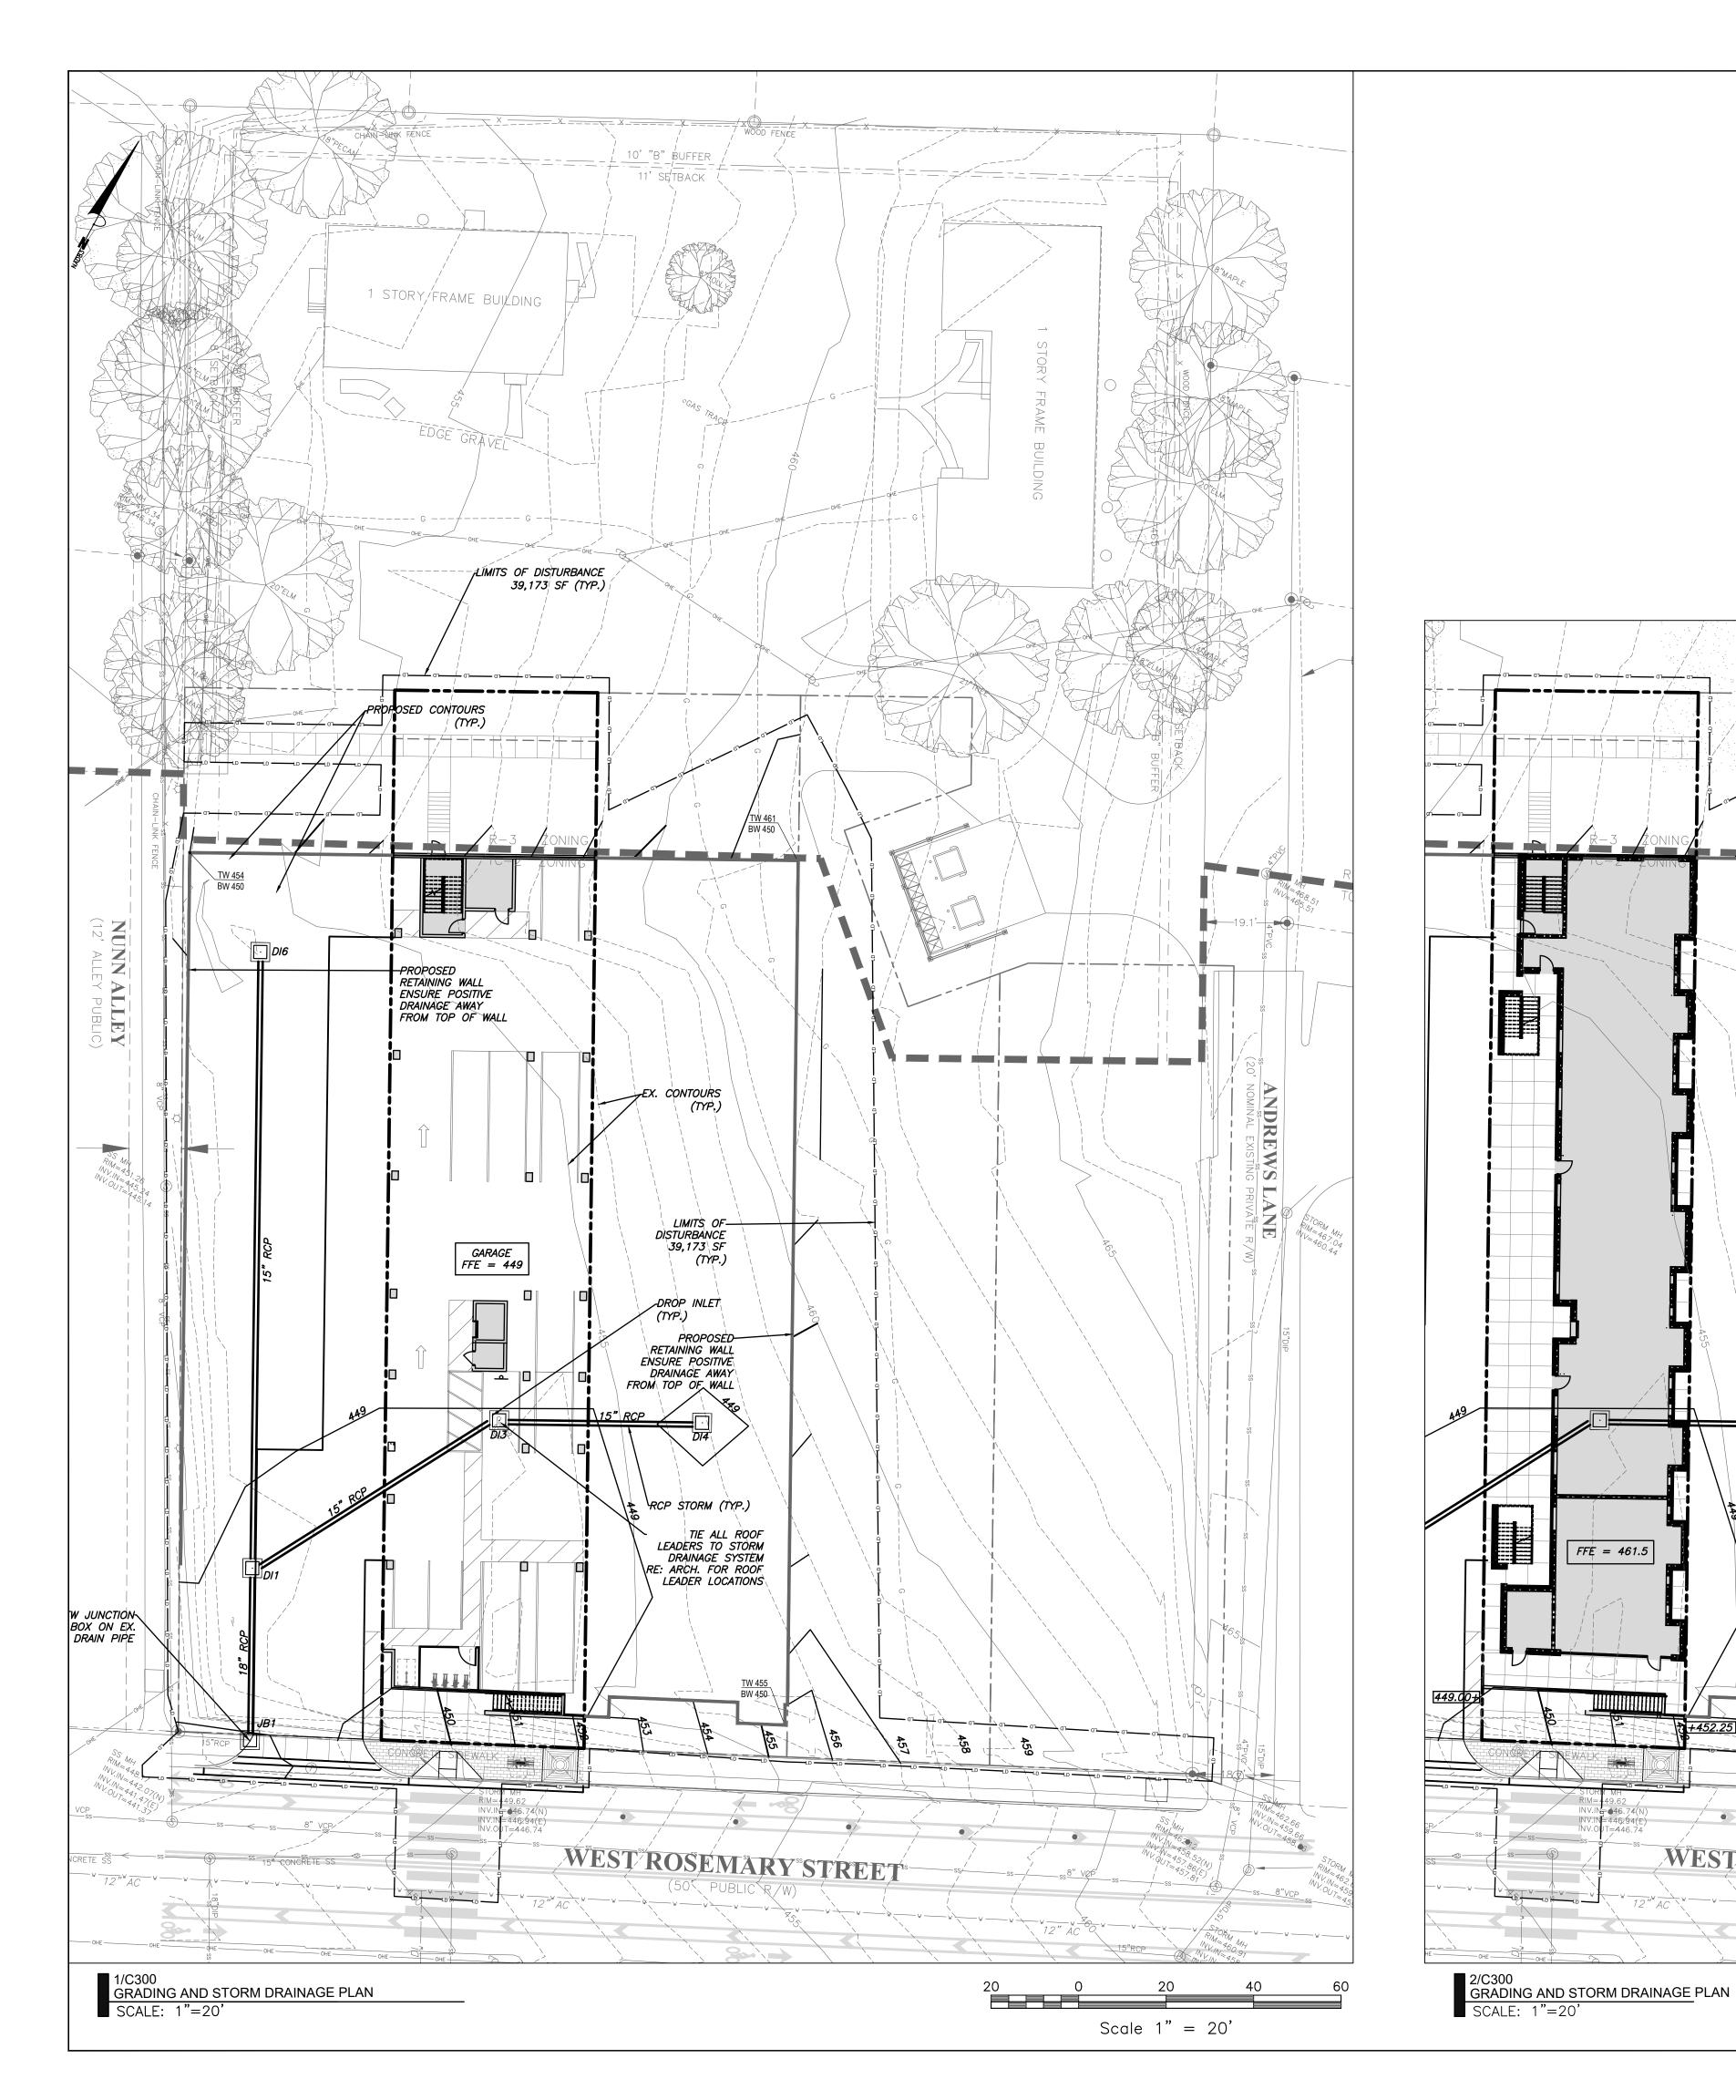

## grading and storm drainage notes

#### **GRADING NOTES:**

- 1. ALL DIMENSIONS AND GRADES SHOWN ON THE PLANS SHALL BE FIELD VERIFIED BY THE CONTRACTOR PRIOR TO CONSTRUCTION. CONTRACTOR SHALL NOTIFY THE OWNER IF ANY DISCREPANCIES EXIST PRIOR TO PROCEEDING WITH CONSTRUCTION FOR NECESSARY PLAN OR GRADE CHANGES. NO EXTRA COMPENSATION SHALL BE PAID TO THE CONTRACTOR FOR ANY WORK DONE DUE TO DIMENSIONS OR GRADES SHOWN INCORRECTLY ON THESE PLANS IF SUCH NOTIFICATION HAS NOT BEEN GIVEN.
- 2. ALL CONSTRUCTION SHALL BE IN ACCORDANCE WITH TOWN OF CHAPEL HILL STANDARDS AND
- 3. CONTRACTOR SHALL NOTIFY "NORTH CAROLINA ONE CALL" (1-800-632-4949) AT LEAST 48 HOURS PRIOR TO BEGINNING CONSTRUCTION OR EXCAVATION TO HAVE EXISTING UTILITIES LOCATED. CONTRACTOR TO CONTACT ANY LOCAL UTILITIES THAT PROVIDE THEIR OWN LOCATOR SERVICES INDEPENDENT OF "NORTH
- 4. CONSTRUCTION, MAINTENANCE AND REMOVAL OF ALL EROSION CONTROL DEVICES ARE THE RESPONSIBILITY OF THE GENERAL CONTRACTOR. 5. EXISTING UTILITIES AND STRUCTURES SHOWN, BOTH UNDERGROUND AND ABOVE GROUND, ARE BASED ON A
- FIELD SURVEY AND THE BEST AVAILABLE RECORD DRAWINGS. THE CONTRACTOR SHALL VERIFY FIELD CONDITIONS PRIOR TO BEGINNING RELATED CONSTRUCTION. ANY DISCREPANCIES SHALL BE REPORTED TO THE OWNER'S REPRESENTATIVE IMMEDIATELY.
- 6. SOIL UNDER BUILDING PAD, PAVED AREAS AND WITHIN SLOPES GREATER THAN 3:1 (H:V) SHALL BE APPROVED, PLACED AND COMPACTED AS RECOMMENDED BY THE GEOTECHNICAL ENGINEER. THESE SOILS SHALL BE COMPACTED AS SPECIFIED UNLESS OTHERWISE RECOMMENDED BY THE GEOTECHNICAL ENGINEER. ANY UNDERCUT OF SOILS IN THESE AREAS SHALL BE APPROVED BY THE GEOTECHNICAL ENGINEER & OWNER. THE UNDERCUT SOILS SHALL ALSO QUANTIFIED BY THE GEOTECHNICAL ENGINEER.
- 7. ALL GRADING MUST PRODUCE SURFACE DRAINAGE ADEQUATE TO PREVENT STANDING WATER OR WET LAWN AREAS, AND TO ENSURE THAT ALL STORM WATER FLOWS TO INLETS OR OTHER POINTS OF DISCHARGE.
- 8. ALL SIDEWALKS SHALL BE CONSTRUCTED WITH A MAXIMUM 1.8% CROSS SLOPE IN THE DIRECTION SHOWN
- 9. CONNECT ALL ROOF LEADERS AND DOWNSPOUTS TO STORM DRAINAGE SYSTEM WITH PVC PIPE. SEE
- 10. CURB INLETS: PROVIDE PRE-CAST CURB INLET HOODS AND COVERS STATING, "DUMP NO WASTE! DRAINS TO JORDAN LAKE", IN ACCORDANCE WITH THE SPECIFICATIONS OF THE TOWN STANDARD DETAIL SD-5A, FOR ALL NEW CURB INLETS FOR PRIVATE, TOWN AND STATE RIGHTS-OF-WAY.

#### STORM DRAINAGE NOTES:

FFE = 461.5

WEST ROSEM

- 1. ALL STORM DRAINAGE PIPES SHOWN ARE TO BE CLASS III REINFORCED CONCRETE (RCP) UNLESS NOTED
- 2. ALL STORM DRAINAGE CONSTRUCTION SHALL BE IN ACCORDANCE WITH THE TOWN OF CHAPEL HILL
- 3. ALL CONCRETE SHALL MEET A MINIMUM 3000 PSI COMPRESSIVE STRENGTH.
- 4. ALL PIPE IN STORM DRAIN STRUCTURES SHALL BE STRUCK EVEN WITH INSIDE WALL.
- 5. ALL PIPE JOINTS SHALL BE MADE WITH PREFORMED JOINT SEALER, WHICH CONFORMS TO AASHTO SPECIFICATION M-198 FOR TYPE B FLEXIBLE PLASTIC GASKETS UNLESS OTHERWISE NOTED.
- 6. THE INTERIOR SURFACES OF ALL STORM DRAINAGE STRUCTURES SHALL BE POINTED AND SMOOTHED TO AN ACCEPTABLE STANDARD USING MORTAR MIXED TO MANUFACTURER'S SPECIFICATIONS.
- 7. ALL BACKFILL SHALL BE NON-PLASTIC IN NATURE, FREE FROM ROOTS, VEGETATION MATTER, WASTE CONSTRUCTION MATERIAL OR OTHER OBJECTIONABLE MATERIAL. SAID MATERIAL SHALL BE CAPABLE OF BEING COMPACTED BY MECHANICAL MEANS AND SHALL HAVE NO TENDENCY TO FLOW OR BEHAVE IN A PLASTIC MANNER UNDER THE TAMPING BLOWS OR PROOF ROLLING.
- 8. MATERIALS DEEMED BY THE OWNER'S REPRESENTATIVE AS UNSUITABLE FOR BACKFILL PURPOSES SHALL BE REMOVED AND REPLACED WITH SUITABLE MATERIAL.
- 9. BACKFILLING OF TRENCHES SHALL BE ACCOMPLISHED IMMEDIATELY AFTER PIPE IS LAID. THE FILL AROUND THE PIPE SHALL BE THOROUGHLY COMPACTED TO 95% OF THE MAXIMUM DRY DENSITY OBTAINABLE WITH THE STANDARD PROCTOR TEST. THE TOP EIGHT (8) INCHES SHALL BE COMPACTED TO 100% STANDARD
- 10. UNDER NO CIRCUMSTANCES SHALL WATER BE ALLOWED TO RISE IN UNBACKFILLED TRENCHES AFTER PIPE
- 11. CONNECT ALL ROOF LEADERS AND DOWNSPOUTS TO STORM DRAINAGE SYSTEM WITH PVC PIPE. SEE ARCHITECTURAL PLANS FOR LOCATIONS.

#### erosion control notes

#### EROSION CONTROL NOTES:

- 1. EROSION CONTROL BOND: IF ONE (1) ACRE OR MORE IS UNCOVERED BY LAND-DISTURBING ACTIVITIES FOR THIS PROJECT, THEN A PERFORMANCE GUARANTEE IN ACCORDANCE WITH SECTION 5-97.1 BONDS OF THE TOWN CODE OF ORDINANCES SHALL BE REQUIRED PRIOR TO FINAL AUTHORIZATION TO BEGIN LAND-DISTURBING ACTIVITIES. THIS FINANCIAL GUARANTEE IS INTENDED TO COVER THE COSTS OF RESTORATION OF FAILED OR FAILING SOIL EROSION AND SEDIMENTATION CONTROLS, AND/OR TO REMEDY DAMAGES RESULTING FROM LAND-DISTURBING ACTIVITIES, SHOULD THE RESPONSIBLE PARTY OR PARTIES FAIL TO PROVIDE PROMPT AND EFFECTIVE REMEDIES ACCEPTABLE TO THE TOWN.
- 2. THE APPLICANT SHALL PROVIDE A COPY OF THE APPROVED EROSION AND SEDIMENT CONTROL PERMIT FROM ORANGE COUNTY EROSION CONTROL DIVISION PRIOR TO RECEIVING A ZONING COMPLIANCE PERMIT. DURING THE CONSTRUCTION PHASE, ADDITIONAL EROSION AND SEDIMENT CONTROLS MAY BE REQUIRED IF THE PROPOSED MEASURES DO NOT CONTAIN THE SEDIMENT. SEDIMENT LEAVING THE PROPERTY IS A VIOLATION OF THE TOWN'S EROSION AND SEDIMENT CONTROL ORDINANCE.
- 3. THE CONTRACTOR SHALL TAKE THE APPROPRIATE MEASURES TO PREVENT AND REMOVE THE DEPOSIT OF WET OR DRY SILT ON ADJACENT PAVED ROADWAYS.
- 4. EROSION CONTROL INSPECTIONS: IN ADDITION TO THE REQUIREMENT DURING CONSTRUCTION FOR INSPECTION AFTER EVERY RAINFALL, THE APPLICANT SHALL INSPECT THE EROSION AND SEDIMENT CONTROL DEVICES WEEKLY, MAKE ANY NECESSARY REPAIRS OR ADJUSTMENTS TO THE DEVICES, AND MAINTAIN INSPECTION LOGS DOCUMENTING THE DAILY INSPECTIONS AND ANY NECESSARY REPAIRS.

#### building height - grade calculation

AVERAGE STREET GRADE = 450.625

111 West Main Street **Durham, N.C. 27701** p 919.682.0368 f 919.688.5646 www.cjtpa.com

Project:

324 ROSEMARY MIXED-USE

324 W ROSEMARY ST. CHAPEL HILL, NC 27516

ORANGE COUNTY NORTH CAROLINA



PRELIMINARY NOT FOR CONSTRUCTION

Job Number: 1663 Checked JSA Date 03.17.2017 Revisions 02.19.2020 COMMENTS

04.24..2020 COMMENTS

SITE PLAN Sheet Title:

**GRADING AND** TORM DRAINAGE

**PLAN** 

Sheet Number

LEGEND Water Valve Light Pole OC0 Sewer Cleanout Curb Inlet/Catch Basin Mail Box Flared End Section ⊗ GV Traffic Signal Box Gas Valve Existing Iron Pipe (3/4" unless noted) Electric Transformer 1/2" Iron Pipe Set O IPS Electric Junction Box Existing PK Nail PK Gas Meter PK Nail Set PKS Sanitary Sewer Manhole Computed Point Storm Sewer Manhole Concrete Monument Telephone Manhole Tree Line Electric Manhole \_\_ × \_\_\_ × \_\_\_ × \_\_\_ × \_\_\_ × \_\_ Telephone Pedestal Gas Line \_\_\_\_\_ GAS \_\_\_\_\_ GAS \_\_\_\_\_ Fire Hydrant Water Line \_\_\_\_w\_\_\_w\_\_\_\_w\_\_\_\_ Post Indicator Valve Overhead Utilities \_\_\_\_ ou\_\_\_\_ ou\_\_\_\_ ou\_\_\_\_ Water Manhole Storm Sewer \_\_\_s \_\_\_\_s \_\_\_\_s \_\_\_\_s \_\_\_ Sanitary Sewer \_\_\_\_\_ss\_\_\_\_\_ss\_\_\_\_\_ss\_\_\_\_\_ss\_\_\_ Water Meter

HB


β

Hot Box

Utility Pole

Guard Rail

Building Wall

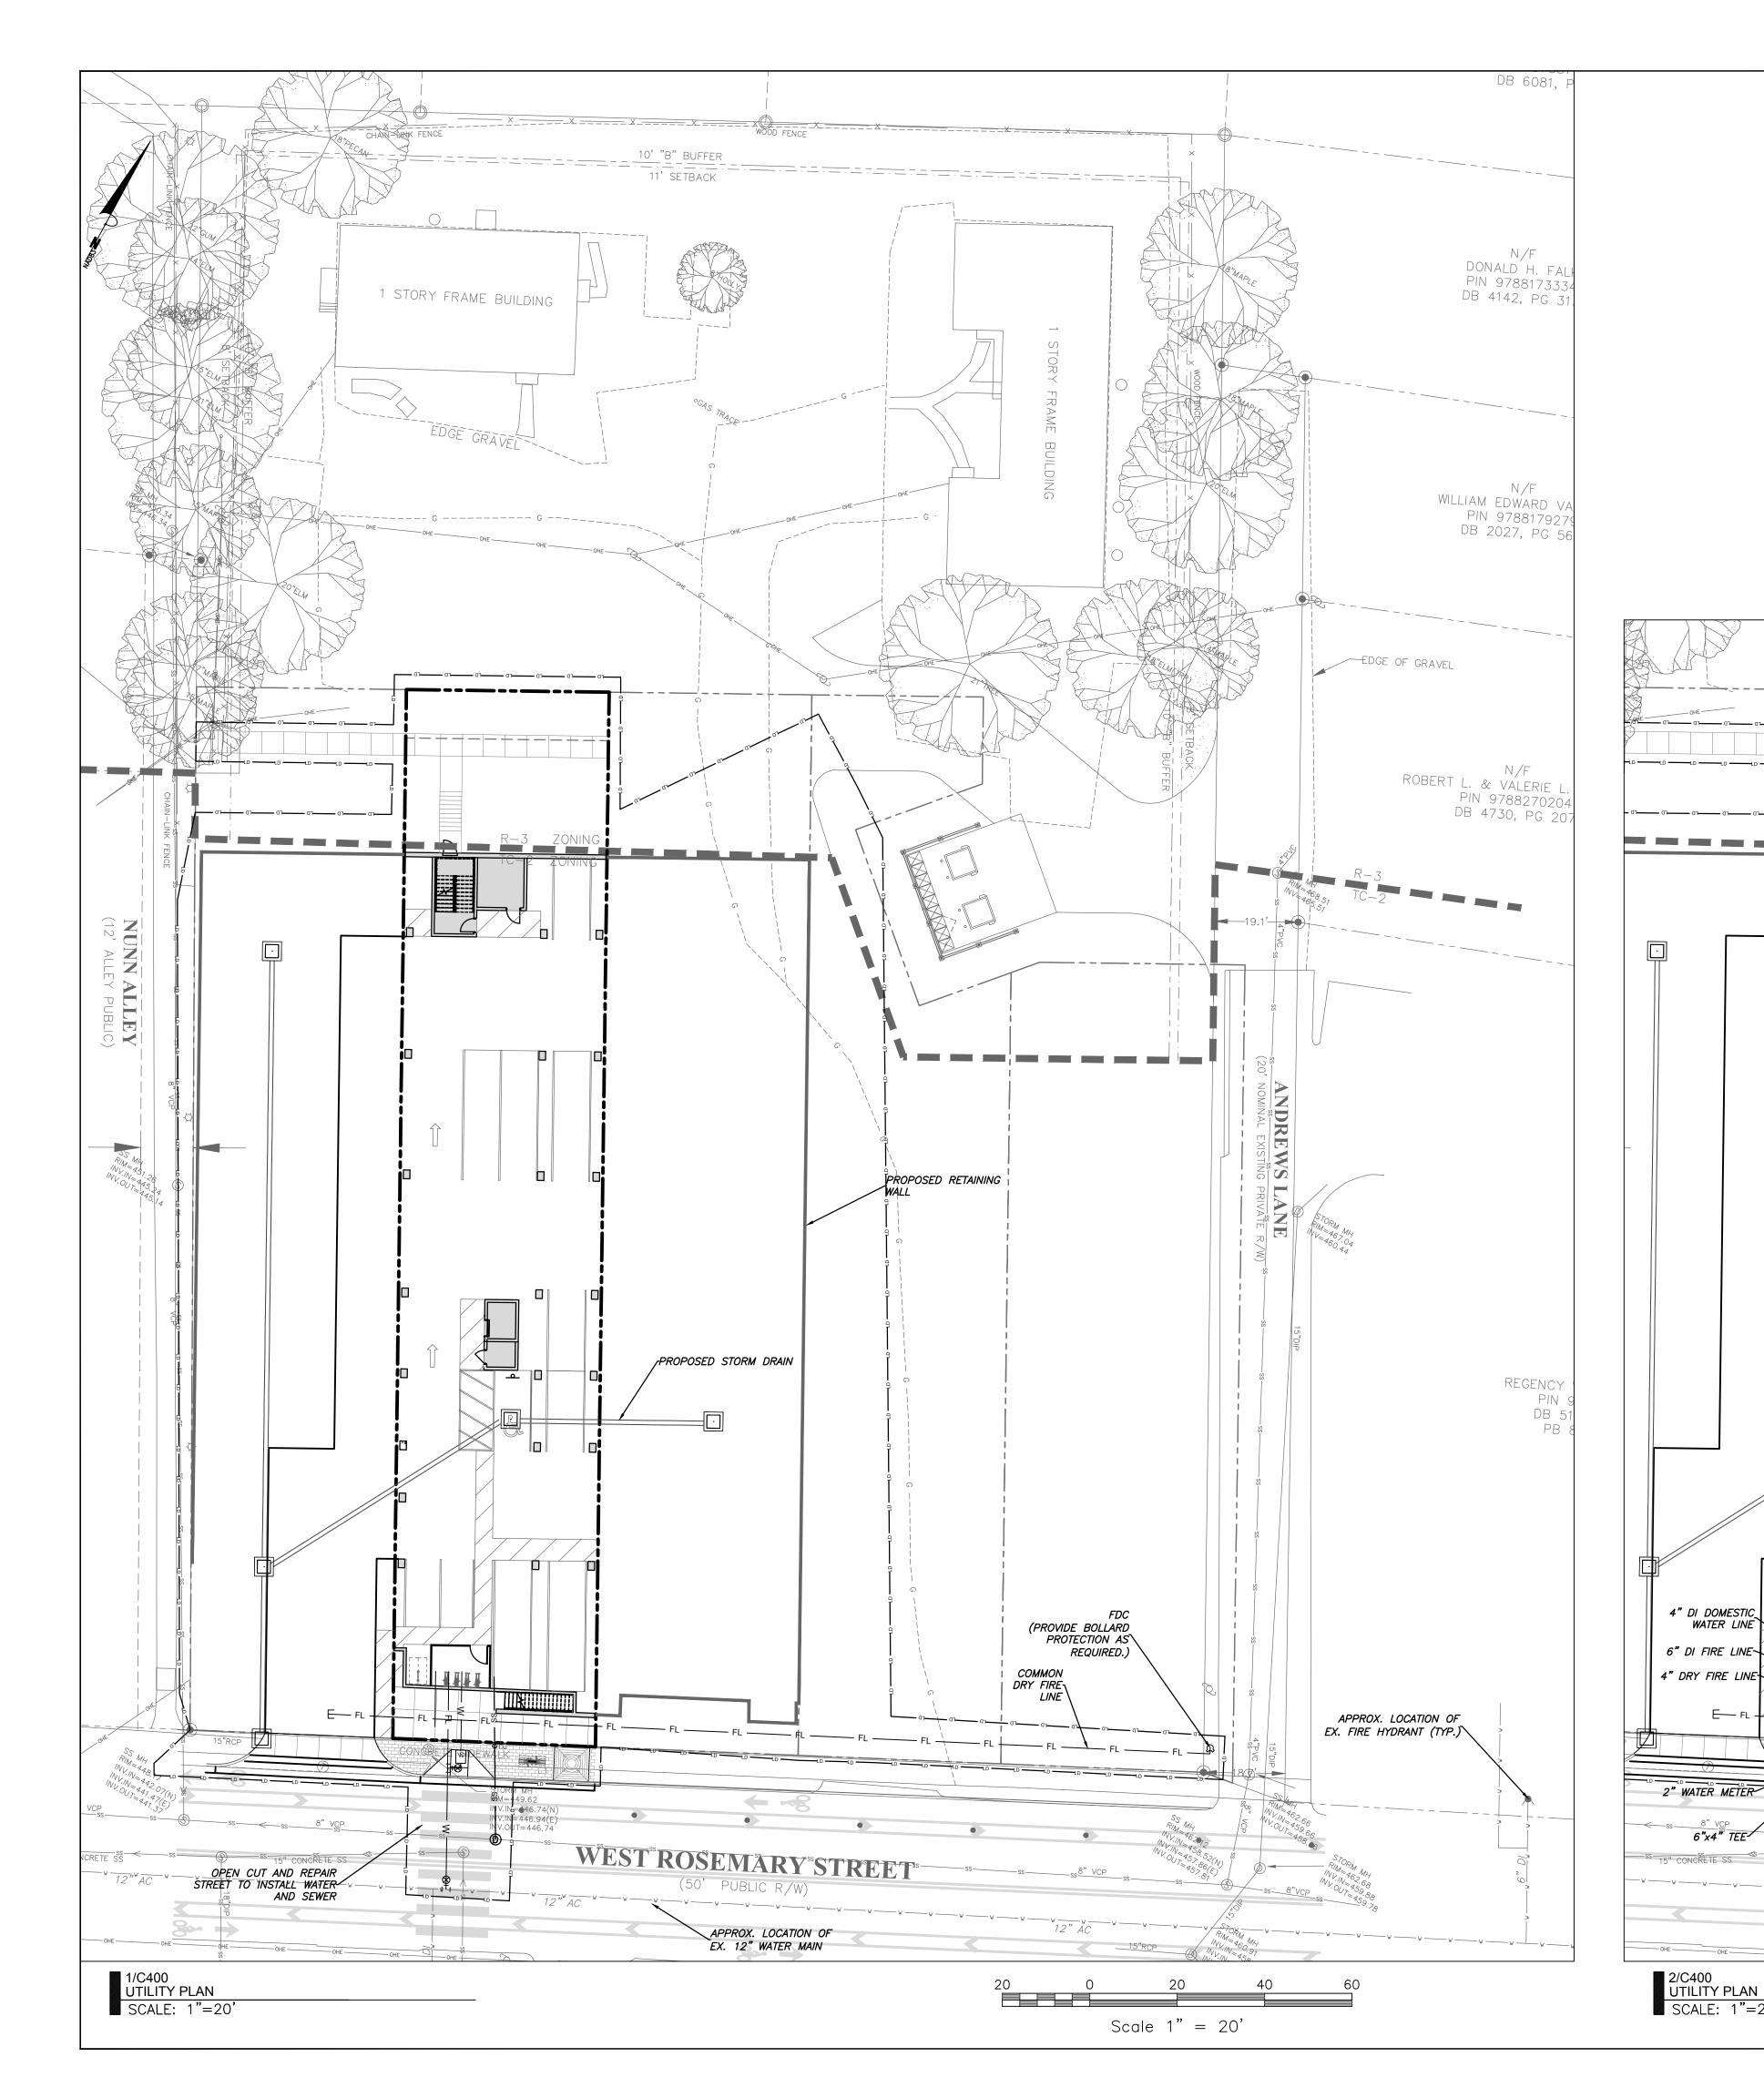

#### utility notes

#### GENERAL NOTES:

- 1. CONTRACTOR SHALL NOTIFY "NORTH CAROLINA ONE CALL" (1-800-632-4949) AT LEAST 48 HOURS PRIOR TO BEGINNING CONSTRUCTION OR EXCAVATION TO HAVE EXISTING UTILITIES LOCATED. CONTRACTOR TO CONTACT ANY LOCAL UTILITIES THAT PROVIDE THEIR OWN LOCATOR SERVICE INDEPENDENT OF "NORTH CAROLINA ONE CALL".
- 2. ALL WATER AND SEWER MAINS WITHIN PUBLIC EASEMENTS AND RIGHT-OF-WAYS TO BE OWNED, OPERATED AND MAINTAINED BY THE TOWN OF CHAPEL HILL.
- 3. ALL CONSTRUCTION SHALL BE IN ACCORDANCE WITH THE TOWN OF CHAPEL HILL STANDARDS AND SPECIFICATIONS.
- 4. ALL EXISTING UNDERGROUND UTILITIES ARE APPROXIMATELY LOCATED. ACTUAL LOCATION AND DEPTH SHALL BE CONFIRMED IN THE FIELD PRIOR TO CONSTRUCTION.
- 5. BEFORE STARTING ANY CONSTRUCTION OF IMPROVEMENTS WITHIN ANY TOWN OR N.C.D.O.T. STREET OR HIGHWAY RIGHT-OF-WAY THE FOLLOWING PROCEDURES SHOULD BE UNDERTAKEN; TOWN RIGHT-OF-WAY: CONTACT LOCAL AUTHORITIES' TRAFFIC ENGINEERING DEPT. FOR INFORMATION ON DETOURS, OPEN CUTTING OF STREETS OR FOR ANY CONSTRUCTION WITHIN RIGHT-OF-WAY. N.C.D.O.T. RIGHT-OF-WAY: CONTACT PROJECT ENGINEERS AND OBTAIN ALL PERMITS AND ENCROACHMENTS (KEEP COPIES ON CONSTRUCTION SITE, ALSO CONTACT N.C.D.O.T. DISTRICT OFFICE 24 HOURS IN ADVANCE BEFORE PLACING CURB AND GUTTER).
- 6. ALL DIMENSIONS AND GRADES SHOWN ON THE PLANS SHALL BE FIELD VERIFIED BY THE CONTRACTOR PRIOR TO CONSTRUCTION. CONTRACTOR SHALL NOTIFY THE OWNER IF ANY DISCREPANCIES EXIST. PRIOR TO PROCEEDING WITH CONSTRUCTION FOR NECESSARY PLAN OR GRADING CHANGES. NO EXTRA COMPENSATION SHALL BE PAID TO THE CONTRACTOR FOR ANY WORK DONE DUE TO DIMENSIONS OR GRADES SHOWN INCORRECTLY ON THESE PLANS IF SUCH NOTIFICATION HAS NOT BEEN GIVEN.
- 7. POWER, TELEPHONE, AND GAS SERVICES TO BUILDINGS SHALL BE UNDERGROUND. ACCESS AND SERVICE ROUTES TO BE COORDINATED WITH THE PUBLIC UTILITIES, CONTRACTOR AND THE
- 8. RESURFACING OF STREET DUE TO UTILITY CUTS SHALL BE REQUIRED AT THE DIRECTION OF ENGINEERING. (MINIMUM 50' TO EITHER SIDE OF UTILITY CUTS).
- 9. IF THERE WILL BE ANY: - FLOOR DRAINS, FROM INTERIOR PARKING AREAS, - DRAINS FROM HYDRAULIC ELEVATOR SHAFTS SHALL CONNECT TO SANITARY SEWER AND INCLUDE OIL WATER SEPARATORS.


#### SANITARY SEWER:

- BACKFLOW PREVENTORS SHALL BE PROVIDED FOR ALL UNITS WITH FINAL FLOOR ELEVATIONS OF BUILDINGS LESS THAN 1'-0" ABOVE UPSTREAM MANHOLE.
- MINIMUM COVER OF 5 FEET IN TRAFFIC AREAS TO BE PROVIDED FOR ALL COLLECTOR LINES 4 INCHES AND LARGER. IF LESS THAN 5 FEET, DUCTILE IRON PIPE SHALL BE REQUIRED.
- MINIMUM SLOPE FOR 4 INCH SANITARY SEWER COLLECTION LINES SHALL BE NO LESS THAN 2.0% WITH CLEANOUTS EVERY 75 LINEAL FEET.
- MINIMUM SLOPE FOR 6 INCH SANITARY SEWER COLLECTION LINES SHALL BE NO LESS THAN 1.0% WITH CLEANOUTS EVERY 75 LINEAL FEET.

#### WATER:

-+-----

- WATERLINES WILL BE 3' OFF CURB AND GUTTER UNLESS SHOWN OTHERWISE.
- 2. LAY WATER MAINS AT LEAST 10 FEET LATERALLY FROM EXISTING OR PROPOSED SANITARY SEWERS. IF LOCAL CONDITIONS OR BARRIERS PREVENT A 10 FOOT SEPARATION, LAY THE WATER MAIN WITH AT LEAST 18" VERTICAL SEPARATION ABOVE THE TOP OF THE SANITARY SEWER PIPE EITHER IN A SEPARATE TRENCH OR IN THE SAME TRENCH ON A BENCH OF
- 3. WHEN A PROPOSED WATER MAIN CROSSES OVER A PROPOSED OR EXISTING SANITARY SEWER, LAY THE WATER MAIN WITH AT LEAST 18" VERTICAL SEPARATION ABOVE THE TOP OF THE SANITARY SEWER. IF LOCAL CONDITIONS PREVENT AN 18" VERTICAL SEPARATION, CONSTRUCT BOTH THE WATER MAIN AND THE SANITARY SEWER FOR A DISTANCE OF 10 FEET ON EACH SIDE TO THE POINT OF CROSSING WITH FERROUS PIPE HAVING WATER MAIN QUALITY JOINTS.
- 4. WHEN A PROPOSED WATER MAIN CROSSES UNDER A PROPOSED OR EXISTING SANITARY SEWER, CONSTRUCT BOTH THE WATER MAIN AND THE SANITARY SEWER OF FERROUS MATERIALS WITH JOINTS THAT ARE EQUIVALENT TO WATER MAIN STANDARDS FOR A DISTANCE OF 10 FEET ON EACH SIDE OF THE POINT OF CROSSING. CENTER THE SECTION OF WATER PIPE AT THE POINT
- MAINTAIN A MINIMUM COVER OF 42" BELOW FINISHED GRADE OVER ALL PIPES UNLESS OTHERWISE DIRECTED OR SHOWN ON THE PLANS. DUE TO THE HEIGHTS OF VALVES, INCREASE THE COVER DEPTHS ADJACENT TO THE VALVES OR VARIED AT POINTS OF TIE—IN TO EXISTING
- 6. ALL FDC(S) AND HYDRANT(S) TO BE PROVIDED WITH 5 INCH DIAMETER STORZ CONNECTIONS.
- 7. PRIVATE FIRE SERVICE MAINS AND APPURTENANCES SHALL BE INSTALLED IN ACCORDANCE WITH NFPA 24. 2018 NCFC SECTION 507
- 8. FDC/STANDPIPES;3313.1 WHERE REQUIRED. IN BUILDINGS REQUIRED TO HAVE STANDPIPES BY SECTION 905.3.1, NOT LESS THAN ONE STANDPIPE SHALL BE PROVIDED FOR USE DURING CONSTRUCTION. SUCH STANDPIPES SHALL BE INSTALLED PRIOR TO CONSTRUCTION EXCEEDING 40 FEET (12192 MM) IN HEIGHT ABOVE THE LOWEST LEVEL OF FIRE DEPARTMENT VEHICLE ACCESS. SUCH STANDPIPE SHALL BE PROVIDED WITH FIRE DEPARTMENT VEHICLE ACCESS. SUCH STANDPIPE SHALL BE PROVIDED WITH FIRE DEPARTMENT HOSE CONNECTIONS AT ACCESSIBLE LOCATIONS ADJACENT TO USABLE STAIRWAYS. SUCH STANDPIPES SHALL BE EXTENDED AS CONSTRUCTION PROGRESSES TO WITHIN ONE FLOOR OF THE HIGHEST POINT OF CONSTRUCTION HAVING SECURED DECKING OR FLOORING. 2018 NCFC SECTION 313

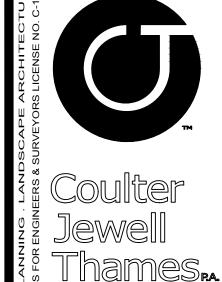


111 West Main Street **Durham, N.C. 27701** p 919.682.0368 f 919.688.5646 www.cjtpa.com

Project:

324 ROSEMARY MIXED-USE

324 W ROSEMARY ST. CHAPEL HILL, NC 27516

ORANGE COUNTY NORTH CAROLINA

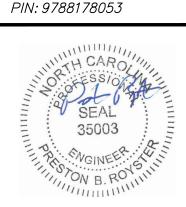

PRELIMINARY NOT FOR CONSTRUCTION

Job Number: 1663

Checked JSA Date 03.17.2017 Revisions 02.19.2020 COMMENTS 04.24..2020 COMMENTS

SITE PLAN

Sheet Title:

UTILITY **PLAN** 

Sheet Number

LEGEND

ISOLATION VALVE TO BE INSTALLED ON FDC LINE IN RISER ROOM. VALVES SHALL BE MONITORED BY SPRINKLER SYSTEMS AND ALARMS FOR ADJACENT BUILDINGS TO ENSURE PROPER OPERATION AND ISOLATION OF SPRINKLER SYSTEMS

(RE: SPRINKLER PLANS) SPRINKLER ASSE# 1047 RPDA BFP TO BË

(RE: PLUMBING PLANS)

—INSTALLED IN RISER

(RE: PLUMBING PLANS)

\_6" DI SANITARY

SEWER SERVICE

12"x6" TAPPING SLEEVE

AND VALVE v —

DOMESTIC ASSE# 1013 RPZ BFP TO BE

*⊸INSTALLED IN RISER* 

ROOM

ROOM.

~CLEANOUT (TYP.)

ON EX. SEWER MAIN.

INSTALL DOGHOUSE MANHOLE

Light Pole Water Valve OC0 Sewer Cleanout Curb Inlet/Catch Basin Flared End Section Mail Box ⊗ GV Gas Valve Existing Iron Pipe (3/4" unless noted) $\bigcirc$ 1/2" Iron Pipe Set O IPS Existing PK Nail PK PK Nail Set PKS Computed Point Concrete Monument Tree Line \_ × \_\_\_ × \_\_\_ × \_\_\_ × \_\_\_ × \_\_ Gas Line \_\_\_\_\_ GAS \_\_\_\_\_ GAS \_\_\_\_\_ Water Line Overhead Utilities \_\_\_\_\_ ou\_\_\_\_\_ ou\_\_\_\_ ou\_\_\_\_ \_\_\_s \_\_\_\_s \_\_\_\_s \_\_\_\_s \_\_\_

Traffic Signal Box Electric Transformer Electric Junction Box Gas Meter Sanitary Sewer Manhole Storm Sewer Manhole Telephone Manhole Electric Manhole Telephone Pedestal


WEST"ROSEMARY"ST Fire Hydrant Post Indicator Valve Water Manhole Water Meter

Hot Box

Utility Pole

HB

Storm Sewer Sanitary Sewer \_\_\_\_\_ss\_\_\_\_\_ss\_\_\_\_\_ss\_\_\_\_\_ss\_\_\_ Guard Rail Building Wall

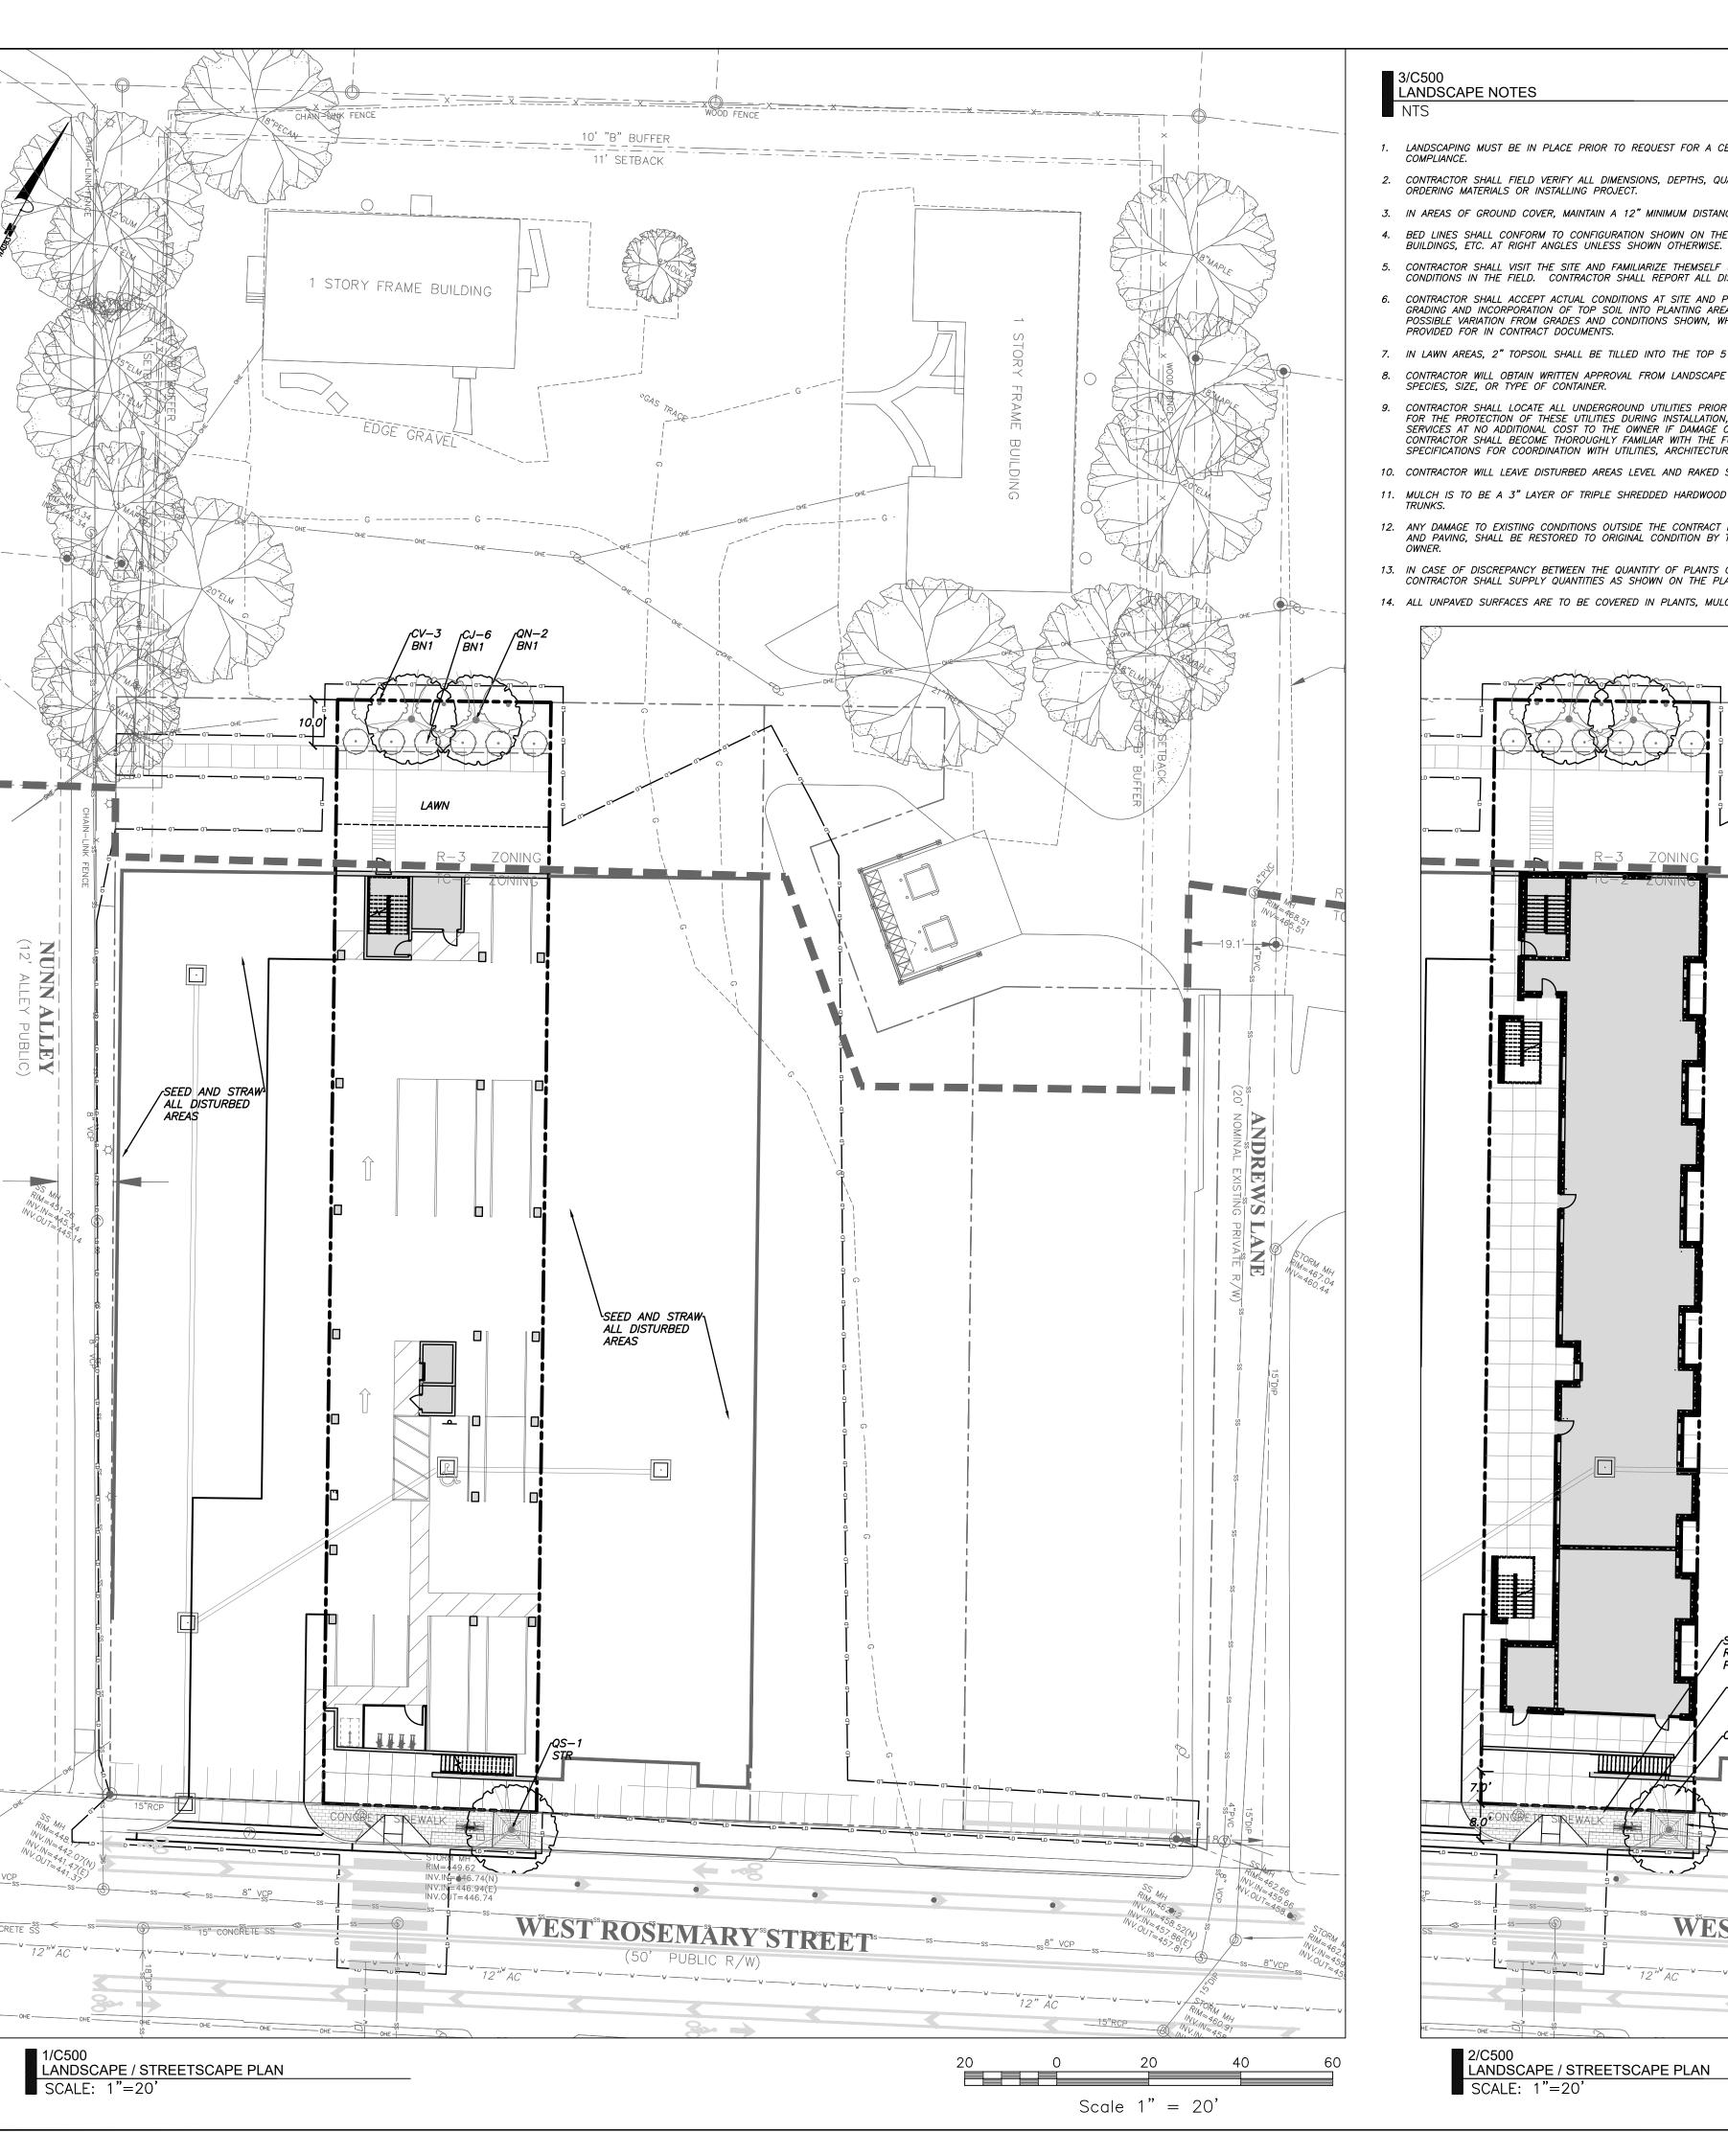

LANDSCAPE NOTES

1. LANDSCAPING MUST BE IN PLACE PRIOR TO REQUEST FOR A CERTIFICATE OF OCCUPANCY OR CERTIFICATE OF COMPLIANCE.

2. CONTRACTOR SHALL FIELD VERIFY ALL DIMENSIONS, DEPTHS, QUANTITIES, DISTANCES, ANGLES AND SLOPES PRIOR TO ORDERING MATERIALS OR INSTALLING PROJECT.

3. IN AREAS OF GROUND COVER, MAINTAIN A 12" MINIMUM DISTANCE BETWEEN PLANTS AND HARD IMPROVEMENTS.

4. BED LINES SHALL CONFORM TO CONFIGURATION SHOWN ON THE PLANS. BED LINES SHALL MEET CURBS, WALKS,

5. CONTRACTOR SHALL VISIT THE SITE AND FAMILIARIZE THEMSELF WITH ACTUAL CONDITIONS AND VERIFY EXISTING CONDITIONS IN THE FIELD. CONTRACTOR SHALL REPORT ALL DISCREPANCIES TO LANDSCAPE ARCHITECT.

6. CONTRACTOR SHALL ACCEPT ACTUAL CONDITIONS AT SITE AND PERFORM THE WORK SPECIFIED INCLUDING FINE GRADING AND INCORPORATION OF TOP SOIL INTO PLANTING AREAS, WITHOUT ADDITIONAL COMPENSATION FOR POSSIBLE VARIATION FROM GRADES AND CONDITIONS SHOWN, WHETHER SURFACE OR SUBSURFACE, EXCEPT AS

7. IN LAWN AREAS, 2" TOPSOIL SHALL BE TILLED INTO THE TOP 5" OF GROUND PRIOR TO SEEDING.

8. CONTRACTOR WILL OBTAIN WRITTEN APPROVAL FROM LANDSCAPE ARCHITECT FOR ANY PLANT SUBSTITUTIONS OF SPECIES, SIZE, OR TYPE OF CONTAINER.

9. CONTRACTOR SHALL LOCATE ALL UNDERGROUND UTILITIES PRIOR TO CONSTRUCTION AND SHALL BE RESPONSIBLE FOR THE PROTECTION OF THESE UTILITIES DURING INSTALLATION, AND SHALL PROMPTLY REPAIR AND RESTORE SERVICES AT NO ADDITIONAL COST TO THE OWNER IF DAMAGE OCCURS DURING INSTALLATION. CONTRACTOR SHALL BECOME THOROUGHLY FAMILIAR WITH THE FULL SET OF CONSTRUCTION DRAWINGS AND SPECIFICATIONS FOR COORDINATION WITH UTILITIES, ARCHITECTURAL FEATURES, ETC.

10. CONTRACTOR WILL LEAVE DISTURBED AREAS LEVEL AND RAKED SMOOTH, REMOVING ALL ROCKS AND DEBRIS.

11. MULCH IS TO BE A 3" LAYER OF TRIPLE SHREDDED HARDWOOD MULCH. MULCH IS TO BE KEPT AWAY FROM TREE

12. ANY DAMAGE TO EXISTING CONDITIONS OUTSIDE THE CONTRACT LIMITS, INCLUDING CURBS, SIDEWALKS, TURF AREAS AND PAVING, SHALL BE RESTORED TO ORIGINAL CONDITION BY THE CONTRACTOR WITHOUT EXTRA COST TO THE

STREETSCAPE PER ROSEMARY STREETSCAPE

TREE GRATE (TYP.)

WEST ROSEM

13. IN CASE OF DISCREPANCY BETWEEN THE QUANTITY OF PLANTS ON THE PLANS COMPARED TO THE PLANT LIST, THE CONTRACTOR SHALL SUPPLY QUANTITIES AS SHOWN ON THE PLANS.

14. ALL UNPAVED SURFACES ARE TO BE COVERED IN PLANTS, MULCH, OR GRASS.



USE CLASSIFICATION: DWELLING UNITS, 7 OR MORE (USE GROUP A)

ADJACENT USE CLASSIFICATION: DWELLING UNITS, 7 OR MORE (USE GROUP A)

NORTHERN BUFFER = TYPE B INTERNAL BUFFER (10' MIN.) PLANTINGS PER 100 LF 4 LARGE TREES 7 SMALL TREES


12 SHRUBS


PLANTINGS PROVIDED = 46' PL

2 LARGE TREES 3 SMALL TREES 6 SHRUBS

LANDSCAPE PLANTING SCHEDULE

| QTY     | %                       | EVGN | KEY | BOTANICAL NAME            | COMMON NAME     | S         | IZE         | SPACING | REMARKS                   |
|---------|-------------------------|------|-----|---------------------------|-----------------|-----------|-------------|---------|---------------------------|
| LARGE T | LARGE TREES             |      |     |                           |                 |           |             |         |                           |
|         | 3                       | N    | QN  | Quercus nuttallii         | Nutall Oak      | 2" cal.   | 8'-10' hgt. |         | Single leader             |
|         | 1                       | N    | QS  | Quercus shumardii         | Shumard Oak     | 3" cal.   |             |         | Single leader, Limb to 7' |
| SMALL   | SMALL TREES SMALL TREES |      |     |                           |                 |           |             |         |                           |
|         | 3                       | N    | CV  | Chionanthus virginicus    | Fringetree      | 1.5" cal. | 5'-6' hgt.  |         | Single trunk              |
| SHRUBS  |                         |      |     |                           |                 |           |             |         |                           |
|         | 6                       | Υ    | CJ  | Camellia japonica 'Jacks' | Spring Camellia | 3 gal.    | 18" hgt.    |         | Full. Matching            |

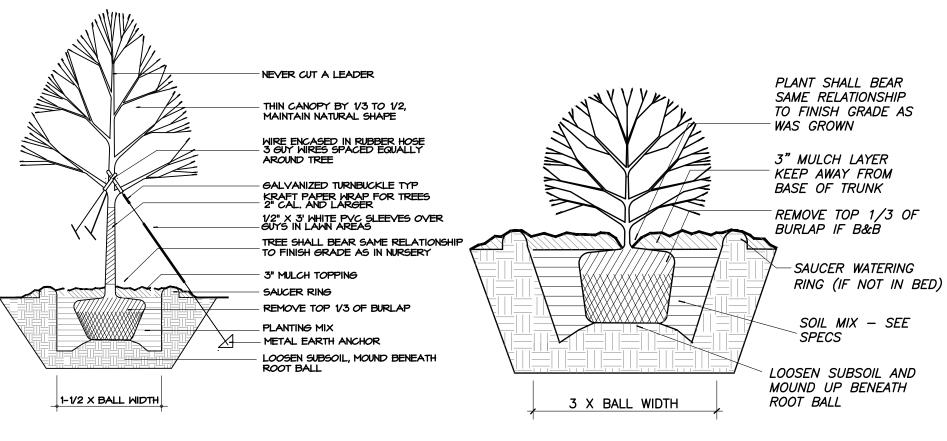

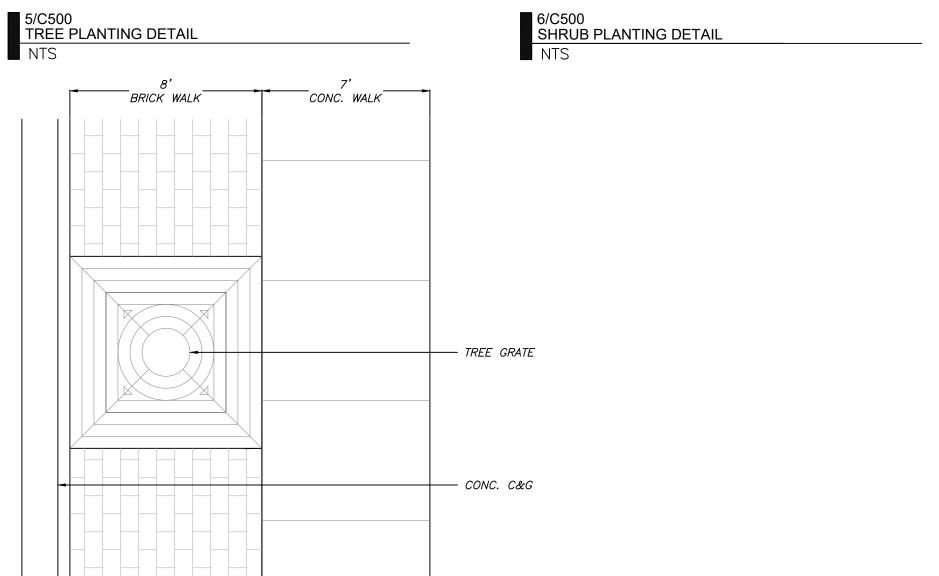

Utility Pole

7/C500 SIDEWALK TYPE "A" - URBAN STYLE

|                        | igored                           |                                           | oLP                                     |
|------------------------|----------------------------------|-------------------------------------------|-----------------------------------------|
| Water Valve            | $\otimes$                        | Light Pole                                | 000                                     |
| Curb Inlet/Catch Basin | <u> </u>                         | Sewer Cleanout                            | _                                       |
| Mail Box               | MB                               | Flared End Section                        |                                         |
| Traffic Signal Box     | ☐ TSB                            | Gas Valve                                 | ⊗ GV                                    |
| Electric Transformer   | T                                | Existing Iron Pipe (3/                    |                                         |
| Electric Junction Box  | E                                | 1/2" Iron Pipe Set                        | O IPS                                   |
| Gas Meter              | G                                | Existing PK Nail                          | ● PK                                    |
| Sanitary Sewer Manhole | 0                                | PK Nail Set                               | PKS                                     |
| Storm Sewer Manhole    | <b>O</b><br><b>®</b><br><b>P</b> | Computed Point                            | Δ                                       |
| Telephone Manhole      | lacktriangle                     | Concrete Monument                         | $\boxtimes$                             |
| Electric Manhole       | <b>©</b>                         | Tree Line                                 | ~~~~~~~~~~~~~~~~~~~~~~~~~~~~~~~~~~~~~~~ |
| Sign                   | <del>-</del> 0-                  | Fence                                     | — x — x — x — x —                       |
| Telephone Pedestal     | ∑ TEL                            | Underground Electric Underground Telephol | ие ие ие<br>ne ит ит ит                 |
| Fire Hydrant           | lacksquare                       | Gas Line                                  | GAS GAS GAS                             |
| Post Indicator Valve   | ○ PIV                            | Water Line<br>Overhead Utilities          | www                                     |
| Water Manhole          | <b>(W)</b>                       | Storm Sewer                               | sss                                     |
| Water Meter            | <b>W</b>                         | Sanitary Sewer                            | ss ss ss                                |
| Hat Dani               |                                  | Guard Rail                                | <del>-0-0-0-0-</del>                    |


111 West Main Street Durham, N.C. 27701 p 919.682.0368 f 919.688.5646 www.cjtpa.com

Project:

324 ROSEMARY MIXED-USE

324 W ROSEMARY ST. CHAPEL HILL, NC 27516

ORANGE COUNTY NORTH CAROLINA

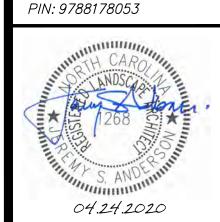

PRELIMINARY NOT FOR CONSTRUCTION

Job Number: 1663 
 Drawn
 JSA, ED

 Checked
 JSA

 Date
 03.17.2017


 Revisions
 02.19.2020 COMMENTS


SITE PLAN

Sheet Title: LANDSCAPE / STREETSCAPE

**PLAN** 

Sheet Number C500

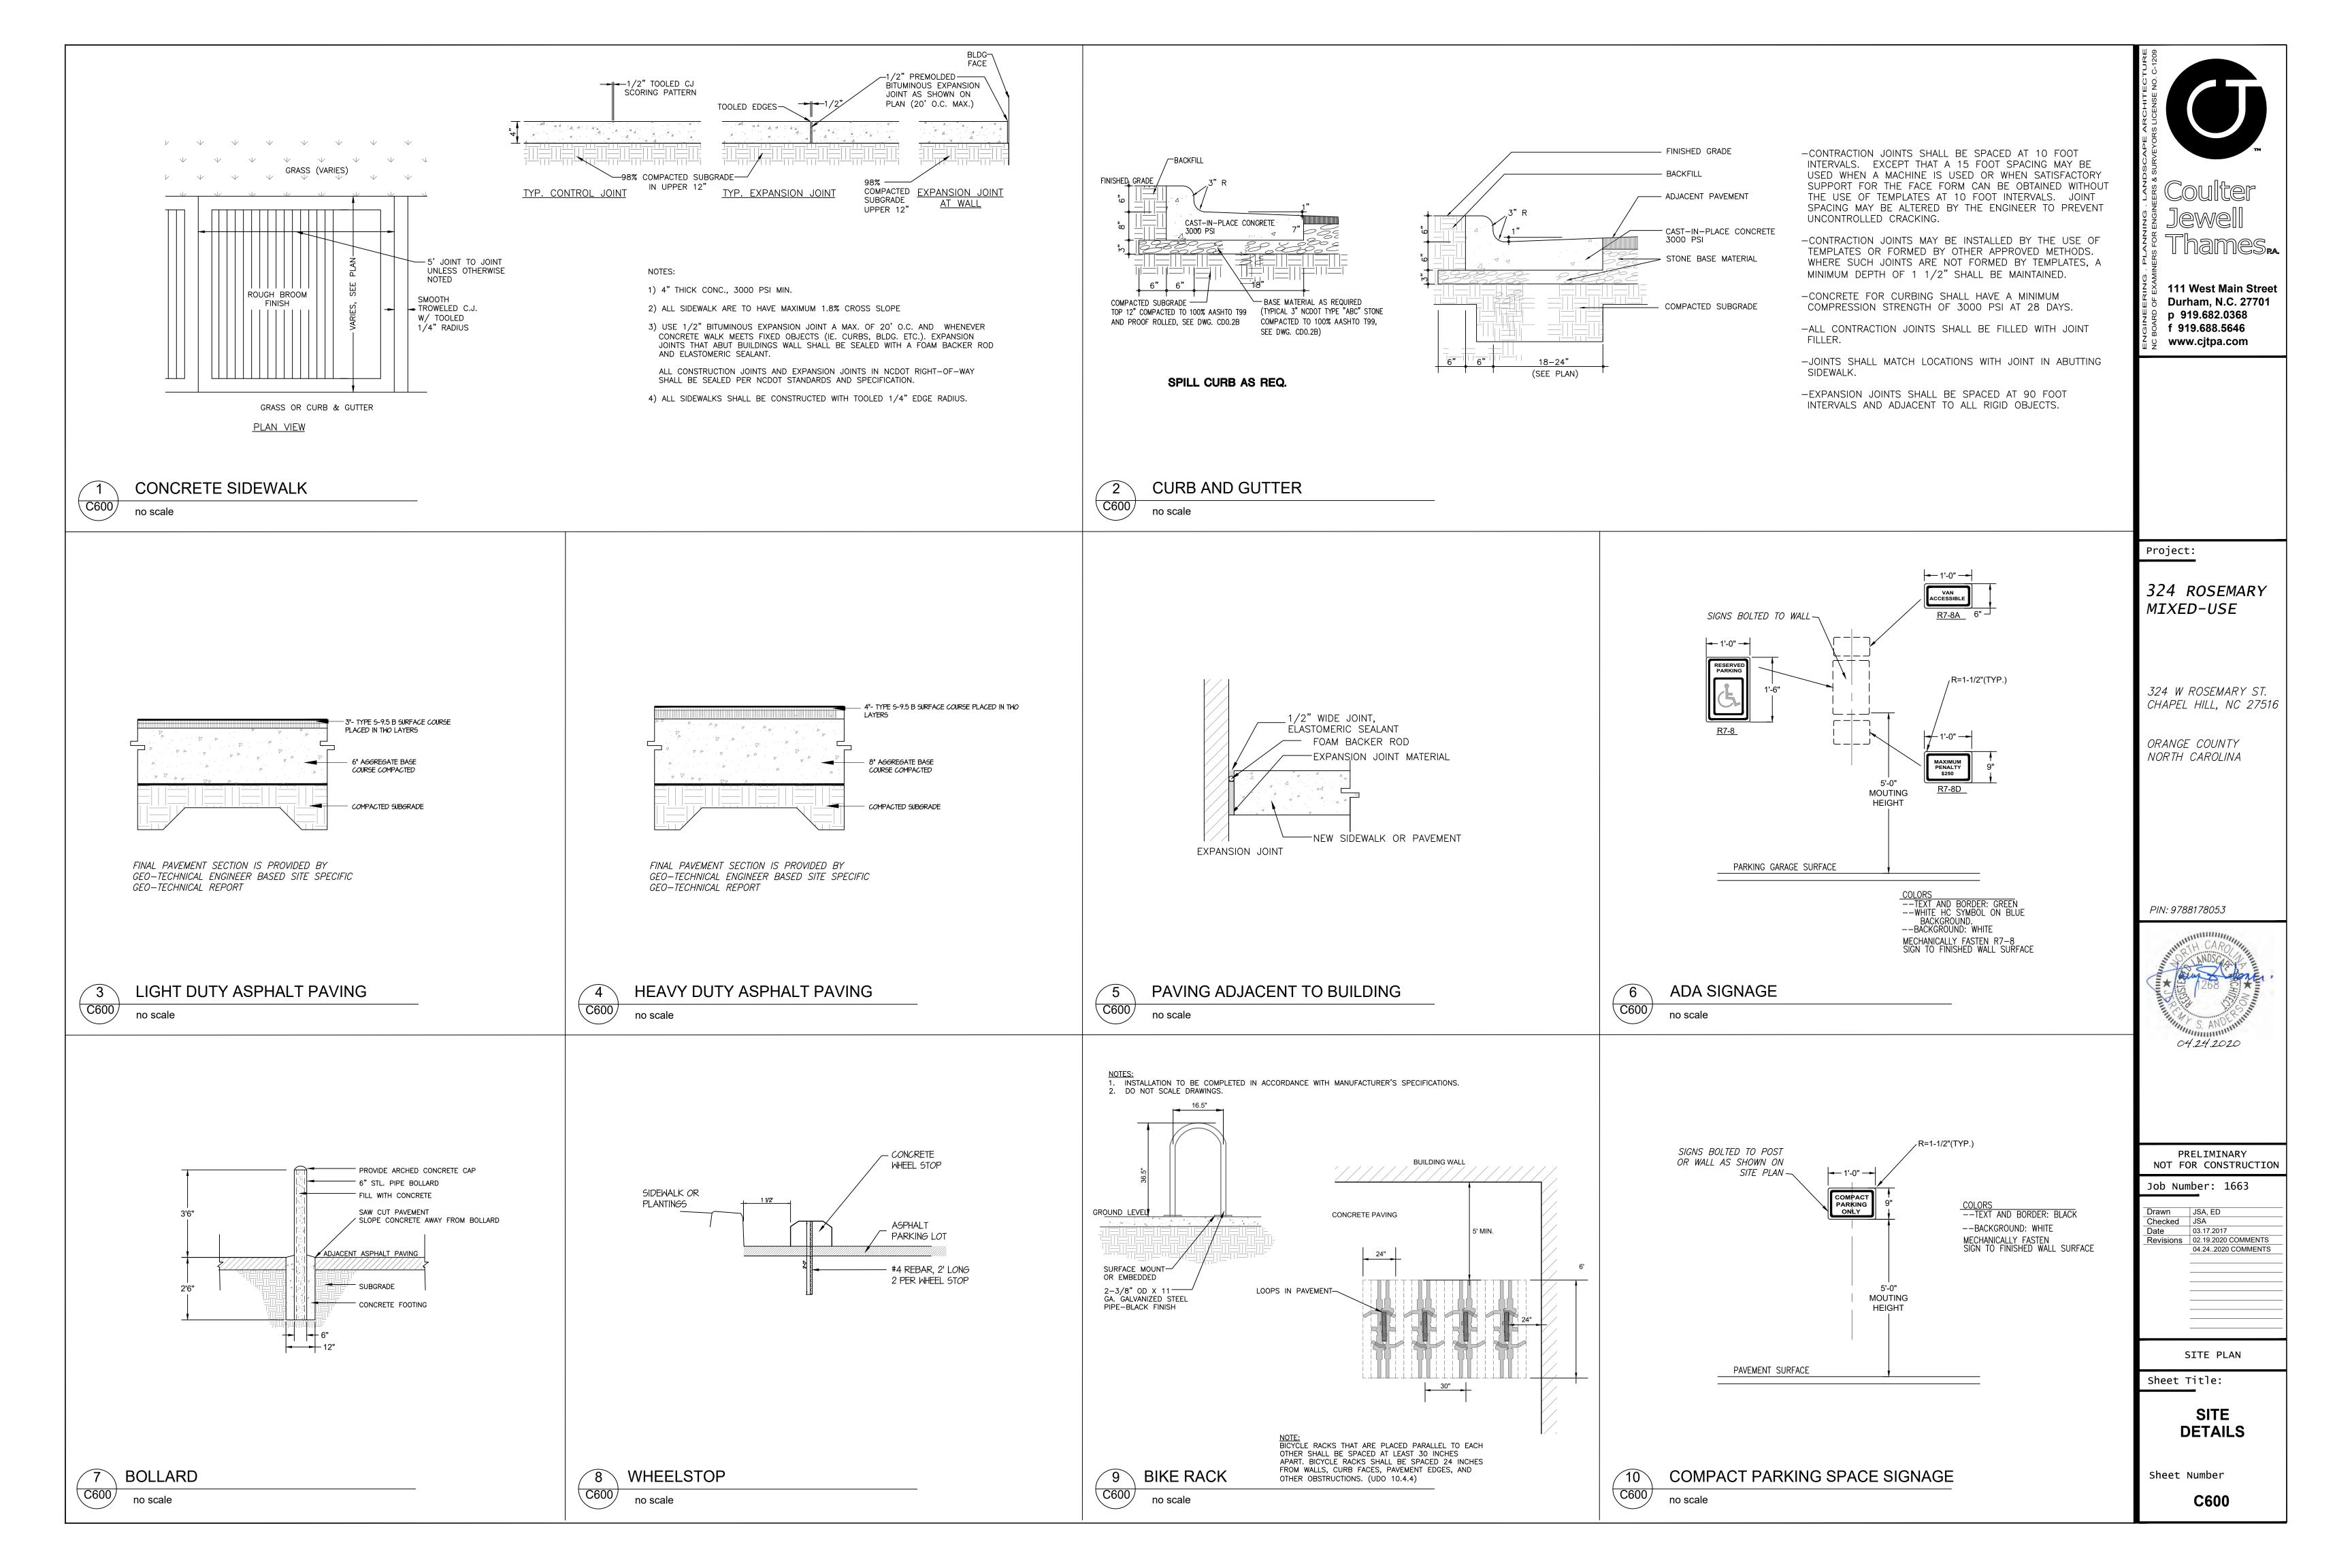

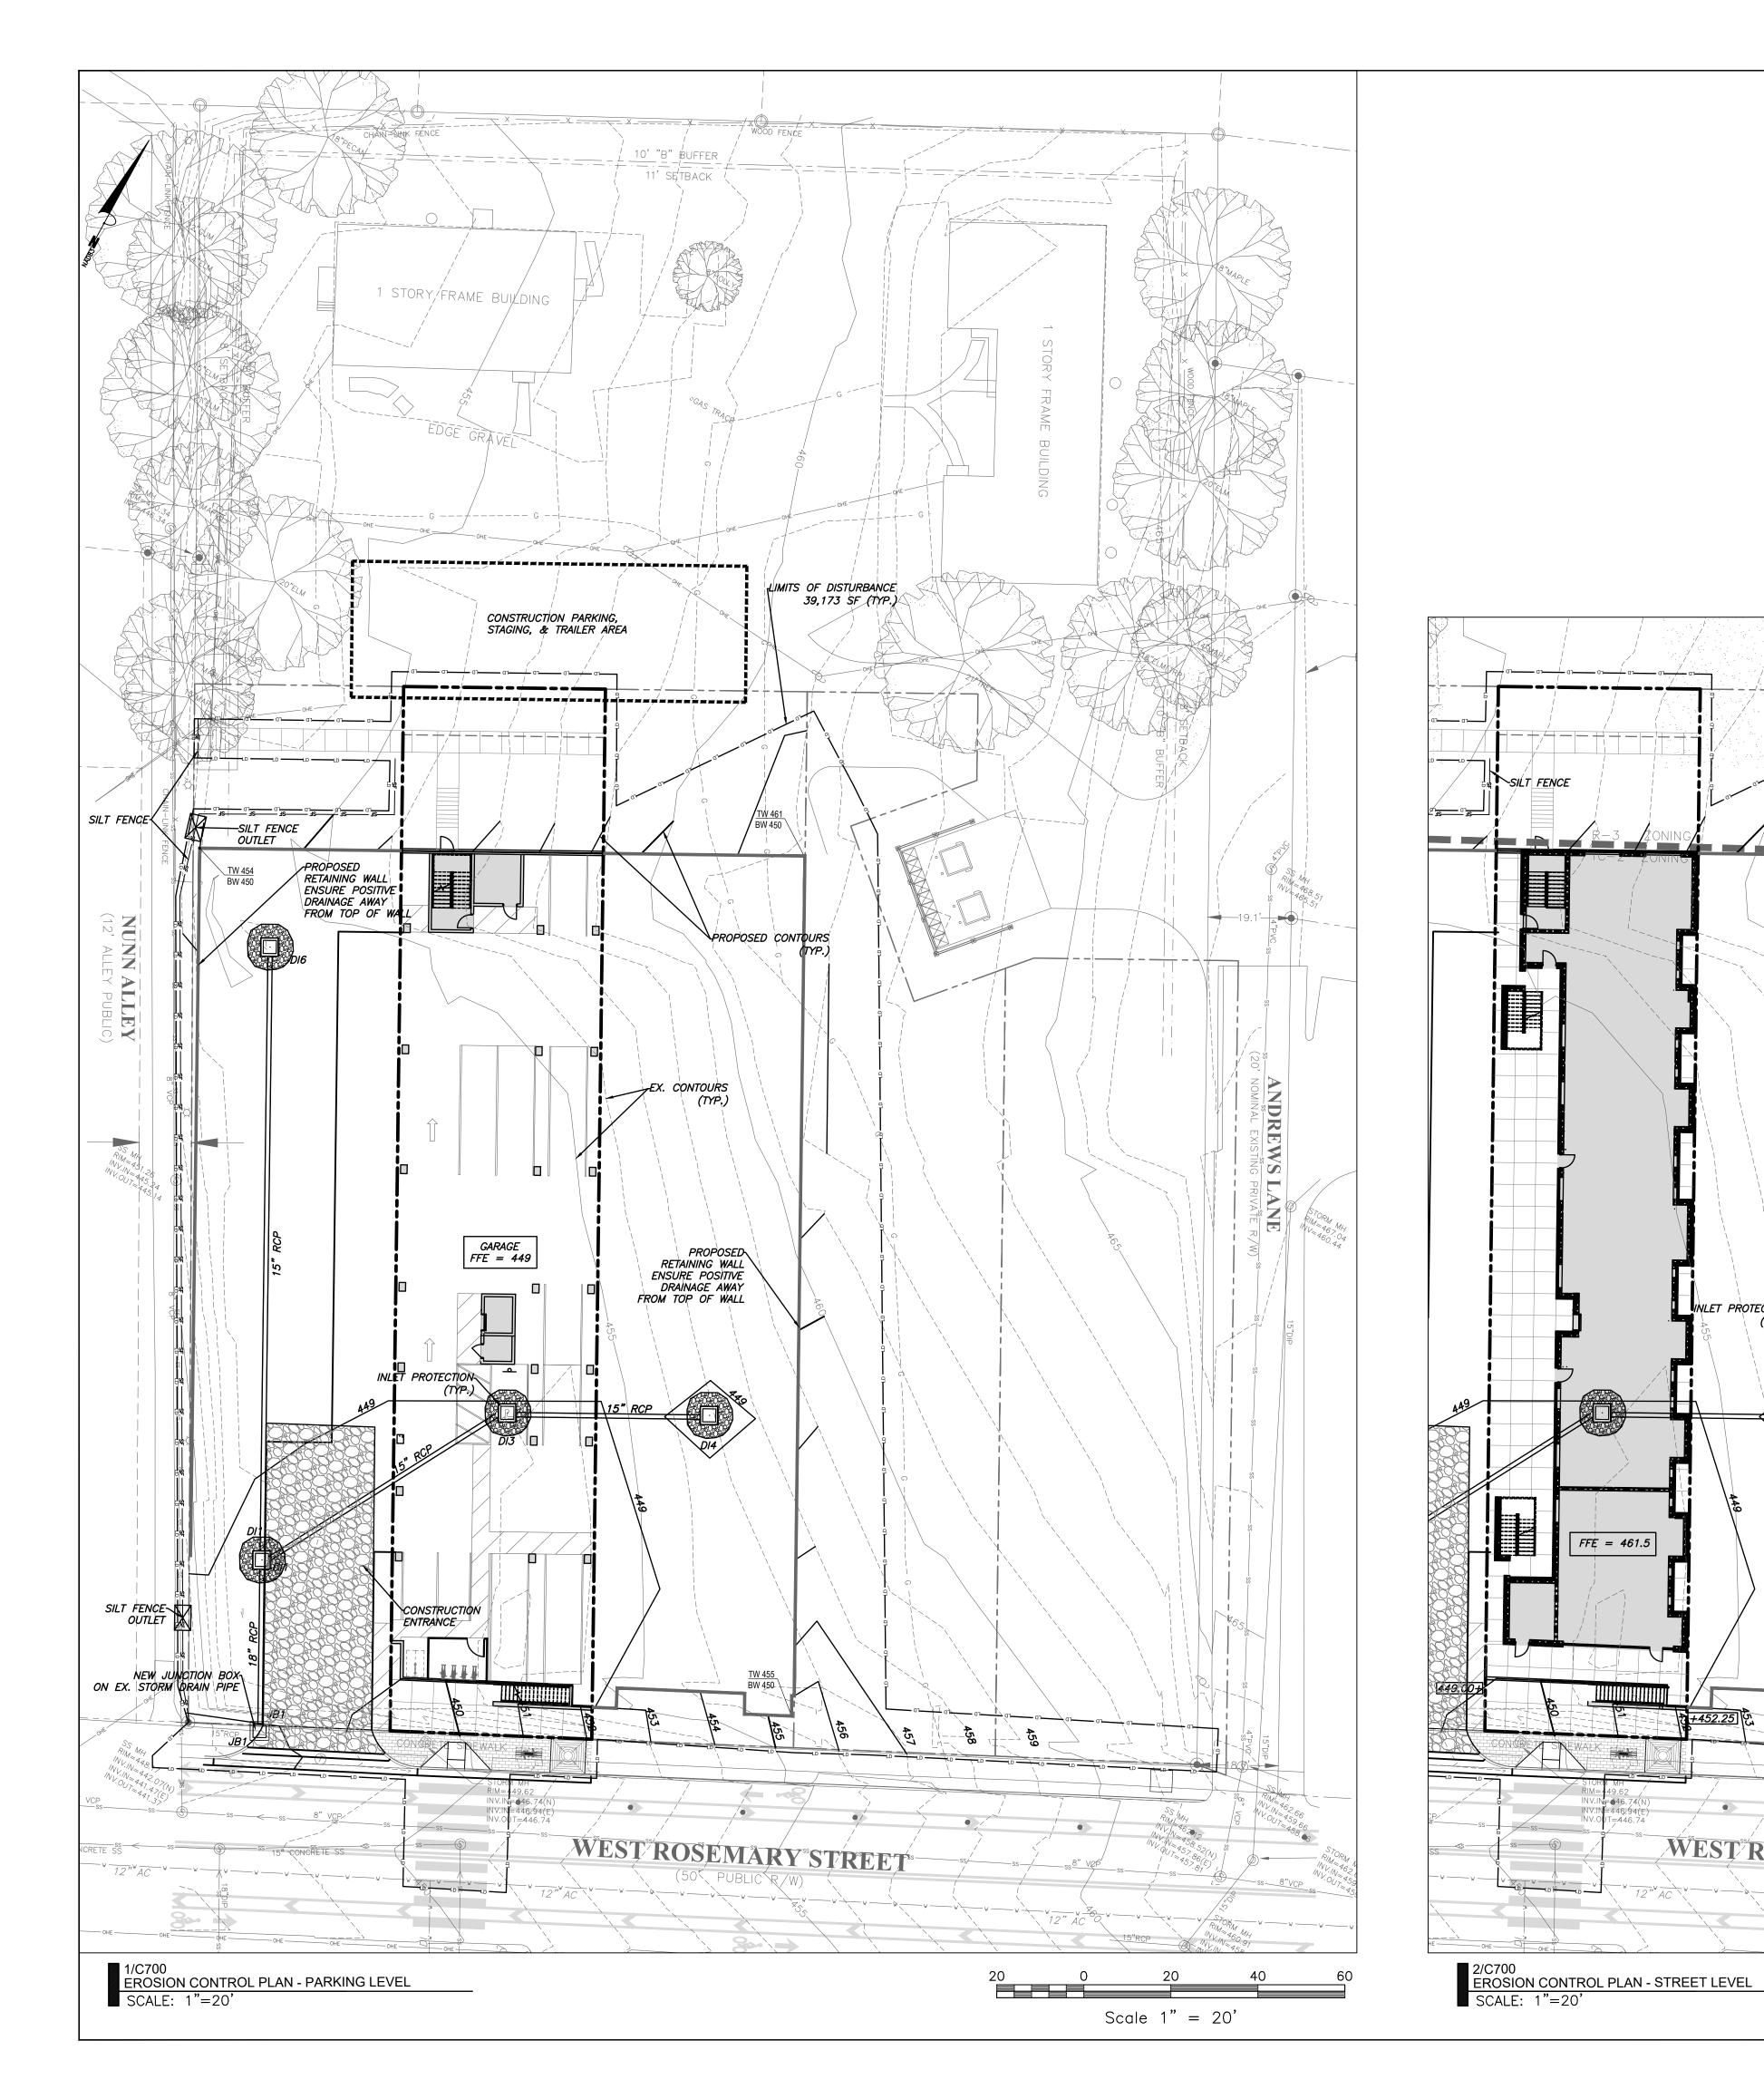

#### **CONSTRUCTION SEQUENCE**

Pre Construction

1. Verify that all approvals and permits necessary to begin and complete the project are in hand. Approval and permits must be obtained prior to disturbance so that work will not be interrupted or delayed due to the lack of approved plans.

2. Schedule and hold a preconstruction conference before starting demolition, clearing or grading with the owner, contractor responsible for grading and erosion control, person responsible for supervising implementation of the erosion control plan, and the Orange County Erosion Control Inspector.

3. Install a box on the site to hold a copy of the approved erosion control plan and to provide a place for the inspector(s) to leave inspection reports, compliance notices, etc. Place the box in a convenient location, such as at the entrance to the site or next to the construction trailer. Erosion control personnel will leave correspondence in the box and raise the red flag if personnel responsible for erosion control cannot be located on the site. Site personnel should check the box daily.

Construction

4. Install gravel construction entrance.

5. Install silt fence and tree protection. Install inlet protection around existing inlets. Clear and demo areas shown inside of the limits of disturbance as necessary to begin construction. Limit disturbance to areas necessary for construction activities at that time. Stabilize disturbed areas as soon as

6. Demo existing utilities as shown and construct new storm drainage. Install inlet protection around new inlets immediately after construction. Seal all junction boxes from stormwater intake from surface. Seal any inlets to stormwater structures not protected by inlet projection.

7. Minimize the amount of area disturbed at any one time.

8. During construction, some temporary measures will be removed to allow construction of permanent

9. If it is determined during the course of construction that significant sediment is leaving the site despite proper implementation and maintenance of the approved erosion control plan, the person responsible for the land disturbing activity is obligated to take additional protective action.

10. Inspect and maintain the erosion control devices so they continue to function properly. Refer to the instructions in the erosion control plan for specific instructions for each device. The person responsible for erosion control is also responsible for taking the initiative in inspecting and maintaining these devices. Do not wait for erosion control personnel to point out the need for repairs and maintenance. Keep mud and debris off the public street at all times. If mud or debris is tracked from the site, use a shovel and broom to remove it immediately. IF MUD AND DEBRIS ARE NOT KEPT OFF THE STREET, ENFORCEMENT ACTION (REVOKING THE GRADING PERMIT AND/OR A STOP WORK ORDER) MAY

11. In addition to the inspections by the Contractor the Owner, the Financially Responsible Party, or their Agent must conduct inspections in accordance with the NPDES General Permit and NCDEQ's Self-Inspection Program for Erosion and Sediment Control.

12. Permanently stabilize all disturbed areas. Refer to seeding schedule for types of stabilization to be

13. When construction is completed, remove all temporary erosion control devices after the drainage area above has been sufficiently been stabilized to restrain erosion. Remove and properly dispose of accumulated sediment and the debris from the devices, and stabilize the location.

Arrange a final inspection with the erosion control inspector to confirm that all requirements of the approved erosion control plan have been completed.

111 West Main Street Durham, N.C. 27701 p 919.682.0368 f 919.688.5646 www.cjtpa.com

Project:

324 ROSEMARY MIXED-USE

324 W ROSEMARY ST. CHAPEL HILL, NC 27516

ORANGE COUNTY NORTH CAROLINA

PIN: 9788178053



PRELIMINARY NOT FOR CONSTRUCTION

Job Number: 1663

EROSION CONTROL PLAN

Sheet Title:

**EROSION CONTROL PLAN** 

Sheet Number C700

**EROSION CONTROL LEGEND** 

 $\longrightarrow\longrightarrow\longrightarrow$ 

——SF ———SF ———

— тР——— ТР——

 $\boxtimes$ 

(TS)

DIVERSION DITCH CONSTRUCTION ENTRANCE SILT FENCE TREE PROTECTION FENCE

INLET PROTECTION


SILT FENCE OUTLET TEMPORARY SEEDING PERMANENT SEEDING

-+,---+----

INLET PROTECTION

WESTROSEM

FFE = 461.5

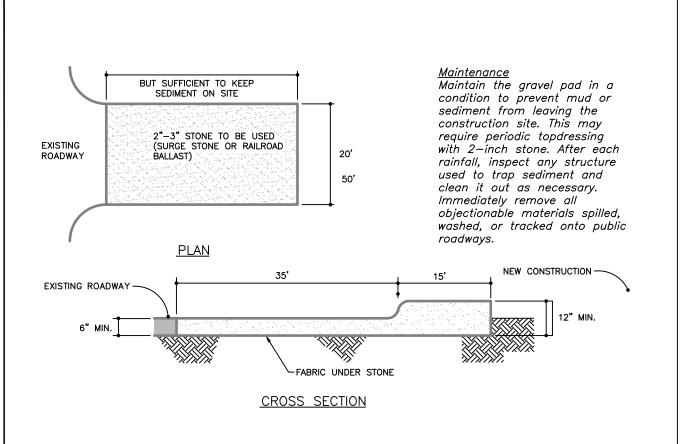

1. PUT SILT FENCE OR TREE PROTECTION FENCE UP TO ENSURE CONSTRUCTION ENTRANCE IS

2. IF CONSTRUCTION ON THE SITES ARE SUCH THAT THE MUD IS NOT REMOVED BY THE VEHICLE TRAVELING OVER THE STONE, THEN THE TIRES OF THE VEHICLES MUST BE


PERSON AS INDICATED ON THE FINANCIAL RESPONSIBILITY FORM.

METAL STAKES

WASHED BEFORE ENTERING THE PUBLIC ROAD. 3. IF A PROJECT CONTINUES TO PULL MUD AND DEBRIS ON TO THE PUBLIC ROAD, THE

GOVERNING AUTHORITY WILL CLEAN THE AREA AND INVOICE THE FINANCIALLY RESPONSIBLE

GRAVEL CONSTRUCTION ENTRANCE

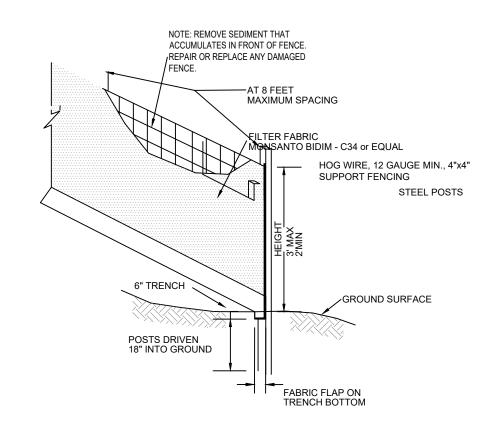

INSPECT SEDIMENT FENCES AT LEAST ONCE A WEEK AND AFTER EACH RAINFALL. MAKE

- ANY REQUIRED REPAIRS IMMEDIATELY. 2. SHOULD THE FABRIC OF A SEDIMENT FENCE COLLAPSE, TEAR, DECOMPOSE OR BECOME INEFFECTIVE. REPLACE IT PROMPTLY. 3. REMOVE SEDIMENT DEPOSITS AS NECESSARY TO PROVIDE ADEQUATE STORAGE VOLUME FOR THE NEXT RAIN AND TO REDUCE PRESSURE ON THE FENCE. TAKE CARE TO AVOID UNDERMINING THE FENCE DURING CLEANOUT.
- 4. REMOVE ALL FENCING MATERIALS AND UNSTABLE SEDIMENT DEPOSITS AND BRING THE AREA TO GRADE AND STABILIZE IT AFTER THE CONTRIBUTING DRAINAGE AREA HAS BEEN

STEEL FENCE POST

WATER FLOW-

BURY WIRE FENCE AND HARDWARE CLOTH-

WIRE FENCE-HARDWARE CLOTH-

<u>PLAN VIEW</u>

MAINTENANCE
INSPECT SILT FENCE OUTLETS AT LEAST ONCE A WEEK AND AFTER EACH RAINFALL. MAKE ANY REQUIRED
TO RECOVER ADEQUATE STORAGE VOLUME FOR

REPAIRS AS NEEDED. REMOVE SEDIMENT AS NECESSARY TO PROVIDE ADEQUATE STORAGE VOLUME FOR

SUBSEQUENT RAINS. WHEN THE CONTRIBUTING DRAINAGE AREA HAS BEEN ADEQUATELY STABILIZED.

REMOVE ALL MATERIALS AND ANY UNSTABLE SOIL, AND EITHER SALVAGE OR DISPOSE OF IT PROPERLY. BRING THE DISTURBED AREA TO PROPER GRADE, THEN SMOOTH AND COMPACT IT. STABILIZE AREAS

-FILTER FABRIC ON GROUND

FOR REPAIR OF SILT FENCE OUTLET FAILURES, USE NO.

57 WASHED STONE AND

NEW FILTER FABRIC/SILT

| 10-10-10 Fertilizer 15 lbs/1000 sf<br>Browntop Millet Seed FALL/WINTER/SPRING TEMPORARY COVED 10s/1000 sf AUGUST 1                                                                                                                                                                                                                                             | Ground Stabilization*                                                                                                                                                         |                             |                                        |  |
|----------------------------------------------------------------------------------------------------------------------------------------------------------------------------------------------------------------------------------------------------------------------------------------------------------------------------------------------------------------|-------------------------------------------------------------------------------------------------------------------------------------------------------------------------------|-----------------------------|----------------------------------------|--|
| Browntop Millet Seed <u>FALL/WINTER/SPRING TEMPORARY COVER</u> Ibs/1000 sf AUGUST 1 Straw Mulch *  SPRING/FALL PERMANENT COVER Lime MARCH 1 — APRIL 30  2                                                                                                                                                                                                      | Site Area<br>Description                                                                                                                                                      | Stabilization<br>Time Frame | Stabilization Time<br>Frame Exceptions |  |
| Improved furt type Fine Fescue Seed. 8 lbs/1000 st                                                                                                                                                                                                                                                                                                             | Perimeter dikes,<br>swales, ditches,<br>and slopes                                                                                                                            | 7 days                      | None                                   |  |
| GRASS - TO MATCH EXISTING ON SITE                                                                                                                                                                                                                                                                                                                              | High Quality<br>Water (HQW)<br>Zones                                                                                                                                          | 7 days                      | None                                   |  |
| BERMUDAGRASS(HYBRID) TALL FESCUE ZOYSIAGRASS                                                                                                                                                                                                                                                                                                                   | Slopes steeper<br>than 3:1                                                                                                                                                    | 7 days                      |                                        |  |
| 7 DUOUSI 0 DED 4000 00 ST                                                                                                                                                                                                                                                                                                                                      | Slopes 3:1 or<br>flatter                                                                                                                                                      | 7 days                      | None                                   |  |
| to loosen and roughen it to recieve seed.  Seed Temporary cover to stabilize temporary sedimentation control measures and                                                                                                                                                                                                                                      | All other areas<br>with slopes<br>flatter than 4:1                                                                                                                            | 7 days                      | None                                   |  |
| cover. Contractor shall install temporary cover suitable for that season and reseed with permanent grass at earliest possible date.  * Anchor straw mulch by applying an asphalt binder emulsion at a rate of 10 gallons per 1000 SF, or install jute, paper or twine netting or excelsior mats staked to ground according to the manufacturer's instructions. | * "Extensions of time may be approved by the permitting authority based on weather or other site-specific conditions that make compliance impracticable" (Section 11.B(2)(b)) |                             |                                        |  |

SEEDING SCHEDULE

SILT FENCE-

- STABILIZATION TIME TABLE
  1. ALL PERMANENT DIKES, SWALES, DITCHES, PERIMETER SLOPES, AND ALL SLOPES STEEPER THAN 3:1 SHALL BE PROVIDED WITH TEMPORARY OR PERMANENT STABILIZATION WITH GROUNDCOVER AS SOON AS PRACTICABLE BUT WITHIN 7 CALENDAR DAYS FROM LAST
- LAND-DISTURBING ACTIVITY. 2. ALL OTHER DISTURBED AREAS SHALL BE PROVIDED WITH TEMPORARY OR PERMANENT STABILIZATION WITH GROUNDCOVER AS SOON AS PRACTICABLE BUT IN ANY EVENT WITHIN 14 CALENDAR DAYS FROM LAST LAND-DISTURBING ACTIVITY.

HARDWARE CLOTH-

STEEL FENCE POST SET MAX. 2' APART-

4' MIN.

FRONT VIEW

"EXPOSED" AREAS INCLUDE, BUT ARE NOT LIMITED TO: AREAS CLEARED FOR ROADWAY CONSTRUCTION. • AREAS CLEARED ON RESIDENTIAL BUILDING LOTS.

 DRAINAGE EASEMENTS AND OPEN DRAINAGE CHANNELS. • SEDIMENT AND EROSION CONTROL MEASURES (SEDIMENT TRAPS, DIVERSION DITCHES, ETC.) AND THE AREAS ADJECENT TO SUCH MEASURES.

FILTER OF NO. 57

FILTER FABRIC ON GROUND

TOP OF SILT FENCE MUST BE

AT LEAST 1' ABOVE THE TOP OF THE WASHED STONE

(REPLACE AS

NECESSARY)

SILT FENCE

OPENING 1" REBAR FOR BAG REMOVAL FROM INLET (REBAR NOT INCLUDED) OPTIONAL OVERFLOW SILTSACK DUMP LOOPS (REBAR NOT INCLUDED) SIDE VIEW INSTALLED INSPECT INLETS AT LEAST WEEKLY AND AFTER EACH SIGNIFICANT (1/2 INCH OR GREATER) RAINFALL EVENT. CLEAR THE MESH WIRE OF ANY DEBRIS OR OTHER OBJECTS TO PROVIDE ADEQUATE FLOW FOR SUBSEQUENT RAINS. TAKE CARE NOT TO DAMAGE OR UNDERCUT THE WIRE MESH DURING SEDIMENT REMOVAL. REPLACE STONE AS NEEDED.

INSTALLATION DETAIL

USE 4 STAPLES ACROSS A

THE START OF EACH ROLL

AND CONTINUE TO STAPLE

THROUGHOUT THE LENGTH

AT 4 FT. INTERVALS IN

BE ON FOOT CENTERS.

AREAS WITH HIGH WATER

VELOCITY, STAPLES SHOULD

Project:

324 ROSEMARY MIXED-USE

111 West Main Street

Durham, N.C. 27701 p 919.682.0368

f 919.688.5646 www.cjtpa.com

324 W ROSEMARY ST. CHAPEL HILL, NC 27516

> ORANGE COUNTY NORTH CAROLINA

PIN: 9788178053



PRELIMINARY

Job Number: 1663

NOT FOR CONSTRUCTION

EROSION CONTROL MATTING

INLET PROTECTION

INSTALLATION

LOCATE BEGINNING OF ROLL WITH STARTER SHEET.

4. STAPLE BLANKET SECURELY TO SOIL AS APPLIED.

MAKE SURE NETTING APPEARS ON TOP OF THE BLANKET WHEN BEING UNROLLED.

THE EROSION CONTROL BLANKET SHOULD BE INSTALLED OVER A PROPERLY PREPARED, FERTILIZED, AND SEEDED

AREA. WHEN THE BLANKET IS UNROLLED, THE NETTING SHOULD BE ON TOP AND THE BLANKET IN CONTACT

THE STAPLES SHOULD BE DRIVEN VERTICALLY INTO THE GROUND. EACH BLANKET SHALL BE STAPLED AT EACH

EDGE AND ALTERNATELY SPACED IN THE CENTER OF EACH BLANKET. USE A COMMON ROW OF STAPLES AT THE SEAM FORMED BY TWO ADJOINING BLANKETS. USE FOUR STAPLES AT THE BEGINNING AND END OF EACH

EROSION CONTROL BLANKET

NAMED IN THE CONTRACT)

STAPLES WILL

APPEAR AS A

"5" ON DICE

(STANDARD)

(TO BE INSTALLED AS SHOWN

AND AS DIRECTED BY ENGINEER.
PAYMENT TO BE AT THE UNIT PRICE

WITH THE SOIL OVER THE ENTIRE AREA. IT IS NOT NECESSARE TO OVERLAP, DIG CHECK SLOTS, ANCHOR

REMOVE OUTER WRAPPING.

IN DITCHES: THE BLANKETS SHOULD BE APPLIED IN THE

DIRECTION OF WATER FLOW, BUTTED SNUGLY AT ENDS AND

BLANKETS SIDE BY SIDE, DO NOT PLACE A SEAM FORMED

STAPLES SHOULD BE SPACED NO MORE THAN FOUR FEET

APART DOWN THE LENGTH OF THE BLANKET.

APPROXIMATELY 90 TO 95 STAPLES REQUIRED FOR EACH

BLANKET. STAPLES: THE STAPLES SHALL BE MADE OF WIRE,

.091" IN DIAMETER OR GREATER, "U" SHAPED WITH

LEGS 6" IN LENGTH AND A 1" CROWN. SIZE AND GAUGE OF STAPLES USED WILL VARY WITH SOIL

THE STAPLES SHALL BE DRIVEN VERTICALLY INTO

IN THE CENTER ALTERNATELY SPACED BETWEEN EACH

COMMÒN ROW OF STAPLES ON ADJOINING BLANKETS.

MAINTENANCE: INSPECT AT LEAST WEEKLY AND AFTER

AREAS FOUND DAMAGED OR NOT IN CLOSE CONTACT

SIDE. (60 STAPLES ON EACH BLANKET). USE A

EACH RAIN OF 1/2" OR MORE. GOOD GROUND CONTACT WITH BLANKET MUST BE MAINTAINED. ANY

STAPLED. REPAIR ANY ERODED AREAS IF FOUND.

WITH THE GROUND SHALL BE REPAIRED AND

MONITOR UNTIL GRAND OVER ESTABLISHED.

THE GROUND, SPACED APPROXIMATELY TWO (2) LINEAL YARDS APART, ON EACH SIDE, AND ONE ROW

SIDES AND STAPLED IN PLACE. WHEN USING TWO OR MORE

BY EDGES OF ADJOINING BLANKETS DIRECTLY IN THE CENTER

NCDOT #5 OR #57 WASHED" STONE" INLET DO NOT USE BURLAP 19-GUAGE HARDWIRE CLOTH

WASHED STONE CONSTRUCTION SPECIFICATIONS

NCDOT #5 OR #57

1. UNIFORMLY GRADE A SHALLOW DEPRESSION APPROACHING THE INLET.

. DRIVE 5-FOOT STEEL POSTS 2 FEET INTO THE GROUND SURROUNDING THE INLET. SPACE POSTS EVENLY AROUND THE PERIMETER OF THE INLET, A MAXIMUM OF 4 FEET APART. . SURROUND THE POSTS WITH WIRE MESH HARDWARE CLOTH. SECURE THE WIRE MESH TO THE STEEL POSTS AT THE TOP, MIDDLE, AND BOTTOM. PLACING A 2-FOOT FLAP OF THE WIRE MESH UNDER THE GRAVEL FOR ANCHORING IS RECOMMENDED.

DRIVE STAKES 2

INTO THE GROUND

- F. PLACE CLEAN GRAVEL (NC DOT #5 OR #57 STONE) ON A 2:1 SLOPE WITH A HEIGHT OF 16 INCHES AROUND THE WIRE, AND SMOOTH TO AN EVEN GRADE.
- 5. ONCE THE CONTRIBUTING DRAINAGE AREA HAS BEEN STABILIZED, REMOVE ACCUMULATED SEDIMENT, AND ESTABLISH FINAL GRADING ELEVATIONS.

6. COMPACT THE AREA PROPERLY AND STABILIZED IT WITH GROUNDCOVER.

MOVE FENCE OR REMOVE

INLET PROTECTION

6/C701 SILT FENCE OUTLET N.T.S.

AROUND THE OUTLET.

FILTER OF NO. 57 WASHED STONE

(REPLACE AS -


NECESSARY)


SILT FENCE

NOTES:

1. MOVE FENCE OR REMOVE TREE IF MORE THAN 20% OF A TREE'S

- CRITICAL ROOT AREA IS UNPROTECTED. 2. ROOT PRUNE TREES TO REMAIN WHERE CONSTRUCTIONACTIVITIES
- WILL SEVER ROOTS. 3. ANY TREE ROOTS EXPOSED BY CONSTRUCTION SHALL BE SEVERED
- CLEANLY WITH A PRUNING TOOL 4. DO NOT DISPOSE OF ANY CHEMICALS OR REMOVE SOIL OUTSIDE THE LIMITS OF WORK
- 5. WHEN INSTALLING NEW LANDSCAPE PLANTS, DO NOT DRIVE EQUIPMENT UPON OR DISTURB THE SOIL WITHIN THE CRITICAL ROOT ZONE OF
- 6. SIGNAGE MUST BE PLACED ON TREE PROTECTION FENCING WITH A MINIMUM MINIMUM SPACING OF 75' O.C., TO READ "TREE PROTECTION AREA - NO TRESPASSING WITHIN THE FENCE".

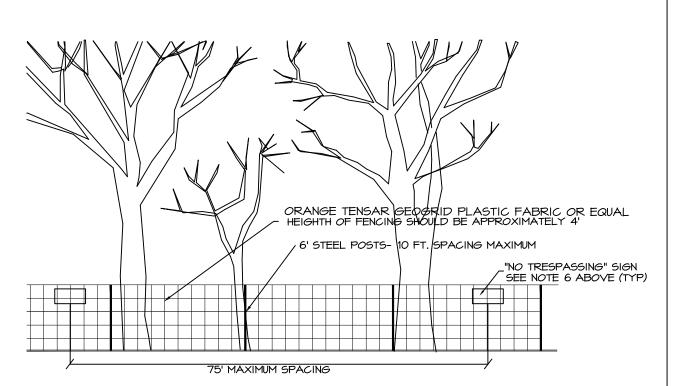

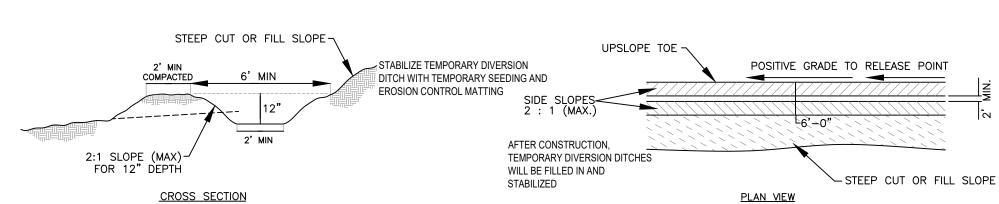

Checked JSA Date 04.20.2020

Revisions

EROSION CONTROL PLAN

Sheet Title:

**EROSION** CONTROL **DETAILS** 

Sheet Number

TREE PROTECTION FENCE DETAIL

CRITICAL ROOT ZONE.

NOT USED

**DIVERSION DITCH DETAIL** 

3.8.3 EXCEPTIONS TO SETBACK AND HEIGHT REGULATIONS.

(B)THE FOLLOWING FEATURES MAY PROJECT ABOVE THE BUILDING ENVELOPE DEFINED BY THE MAXIMUM HEIGHT LIMITATIONS AND ADDITIONAL SETBACK REQUIREMENTS CONTAINED IN RULES FOR INTERPRETATION OF TABLE 3.8-1, COLUMNS (F) AND (G), BELOW, PROVIDED THE TOWN MANAGER DETERMINES THAT SUCH FEATURES DO NOT SIGNIFICANTLY IMPAIR THE DEGREE OF SOLAR ACCESS PROVIDED ADJACENT PROPERTIES THROUGH APPLICATION OF THE APPROPRIATE SOLAR SETBACK REQUIREMENTS:

(1) CHIMNEYS, ACCESSORY RADIO OR TELEVISION ANTENNAS, FLAGPOLES, MONUMENTS, CUPOLAS, PARAPETS, DORMERS, CLOCK TOWERS OR DECORATIVE TOWERS WITH A FOOTPRINT NOT EXCEEDING TWENTY (20) PERCENT OF THE PRINCIPAL BUILDING, PROVIDED THE PROJECTION OF SUCH STRUCTURES ABOVE THE BUILDING ENVELOPE DOES NOT EXCEED FIFTEEN (15) PERCENT OF THE MAXIMUM HEIGHT LIMITATION THAT DEFINES THE PORTION OF THE BUILDING ENVELOPE PENETRATED BY SUCH STRUCTURES;

#### DESIGN NOTES:

- ALL ROOFS ARE WITHIN THE BUILDING ENVELOPE AS DEFINED BY THIS CODE, WITH PORTIONS ANGLED AT A 1:1 AND 1:1.7 SLOPE AS REQUIRED.
- ALL PARAPETS COMPLY WITH THE ABOVE REFERENCED EXCEPTION, NOT EXCEEDING 15% OF THE MAXIMUM HEIGHT LIMITATION.

#### WEST ROSEMARY STREET DESIGN GUIDELINES

THE PROJECT PROPOSES TO MEET THE GUIDELINES OF THE WEST ROSEMARY STREET

#### PUBLIC REALM


- DEVELOPMENT GUIDE IN THE FOLLOWING MANNER:
- PROVIDING IMPROVED AND CONTINUOUS SIDEWALKS ALONG ROSEMARY ST. PROVIDING STREET TREES ALONG AT LEAST 60% OF THE BLOCK LENGTH. EXISTING ROSEMARY ST LIGHTING IS ALREADY IN PLACE. ADDITIONAL LIGHTING WILL BE PROVIDED ON THE BUILDING FACADE TO CREATE A SAFE AND WELCOMING PEDESTRIAN EXPERIENCE.


PROVIDING SUFFICIENT SPACE FOR PEDESTRIANS ALONG ROSEMARY ST.

- INFRASTRUCTURE WILL BE SCREENED TO MINIMIZE VISIBILITY FROM THE PUBLIC RIGHT OF WAY.
- PARKING IS PROPOSED TO BE STRUCTURED AND BELOW BUILDING AND WILL BE SCREENED TO MINIMIZE VISIBILITY FROM THE PUBLIC RIGHT OF WAY.
- VEHICLE CURB CUTS ARE MINIMIZED SO AS TO PROVIDE SHARED ACCESS FOR ADJACENT PROPERTIES.

#### BUILDING DESIGN

- A HORIZONTAL DATUM LINE IS CREATED THROUGH THE DESIGN OF THE PODIUM PLINTH (BELOW BUILDING PARKING LEVEL). AND THROUGH A FACADE RECESS AT THE FIRST MIXED-USE LEVEL FROM LEVELS ABOVE.
- ALL BUILDING ENTRIES ARE PROVIDED OFF OF STREETS OR THE PODIUM PLINTH. PEDESTRIAN SCALE SIGNAGE AND AMENITIES WILL BE CONSIDERED AND
- ENCOURAGED. VERTICAL BAYS, VARIETY IN THE UPPER CORNICE HEIGHTS AND VISUAL BREAKS IN THE FACADE WILL BE CONSIDERED.
- WHERE POSSIBLE, UTILITY SERVICES WILL BE LOCATED BELOW GROUND OR IN THE REAR OF THE SITE TO MINIMIZE VISIBILITY FROM THE PUBLIC RIGHT OF WAY.

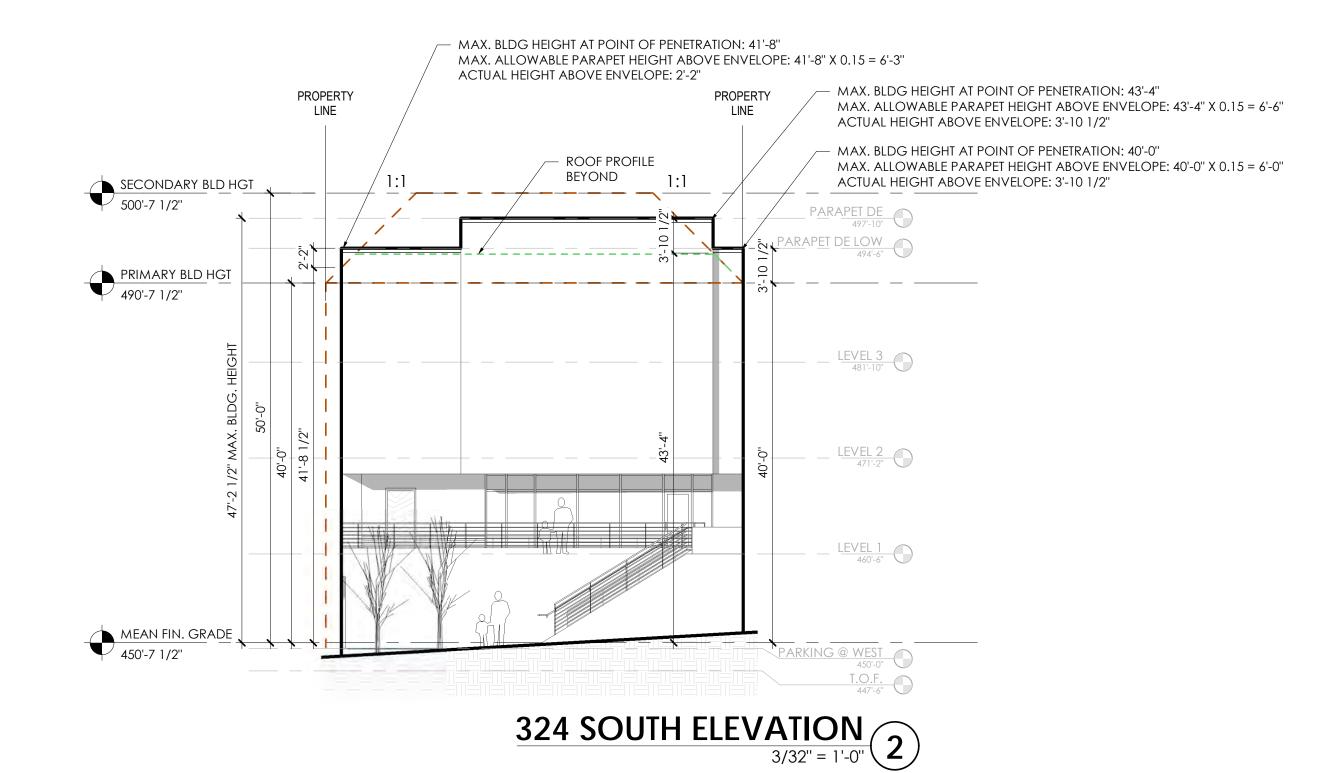

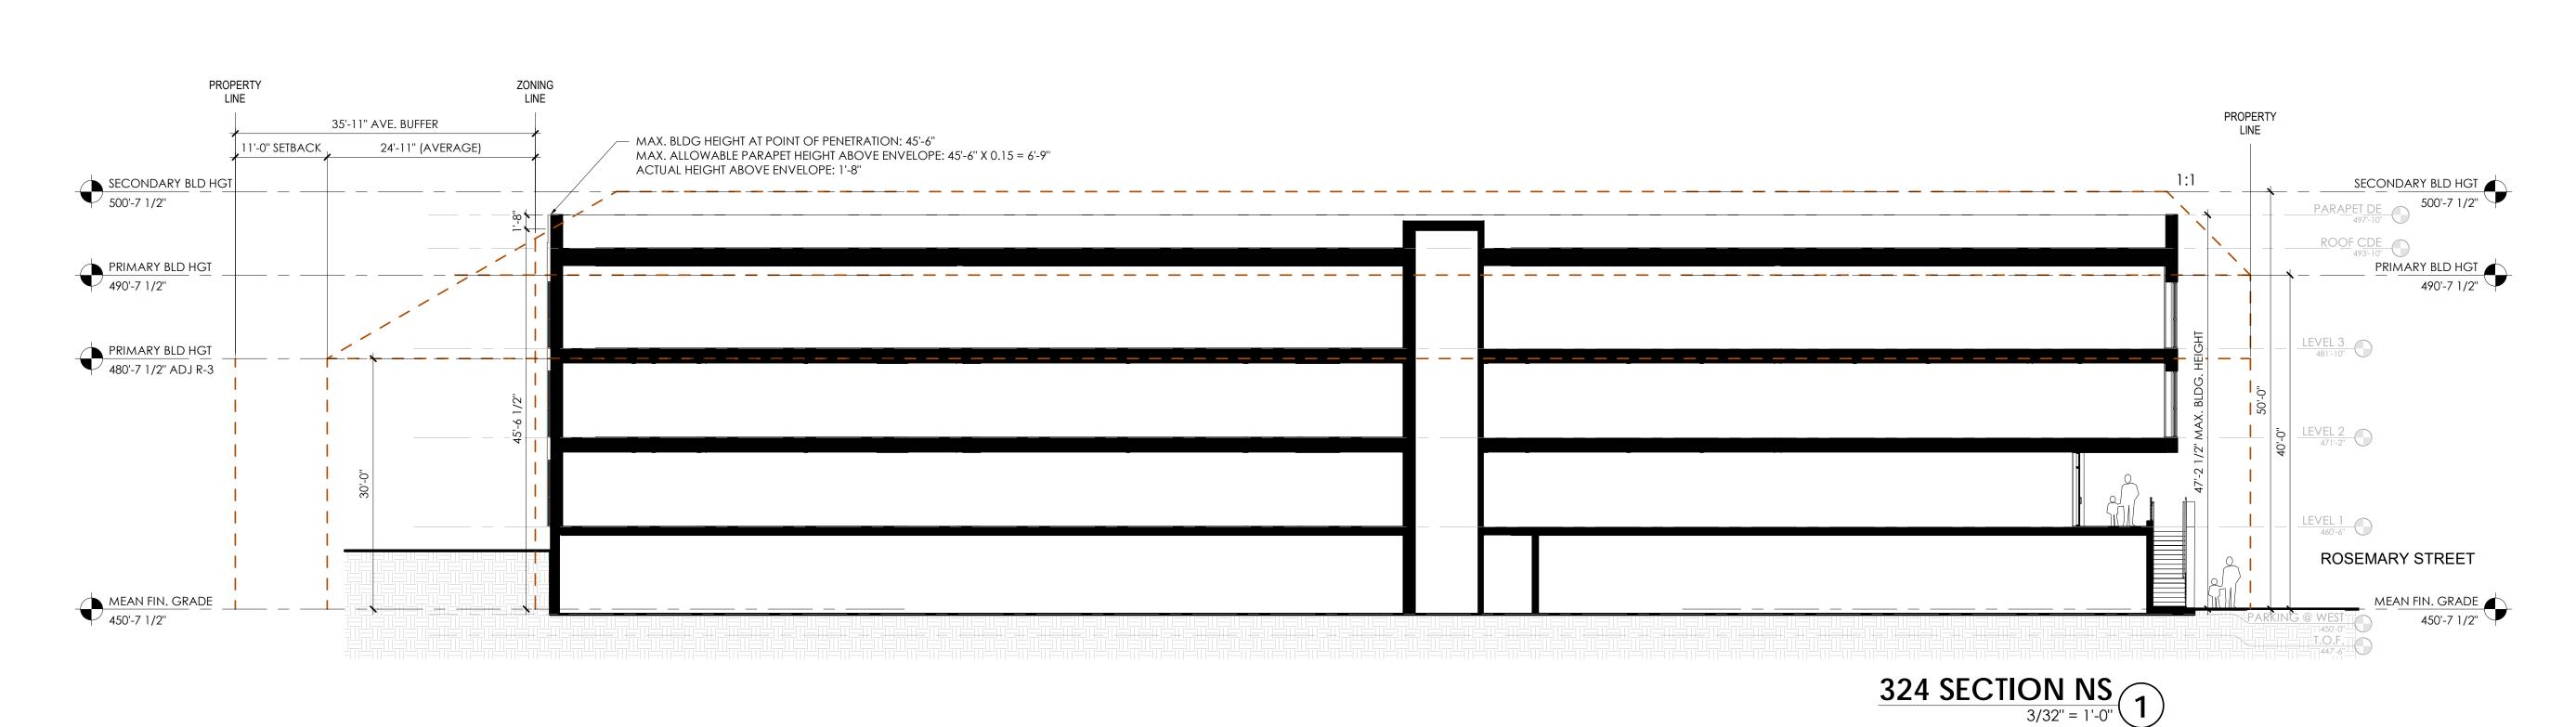

SPECIFICATIONS ARE INSTRUMENTS OF SERVICE AND
AS SUCH SHALL REMAIN THE PROPERTY OF THE ARCHITECT. THEY HAVE BEEN PREPARED FOR A SPECIFIC PROJECT AND SHALL NOT BE USED IN CONJUNCTION WITH ANY OTHER PROJECTS WITHOUT PRIOR WRITTEN PERMISSION OF THE ARCHITECT.

©-MHAworks 2020 SHEET NAME: **EXTERIOR ELEVATIONS AND** 

PHASE: PRE-DESIGN

DATE

**BUILDING ENVELOPE** 

**REVISIONS:** # DESC:

ISSUE DATE: **04/21/20** PROJECT #: **17045** DRAWN BY: **REK** 

SHEET NUMBER 324.AS1