

SPECIAL USE PERMIT APPLICATION



TOWN OF CHAPEL HILL
Planning Department
405 Martin Luther King Jr. Blvd.
Chapel Hill, NC 27514
phone (919) 969-5066 fax (919) 969-2014
www.townofchapelhill.org

Parcel Identifier Number (PIN): 9799-39-9116 and 9799-49-0235 Date February 5th, 2020

Section A: Project Information

Project Name: Christ Community Church
Property Address: 141 Erwin Road Zip Code: 27514
Use Groups (A, B, and/or C): B Existing Zoning District: R-2
Project Description: Demolish existing residence and existing day care and build one worship building of 11,420 sf with 117 parking spaces and associated stormwater controls and public improvements.

Section B: Applicant, Owner, and/or Contract Purchaser Information

Applicant Information (to whom correspondence will be mailed):

Name: Christ Community Church
Address: 1526 E. Franklin Street
City: Chapel Hill State: NC Zip Code: 27514
Phone: (919) 636-5258 Email: byron@cccpc.org

The undersigned applicant hereby certifies that, to the best of their knowledge and belief, all information supplied with this application and accurate.

Signature: *Byron J. Peterson, Jr.* Date: 2/4/2020

Owner/Contract Purchaser Information:

Owner Contract Purchaser

Name: Christ Community Church
Address: 1526 E. Franklin Street
City: Chapel Hill State: NC Zip Code: 27514
Phone: 919-636-5258 Email: byron@cccpc.org

The undersigned applicant hereby certifies that, to the best of their knowledge and belief, all information supplied with this application and accurate.

Signature: *Byron J. Peterson, Jr.* Date: 2/4/2020

Click [here](#) for application submittal instructions.



PROJECT FACT SHEET

TOWN OF CHAPEL HILL
Planning Department

Section A: Project Information

Use Type: (check/list all that apply)

Office/Institutional Residential Mixed-Use Other: PLACE OF WORSHIP

Overlay District: (check all that apply)

Historic District Neighborhood Conservation District Airport Hazard Zone

Section B: Land Area

| | | | | |
|--|---|------|---------|---------|
| Net Land Area (NLA): Area within zoning lot boundaries | | NLA= | 111,645 | sq. ft. |
| Choose one, or both, of the following (a or b), not to exceed 10% of NLA | a) Credited Street Area (total adjacent frontage) x ½ width of public right-of-way | CSA= | 11,165 | sq. ft. |
| | b) Credited Permanent Open Space (total adjacent frontage) x ½ public or dedicated open space | COS= | | sq. ft. |
| TOTAL: NLA + CSA and/or COS = Gross Land Area (not to exceed NLA + 10%) | | GLA= | 122,810 | sq. ft. |

Section C: Special Protection Areas, Land Disturbance, and Impervious Area

Special Protection Areas: (check all those that apply)

Jordan Buffer Resource Conservation District 100 Year Floodplain Watershed Protection District

| Land Disturbance | Total (sq. ft.) |
|--|-----------------|
| Area of Land Disturbance (Includes: Footprint of proposed activity plus work area envelope, staging area for materials, access/equipment paths, and all grading, including off-site clearing) | 92,400 |
| Area of Land Disturbance within RCD | None |
| Area of Land Disturbance within Jordan Buffer | None |

| Impervious Areas | Existing (sq. ft.) | Demolition (sq. ft.) | Proposed (sq. ft.) | Total (sq. ft.) |
|---|--------------------|----------------------|--------------------|-----------------|
| Impervious Surface Area (ISA) | 9,690 | 9,666 | 51,949 | 51,973 |
| Impervious Surface Ratio: Percent Impervious Surface Area of Gross Land Area (ISA/GLA)% | 7.89 | 7.87 | 42.30 | 42.32 |
| If located in Watershed Protection District, % of impervious surface on 7/1/1993 | NA | NA | NA | NA |



Section D: Dimensions

| Dimensional Unit (sq. ft.) | Existing (sq. ft.) | Demolition (sq. ft.) | Proposed (sq. ft.) | Total (sq. ft.) |
|-----------------------------------|---------------------------|-----------------------------|---------------------------|------------------------|
| Number of Buildings | Seven ; 7,725 sf | Six ; 7,646 sf | One : 11,420 sf | Two ; 11,420 sf |
| Number of Floors | One and Two | One and Two | Two | One and Two |
| Recreational Space | None | None | None | None |

| Residential Space | | | | |
|---|--------------------------|-----------------------------|---------------------------|------------------------|
| Dimensional Unit (sq. ft.) | Existing (sq.ft.) | Demolition (sq. ft.) | Proposed (sq. ft.) | Total (sq. ft.) |
| Floor Area (all floors – heated and unheated) | 4,551 | 4,551 | NONE | NONE |
| Total Square Footage of All Units | | | | |
| Total Square Footage of Affordable Units | | | | |
| Total Residential Density | | | | |
| Number of Dwelling Units | | | | |
| Number of Affordable Dwelling Units | | | | |
| Number of Single Bedroom Units | | | | |
| Number of Two Bedroom Units | | | | |
| Number of Three Bedroom Units | | | | |

| Non-Residential Space (Gross Floor Area in Square Feet) | | | | | |
|--|-----------------|-----------------|-------------------|-----------------|-----------------|
| Use Type | Existing | Proposed | Uses | Existing | Proposed |
| Commercial | 3,095 sf | 0 sf | | | |
| Restaurant | | | # of Seats | | |
| Government | | | | | |
| Institutional | | | | | |
| Medical | | | | | |
| Office | | | | | |
| Hotel | | | # of Rooms | | |
| Industrial | | | | | |
| Place of Worship | 0 sf | 11,420 sf | # of Seats | None | 250 |
| Other | | | | | |

| Dimensional Requirements | | Required by Ordinance | Existing | Proposed |
|---------------------------------|---------------------------------------|------------------------------|-----------------|--------------------|
| Setbacks (minimum) | Street | 26 | 39 | 30 (from new R/W) |
| | Interior (neighboring property lines) | 11 | 25 | 25 |
| | Solar (northern property line) | 13 | 66 | 74 |
| Height (maximum) | Primary | 29 | NA | 16 |
| | Secondary | 50 | 31 (Approx) | 50 |
| Streets | Frontages | 52 | 145 | 239 |
| | Widths | 65 | 131 | 252 |



Section F: Adjoining or Connecting Streets and Sidewalks

Note: For approval of proposed street names, contact the Engineering Department.

| Street Name | Right-of-Way Width | Pavement Width | Number of Lanes | Existing Sidewalk* | Existing Curb/Gutter |
|-----------------|--------------------|----------------|-----------------|------------------------------|------------------------------|
| Old Oxford Road | 60 | 24 | Two | <input type="checkbox"/> Yes | <input type="checkbox"/> Yes |
| Erwin Road | 60 | 30 | 2/3 | <input type="checkbox"/> Yes | <input type="checkbox"/> Yes |

List Proposed Points of Access (Ex: Number, Street Name):

*If existing sidewalks do not exist and the applicant is adding sidewalks, please provide the following information:

| Sidewalk Information | | | |
|----------------------|------------|---------|--|
| Street Names | Dimensions | Surface | Handicapped Ramps |
| Old Oxford Road | 5 ft | Conc | <input checked="" type="checkbox"/> Yes <input type="checkbox"/> No <input type="checkbox"/> N/A |
| Erwin Road | 5 ft | Conc | <input checked="" type="checkbox"/> Yes <input type="checkbox"/> No <input type="checkbox"/> N/A |

Section G: Parking Information

| Parking Spaces | Minimum | Maximum | Proposed |
|-----------------|---------|---------|----------|
| Regular Spaces | 50 | 125 | 112 |
| Handicap Spaces | 2 | 3 | 5 |
| Total Spaces | 52 | 128 | 117 |
| Loading Spaces | NA | NA | NA |
| Bicycle Spaces | 5 | 5 | 8 |
| Surface Type | Asphalt | | |

Section H: Landscape Buffers

| Location (North, South, Street, Etc.) | Minimum Width | Proposed Width | Alternate Buffer | Modify Buffer |
|---------------------------------------|---------------|----------------|---|---|
| North | 20 | 40 | <input type="checkbox"/> Yes | <input type="checkbox"/> Yes |
| South | 10 (SHARED) | 10 (SHARED) | <input type="checkbox"/> Yes | <input checked="" type="checkbox"/> Yes |
| East | 30 | 30 | <input type="checkbox"/> Yes | <input type="checkbox"/> Yes |
| West | 20 | 30/26 | <input checked="" type="checkbox"/> Yes | <input type="checkbox"/> Yes |



Section I: Land Use Intensity

Existing Zoning District: R-2
Proposed Zoning Change (if any):

| Zoning – Area – Ratio | | | Impervious Surface Thresholds | | | Minimum and Maximum Limitations | |
|-----------------------|------------------------|------------------------------|--------------------------------|---------------------------------|------------------------|--------------------------------------|--|
| Zoning District(s) | Floor Area Ratio (FAR) | Recreation Space Ratio (RSR) | Low Density Residential (0.24) | High Density Residential (0.50) | Non-Residential (0.70) | Maximum Floor Area (MFA) = FAR x GLA | Minimum Recreation Space (MSR) = RSR x GLA |
| R-2 | .093 | | | | | | |
| | | | | | | | |
| | | | | | | | |
| TOTAL | .093 | | | NA | 85,967 | 11,421 | NA |
| RCD Streamside | | 0.01 | | | | | |
| RCD Managed | | 0.019 | | | | | |
| RCD Upland | | | | | | | |

Section J: Utility Service

Check all that apply:

| | | | | |
|--------------------|---|---|--|--------------------------------|
| Water | <input checked="" type="checkbox"/> OWASA | <input type="checkbox"/> Individual Well | <input type="checkbox"/> Community Well | <input type="checkbox"/> Other |
| Sewer | <input checked="" type="checkbox"/> OWASA | <input type="checkbox"/> Individual Septic Tank | <input type="checkbox"/> Community Package Plant | <input type="checkbox"/> Other |
| Electrical | <input checked="" type="checkbox"/> Underground | <input type="checkbox"/> Above Ground | | |
| Telephone | <input checked="" type="checkbox"/> Underground | <input type="checkbox"/> Above Ground | | |
| Solid Waste | <input checked="" type="checkbox"/> Town | <input type="checkbox"/> Private | | |



**SPECIAL USE PERMIT APPLICATION
SUBMITTAL REQUIREMENTS
TOWN OF CHAPEL HILL
Planning Department**

The following must accompany your application. Failure to do so will result in your application being considered incomplete. For assistance with this application, please contact the Chapel Hill Planning Department (Planning) at (919) 969-5066 or at planning@townofchapelhill.org.

| | | | |
|----|---|----------------|---------------------------------------|
| X | Application fee (including Engineering Review fee) (refer to fee schedule) | Amount Paid \$ | <input type="text" value="8,924.40"/> |
| X | Pre-application meeting –with appropriate staff | | |
| X | Digital Files – provide digital files of all plans and documents | | |
| X | Recorded Plat or Deed of Property | | |
| X | Project Fact Sheet | | |
| X | Traffic Impact Statement – completed by Town’s consultant (or exemption) | | |
| X | Description of Public Art Proposal | | |
| X | Statement of Justification | | |
| X | Response to Community Design Commission and Town Council Concept Plan comments | | |
| NA | Affordable Housing Proposal, if applicable | | |
| NA | Provide existing Special Use Permit, if Modification | | |
| X | Mailing list of owners of property within 1,000 feet perimeter of subject property (see GIS notification tool) | | |
| X | Mailing fee for above mailing list (mailing fee is double due to 2 mailings) | Amount Paid \$ | <input type="text"/> |
| X | Written Narrative describing the proposal | | |
| X | Resource Conservation District, Floodplain, & Jordan Buffers Determination – necessary for all submittals | | |
| NA | Jurisdictional Wetland Determination – if applicable | | |
| NA | Resource Conservation District Encroachment Exemption or Variance (determined by Planning) | | |
| NA | Jordan Buffer Authorization Certificate or Mitigation Plan Approval (determined by Planning) | | |
| X | Reduced Site Plan Set (reduced to 8.5” x 11”) | | |

Stormwater Impact Statement (1 copy to be submitted)

- a) Written narrative describing existing & proposed conditions, anticipated stormwater impacts and management structures and strategies to mitigate impacts
- b) Description of land uses and area (in square footage)
- c) Existing and proposed impervious surface area in square feet for all subareas and project area
- d) Ground cover and uses information
- e) Soil information (classification, infiltration rates, depth to groundwater and bedrock)
- f) Time of concentration calculations and assumptions
- g) Topography (2-foot contours)
- h) Pertinent on-site and off-site drainage conditions
- i) Upstream and/or downstream volumes
- j) Discharges and velocities
- k) Backwater elevations and effects on existing drainage conveyance facilities
- l) Location of jurisdictional wetlands and regulatory FEMA Special Flood Hazard Areas
- m) Water quality volume calculations
- n) Drainage areas and sub-areas delineated
- o) Peak discharge calculations and rates (1, 2, and 25-year storms)
- p) Hydrographs for pre- & post-development without mitigation, post-development with mitigation
- q) Volume calculations and documentation of retention for 2-year storm



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- r) 85% TSS removal for post-development stormwater runoff
- s) Nutrient loading calculations
- t) BMP sizing calculations
- u) Pipe sizing calculations and schedule (include HGL & EGL calculations and profiles)

Plan Sets (10 copies to be submitted no larger than 24" x 36")

Plans should be legible and clearly drawn. All plan set sheets should include the following:

- Project Name
- Legend
- Labels
- North Arrow (North oriented toward top of page)
- Property boundaries with bearing and distances
- Scale (Engineering), denoted graphically and numerically
- Setbacks
- Streams, RCD Boundary, Jordan Riparian Buffer Boundary, Floodplain, and Wetlands Boundary, where applicable
- Revision dates and professional seals and signatures, as applicable

Cover Sheet

- a) Include Project Name, Project fact information, PIN, and Design Team

Area Map

- a) Project name, applicant, contact information, location, PIN, & legend
- b) Dedicated open space, parks, greenways
- c) Overlay Districts, if applicable
- d) Property lines, zoning district boundaries, land uses, project names of site and surrounding properties, significant buildings, corporate limit lines
- e) Existing roads (public & private), rights-of-way, sidewalks, driveways, vehicular parking areas, bicycle parking, handicapped parking, street names
- f) 1,000' notification boundary

Existing Conditions Plan

- a) Slopes, soils, environmental constraints, existing vegetation, and any existing land features
- b) Location of all existing structures and uses
- c) Existing property line and right-of-way lines
- d) Existing utilities & easements including location & sizes of water, sewer, electrical, & drainage lines
- e) Nearest fire hydrants
- f) Nearest bus shelters and transit facilities
- g) Existing topography at minimum 2-foot intervals and finished grade
- h) Natural drainage features & water bodies, floodways, floodplain, RCD, Jordan Buffers & Watershed boundaries



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Detailed Site Plan

- a) Existing and proposed building locations
- b) Description & analysis of adjacent land uses, roads, topography, soils, drainage patterns, environmental constraints, features, existing vegetation, vistas (on and off-site)
- c) Location, arrangement, & dimension of vehicular parking, width of aisles and bays, angle of parking, number of spaces, handicapped parking, bicycle parking. Typical pavement sections & surface type.
- d) Location of existing and proposed fire hydrants
- e) Location and dimension of all vehicle entrances, exits, and drives
- f) Dimensioned street cross-sections and rights-of-way widths
- g) Pavement and curb & gutter construction details
- h) Dimensioned sidewalk and tree lawn cross sections
- i) Proposed transit improvements including bus pull-off and/or bus shelter
- j) Required landscape buffers (or proposed alternate/modified buffers)
- k) Required recreation area/space (including written statement of recreation plans)
- l) Refuse collection facilities (existing and proposed) or shared dumpster agreement
- m) Construction parking, staging, storage area, and construction trailer location
- n) Sight distance triangles at intersections
- o) Proposed location of street lights and underground utility lines and/or conduit lines to be installed
- p) Easements
- q) Clearing and construction limits
- r) Traffic Calming Plan – detailed construction designs of devices proposed & associated sign & marking plan

Stormwater Management Plan

- a) Topography (2-foot contours)
- b) Existing drainage conditions
- c) RCD and Jordan Riparian Buffer delineation and boundary (perennial & intermittent streams; note ephemeral streams on site)
- d) Proposed drainage and stormwater conditions
- e) Drainage conveyance system (piping)
- f) Roof drains
- g) Easements
- h) BMP plans, dimensions, details, and cross-sections
- i) Planting and stabilization plans and specifications

Landscape Protection Plan

- a) Rare, specimen, and significant tree survey within 50 feet of construction area
- b) Rare and specimen tree critical root zones
- c) Rare and specimen trees proposed to be removed
- d) Certified arborist tree evaluation, if applicable
- e) Significant tree stand survey
- f) Clearing limit line
- g) Proposed tree protection/silt fence location
- h) Pre-construction/demolition conference note
- i) Landscape protection supervisor note
- j) Existing and proposed tree canopy calculations, if applicable



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Planting Plan

- a) Dimensioned and labeled perimeter buffers
- b) Off-site buffer easement, if applicable
- c) Landscape buffer and parking lot planting plan (including planting strip between parking and building, entryway planting, and 35% shading requirement)

Steep Slope Plan

- a) Classify and quantify slopes 0-10%, 10-15%, 15-25%, and 25% and greater
- b) Show and quantify areas of disturbance in each slope category
- c) Provide/show specialized site design and construction techniques

Grading and Erosion Control Plan

- a) Topography (2-foot contours)
- b) Limits of Disturbance
- c) Pertinent off-site drainage features
- d) Existing and proposed impervious surface tallies

Streetscape Plan, if applicable

- a) Public right-of-way existing conditions plan
- b) Streetscape demolition plan
- c) Streetscape proposed improvement plan
- d) Streetscape proposed utility plan and details
- e) Streetscape proposed pavement/sidewalk details
- f) Streetscape proposed furnishing details
- g) Streetscape proposed lighting detail

Solid Waste Plan

- a) Preliminary Solid Waste Management Plan
- b) Existing and proposed dumpster pads
- c) Proposed dumpster pad layout design
- d) Proposed heavy duty pavement locations and pavement construction detail
- e) Preliminary shared dumpster agreement, if applicable



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Construction Management Plan

- a) Construction trailer location
- b) Location of construction personnel parking and construction equipment parking
- c) Location and size of staging and materials storage area
- d) Description of emergency vehicle access to and around project site during construction
- e) Delivery truck routes shown or noted on plan sheets

Energy Management Plan

- a) Description of how project will be 20% more energy efficient than ASHRAE standards
- b) Description of utilization of sustainable forms of energy (Solar, Wind, Hydroelectric, and Biofuels)
- c) Participation in NC GreenPower program
- d) Description of how project will ensure indoor air quality, adequate access to natural lighting, and allow for proposed utilization of sustainable energy
- e) Description of how project will maintain commitment to energy efficiency and reduced carbon footprint over time
- f) Description of how the project's Transportation Management Plan will support efforts to reduce energy consumption as it affects the community

Exterior Elevations

- a) An outline of each elevation of the building, including the finished grade line along the foundation (height of building measured from mean natural grade)



CHRIST COMMUNITY CHURCH

December 12th, 2019
Revised March 5th, 2020

Findings of Fact and Requests by the Applicant to Town Council

- A. **Project:** Christ Community Church
- B. **Location:** 141 Erwin Road (Corner of Old Oxford and Erwin Roads)
- C. **Type of Application:** Special Use Permit
- D. **Summary of Project:** On the 2.56-acre parcel, the existing residential buildings and outbuildings will be removed and recycled to the extent practicable. A new 11,420 Church, consisting of a worship area, fellowship area, classrooms, and Church office is proposed. The site will include on-site parking, extensive stormwater controls, existing buffer trees and new plantings and fencing, and widening, curb and sidewalk along both Old Oxford and Erwin Road frontages. There will be no use on the site other than a worship facility.

E. **Findings of Fact:**

1. ***That the use or development is located, designed and proposed to be operated so as to maintain or promote the public health, safety and general welfare.***

This application is for a worship facility with Sunday services; there will be a very small office staff of 1 to 3 persons during weekdays. There will be no daycare or school use.

The Traffic Study shows there will be no change in level of service due to Christ Community Church. The Traffic Study recommends two (2) entrances, widening of Erwin Road with bike lane, and widening of Old Oxford along with public sidewalks along both streets. The SUP plans for the Church incorporate all these recommendations.

An extensive underground Stormwater treatment and detention system, located under the parking lot, will control runoff rate and treat runoff to meet and exceed Town standards.

When Concept Plans were submitted for this project, several neighbors predicted that Christ Community Church would be a “good neighbor”. The Church is fully committed to realizing this expectation.

2. ***That the use or development complies with all required regulations and standards of this chapter, including all applicable provisions of Articles 3 and 5, the applicable specific standards contained in the supplemental use regulations (Article 6), and with all other applicable regulations.***

This project will comply with all TOCH regulations and standards. As discussed later in this statement, the Church requests Council permission to retain the 50-year-old, small outdoor storage shed with dirt floor in the southwest portion of the site to store yard equipment, so as to be able to maintain its 2.8-acre campus. Along its southern boundary with the proposed Summit Hospitality Group project, Town Council asked Christ Community Church to “work with” the adjoining project during the concept design process. This cooperation has resulted in requests by the Applicant to Town Council for a modified shared buffer, for the adjustment of the property line between the two projects, and for a fire lane connection between the two properties.

Connecting the Riches of Christ to the Realities of Life

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CHRIST COMMUNITY CHURCH

December 12th, 2019
Revised March 5th, 2020

3. That the use or development is located, designed and proposed to be operated so as to maintain or enhance the value of contiguous property, or that the use or development is a public necessity:

At the Concept stage, neighbors expressed concern about stormwater runoff, traffic and building height and buffering. The submitted SUP plans and details for Christ Community Church address each of those concerns:

- Larger areas of existing hardwoods and existing tree areas will be left undisturbed on the site as compared to the Concept Plan.
- Treed buffers, planted buffers and fencing have been increased since the Concept Pan.
- Impervious surface has been reduced by about 10% since the Concept Plan.
- Extensive stormwater controls and curbing will be installed to address any offsite stormwater impacts.
- The Traffic Study shows no traffic impact.
- Building height has been reduced. This, along with the extensive existing trees to be saved, will result in the Church being well-screened from neighbors.

4. That the use or development conforms with the general plans for the physical development of the town as embodied in this appendix and in the Comprehensive Plan.

This project will comply with all zoning standards for the existing R2 Zoning.

With regard to Town Strategic Goals for 2020-2022, the SUP plans for Christ Community Church fully support the three (3) Council objectives for Environmental Stewardship:

- The 7,646 SF of existing buildings to be removed will be recycled to the maximum extent possible.
- Extensive stands of existing hardwoods and red cedars on site will be permanently preserved.
- EV stations will be built as part of initial construction, with provisions made for an additional 20 EV stations which could be connected when circumstances warrant.
- Extensive stormwater controls will protect neighbors, waterways, and preserve ecosystems.
- Absolutely no stream buffer, RCD, wetland or any other environmentally sensitive areas will be impacted by this development.

The Council Goal of increased connectivity will be achieved because of the extensive proposed public and private sidewalk system, the proposed bike lane on Erwin Road and the proposed covered bike spaces on site.

Although meeting the spiritual needs of Chapel Hill residents may not be a “stated” Council Goal, Christ Community Church has held services for over a dozen years at a couple different locations in Chapel Hill. The Church is excited about the possibility of maintaining and enhancing its spiritual presence in the local community with its own, permanent worship building, and respectfully asks for the support and confidence of the Chapel Hill Town Council to approve this SUP application.

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CHRIST COMMUNITY CHURCH

III

December 12th, 2019
Revised March 5th, 2020

F. Requests by the Applicant to Town Council for Modifications:

1. **Modified Buffer:** The existing 50-year-old outdoor storage shed, buffered by an existing 8' opaque wood fence and existing large pine and hardwood trees, is 26 feet from the property line and encroaches 4.8 feet into the required buffer. The Church respectfully asks that the existing 26-foot buffer, the existing mature trees and the existing fence be the approved by Council as an Alternate, Modified Buffer so that this shed can remain.
2. **Summit Hospitality Group Project:** The Church has met extensively with representatives of the Summit project over the past 16 months. Christ Community Church and Summit have agreed to cooperate and coordinate in the areas of the street widening for Erwin Road, stormwater, fire lane, and tree save areas along the southern boundary. The plans show a proposed adjustment to the property line between the two projects, providing a fire lane connection for Summit and, in particular, to provide a full-width shared Modified landscape buffer between Christ Community Church and the Summit project. The Church asks that Town Council recognize and support the extensive cooperation between the two projects by approving an SUP stipulation which modifies regulations to allow the Town Manager to approve all documents related to (a) adjusting the existing property line (LUMO article 4.5.5(b)(1), and (b) providing a Modified, shared landscape buffer (LUMO article 5.6.5), where the other half of the shared buffer will be provided at the time the adjacent property is developed.
3. **Cupola Height:** The overall height of the building and roof cupola have each been reduced in order to conform with LUMO article 3.8.3(b)(1). While the maximum height of the cupola as designed is within the limits defined by LUMO (15% maximum above core building height at vertical intersection of roof element and building envelope), the leading edge of the shortened cupola (facing Erwin Road) is now 9-³/₄" above the maximum height allowed. Since the cupola cannot be further shortened without eliminating windows on (2) of the 4 sides, and the cupola as designed is an important element of an architectural expression that has been generally well-received by neighbors, CDC, and the Town Council, we respectfully request that Town Council approve an SUP stipulation which modifies regulations to allow the height of the cupola to be approved as designed.
4. **Timetable:** Christ Community Church is very hopeful that an SUP for this important project will gain approval from the Town Council in the first quarter of 2020. Immediately after obtaining an SUP, the church will close on the property and have full title to the land, and will be able to alter the property line as described above. After purchase and closing, the Church must embark on a second fund raising campaign in order to acquire the money to design and build the 11,420 SF structure, the private improvements, and the proposed extensive public improvements.

Because of the need for fundraising, the Church respectfully asks Council to approve an SUP Stipulation that will allow the Town Manager to approve a detailed Phasing Plan so that construction must begin within five (5) years after SUP approval and construction must be complete within eight (8) years after SUP approval, subject to all other provisions of LUMO with respect to time limits and time extensions.

Connecting the Riches of Christ to the Realities of Life

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FIRM: C-347

A) Comments from Community Design Commission on January 22, 2019

| <u>Comment</u> | <u>Response</u> |
|--|--|
| <u>Susanna Dancy</u> | |
| 1) Traffic concerns are outside our preview..... | We Agree |
| 2) Building at the corner? | Building moved closer to corner |
| 3) Not concerned about the height of the building, because churches are landmark/civic structures | Acknowledge |
| 4) I like the parking in the back, and the layout for connections..... | We Agree |
| 5) RI/RO – may need full intersection..... | RI/RO eliminated; full intersection now proposed |

Lucy Carol Davis

| | |
|---|-------------|
| 1) I like it | We Agree |
| 2) Don't see the height of the building as an issue..... | Acknowledge |
| 3) I like the landscape along the road | We Agree |
| 4) I like the parking in the back; like porches – break up height | We Agree |
| 5) I don't see rush hour traffic as a factor | Acknowledge |
| 6) So far, I like what I see | Acknowledge |

Chris Berndt

| | |
|--|------------------------------------|
| 1) Clarification: Is the height 56 feet at the rear, and 40-something at the front? | Yes 56ft rear; about 43ft at front |
| 2) I like the design; it fits with the topography and the neighborhood | We Agree |

Chris Berndt (continued)

- 3) Biggest concern is storm water..... Acknowledge
- 4) Have you considered pervious parking? Poorly drained soils on site will not allow pervious paving to work
- 5) Need details of second building Second building has been eliminated
- 6) Access points: Will main access be from Erwin Road? Yes
Prevent being a "cut-thru" to Marriott..... Traffic Study allows only emergency Connection

Megan Patnaik

- 1) I like the proposed use of the property We Agree
- 2) I like the pedestrian-friendly rear of the building. We Agree
- 3) Can better pedestrian access be added to the front? Good pedestrian access has been added from Erwin sidewalk to the Church

Ted Hoskins

- 1) I like the design We Agree
- 2) I'm not troubled by the height of the building; Acknowledge
it's consistent with a civic use
- 3) I am intrigued by Chris' comment about access See response to Chris Berndt
- 4) Might you improve drainage beyond the We have designed the storm detention to
minimum requirement as a trade for R3 rezoning? Exceed Town Standards

Polly Van De Velde

- 1) I like the design We Agree
- 2) Many trees removed We have increased trees to be saved along all four sides of the site
- 3) Can you implement "rain gardens"? We tried, but rain gardens will not Provide enough storage to reduce Runoff to below pre-development levels

- 4) Can you use cross- parking ? Town Traffic Study prohibits cross-parking
- 5) Regarding Phase 2: I have a little problem Phase 2 has been eliminated
approving something without seeing it
- 6) Right In/Right Out a concern RI/RO eliminated

Susan Lyons

- 1) I really like appearance of the building; a really good fit..... We Agree
- 2) I'm concerned about the storm water We have designed the storm detention
To exceed Town Standards
- 3) Trees in the buffer area We have increased trees to be saved
Along all four sides of the site

Voulker (Chairman)

- 1) I really like the building Acknowledge
- 2) I'm concerned about the parking – the runoff from The storm system will mitigate storm
Stormwater – so I'd like to see that improved with flows to a greater extent than Town
Measures beyond the minimum Standards
- 3) If Phase 2 is harmonized with this present design, Phase 2 has been eliminated
then I can foresee a great project
- 4) As for future use, I think we need to take what Thank you
has been presented on good faith
- 5) Want to see buffer replanted..... We have saved many existing trees
in the bufferyards.

FIRM: C-347

B) Comments from Town Council on March 20, 2019

Comment

Response

Michael Parker

- | | |
|---|--|
| 1) Not enough parking, but too much Impervious..... | We have increased the parking and reduced the impervious surface area |
| 2) Move building? | We moved the building north |
| 3) When will second building be built? | We have dropped the second building |
| 4) Study entrance off Erwin | The Traffic Study recommends a full intersection off Erwin and we agree. |
| 5) Is this project eligible for Conditional Zoning? | No, it is not eligible |

Hongbin Gu

- | | |
|--|--|
| 1) For rezoning, must make the case | There is no rezoning involved |
| 2) Can building fit into R2? | Yes, that is exactly what we have done. |
| 3) Take building one step at a time; wait until R3 needed..... | Yes, we will wait until additional room is needed. |
| 4) Parking and flood issues | We have improved parking based on Council suggestions and we propose a stormwater solution which will go above and beyond Town Standards |

Alan Baunsi

- | | |
|---|--|
| 1) Like design of building | We Agree |
| 2) Do simple first | We Agree |
| 3) How many attend services? | Currently about 165; the worship area in the proposed building will seat 250 |
| 4) What will second building look like? | Second building has been dropped. |

Karen Stegman

- 1) Parking, need tree preservation..... We have increased parking, saved trees on all four (4) sides and have reduced impervious surface.
- 2) Check impervious See answer to #1
- 3) Large buffer to neighborhood We have saved trees and increased the buffer to the neighborhood
- 4) Need Traffic Study for volumes Traffic Study shows no traffic impact from this project
- 5) Like idea of neighborhood access to the playground We Agree.

Nancy Oates

- 1) This may be the best project for the neighborhood..... We Agree.
- 2) Curve on Erwin Erwin Road will be widened; the curve is completely off our site
- 3) Can hotel be overflow? The Traffic Study prohibits any shared parking
- 4) Like the design We Agree
- 5) Build Phase 2 when it's needed. Build what you can now..... We Agree.

Pam Heminger

- 1) Continue dealing with neighbors We agree and are doing so.
- 2) Church will be a good neighbor We Agree.
- 3) Traffic Study needed We Agree.
- 4) Impervious needs to be looked at Impervious surface has been reduced.
- 5) Concerned about second building Second building has been dropped

Pam Heminger (Continued)

- 6) Two entrances The Traffic Study recommends two (2) full entrances and we agree
- 7) Work with Marriott about parking We are cooperating about emergency Access, but the Traffic Study prohibits Cross-parking

Special Use Permit Narrative: Energy Management Plan

This project will reduce energy consumption in a number of important ways:

Solar orientation: there is a balcony and large roof overhang along the SW side of the structure that will serve to minimize heat gain in the summer months, while allowing for solar penetration/ heat gain in the winter months, thus reducing energy use year round.

Building siting: locating the ground floor below the finished grade for entire NE edge of the building will serve to provide significant insulation value, reducing energy required for heating and cooling.

Daylighting: large windows with insulating glazing combined with proper shading will be used to provide access to natural light while reducing solar heat gain, thus reducing costs associated with artificial lighting.

Construction- transportation: to the greatest extent feasible, the church will seek to use locally-sourced construction materials for this project in order to reduce energy consumption required for transport.

Construction- materials: to the greatest extent feasible, the church will seek to use sustainably-sourced and recycled building and finish materials, thus reducing latent energy costs.

HVAC and Lighting: mechanical and electrical systems will be designed to provide a minimum of 10% energy savings in excess of the standards required by ASHRAE 90.1 (2010). Strategies will include high-efficiency mechanical systems, generous building insulation, and maximum use of LED lighting fixtures.



CHRIST COMMUNITY CHURCH


September 6, 2019

Special Use Permit Narrative: Public Art Program

The applicant seeks to provide a worship facility that will be attractive, sensitive to existing landforms and neighboring structures, and welcoming to visitors by car, bike, or foot. No additional public art is currently proposed for the project, but we do believe that the massing and detailing of the building itself will project an iconography that is aesthetically pleasing and appropriate to its location along the Erwin Road corridor.

Connecting the Riches of Christ to the Realities of Life

P.O. Box 2314 • Chapel Hill, NC 27515 • www.cccpca.org

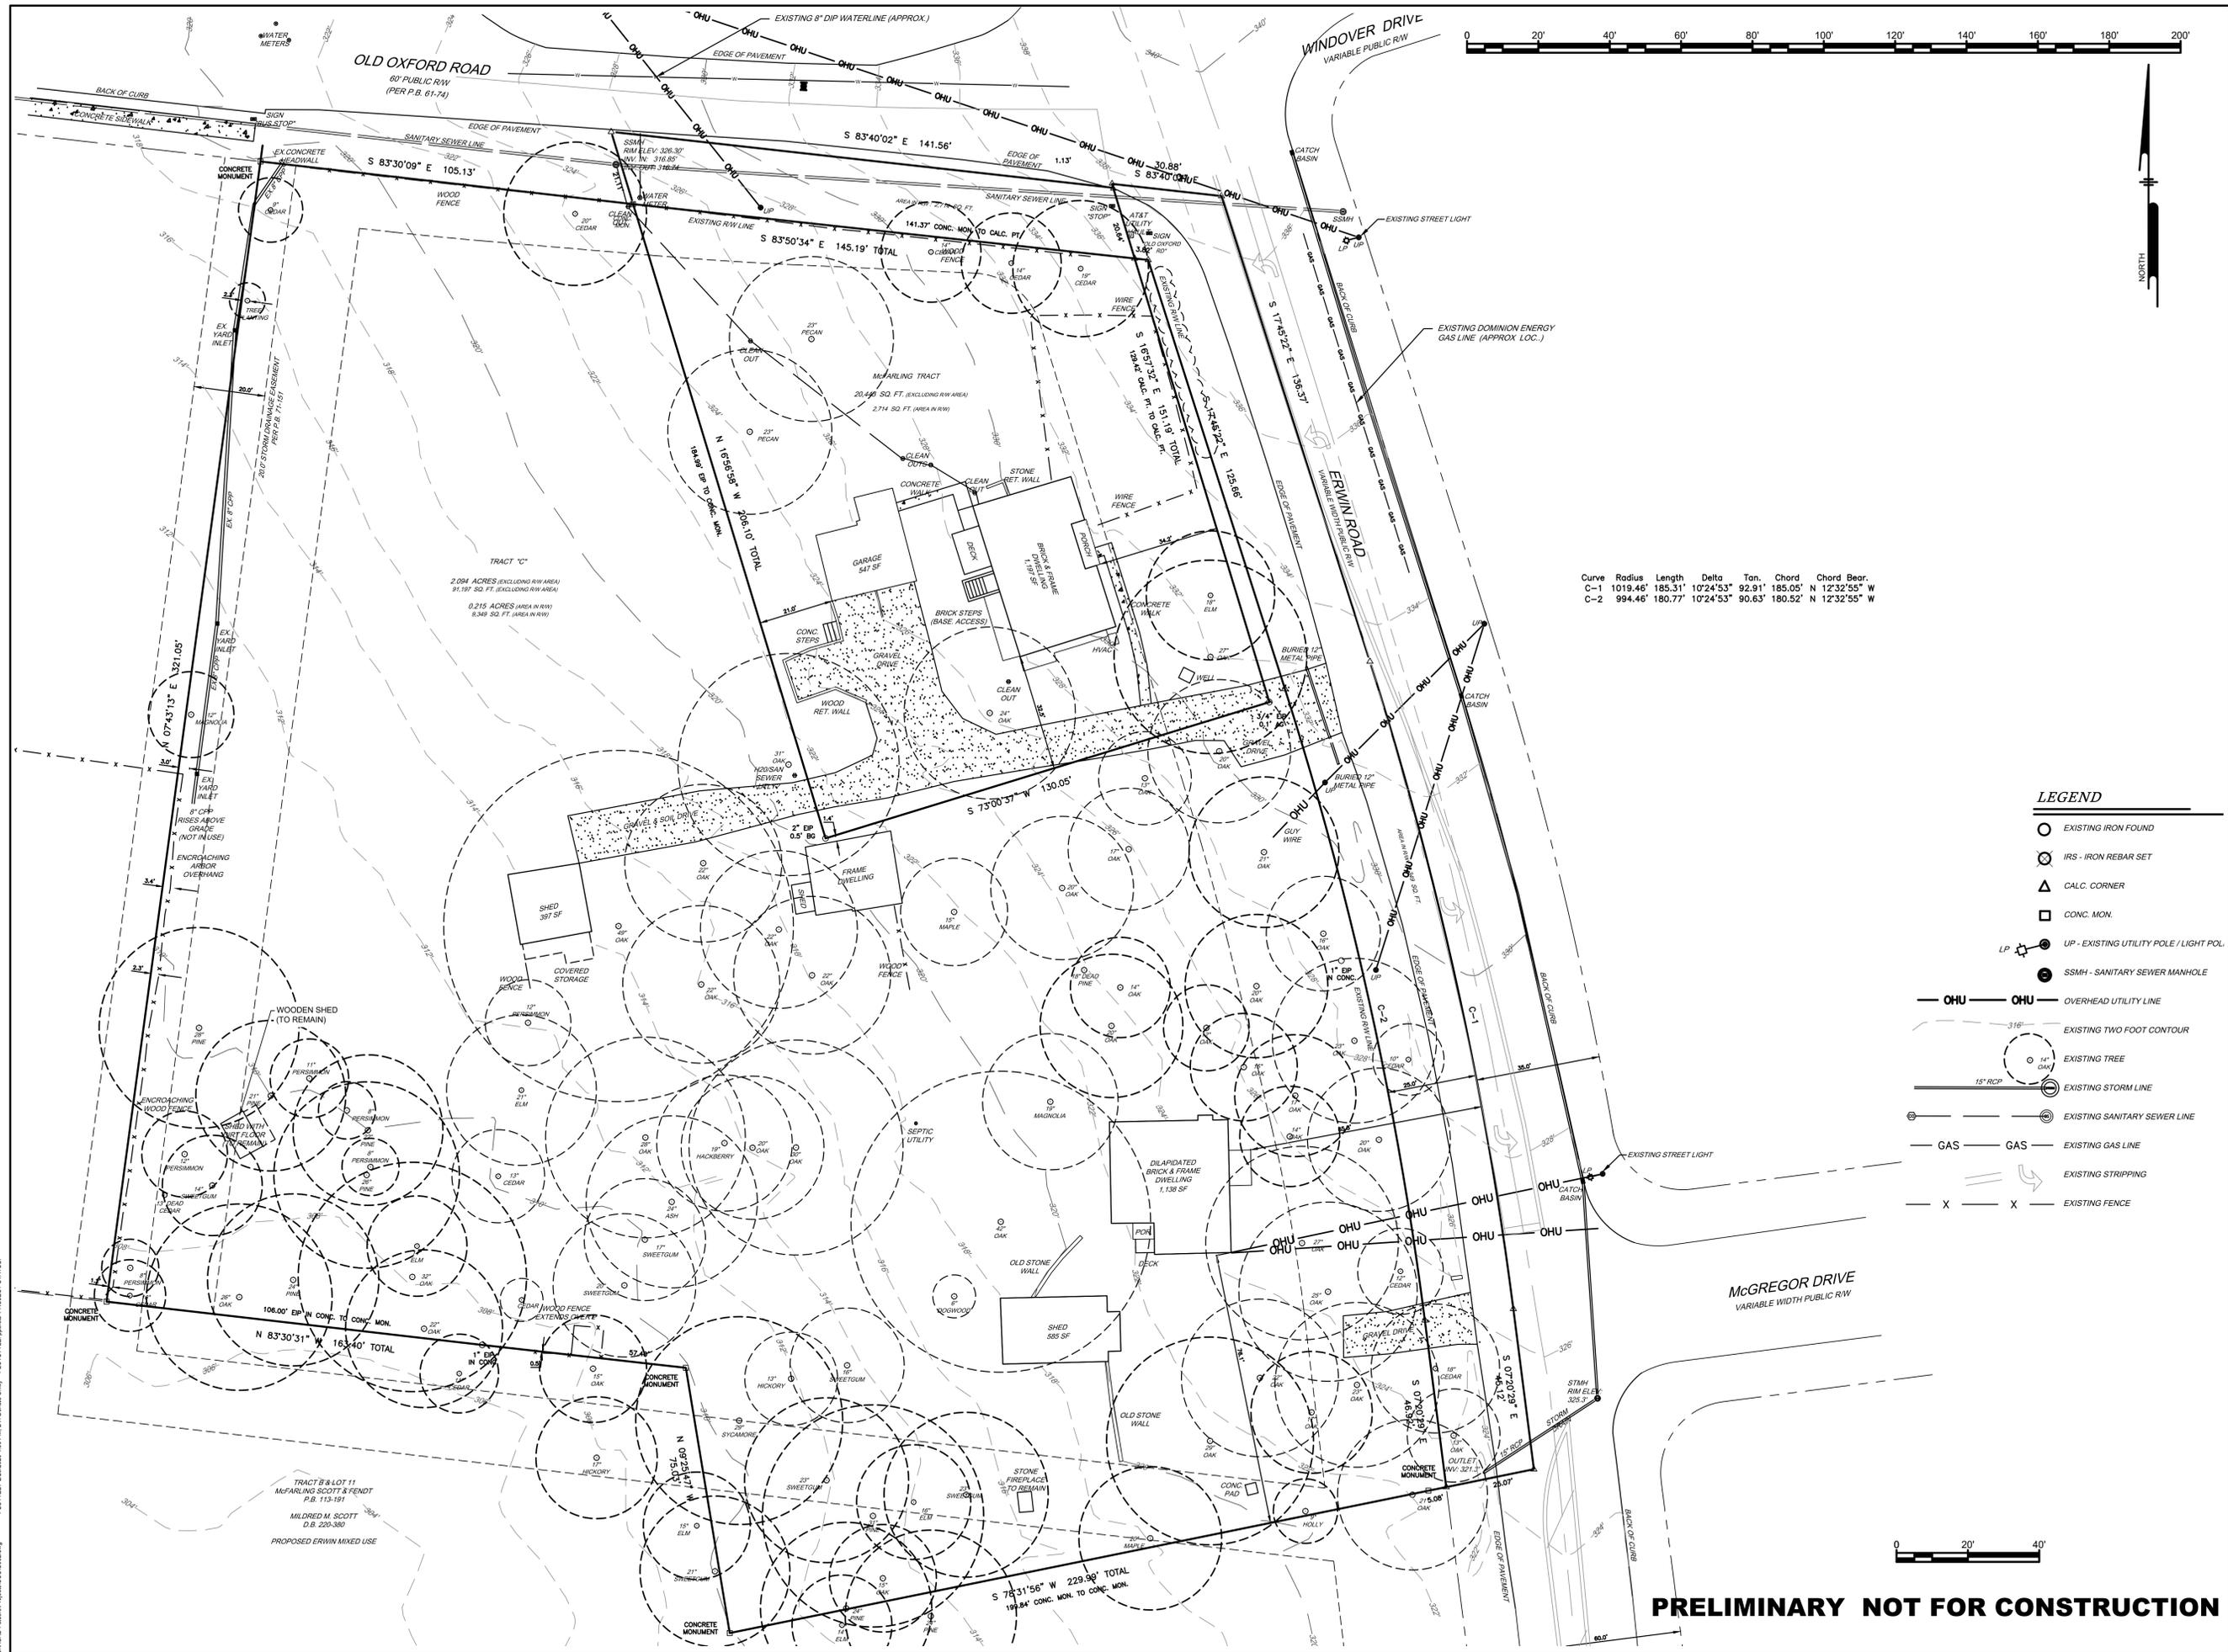

| Curve | Radius | Length | Delta | Tan. Chord | Chord Bear. |
|-------|----------|---------|-----------|------------|-----------------------|
| C-1 | 1019.46' | 185.31' | 10°24'53" | 92.91' | 185.05' N 12°32'55" W |
| C-2 | 994.46' | 180.77' | 10°24'53" | 90.63' | 180.52' N 12°32'55" W |

LEGEND

- EXISTING IRON FOUND
- ⊗ IRS - IRON REBAR SET
- △ CALC. CORNER
- CONC. MON.
- LP ○ EXISTING UTILITY POLE / LIGHT POL.
- SSMH - SANITARY SEWER MANHOLE
- OHU — OHU — OVERHEAD UTILITY LINE
- EXISTING TWO FOOT CONTOUR
- EXISTING TREE
- EXISTING STORM LINE
- EXISTING SANITARY SEWER LINE
- GAS --- EXISTING GAS LINE
- ⇄ EXISTING STRIPPING
- X — X — EXISTING FENCE

ALL DIMENSIONS MUST BE VERIFIED BY CONTRACTOR AND OWNER MUST BE NOTIFIED OF ANY DISCREPANCIES BEFORE PROCEEDING WITH WORK

**CHRIST COMMUNITY CHURCH
EXISTING CONDITIONS PLAN**

141 ERWIN ROAD, CHAPEL HILL, N.C. 27514
 PIN# 9799-39-9116 AND 9799-49-0235
 APPLICANT:
 CHRIST COMMUNITY CHURCH
 1528 E. FRANKLIN STREET, SUITE 201
 CHAPEL HILL, N.C. 27514

| # | DATE | NO. | REVISIONS | BY |
|---|------------|-----|---------------------------|----|
| 1 | 11-17-2019 | | SUBMITTAL #1 COMMENTS | |
| 2 | 11-17-2019 | | OWASA 11/13/2019 COMMENTS | |
| 3 | 1-17-2020 | | SUBMITTAL #2 COMMENTS | |
| 4 | 2-9-2020 | | PROPERTY LINE SWAP | |
| 5 | 2-9-2020 | | TOWN COMMENTS | |
| 6 | 2/26/2020 | | NCDOT AND TOWN COMMENTS | |


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| | |
|---------------|-----------|
| PROJECT | 401801 |
| DATE | 8/28/2019 |
| DRAWING SCALE | 1" = 20' |
| DRAWN BY | DC |
| APPROVED BY | PP |

C002
SHEET 3 OF 16

PRELIMINARY NOT FOR CONSTRUCTION

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TREE SAVE NOTE:
STANDS OF EXISTING HARDWOOD AND CEDAR TREES WILL BE PRESERVED AS SHOWN HERON. THESE STANDS OF EXISTING TREES WILL PRESERVE CANOPY OF OVER 33% OF THE SITE. CANOPY TREES WILL BE REPLACED AS SHOWN ON SHEET L001 TO ACHIEVE GREATER THAN 40% CANOPY COVERAGE.

DEMOLITION NOTES:
1. EXISTING DWELLINGS / STORAGE BUILDINGS ARE ABOUT 60 YEARS OLD. BUILDING MATERIALS, FIXTURES AND APPLIANCES WILL BE RECYCLED TO THE MAXIMUM EXTENT POSSIBLE.
2. ALL OTHER DEMOLITION PRODUCTS WILL BE PROPERLY DISPOSED OF PER ORANGE COUNTY REGULATIONS.
3. THE EXISTING SHED WITHOUT FLOOR WILL REMAIN.

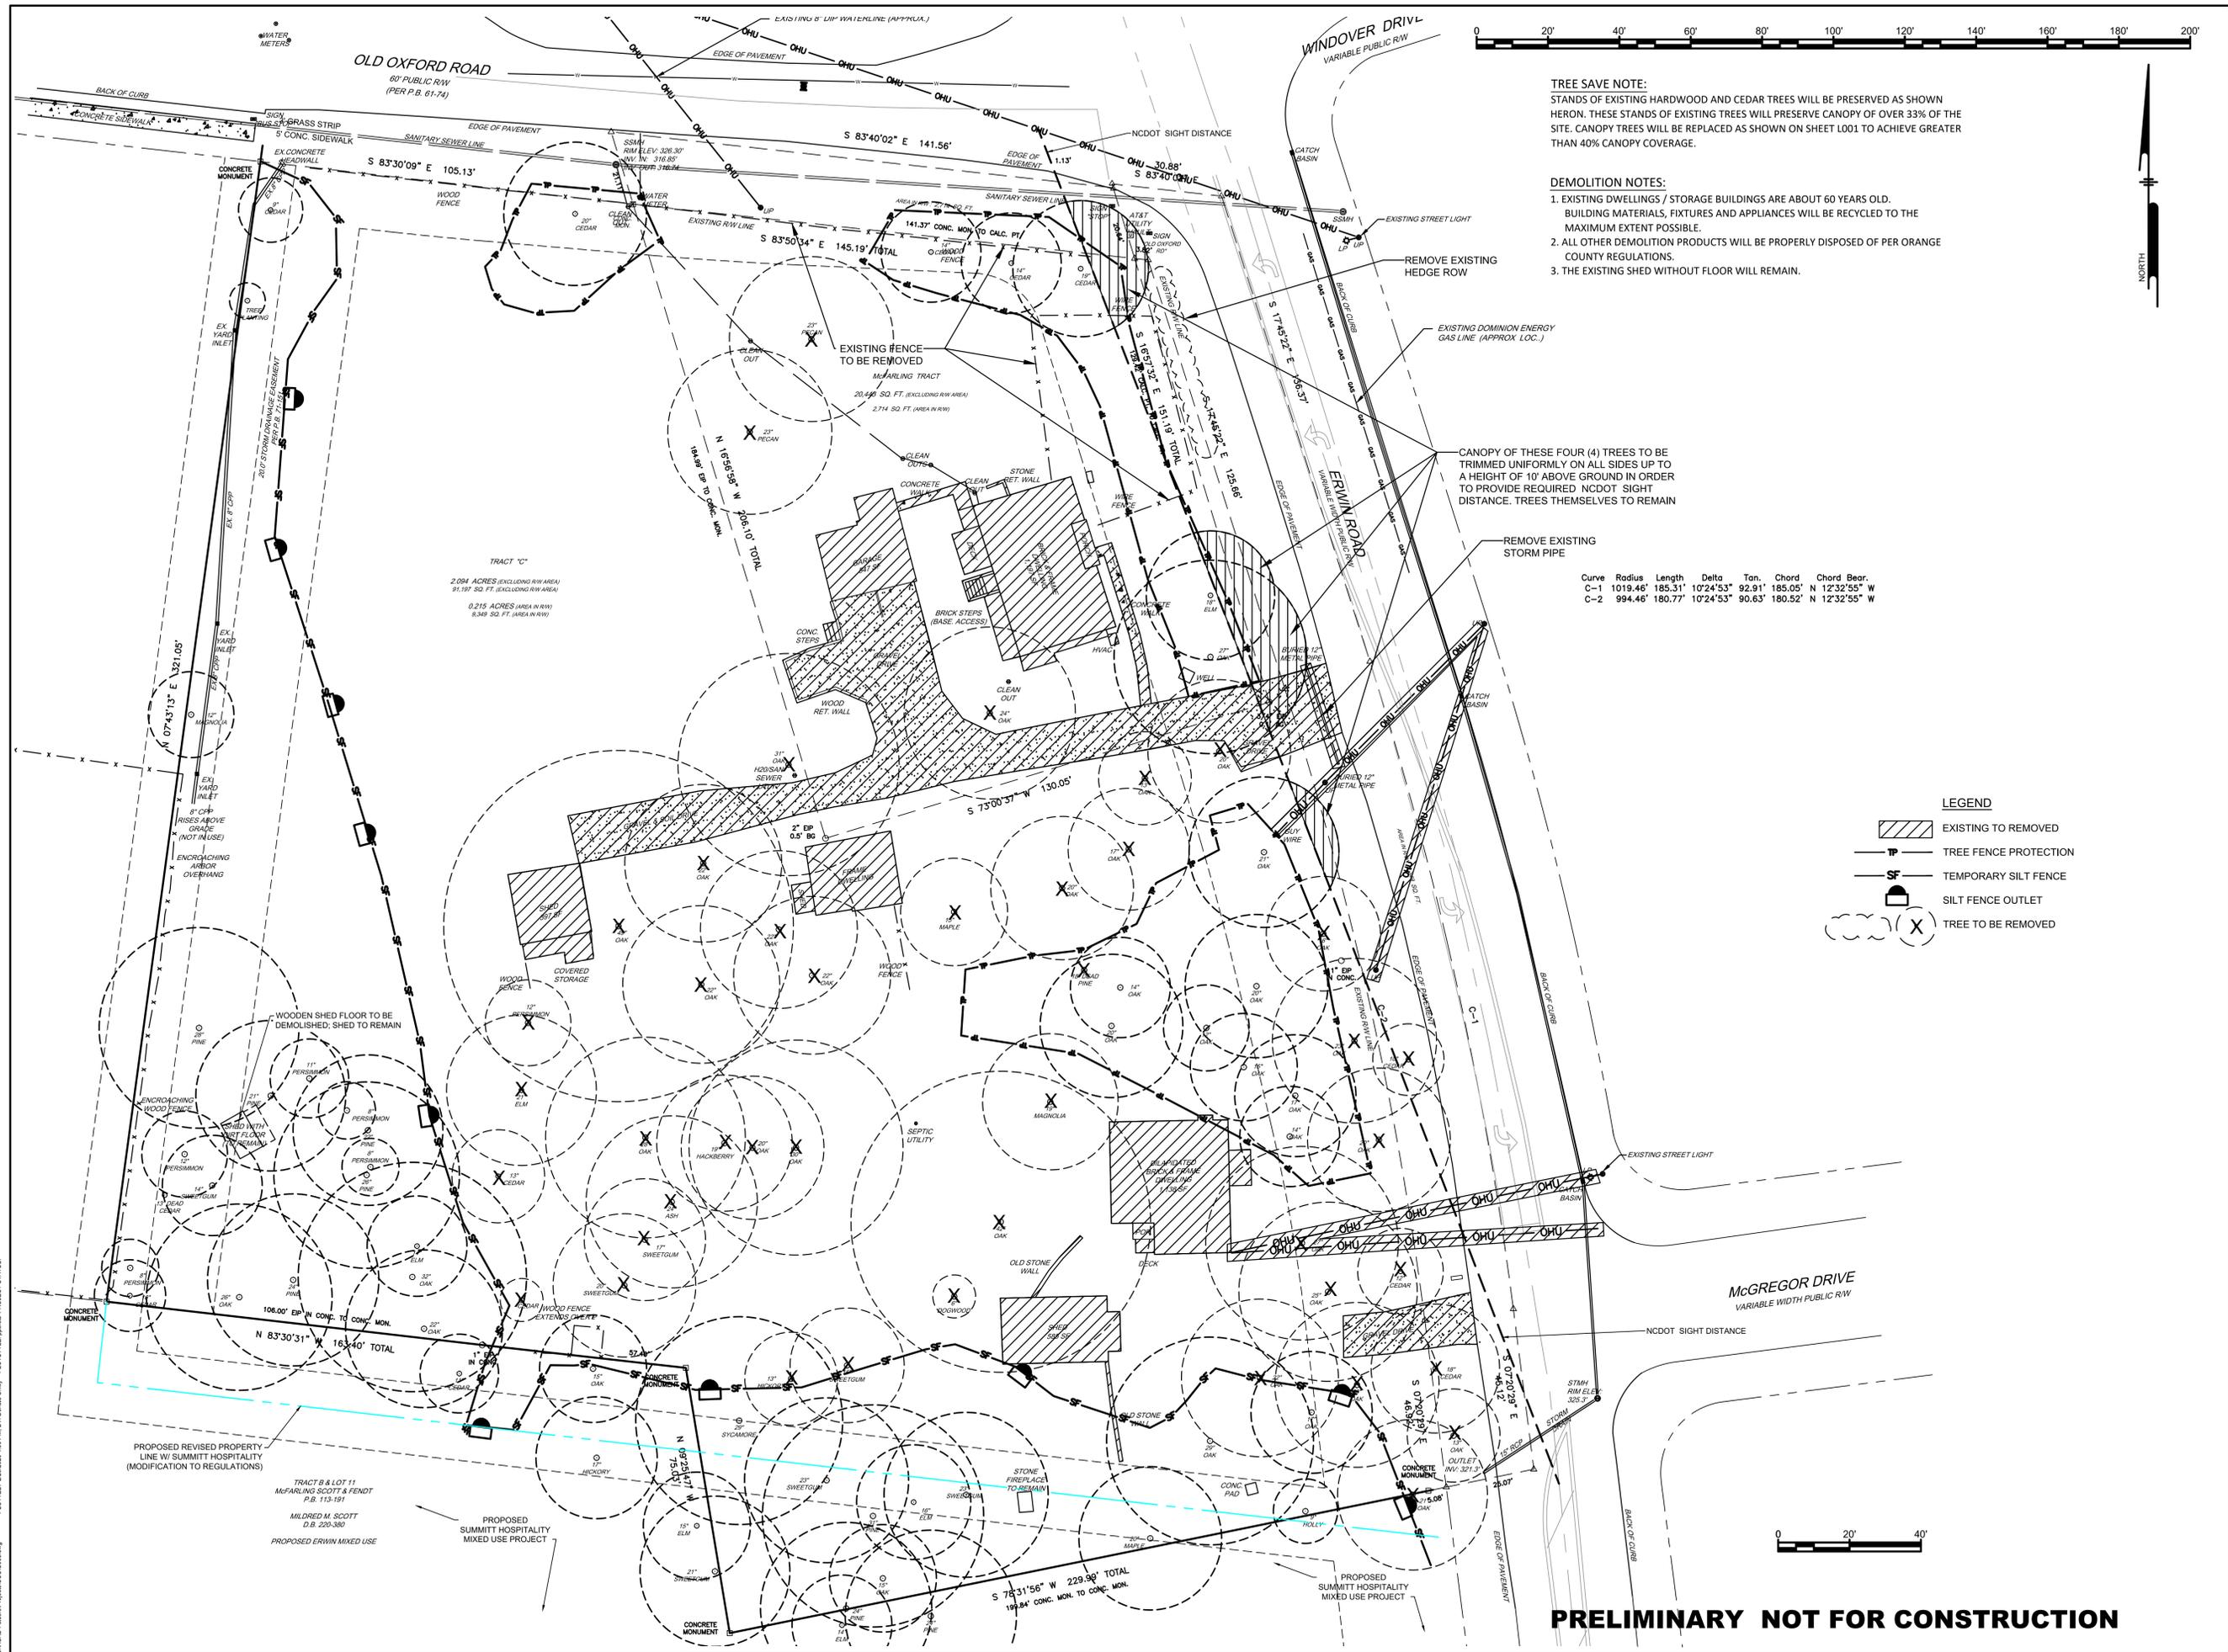CANOPY OF THESE FOUR (4) TREES TO BE TRIMMED UNIFORMLY ON ALL SIDES UP TO A HEIGHT OF 10' ABOVE GROUND IN ORDER TO PROVIDE REQUIRED NCDOT SIGHT DISTANCE. TREES THEMSELVES TO REMAIN

| Curve | Radius | Length | Delta | Tan. Chord | Chord Bear. |
|-------|----------|---------|-----------|------------|-----------------------|
| C-1 | 1019.46' | 185.31' | 10°24'53" | 92.91' | 185.05' N 12°32'55" W |
| C-2 | 994.46' | 180.77' | 10°24'53" | 90.63' | 180.52' N 12°32'55" W |

LEGEND

| | |
|--|------------------------|
| | EXISTING TO BE REMOVED |
| | TREE FENCE PROTECTION |
| | TEMPORARY SILT FENCE |
| | SILT FENCE OUTLET |
| | TREE TO BE REMOVED |

ALL DIMENSIONS MUST BE VERIFIED BY CONTRACTOR AND OWNER MUST BE NOTIFIED OF ANY DISCREPANCIES BEFORE PROCEEDING WITH WORK

CHRIST COMMUNITY CHURCH
141 ERWIN ROAD, CHAPEL HILL, N.C. 27514
PHONE 979-99-9116 AND 979-99-0235

DEMOLITION & LANDSCAPE PROTECTION PLAN

APPLICANT:
CHRIST COMMUNITY CHURCH
1528 E. FRANKLIN STREET, SUITE 201
CHAPEL HILL, N.C. 27514

| # | DATE | NO. | BY | REVISIONS |
|---|------------|-----|----|---------------------------|
| 1 | 11-17-2019 | | | SUBMITTAL #1 COMMENTS |
| 2 | 11-17-2019 | | | OWASA 11/13/2019 COMMENTS |
| 3 | 1-17-2020 | | | SUBMITTAL #2 COMMENTS |
| 4 | 1-27-2020 | | | PROPERTY LINE SWAP |
| 5 | 2-9-2020 | | | TOWN COMMENTS |
| 6 | 2/26/2020 | | | NCDOT AND TOWN COMMENTS |



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| | |
|---------------|-----------|
| PROJECT | 401801 |
| DATE | 8/28/2019 |
| DRAWING SCALE | 1" = 20' |
| DRAWN BY | DC |
| APPROVED BY | PNP |

C003
SHEET 4 OF 16

PRELIMINARY NOT FOR CONSTRUCTION

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STORM DRAINAGE SCHEDULE
CHRIST COMMUNITY CHURCH
 8/23/19
 Design Storm: 10-YEAR
 Note: Rim elevations are taken from the top of structure.

| STRUCTURE | RIM ELEV. | INV IN | INV OUT | PIPE LENGTH | PIPE SIZE | LOOKING DOWNSTREAM SLOPE |
|----------------|-----------|--------|---------|-------------|-----------|--------------------------|
| CI-1 | 310.98 | | 307.10 | 5 | 18" | 1.00% |
| CI-2 | 310.98 | 307.05 | 306.95 | 24 | 24" | 1.04% |
| DETENTION | | | | | | |
| JB-3 | 319.90 | | 315.00 | 95 | 15" | 8.74% |
| DETENTION | | | | | | |
| OUTLET CHAMBER | 313.75 | 300.00 | 300.00 | 5 | 18" | 1.00% |
| JB-4 | 313.30 | 299.75 | TBD | 18 | 18" | TBD |

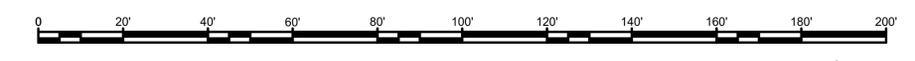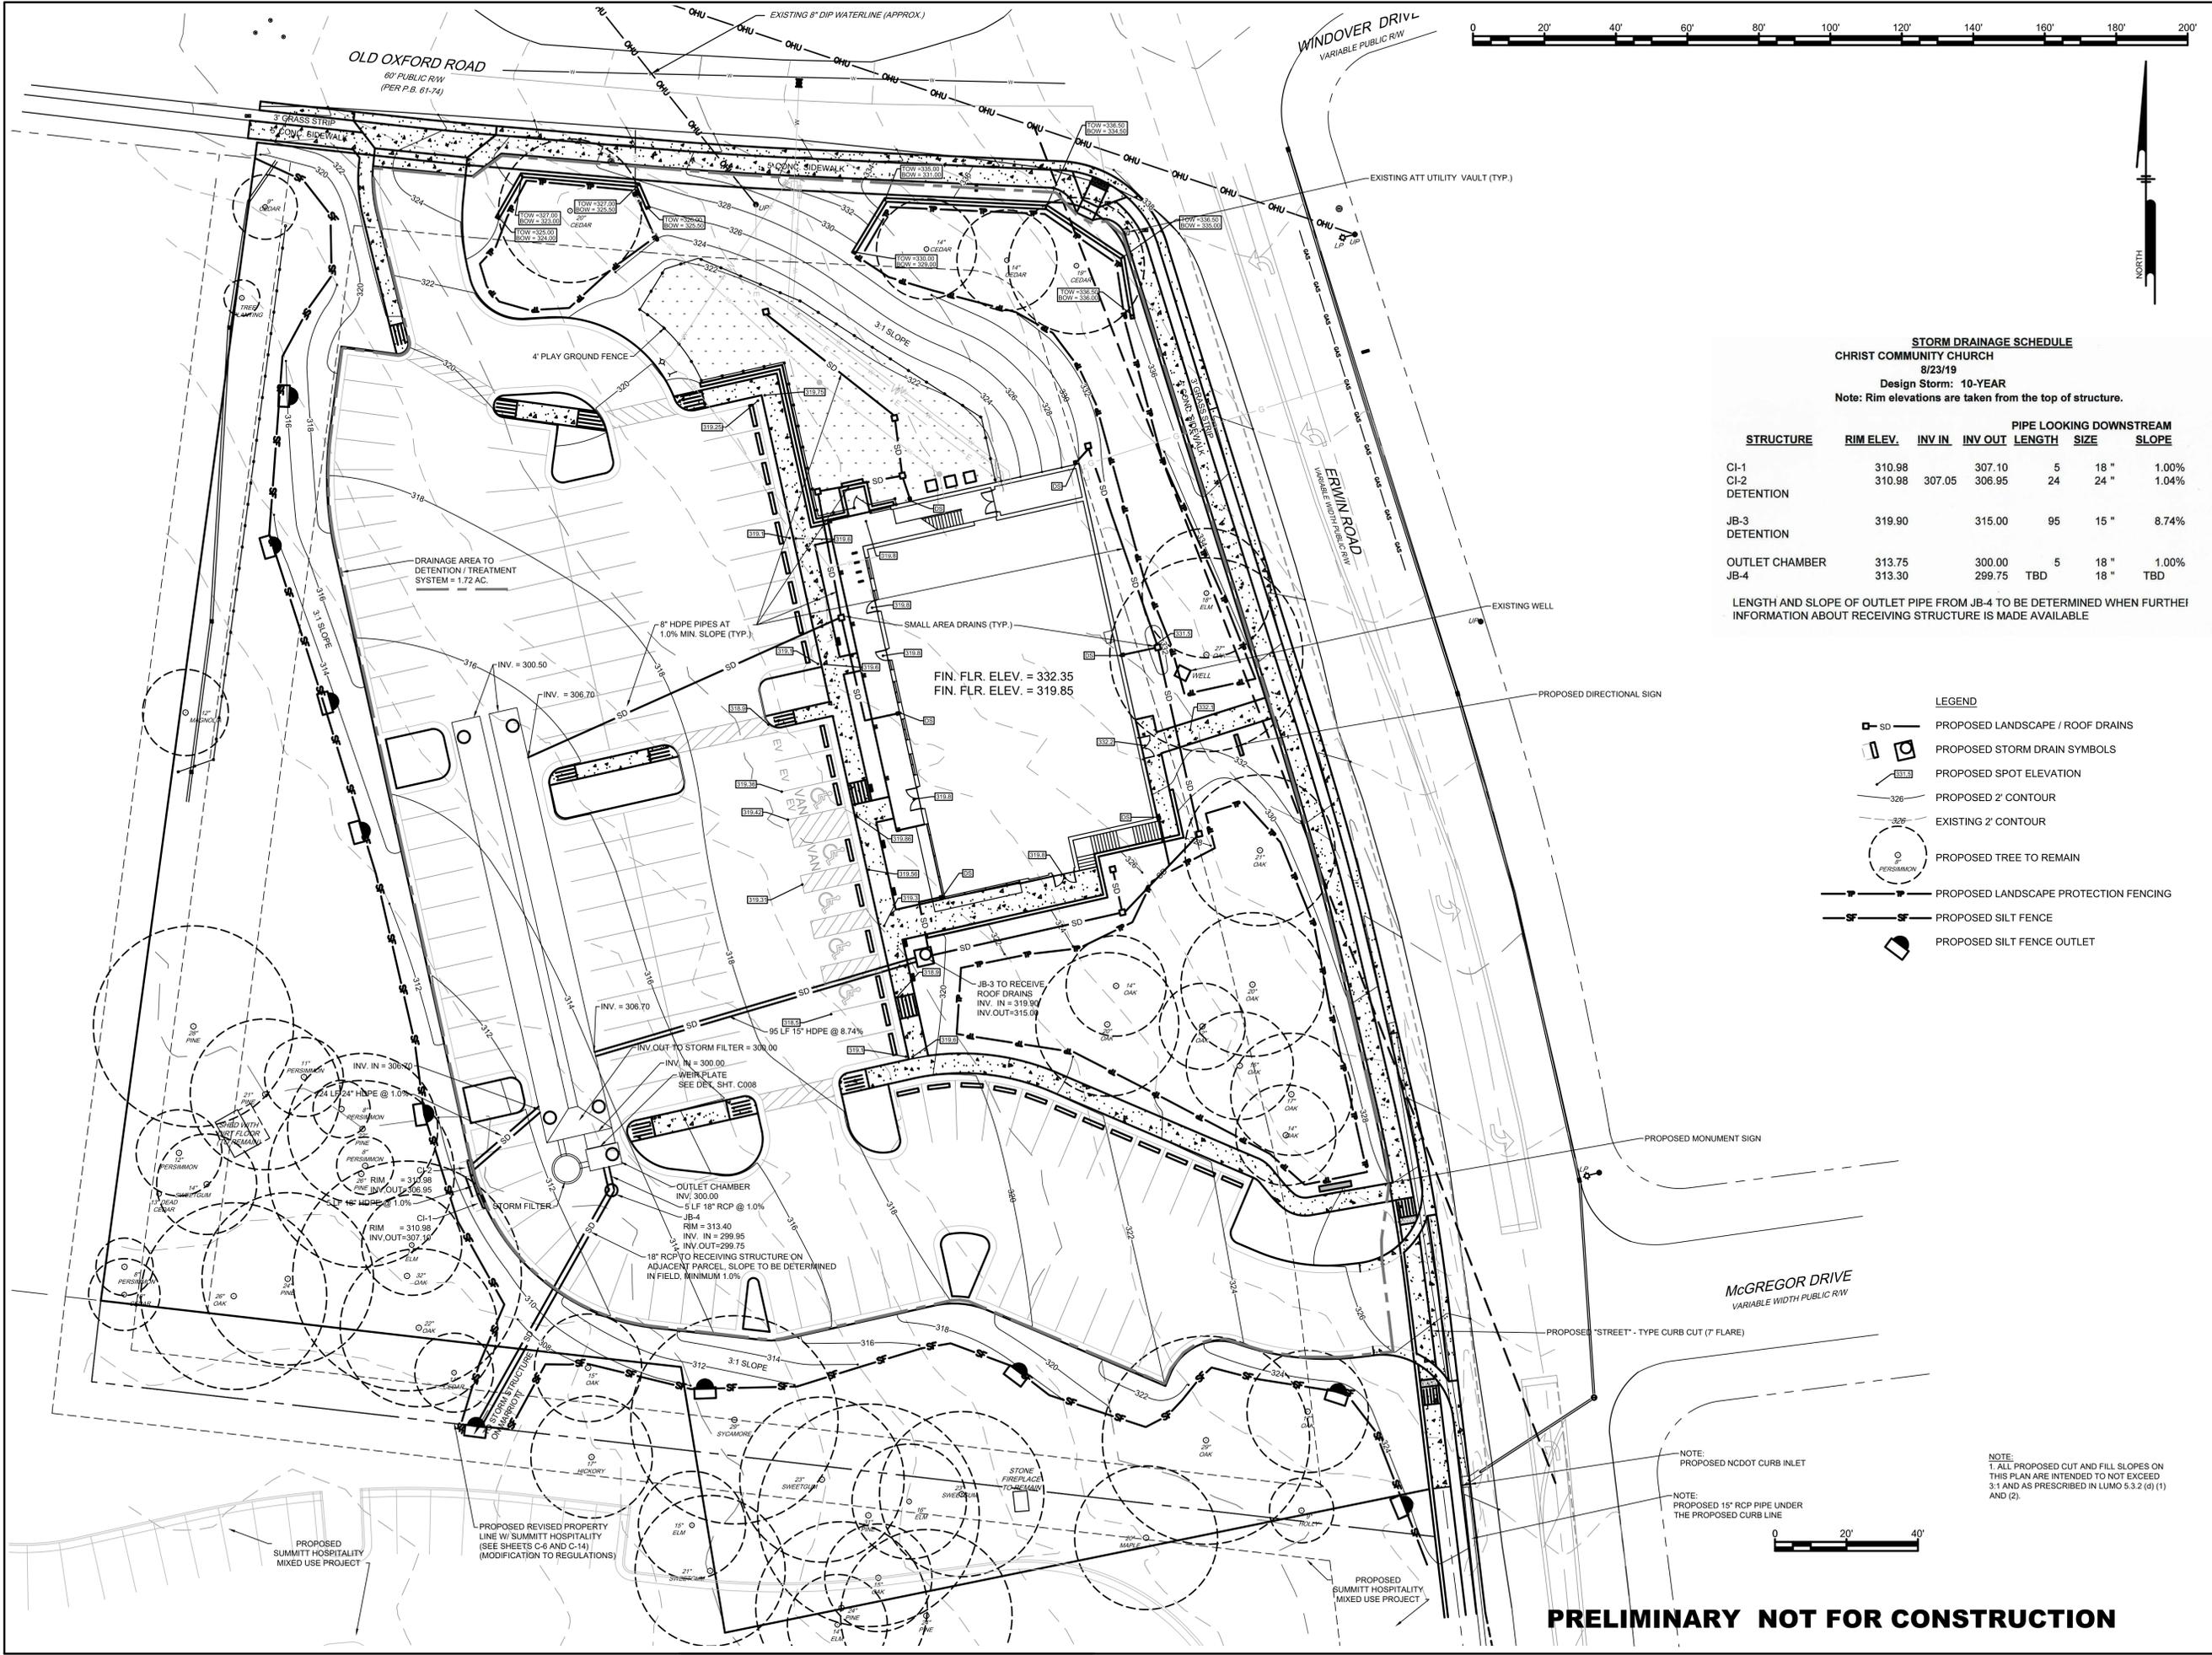LENGTH AND SLOPE OF OUTLET PIPE FROM JB-4 TO BE DETERMINED WHEN FURTHER INFORMATION ABOUT RECEIVING STRUCTURE IS MADE AVAILABLE

- LEGEND**
- PROPOSED LANDSCAPE / ROOF DRAINS
 - PROPOSED STORM DRAIN SYMBOLS
 - PROPOSED SPOT ELEVATION
 - PROPOSED 2' CONTOUR
 - EXISTING 2' CONTOUR
 - PROPOSED TREE TO REMAIN
 - PROPOSED LANDSCAPE PROTECTION FENCING
 - PROPOSED SILT FENCE
 - PROPOSED SILT FENCE OUTLET

ALL DIMENSIONS MUST BE VERIFIED BY CONTRACTOR AND OWNER MUST BE NOTIFIED OF ANY DISCREPANCIES BEFORE PROCEEDING WITH WORK

CHRIST COMMUNITY CHURCH
 141 ERWIN ROAD, CHAPEL HILL, N.C. 27514
 P/N# 9799-39-9116 AND 9799-49-0235
GRADING & DRAINAGE PLAN
 APPLICANT:
CHRIST COMMUNITY CHURCH
 1528 E. FRANKLIN STREET, SUITE 201
 CHAPEL HILL, N.C. 27514

| # | # | # | # | # | # | # | DATE | REVISIONS | BY |
|------------|----|----|----|----|----|----|------|-----------|----|
| | DC | DC | DC | DC | DC | DC | | | |
| 2/26/2020 | 6 | 6 | 6 | 6 | 6 | 6 | | | |
| 2-9-2020 | 5 | 5 | 5 | 5 | 5 | 5 | | | |
| 1-27-2020 | 4 | 4 | 4 | 4 | 4 | 4 | | | |
| 1-17-2020 | 3 | 3 | 3 | 3 | 3 | 3 | | | |
| 12-27-2019 | 2 | 2 | 2 | 2 | 2 | 2 | | | |
| 11-17-2019 | 1 | 1 | 1 | 1 | 1 | 1 | | | |

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| | |
|---------------|-----------|
| PROJECT | 401801 |
| DATE | 8/28/2019 |
| DRAWING SCALE | 1" = 20' |
| DRAWN BY | DC |
| APPROVED BY | PNP |

C005
 SHEET 6 OF 16

PRELIMINARY NOT FOR CONSTRUCTION

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Philip N. Post, PE, PLS
 (919) 818-7862
 philip.n.post@gmail.com
 PO Box 4912
 Chapel Hill, NC 27515

PHILIP
 POST
 ENGINEERING
 FIRM: C-347

ALL DIMENSIONS MUST BE VERIFIED BY CONTRACTOR AND OWNER MUST BE NOTIFIED OF ANY DISCREPANCIES BEFORE PROCEEDING WITH WORK

CHRIST COMMUNITY CHURCH
 141 ERWIN ROAD, CHAPEL HILL, N.C. 27514
 PIN# 9799-39-9116 AND 9799-49-0235
CONSTRUCTION MANAGEMENT PLAN
BOUNDARY SWAP AND BUFFERS
 APPLICANT:
CHRIST COMMUNITY CHURCH
 1526 E. FRANKLIN STREET, SUITE 201
 CHAPEL HILL, N.C. 27514

LEGEND

- TP — TREE FENCE PROTECTION
- SF — TEMPORARY SILT FENCE
- ◻ SILT FENCE OUTLET
- - - PROPOSED LAND SWAP PROPERTY LINE

| # | DATE | NO. | REVISIONS | BY |
|------------|------|-----|---------------------------|----|
| 2/26/2020 | 6 | | NCDOT AND TOWN COMMENTS | |
| 2-9-2020 | 5 | | TOWN COMMENTS | |
| 1-27-2020 | 4 | | PROPERTY LINE SWAP | |
| 1-17-2020 | 3 | | SUBMITTAL #2 COMMENTS | |
| 12-27-2019 | 2 | | OWASA 11/13/2019 COMMENTS | |
| 11-17-2019 | 1 | | SUBMITTAL #1 COMMENTS | |





















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PROJECT: 401801
 DATE: 8/28/2019
 DRAWING SCALE: 1" = 20'
 DRAWN BY: DC
 APPROVED BY: PNP

C006
 SHEET 7 OF 16

PRELIMINARY NOT FOR CONSTRUCTION

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 PLOTTED: 2/26/2020 4:57 PM BY: Donald Chisholm
 PLOTSTYLE: acad.ctb
 PROJECT STATUS: —

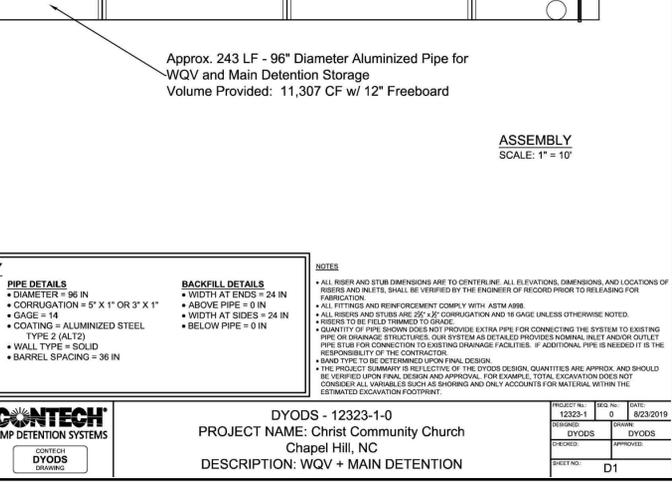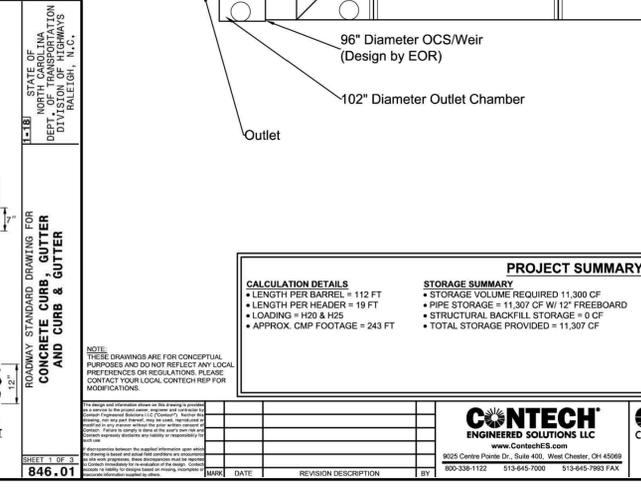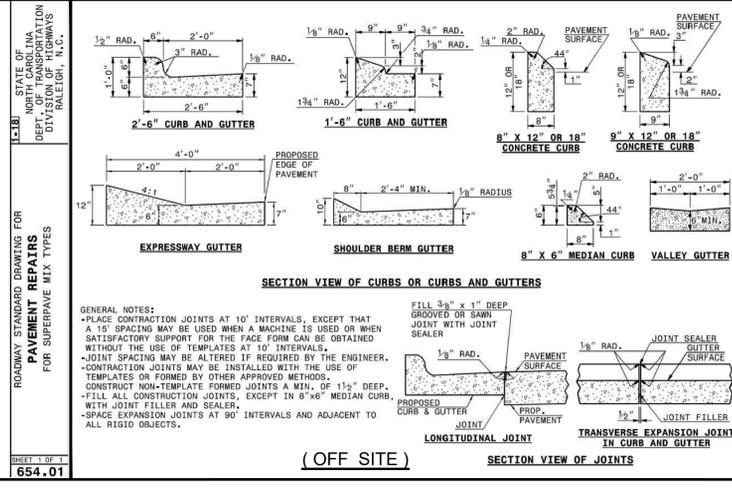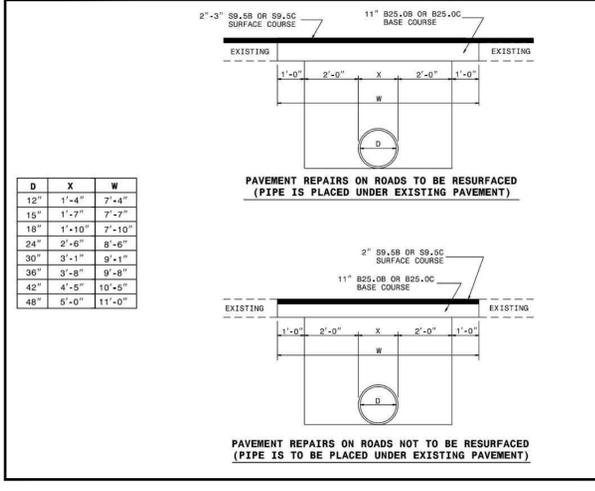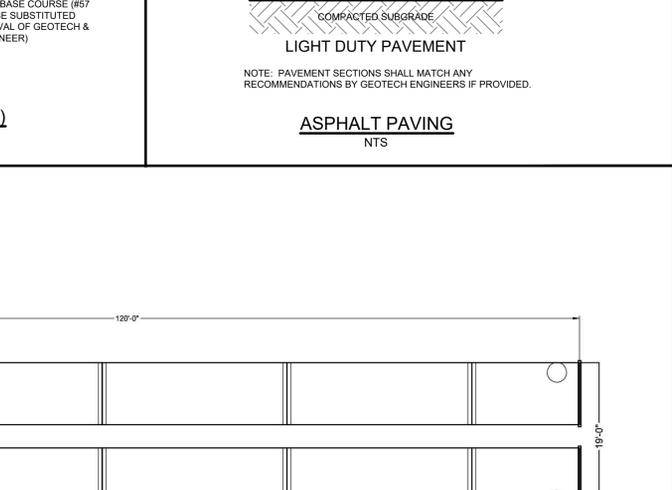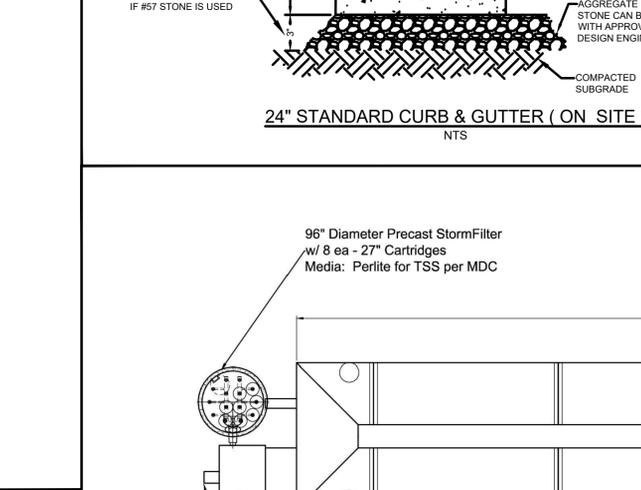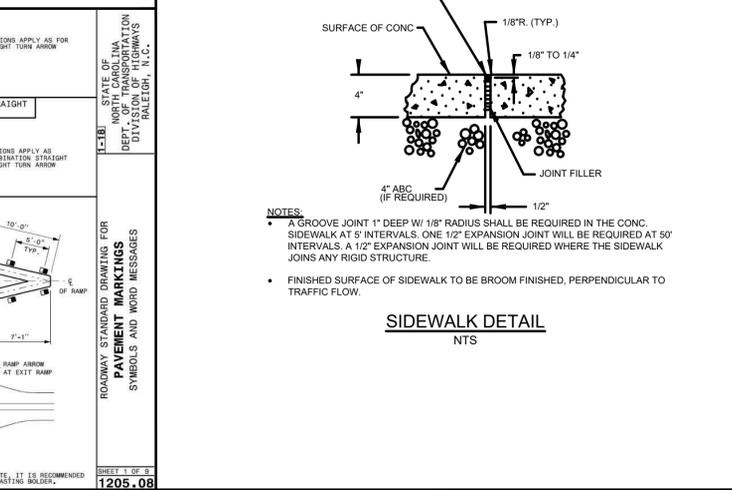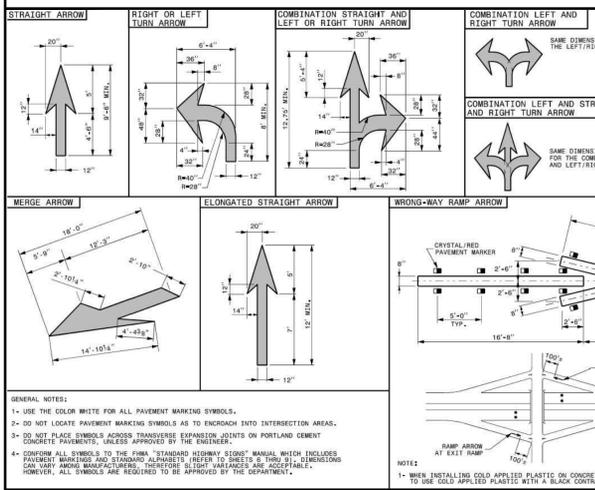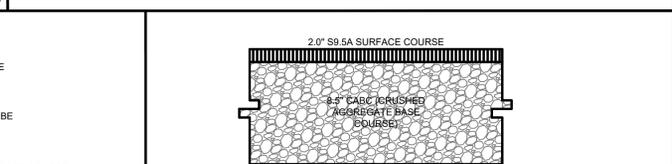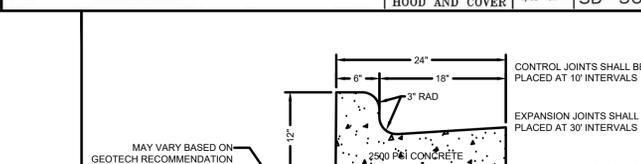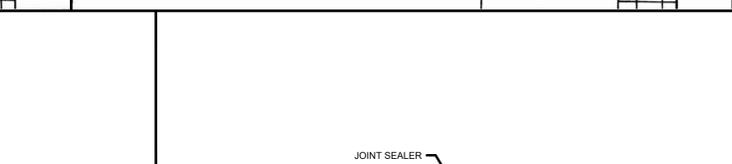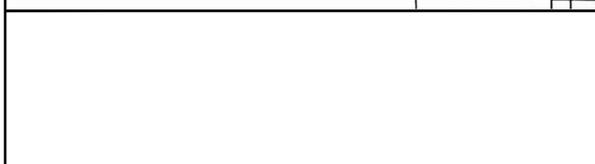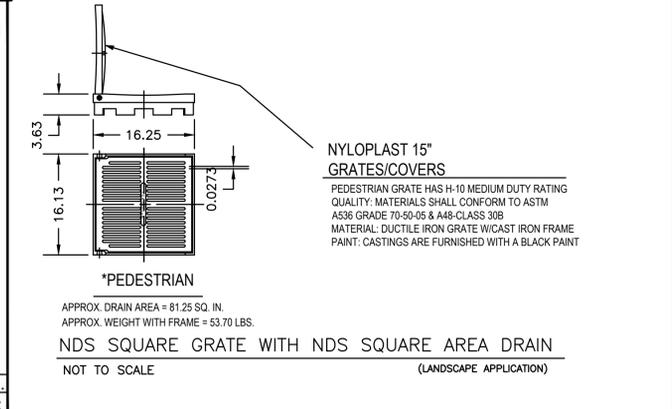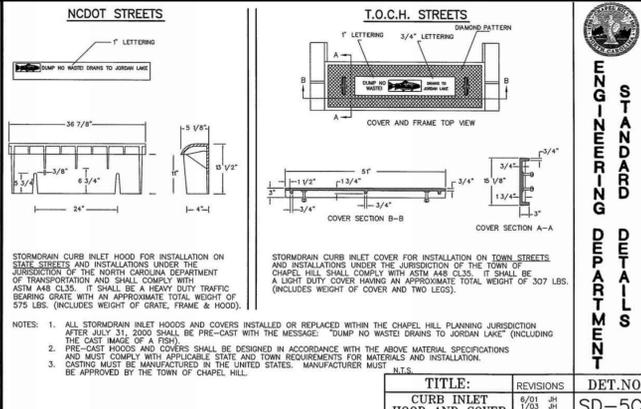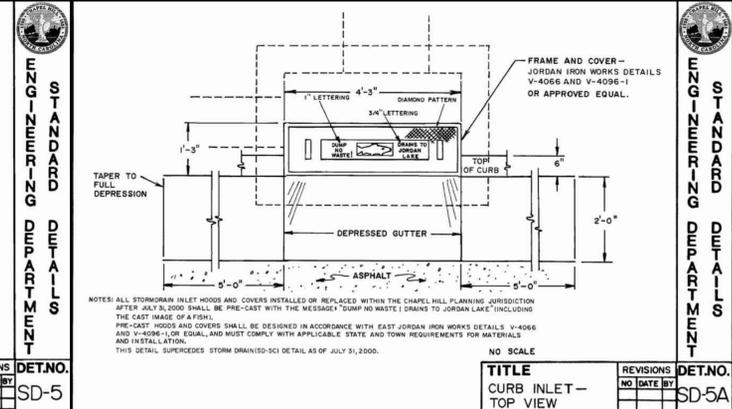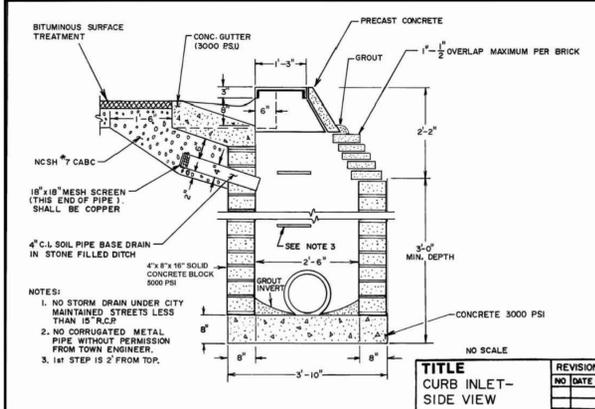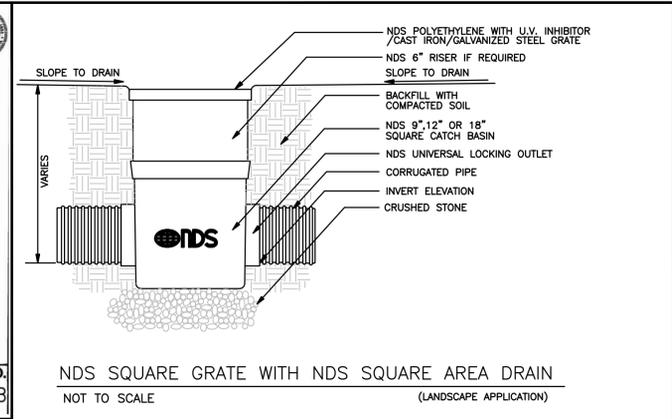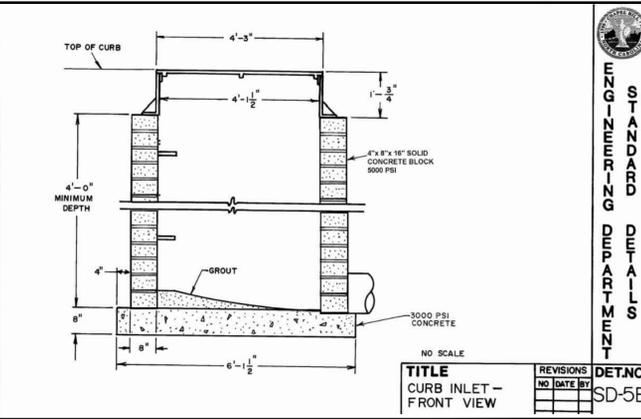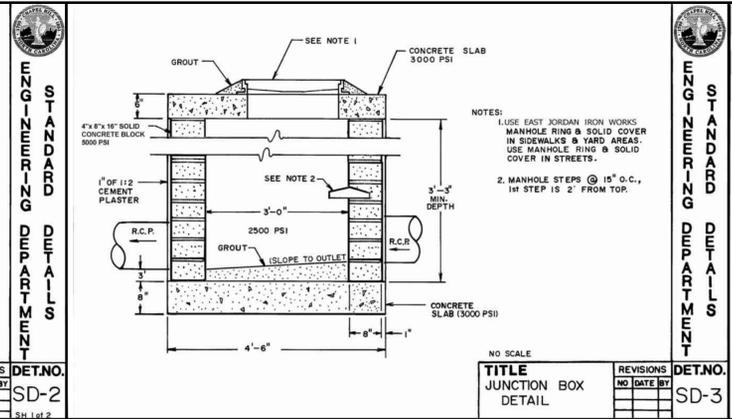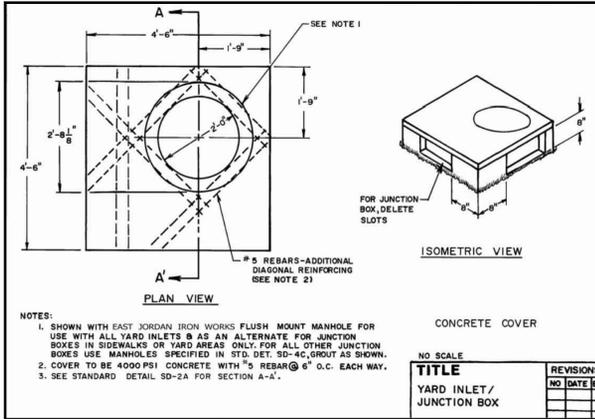






CHRIST COMMUNITY CHURCH
 141 ERWIN ROAD, CHAPEL HILL, N.C. 27514
 P/N# 9799-99-9116 AND 9799-49-0235

APPLICANT:
CHRIST COMMUNITY CHURCH
 1526 E. FRANKLIN STREET, SUITE 201
 CHAPEL HILL, N.C. 27514

PHILIP POST ENGINEERING
 Philip N. Post, PE, PLS
 (919) 818-7862
 philip.n.post@gmail.com
 PO Box 4932
 Chapel Hill, NC 27515

PROJECT: 401801
DATE: 8/28/2019
DRAWING SCALE: -
DRAWN BY: DC
APPROVED BY: PP

SHEET 8 OF 16

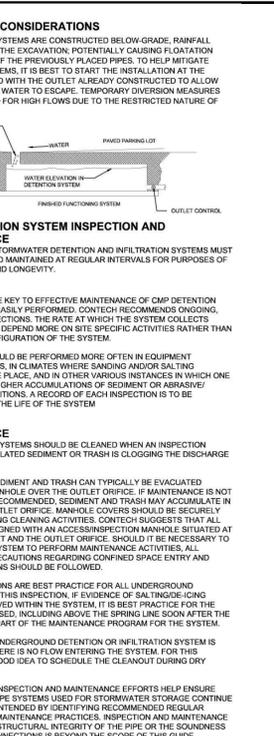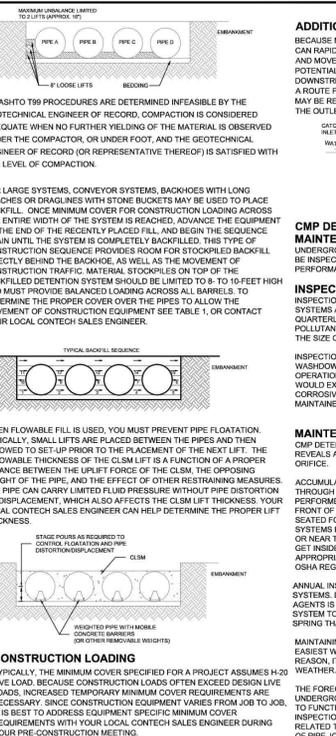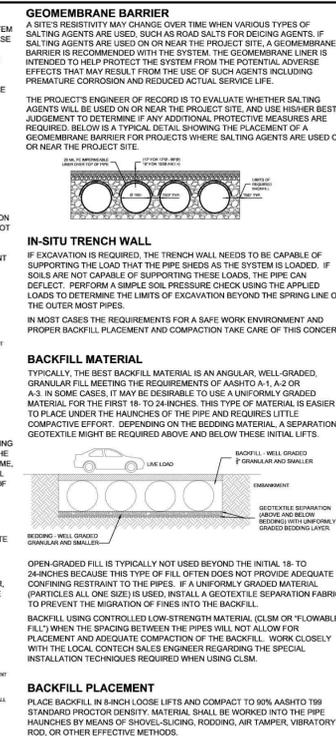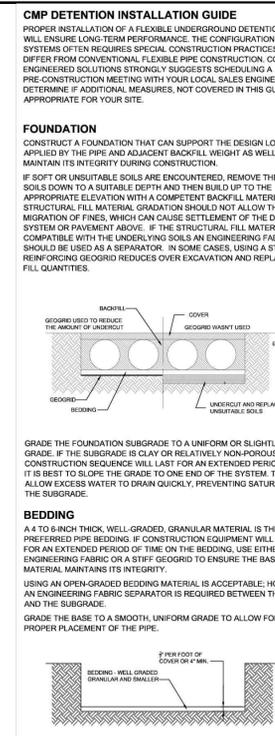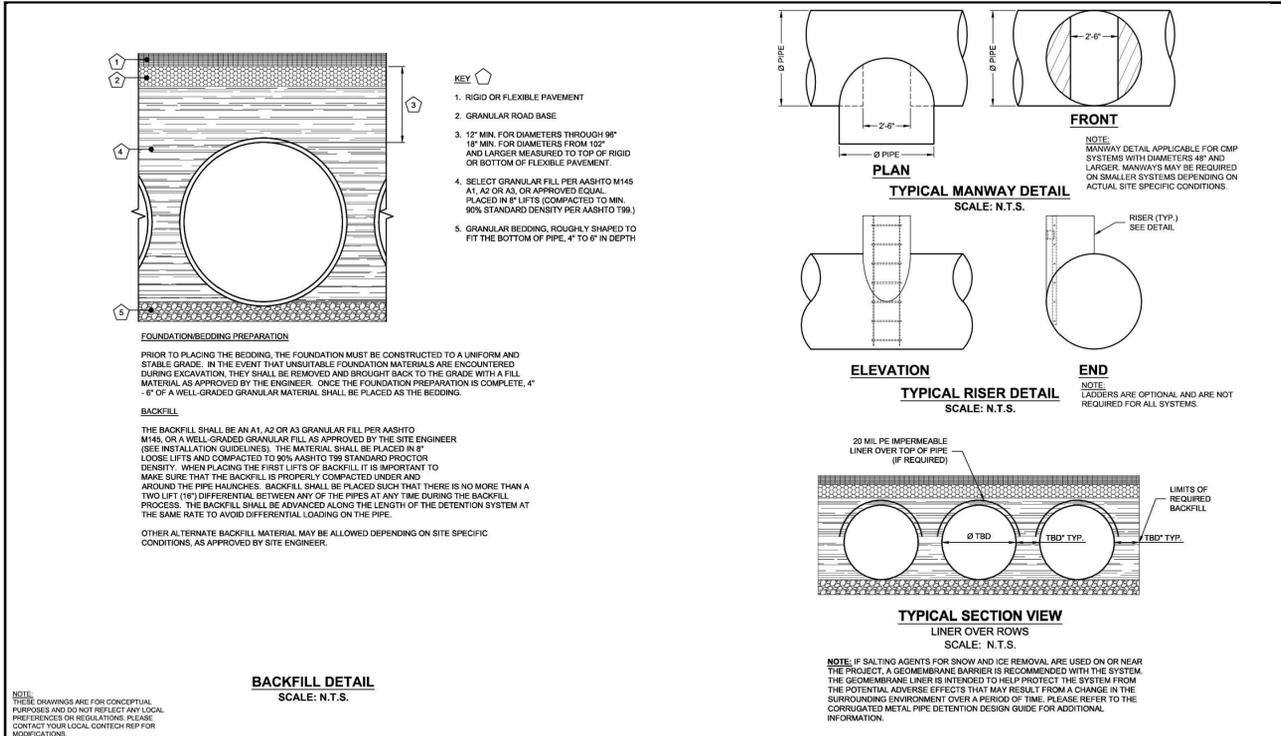

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| NO. | DATE | REVISION DESCRIPTION | BY |
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800-338-1122 513-645-7000 513-645-7993 FAX

CONTECH
CMP DETENTION SYSTEMS
CONTECH DYODS DRAWING

DYODS - 12323-1-0
PROJECT NAME: Christ Community Church
Chapel Hill, NC
DESCRIPTION: WQV + MAIN DETENTION

| PROJECT NO. | REV. NO. | DATE |
|-------------|----------|-----------|
| 12323-1 | 0 | 8/23/2019 |

DESIGNED: DYODS
CHECKED: DYODS
DATE: 8/23/2019
SHEET NO: D2

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CONTECH
CMP DETENTION SYSTEMS
CONTECH DYODS DRAWING




DYODS - 12323-1-0
PROJECT NAME: Christ Community Church
Chapel Hill, NC
DESCRIPTION: WQV + MAIN DETENTION

| PROJECT NO. | REV. NO. | DATE |
|-------------|----------|-----------|
| 12323-1 | 0 | 8/23/2019 |

DESIGNED: DYODS
CHECKED: DYODS
DATE: 8/23/2019
SHEET NO: D4

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800-338-1122 513-645-7000 513-645-7993 FAX

CONTECH
CMP DETENTION SYSTEMS
CONTECH DYODS DRAWING

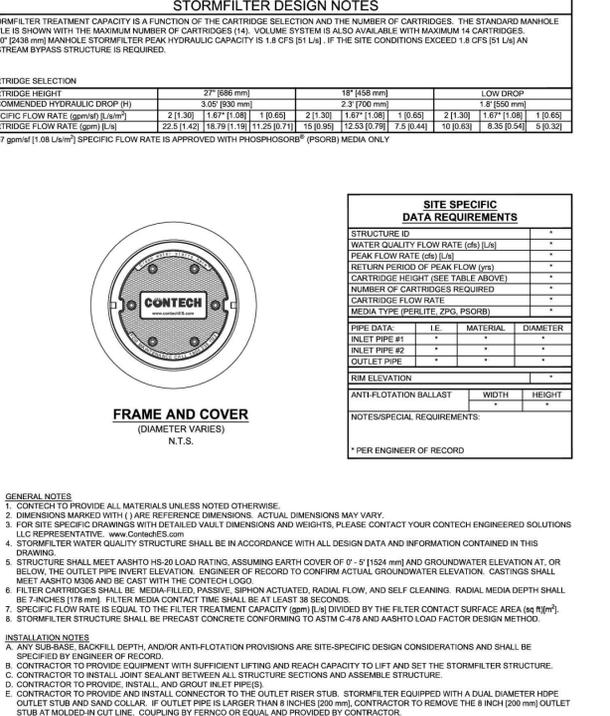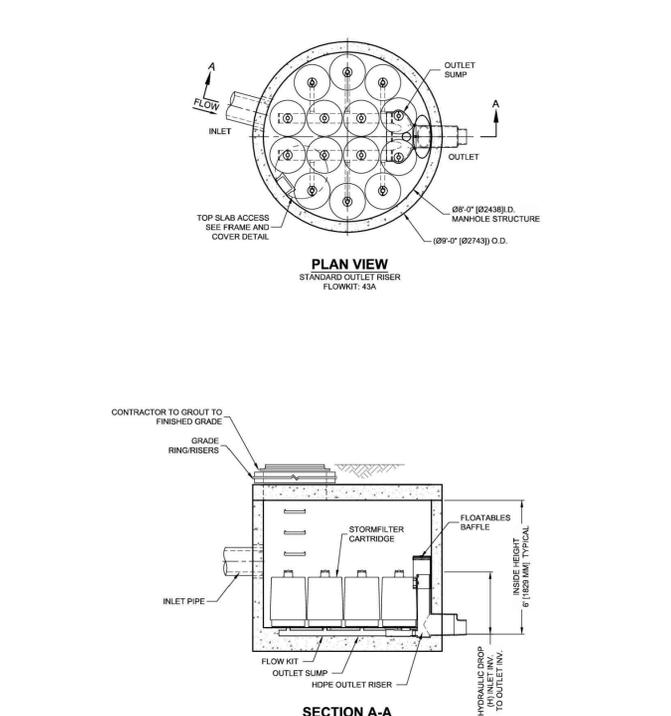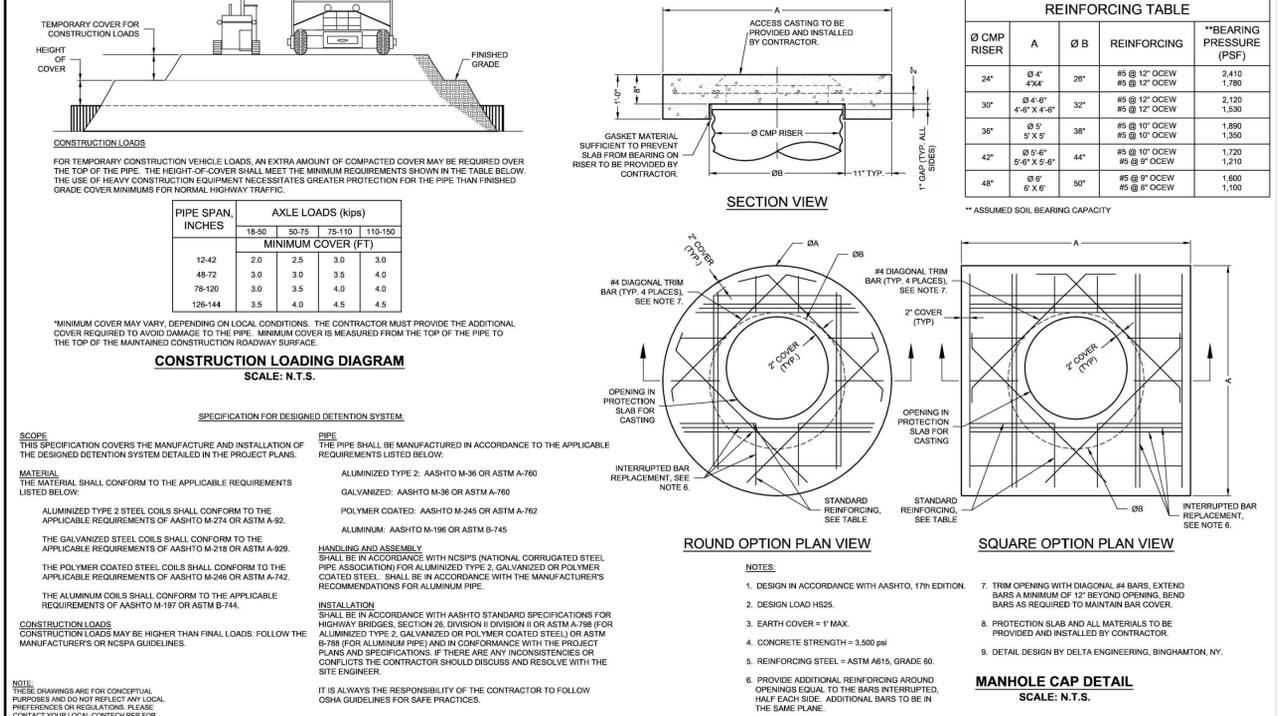DYODS - 12323-1-0
PROJECT NAME: Christ Community Church
Chapel Hill, NC
DESCRIPTION: WQV + MAIN DETENTION

| PROJECT NO. | REV. NO. | DATE |
|-------------|----------|-----------|
| 12323-1 | 0 | 8/23/2019 |

DESIGNED: DYODS
CHECKED: DYODS
DATE: 8/23/2019
SHEET NO: D3

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8025 Centre Pointe Dr., Suite 400, West Chester, OH 45399
800-338-1122 513-645-7000 513-645-7993 FAX

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CMP DETENTION SYSTEMS
CONTECH DYODS DRAWING



DYODS - 12323-1-0
PROJECT NAME: Christ Community Church
Chapel Hill, NC
DESCRIPTION: WQV + MAIN DETENTION

| PROJECT NO. | REV. NO. | DATE |
|-------------|----------|-----------|
| 12323-1 | 0 | 8/23/2019 |

DESIGNED: DYODS
CHECKED: DYODS
DATE: 8/23/2019
SHEET NO: D4

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| NO. | DATE | REVISION DESCRIPTION | BY |
|-----|------|----------------------|----|
| | | | |

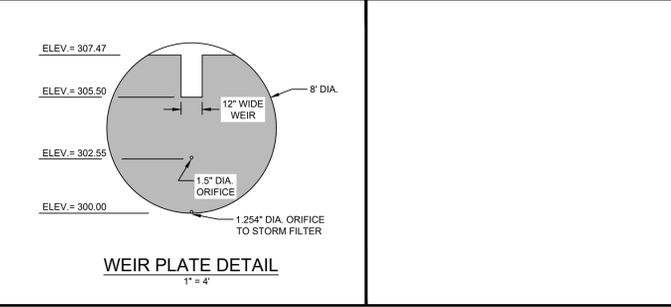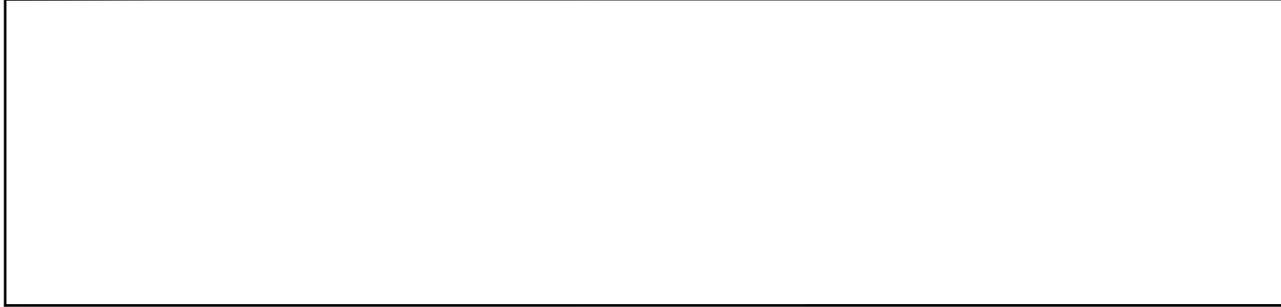

CHRIST COMMUNITY CHURCH
141 ERWIN ROAD, CHAPEL HILL, N.C. 27514
PHONE 979-369-9116 AND 979-949-0235

STORMWATER FILTERA DETAILS

APPLICANT: CHRIST COMMUNITY CHURCH
1526 E. FRANKLIN STREET, SUITE 201
CHAPEL HILL, N.C. 27514

Philip N. Post, PE, PLS
919 818-7862
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PO Box 4932
Chapel Hill, NC 27515

PHILIP POST
ENGINEERING FIRM, L347


ALL DIMENSIONS MUST BE VERIFIED BY CONTRACTOR AND OWNER MUST BE NOTIFIED OF ANY DISCREPANCIES BEFORE PROCEEDING WITH WORK

| NO. | DATE | REVISIONS |
|-----|------|-----------|
| | | |

PROJECT: 401801
DATE: 8/28/2019
DRAWING SCALE: -
DRAWN BY: DC
APPROVED BY: PP

C008
SHEET 9 OF 16

PRELIMINARY
NOT FOR CONSTRUCTION

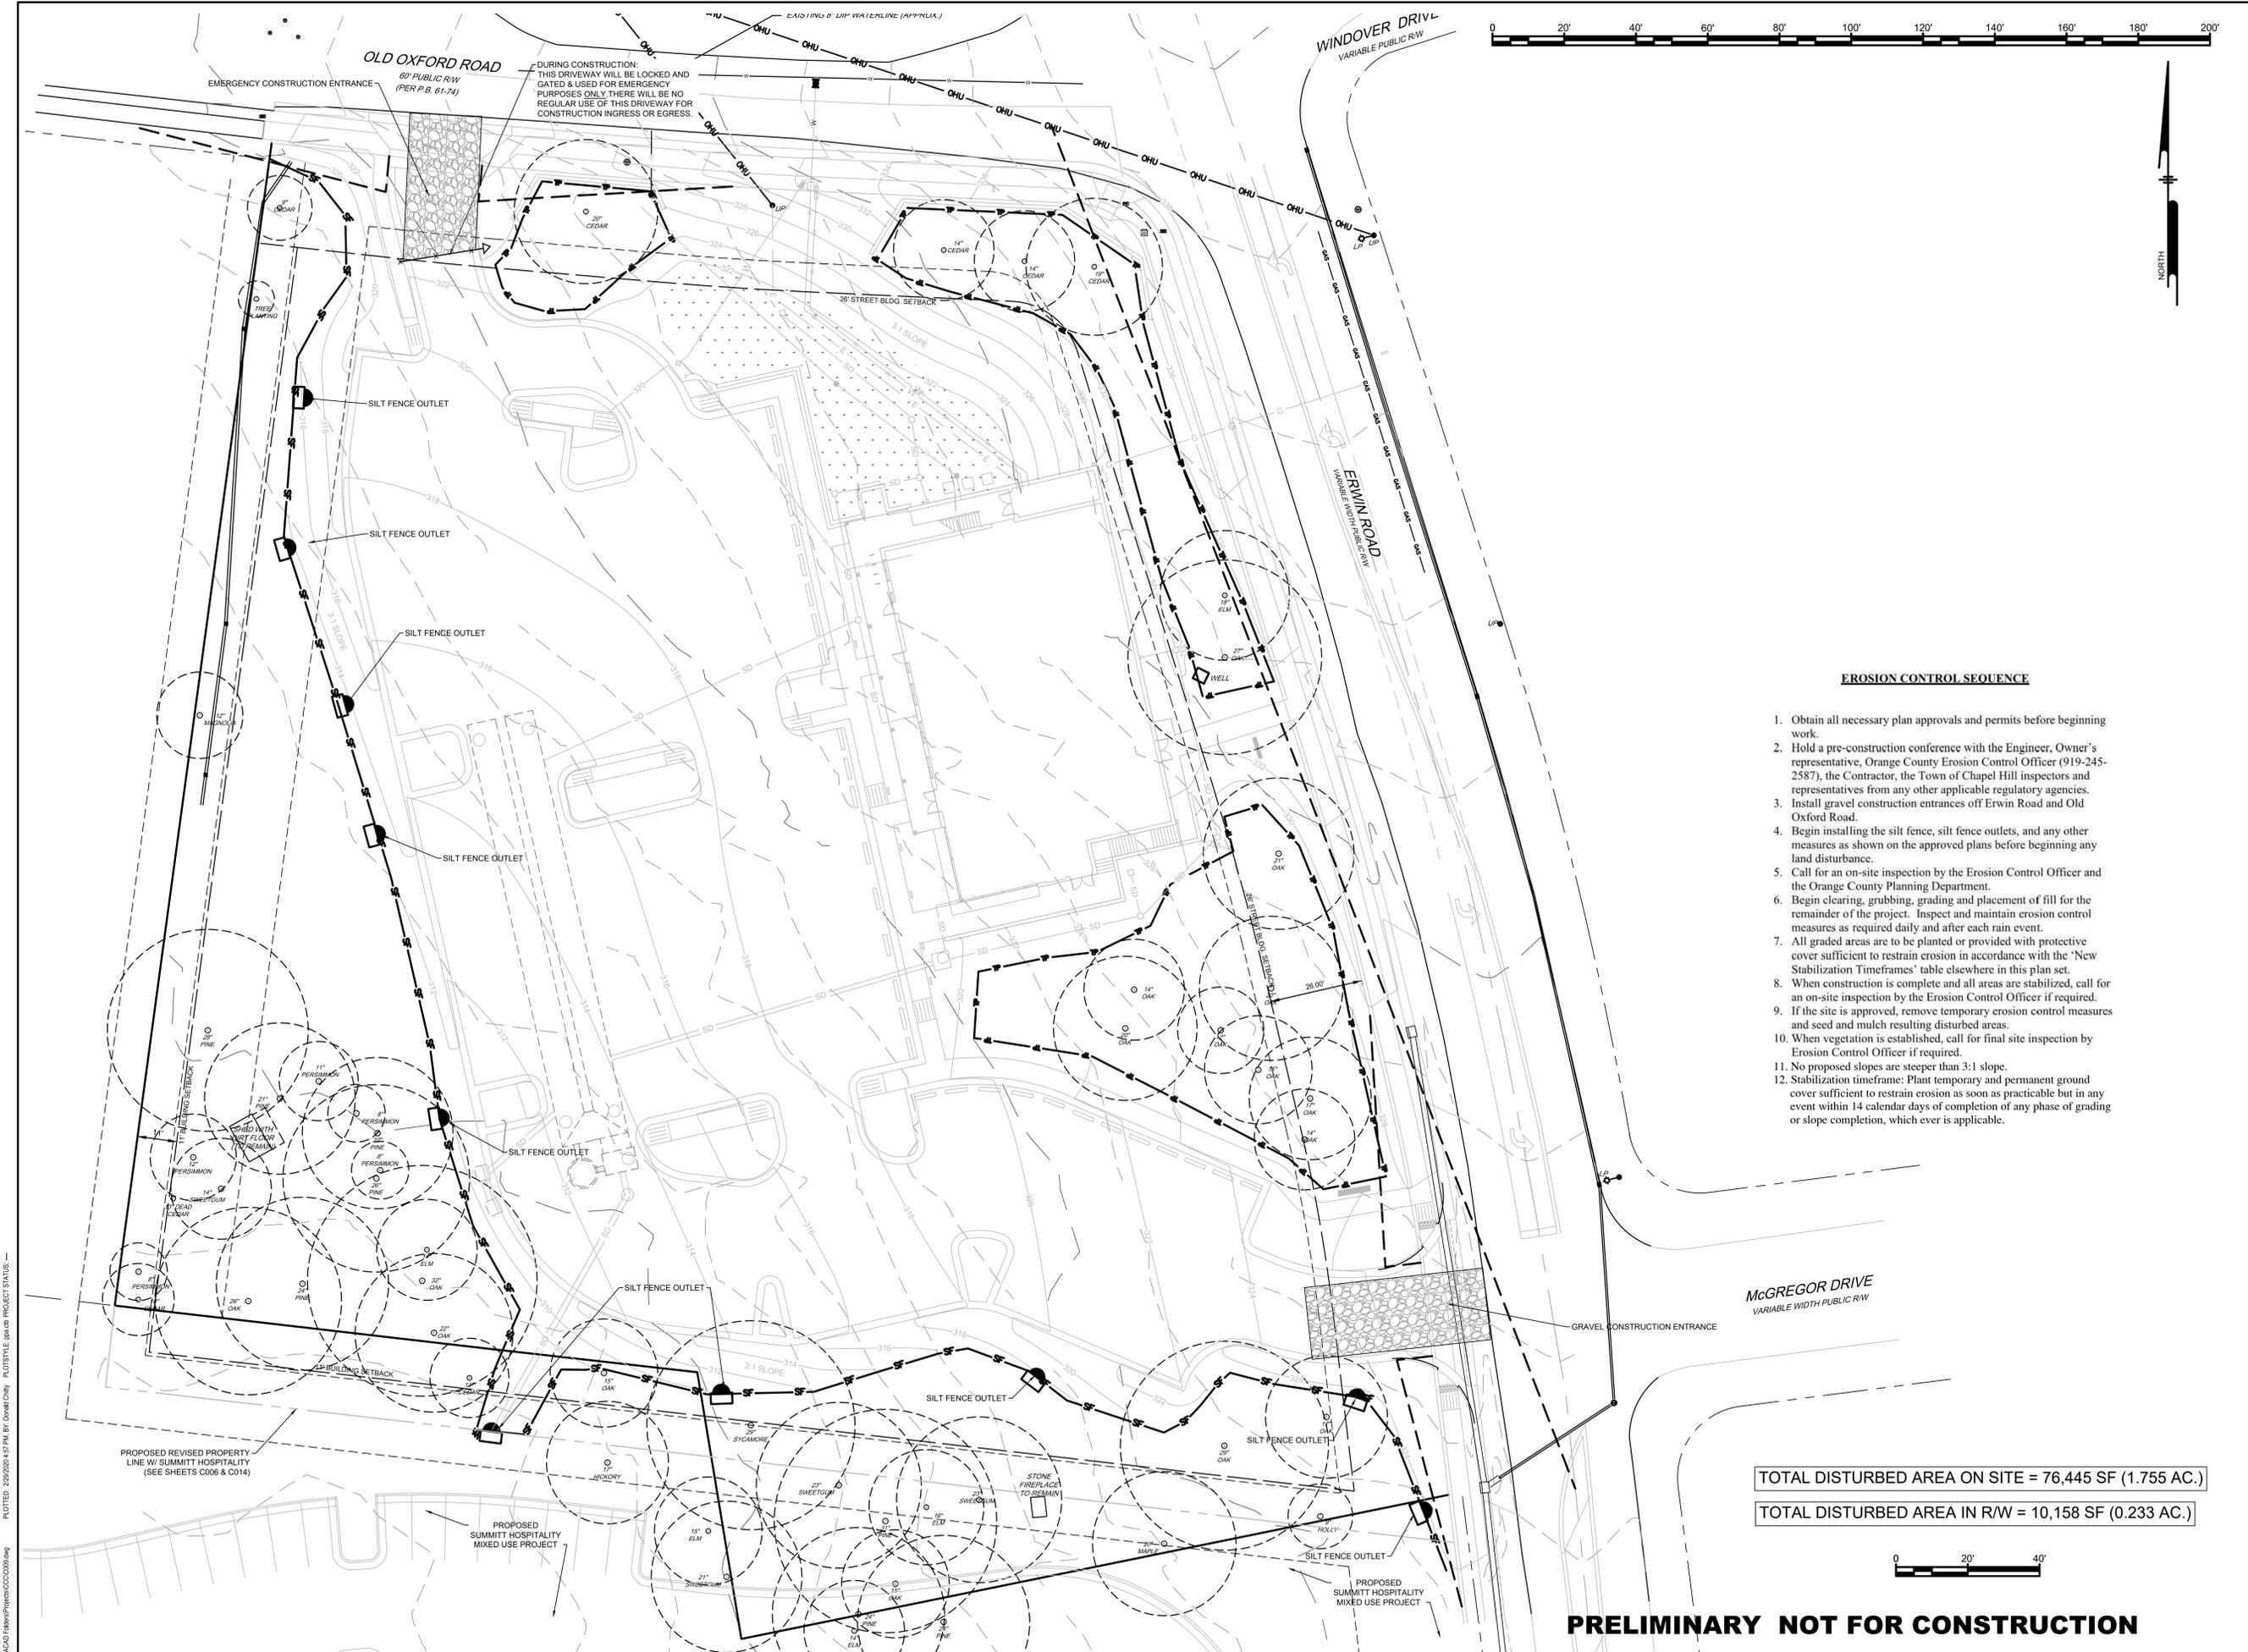

EROSION CONTROL SEQUENCE

1. Obtain all necessary plan approvals and permits before beginning work.
2. Hold a pre-construction conference with the Engineer, Owner's representative, Orange County Erosion Control Officer (919-245-2587), the Contractor, the Town of Chapel Hill inspectors and representatives from any other applicable regulatory agencies.
3. Install gravel construction entrances off Erwin Road and Old Oxford Road.
4. Begin installing the silt fence, silt fence outlets, and any other measures as shown on the approved plans before beginning any land disturbance.
5. Call for an on-site inspection by the Erosion Control Officer and the Orange County Planning Department.
6. Begin clearing, grubbing, grading and placement of fill for the remainder of the project. Inspect and maintain erosion control measures as required daily and after each rain event.
7. All graded areas are to be planted or provided with protective cover sufficient to restrain erosion in accordance with the 'New Stabilization Timeframes' table elsewhere in this plan set.
8. When construction is complete and all areas are stabilized, call for an on-site inspection by the Erosion Control Officer if required.
9. If the site is approved, remove temporary erosion control measures and seed and mulch resulting disturbed areas.
10. When vegetation is established, call for final site inspection by Erosion Control Officer if required.
11. No proposed slopes are steeper than 3:1 slope.
12. Stabilization timeframe: Plant temporary and permanent ground cover sufficient to restrain erosion as soon as practicable but in any event within 14 calendar days of completion of any phase of grading or slope completion, which ever is applicable.

TOTAL DISTURBED AREA ON SITE = 76,445 SF (1.755 AC.)

TOTAL DISTURBED AREA IN R/W = 10,158 SF (0.233 AC.)



PRELIMINARY NOT FOR CONSTRUCTION

ALL DIMENSIONS MUST BE VERIFIED BY CONTRACTOR AND OWNER MUST BE NOTIFIED OF ANY DISCREPANCIES BEFORE PROCEEDING WITH WORK

CHRIST COMMUNITY CHURCH
 141 ERWIN ROAD, CHAPEL HILL, N.C. 27514
 P/N# 9799-39-9116 AND 9799-49-0235

EROSION CONTROL PLAN

APPLICANT:
CHRIST COMMUNITY CHURCH
 1526 E. FRANKLIN STREET, SUITE 201
 CHAPEL HILL, N.C. 27514

| # | DATE | NO. | REVISIONS | BY |
|------------|------|-----|---------------------------|-----|
| 2/26/2020 | 6 | | NCDOT AND TOWN COMMENTS | DC |
| 2-9-2020 | 5 | | TOWN COMMENTS | #DC |
| 1-27-2020 | 4 | | PROPERTY LINE SWAP | DC |
| 1-17-2020 | 3 | | SUBMITTAL #2 COMMENTS | DC |
| 12-27-2019 | 2 | | OWASA 11/13/2019 COMMENTS | DC |
| 11-17-2019 | 1 | | SUBMITTAL #1 COMMENTS | DC |

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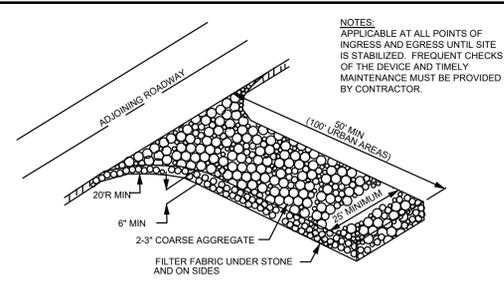
| | |
|---------------|-----------|
| PROJECT | 401801 |
| DATE | 8/28/2019 |
| DRAWING SCALE | 1" = 20' |
| DRAWN BY | DC |
| APPROVED BY | PNP |

C009
 SHEET 10 OF 16

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 Chapel Hill, NC 27515

PHILIP POST ENGINEERING
 FIRM: C-347

C:\ACAD\Folder\Sheet\C009.dwg PLOTFILE: 20190828_457.Plot File: D:\npl\chc\chc\PROJECT STATUS -



NOTES:
 APPLICABLE AT ALL POINTS OF INGRESS AND EGRESS UNTIL SITE IS STABILIZED. FREQUENT CHECKS OF THE DEVICE AND TIMELY MAINTENANCE MUST BE PROVIDED BY CONTRACTOR.

NOTES:
 WASHED STONE PAD TO BE 50L X 25W X 6TH MINIMUM (100L MIN IN URBAN AREAS). IF THE ADJOINING ROADWAY IS WIDER THAN 25', THEN THE WASHED STONE SHALL BE AS WIDE AS THE ADJOINING ROADWAY.


TURNING RADIUS OF 20' MINIMUM TO ACCOMMODATE LARGE TRUCKS SHALL BE PROVIDED.

ENTRANCE(S) SHOULD BE LOCATED TO PROVIDE FOR MAXIMUM USE BY ALL CONSTRUCTION VEHICLES.

MUST BE MAINTAINED IN A CONDITION WHICH WILL PREVENT TRACKING OR DIRECT FLOW OF MUD ONTO ADJACENT STREETS.

PERIODIC TOP DRESSING WITH STONE (2" THICK) WILL BE NECESSARY. ANY MATERIAL WHICH STILL MAKES IT ONTO THE ROAD MUST BE CLEANED UP IMMEDIATELY.


TEMPORARY GRAVEL CONSTRUCTION ENTRANCE / EXIT
 NTS

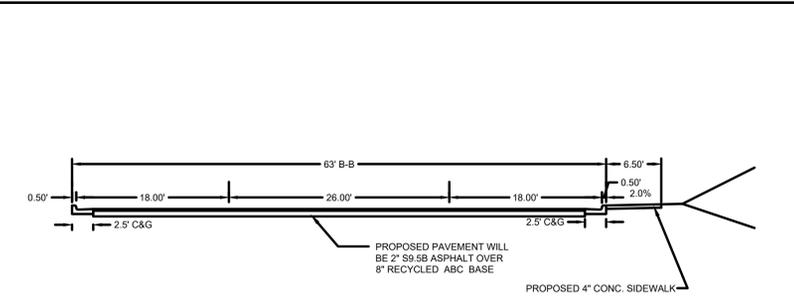


PARKING LOT TYPICAL SECTION
 NTS

NPDES Stormwater Discharge Permit for Construction Activities (NCGO1) NCDENR/Division of Water Quality

| NEW STABILIZATION TIMEFRAMES (Effective Aug. 3, 2011) | | |
|--|---------------|--|
| SITE AREA DESCRIPTION | STABILIZATION | TIMEFRAME EXCEPTIONS |
| Perimeter dikes, swales, ditches, slopes | 7 days | None |
| High Quality Water (HQW) Zones | 7 days | None |
| Slopes steeper than 3:1 | 7 days | If slopes are 10' or less in length and are not steeper than 2:1, 14 days are allowed. |
| Slopes 3:1 or flatter | 14 days | 7 days for slopes greater than 50' in length. |
| All other areas with slopes flatter than 4:1 | 14 days | None, except for perimeters and HQW Zones. |

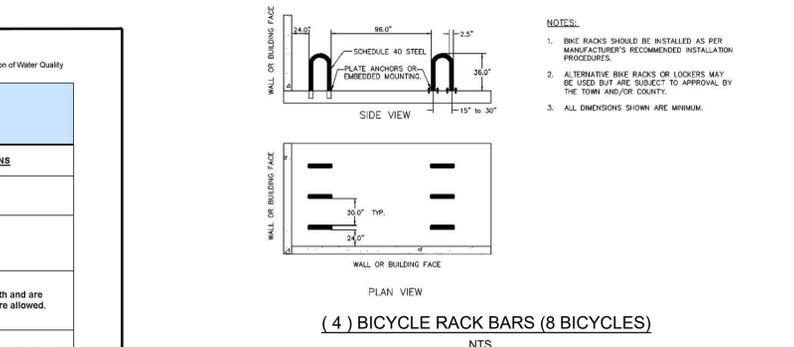


(4) BICYCLE RACK BARS (8 BICYCLES)
 NTS

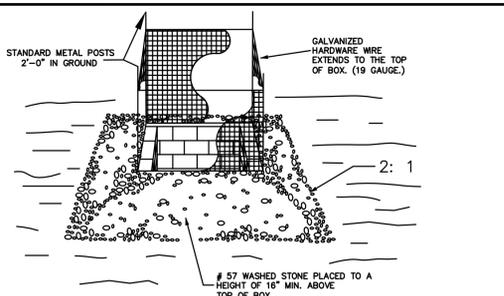


CONSTRUCTION SPECIFICATIONS:
 1. UNIFORMLY GRADE A SHALLOW DEPRESSION APPROACHING INLET.
 2. DRIVE 5" STEEL POSTS 2 FEET INTO THE GROUND SURROUNDING THE INLET. SPACE POSTS EVENLY AROUND THE PERIMETER OF THE INLET, A MAXIMUM OF 4' APART.
 3. SURROUND THE POSTS WITH WIRE MESH HARDWARE CLOTH. SECURE THE WIRE MESH TO THE STEEL POSTS AT THE TOP, MIDDLE, & BOTTOM. PLACING A 2"-FT. FLAP OF THE WIRE MESH UNDER THE GRAVEL FOR ANCHORING IS RECOMMENDED.
 4. PLACE CLEAN GRAVEL (NO DOT #5 OR #57 STONE) ON A 2:1 SLOPE WITH A HEIGHT OF 16" AROUND THE WIRE, AND SMOOTH TO AN EVEN GRADE.
 5. ONCE THE CONTRIBUTING DRAINAGE AREA HAS BEEN STABILIZED, REMOVE ACCUMULATED SEDIMENT, AND ESTABLISH FINAL GRADING ELEVATIONS.
 6. COMPACT THE AREA PROPERLY AND STABILIZE IT WITH GROUND COVER.

MAINTENANCE:
 INSPECT INLETS AT LEAST WEEKLY AND AFTER EACH SIGNIFICANT (1" OR GREATER) RAINFALL EVENT. CLEAR THE WIRE MESH OF ANY DEBRIS OR OTHER OBJECTS TO PROVIDE ADEQUATE FLOW FOR SUBSEQUENT RAINS. TAKE CARE NOT TO DAMAGE OR UNDERCUT THE WIRE MESH DURING SEDIMENT REMOVAL. REPLACE STONE AS NEEDED.

Inlet Protection
 Not to scale

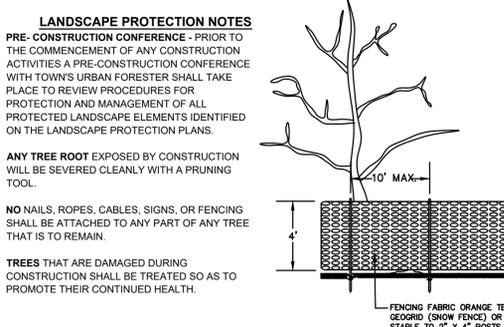


Tree Protection Fence Detail
 Not to scale

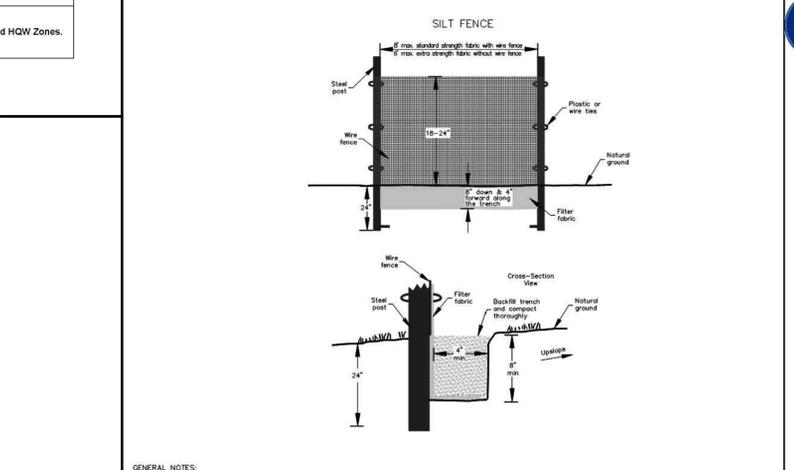


GENERAL NOTES:
 1. Use silt fence only when drainage area does not exceed 1/4 acre and never in areas of concentrated flow.
 2. Silt fence shall not be removed unless site is stabilized and inspected by Town of Chapel Hill staff.


NOTE: DRAWING NOT TO SCALE

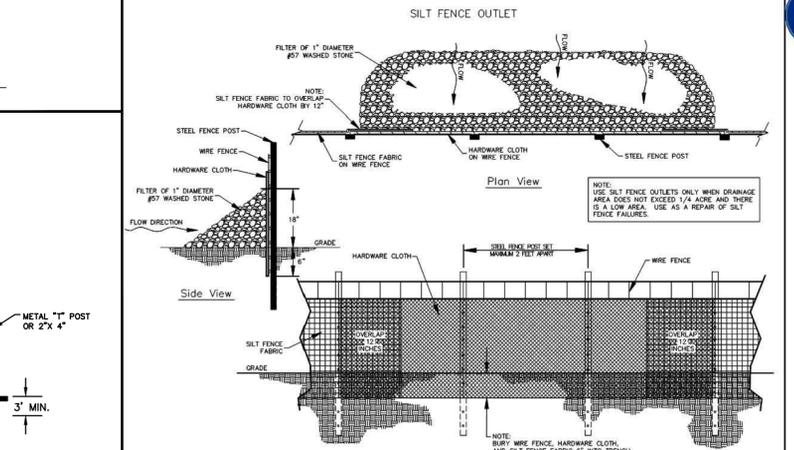


Silt Fence Outlet
 TITLE: SILT FENCE OUTLET REVISIONS: 08/13 15 DET. NO: SD-19

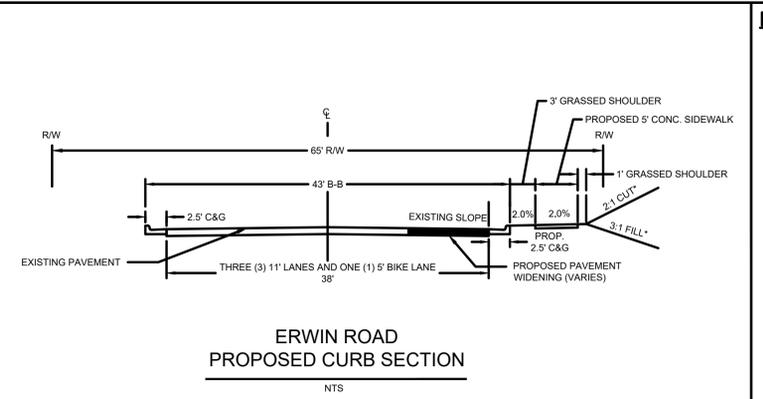


ERWIN ROAD PROPOSED CURB SECTION
 NTS

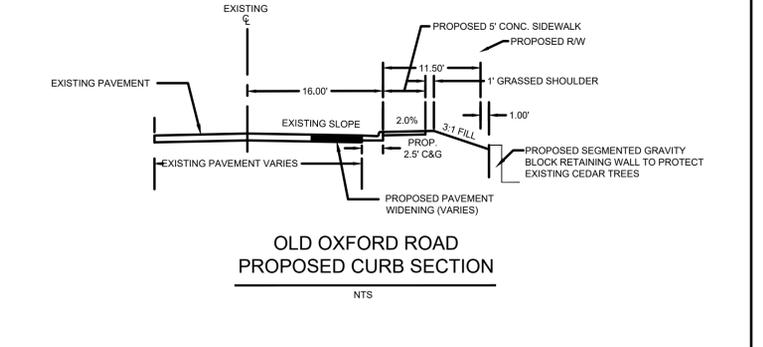

OLD OXFORD ROAD PROPOSED CURB SECTION
 NTS

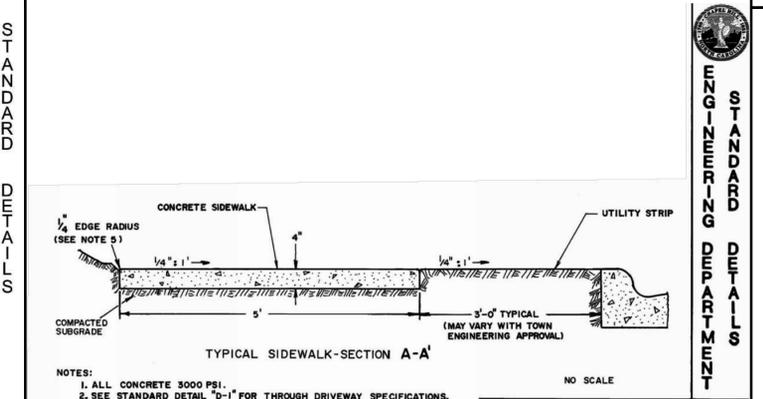

NOTES:
 1. ALL CONCRETE 3000 PSI.
 2. SEE STANDARD DETAIL "D-1" FOR THROUGH DRIVEWAY SPECIFICATIONS.
 3. EXPANSION JOINTS 50' APART MAXIMUM.
 4. CONTROL JOINT EVERY 5 FEET.
 5. ALL SIDEWALKS SHALL BE CONSTRUCTED WITH TOOLED 1/4" EDGE RADIUS.
 6. IF UTILITY STRIP IS COMPLETELY ELIMINATED, SIDEWALK SHALL BE PLACED DIRECTLY AT BACK-OF-CURB WITH 1/4" EDGE RADIUS.

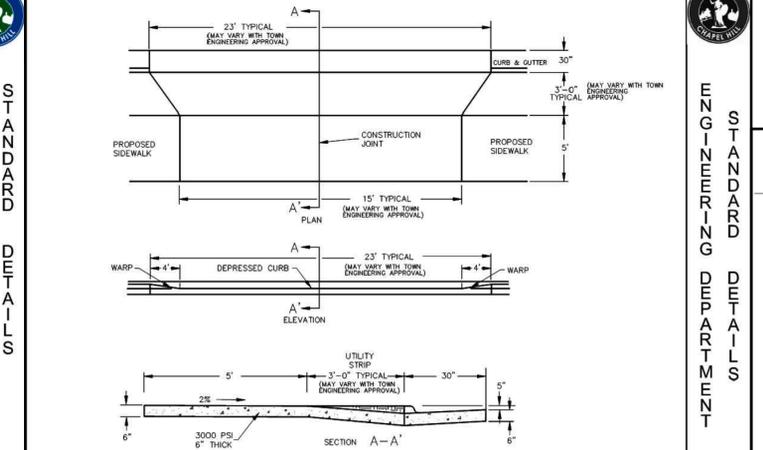

Typical Driveway Entrance
 TITLE: FAN TYPE DRIVEWAY ENTRANCE REVISIONS: 10/15 MR DET. NO: D-1

PERMANENT SEEDING IN NORTH CAROLINA (TABLE 6.11)

| SEEDING MIXTURE SPECIES | RATE (LB/ACRE) |
|-------------------------|----------------|
| TALL FESCUE | 250 |
| SERICEA LESPEDEZA | 20 |
| KOBE LESPEDEZA | 10 |
| | 50 |

SEEDING NOTES:
 1. AFTER AUGUST 15 USE UNSCARIFIED SERICEA SEED.
 2. WHERE PERIODIC MOWING IS PLANNED OR A NEAR APPEARANCE IS DESIRED, OMIT SERICEA AND INCREASE KOBE LESPEDEZA TO 40 LB/ACRE.
 3. TO EXTEND SPRING SEEDING DATES INTO JUNE, ADD 15LB/ACRE HULLED BERMOUDAGRASS. HOWEVER, AFTER MID-APRIL IT IS PREFERABLE TO SEED TEMPORARY COVER.

NURSE PLANTS:
 BETWEEN MAY 1 AND AUGUST 15, ADD 10 LB/ACRE GERMAN MILLET OR 15LB/ACRE SUDANGRASS. PRIOR TO MAY 1 OR AFTER AUGUST 15 ADD 40 LB/ACRE RYE (GRAIN).

SEEDING DATES:

| FALL: | BEST | POSSIBLE |
|--------------------------|------------------------|------------------------|
| AUGUST 25 - SEPTEMBER 15 | | AUGUST 20 - OCTOBER 25 |
| LATE WINTER: | FEBRUARY 15 - MARCH 21 | FEBRUARY 1 - APRIL 15 |

SOIL AMENDMENTS:
 APPLY LIME AND FERTILIZER ACCORDING TO SOIL TESTS, OR APPLY 4,000 LB/ACRE GROUND AGRICULTURAL LIMESTONE AND 1,000 LB/ACRE 10-10-10 FERTILIZER.

MULCH:
 APPLY 4,000 LB/ACRE GRAIN STRAW OR EQUIVALENT COVER OF ANOTHER SUITABLE MULCH. ANCHOR STRAW BY TACKING WITH ASPHALT, NETTING OR ROVING OR BY CRIMPING WITH A MULCH ANCHORING TOOL. A DISK WITH BLADES SET NEARLY STRAIGHT CAN BE USED AS A MULCH ANCHORING TOOL.

MAINTENANCE:
 REFER FERTILIZER IN THE SECOND YEAR UNLESS GROWTH IS FULLY ADEQUATE. MAY BE MOWED ONCE OR TWICE A YEAR, BUT MOWING IS NOT NECESSARY. RESEED, FERTILIZE AND MULCH DAMAGED AREAS IMMEDIATELY.

SEEDING SCHEDULE

- 1) CHISEL COMPACTED AREAS AND SPREAD TOPSOIL 3 INCHES DEEP OVER ADVERSE SOIL CONDITIONS, IF AVAILABLE.
- 2) RIP THE ENTIRE AREA TO 6 INCHES DEPTH.
- 3) REMOVE ALL LOOSE ROCK, ROOTS, AND OTHER OBSTRUCTIONS LEAVING SURFACE REASONABLY SMOOTH AND UNIFORM.
- 4) APPLY AGRICULTURAL LIME, FERTILIZER, AND UNIFORMLY MIX WITH SOIL (SEE BELOW).
- 5) SEED ON A FRESHLY PREPARED SEEDBED AND SEED LIGHTLY WITH SEEDING EQUIPMENT OR CULTIPACK.
- 6) MULCH IMMEDIATELY AFTER SEEDING.
- 7) INSPECT ALL SEEDING AREAS AND MAKE NECESSARY RESEEDINGS WITHIN THE PLANTING SEASON, IF POSSIBLE. STAND SHOULD BE OVER 60% DAMAGED, REESTABLISH WITH ORIGINAL LIME, FERTILIZER AND SEEDING RATES.
- 8) CONSULT CONSERVATION INSPECTOR ON MAINTENANCE AND FERTILIZATION AFTER PERMANENT COVER IS STABILIZED.

SEED PREPARATION:
 * APPLY:
 AGRICULTURAL LIMESTONE - 2 TONS/ACRES (3 TONS/ACRE IN CLAY SOILS)
 FERTILIZER - 1,000 lbs. / ACRE - 10-10-10
 SUPERPHOSPHATE - 500 lbs* / ACRE - 20% ANALYSIS
 MILCH - 2 TONS / ACRE (500 LBS/AC FOR STEEP SLOPES) - SMALL GRAIN STRAW
 ANOTHER - ASPHALT EMULSION @ 300 GALS./ACRE

MAINTENANCE:
 NEW SEEDLINGS SHOULD BE INSPECTED FREQUENTLY AND MAINTENANCE PERFORMED AS NEEDED. IF RILLS AND GULLIES DEVELOP, THEY MUST BE FILLED, RE-SEED, AND MULCHED AS SOON AS POSSIBLE. DIVERSIONS MAY BE NEEDED UNTIL NEW PLANTS TAKE HOLD.

DAMAGE TO VEGETATION FROM DISEASE, INSECTS, TRAFFIC, ETC., CAN OCCUR AT ANY TIME. HERBICIDES AND REGULAR MOWING MAY BE NEEDED TO CONTROL WEEDS, DUST AND SPRAYS MAY BE NEEDED TO CONTROL INSECTS.

WEEK OR DAMAGED SPOTS MUST BE RELIEM, FERTILIZED, MULCHED, AND RESEED AS PROMPTLY AS POSSIBLE.

TEMPORARY SEEDING IN NORTH CAROLINA

| SEASON | SEEDING MIXTURE SPECIES | RATE (LB/ACRE) |
|----------------------------|---|----------------|
| LATE WINTER & EARLY SPRING | RYE (GRAIN) ANNUAL LESPEDEZA (KOBE IN PIEDMONT AND COASTAL PLAIN, KOREAN IN MOUNTAINS) | 120 50 |
| SUMMER | GERMAN MILLET OMIT ANNUAL LESPEDEZA WHEN DURATION OF TEMPORARY COVER IN THE PIEDMONT AND MOUNTAINS, A SMALL-STEMMED SUNDAGRASS | 40 |
| FALL | RYE (GRAIN) | 120 |


SEEDING DATES:

| SEASON | RECOMMENDATIONS |
|----------------------------|--|
| LATE WINTER & EARLY SPRING | MOUNTAINS - ABOVE 2500 ft. FEB. 15 - MAY 15 PIEDMONT - JAN. 1 - AUG. 15 COASTAL PLAIN - DEC. 1 - APR. 15 |
| SUMMER | MOUNTAINS - MAY 15 - AUG. 15 PIEDMONT - MAY 1 - AUG. 15 COASTAL PLAIN - APR. 15 - AUG. 15 |
| FALL | MOUNTAINS - AUG. 15 - DEC. 15 COASTAL PLAIN AND PIEDMONT - AUG. 15 - DEC. 30 |

SOIL AMENDMENTS:
 FOLLOW RECOMMENDATIONS OF SOIL TESTS OR APPLY 2,000 LB/ACRE GROUND AGRICULTURAL LIMESTONE AND 750 LBS/ACRE 10-10-10 FERTILIZER

MULCH:
 APPLY 4,000 LB/ACRE STRAW. ANCHOR STRAW BY TACKING WITH ASPHALT, NETTING OR A MULCH ANCHORING TOOL. A DISK WITH BLADES SET NEARLY STRAIGHT CAN BE USED AS A MULCH ANCHORING TOOL.

MAINTENANCE:
 REFER FERTILIZER IF GROWTH IS NOT FULLY ADEQUATE. RESEED, FERTILIZE AND MULCH IMMEDIATELY FOLLOWING EROSION OR OTHER DAMAGE.

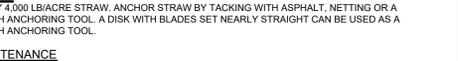

CONCRETE WASHOUT PIT

1. INSTALL CONCRETE WASHOUT PIT AT LOCATIONS SHOWN ON PLANS.
2. LINE PIT WITH IMPERVIOUS FABRIC OR POLYETHYLENE SHEET. ANCHOR FABRIC INTO GROUND OUTSIDE PIT AS SHOWN.
3. MAXIMUM WATER AND SEDIMENT DEPTH IS 12". PIT MUST BE EXCAVATED AND RE-LINED WHEN DEPTH OF SEDIMENT REACHES 12" OR COMBINED WATER/SEDIMENT DEPTH EXCEEDS 12" FOLLOWING WASHOUT OF CONCRETE TRUCK.
4. ALLOW WATER TO EVAPORATE COMPLETELY PRIOR TO EXCAVATING PIT.
5. WASHOUT PIT MAY BE LOCATED NO CLOSER THAN 8' TO DRAINAGE INLETS, OR SURFACE WATERS.

CONCRETE WASHOUT PIT

Philip N. Post, PE, PLS
 (919) 818-7862
 philip.n.post@gmail.com
 PO Box 4932
 Chapel Hill, NC 27515

PHILIP POST ENGINEERING FIRM, C-347

ALL DIMENSIONS MUST BE VERIFIED BY CONTRACTOR AND OWNER MUST BE NOTIFIED OF ANY DISCREPANCIES BEFORE PROCEEDING WITH WORK

CHRIST COMMUNITY CHURCH
 141 ERWIN ROAD, CHAPEL HILL, N.C. 27514
 PH# 9799-39-9116 AND 9799-49-0235

CHRIST COMMUNITY CHURCH
 1528 E. FRANKLIN STREET, SUITE 201
 CHAPEL HILL, N.C. 27514

| # | DC | #DC | DC | DC | DC | DC | BY |
|---|---------------------------|-----|----|----|----|----|----|
| # | NCDOT AND TOWN COMMENTS | | | | | | |
| # | TOWN COMMENTS | | | | | | |
| # | PROPERTY LINE SWAP | | | | | | |
| # | SUBMITTAL #2 COMMENTS | | | | | | |
| # | OWASA 11/13/2019 COMMENTS | | | | | | |
| # | SUBMITTAL #1 COMMENTS | | | | | | |
| # | NO. | | | | | | |
| # | DATE | | | | | | |

ALL DOCUMENTS PREPARED BY PHILIP POST ENGINEERING ARE INSTRUMENTS OF SERVICE IN RESPECT OF THE PROJECT. THEY ARE NOT INTENDED OR REPRESENTED TO BE SUITABLE FOR REUSE BY OWNER OR OTHERS ON THE EXTENSIONS OF THE PROJECT OR ON ANY OTHER PROJECT. ANY REUSE WITHOUT WRITTEN VERIFICATION OR ADAPTATION BY PHILIP POST ENGINEERING FOR THE SPECIFIC PURPOSE INTENDED WILL BE AT OWNERS SOLE RISK AND WITHOUT LIABILITY ON LEGAL EXPENSE TO PHILIP POST ENGINEERING. AND OWNER SHALL INDEMNIFY AND HOLD HARMLESS PHILIP POST ENGINEERING FROM ALL CLAIMS, DAMAGES, LOSSES AND EXPENSES ARISING OUT OF OR FROM THIS INSTRUMENT.

PROJECT: 401801


DATE: 8/28/2019

DRAWING SCALE: -

DRAWN BY: DC

APPROVED BY: PP

PRELIMINARY NOT FOR CONSTRUCTION

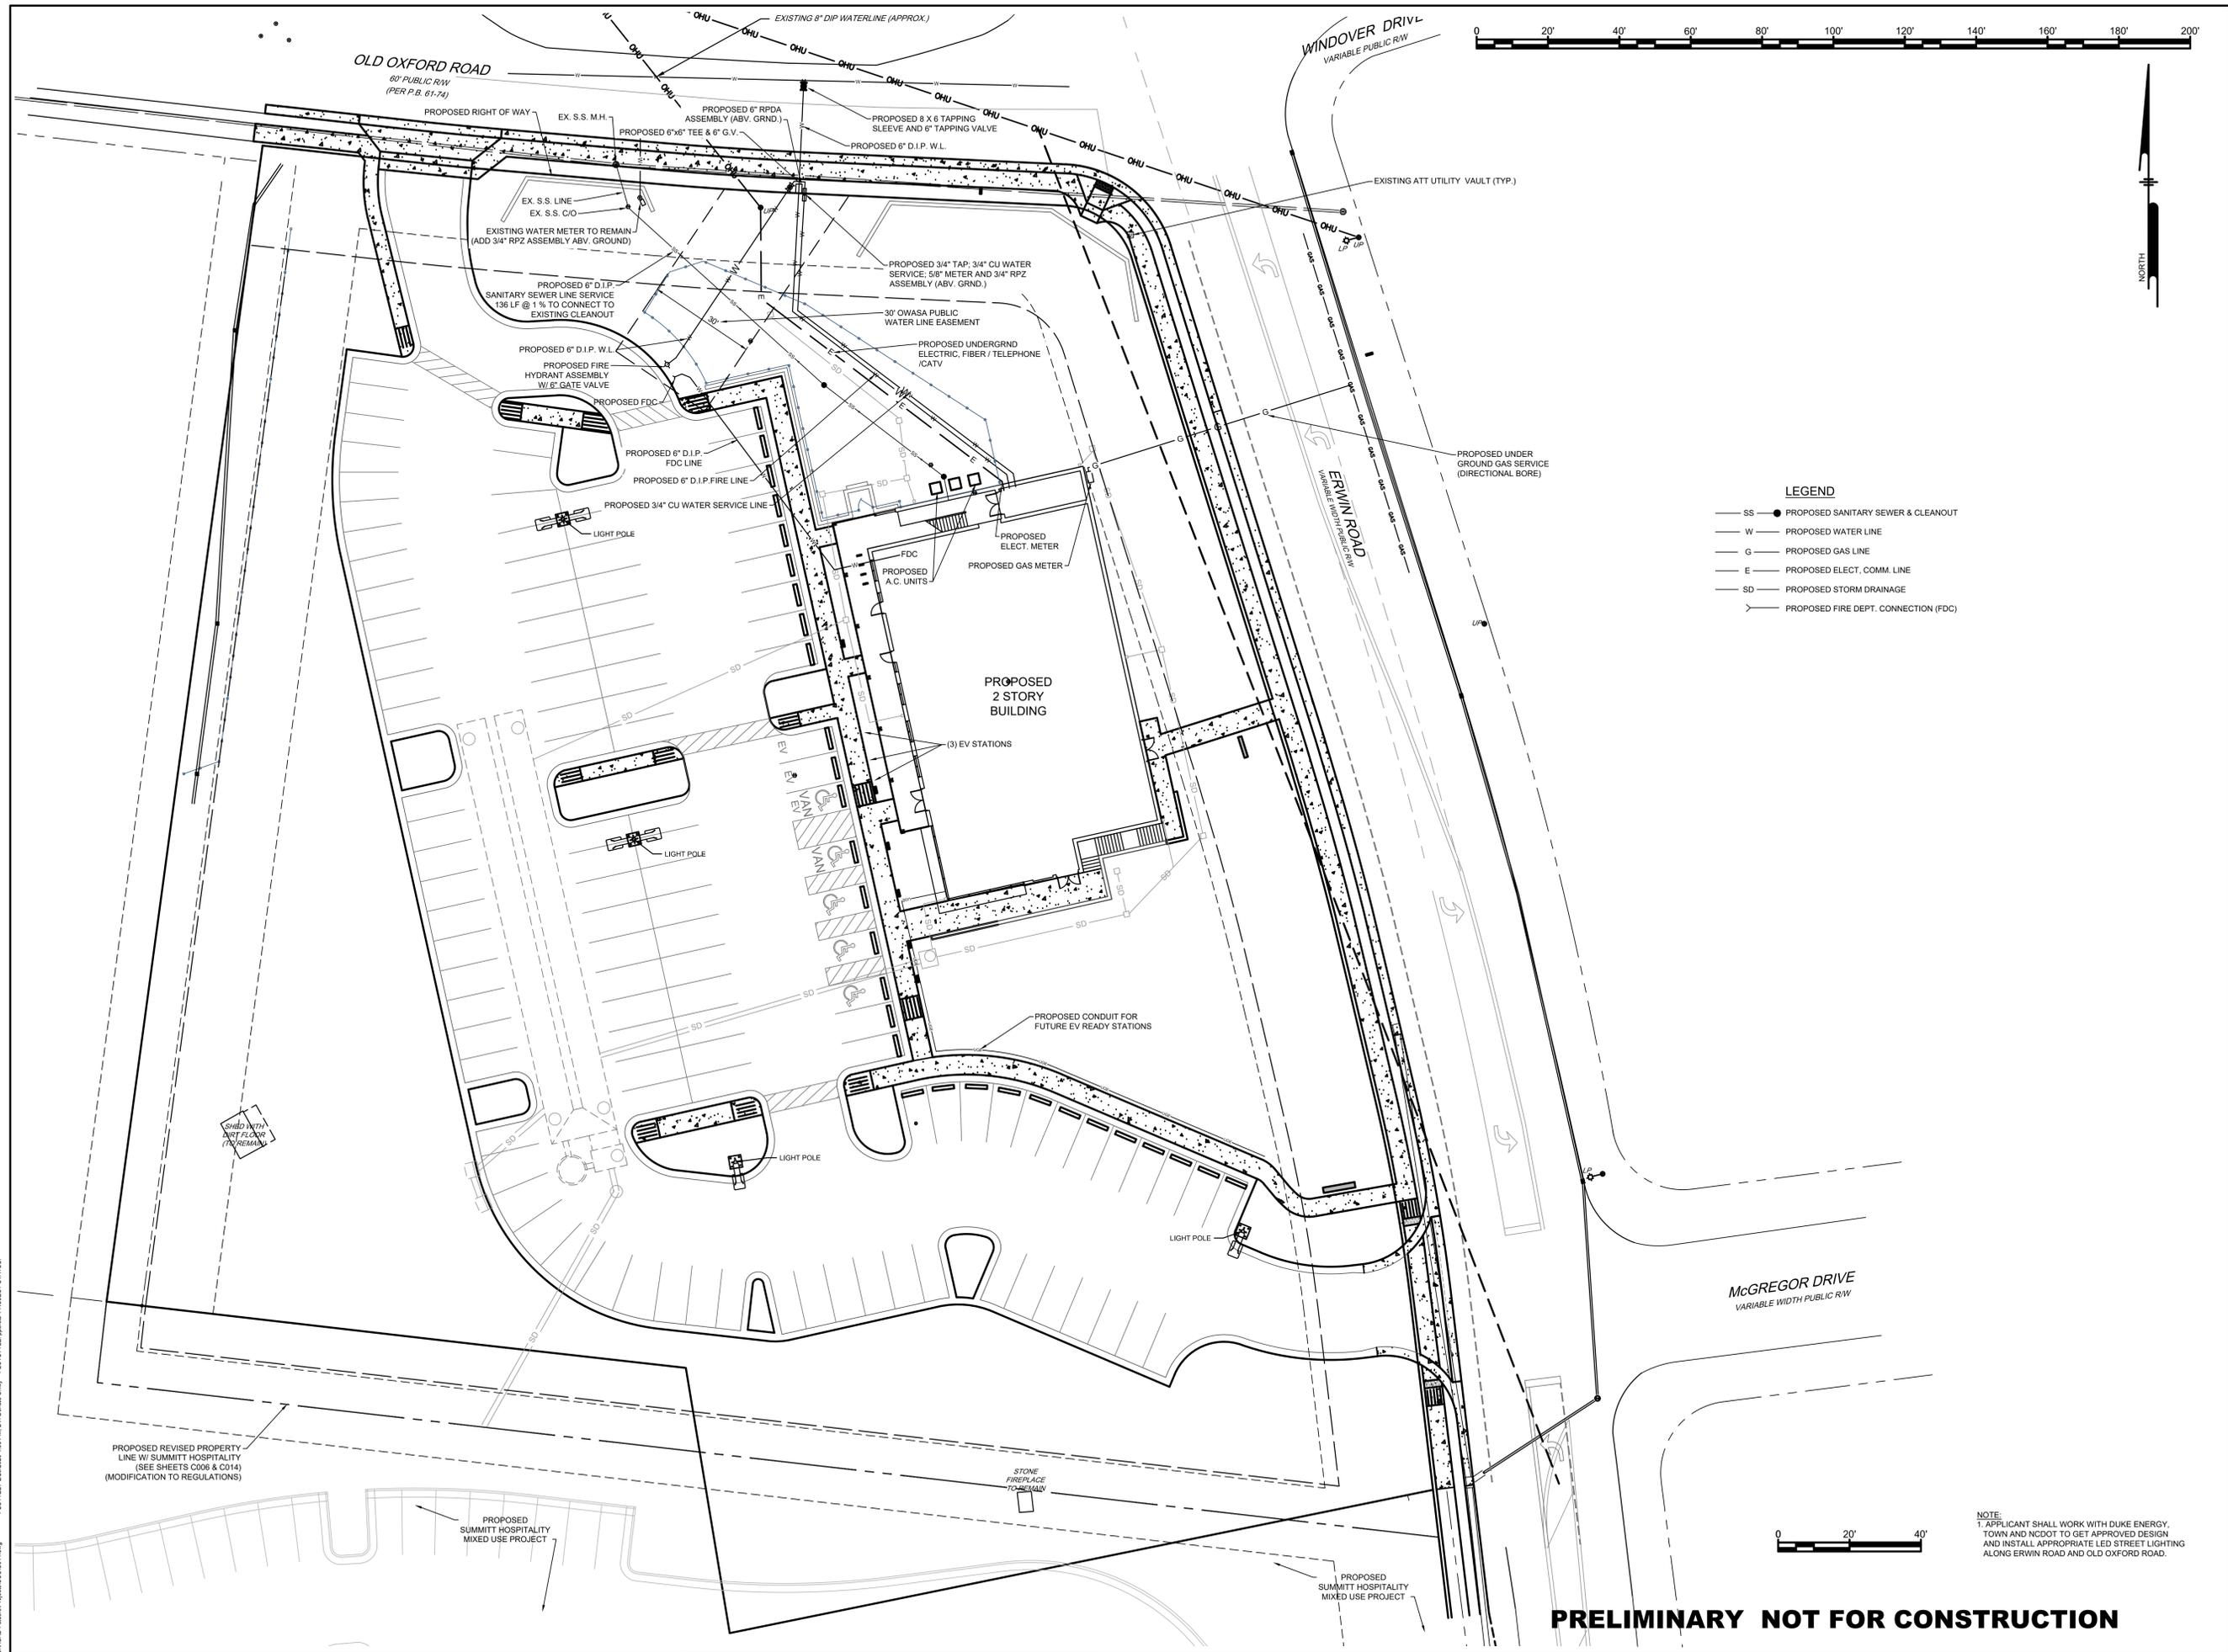

Philip N. Post, PE, PLS
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 PO Box 4912
 Chapel Hill, NC 27515

PHILIP
 POST
 ENGINEERING
 FIRM: C-347

ALL DIMENSIONS MUST BE VERIFIED BY CONTRACTOR AND OWNER MUST BE NOTIFIED OF ANY DISCREPANCIES BEFORE PROCEEDING WITH WORK

CHRIST COMMUNITY CHURCH
 141 ERWIN ROAD, CHAPEL HILL, N.C. 27514
 P/N# 9799-39-9116 AND 9799-49-0235

UTILITY PLAN & FIRE DEPT. FDC

APPLICANT:
CHRIST COMMUNITY CHURCH
 1528 E. FRANKLIN STREET, SUITE 201
 CHAPEL HILL, N.C. 27514

| # | DATE | NO. | BY | REVISIONS |
|------------|------|-----|----|---------------------------|
| 2/26/2020 | 6 | | | NCDOT AND TOWN COMMENTS |
| 2-9-2020 | 5 | | | TOWN COMMENTS |
| 1-27-2020 | 4 | | | PROPERTY LINE SWAP |
| 1-17-2020 | 3 | | | SUBMITTAL #2 COMMENTS |
| 12-27-2019 | 2 | | | OWASA 11/13/2019 COMMENTS |
| 11-17-2019 | 1 | | | SUBMITTAL #1 COMMENTS |





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PROJECT: 401801
 DATE: 8/28/2019
 DRAWING SCALE: 1" = 20'
 DRAWN BY: DC
 APPROVED BY: PNP

PRELIMINARY NOT FOR CONSTRUCTION

NOTE:
 1. APPLICANT SHALL WORK WITH DUKE ENERGY, TOWN AND NCDOT TO GET APPROVED DESIGN AND INSTALL APPROPRIATE LED STREET LIGHTING ALONG ERWIN ROAD AND OLD OXFORD ROAD.

C:\ACAD\Projects\19082019\19082019.dwg PLOTFILE: 20200828-10:58:46 AM BY: Donald Chisholm PLOTFILE: 19082019.dwg PROJECT STATUS: —

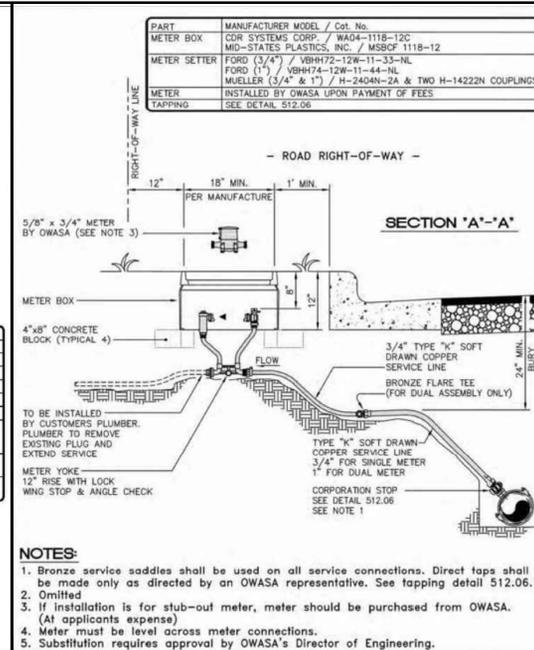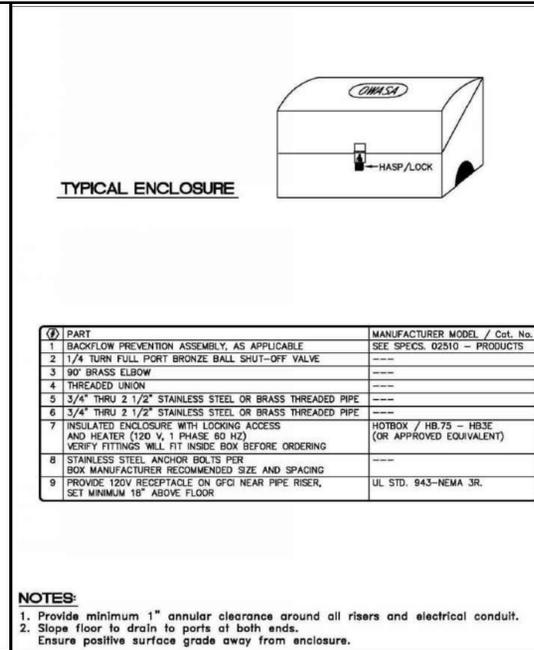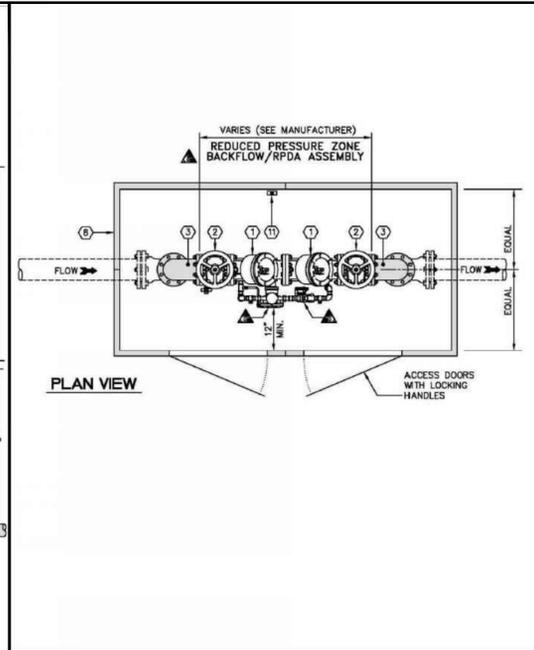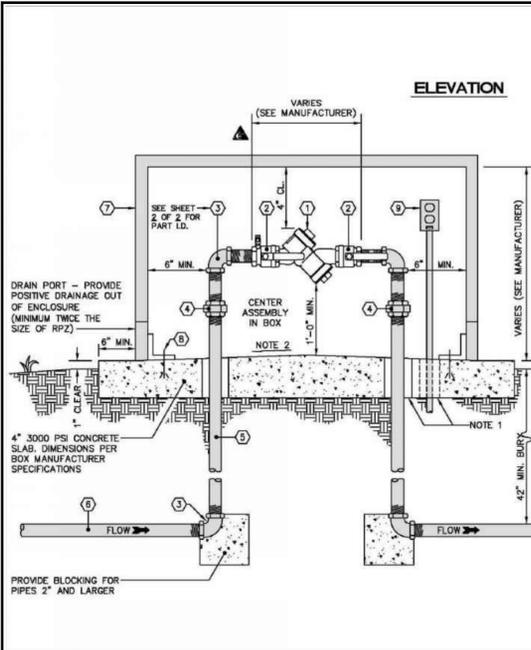

ORANGE WATER AND SEWER AUTHORITY
 400 Jones Ferry Road, PO Box 366, Cary, NC 27518-0366
 Voice: (919) 968-4421, Fax: (919) 968-4464, www.owasa.org

3/4" to 2" RPZ ASSEMBLY (ABOVE GROUND)
 SCALE: Not To Scale, DETAIL # 515.06, REVISION DATE: December 20, 2016

ORANGE WATER AND SEWER AUTHORITY
 400 Jones Ferry Road, PO Box 366, Cary, NC 27518-0366
 Voice: (919) 968-4421, Fax: (919) 968-4464, www.owasa.org





2 1/2" to 10" RPZ, RPDA ASSEMBLY (ABOVE GROUND)
 SCALE: Not To Scale, DETAIL # 515.10, REVISION DATE: December 20, 2016

ORANGE WATER AND SEWER AUTHORITY
 400 Jones Ferry Road, PO Box 366, Cary, NC 27518-0366
 Voice: (919) 968-4421, Fax: (919) 968-4464, www.owasa.org

3/4" to 2" RPZ ASSEMBLY (ABOVE GROUND)
 SCALE: Not To Scale, DETAIL # 515.06, REVISION DATE: December 20, 2016

ORANGE WATER AND SEWER AUTHORITY
 400 Jones Ferry Road, PO Box 366, Cary, NC 27518-0366
 Voice: (919) 968-4421, Fax: (919) 968-4464, www.owasa.org

3/4" SINGLE & 1" DUAL SERVICE INSTALLATION
 SCALE: Not To Scale, DETAIL # 515.01, REVISION DATE: November 28, 2012

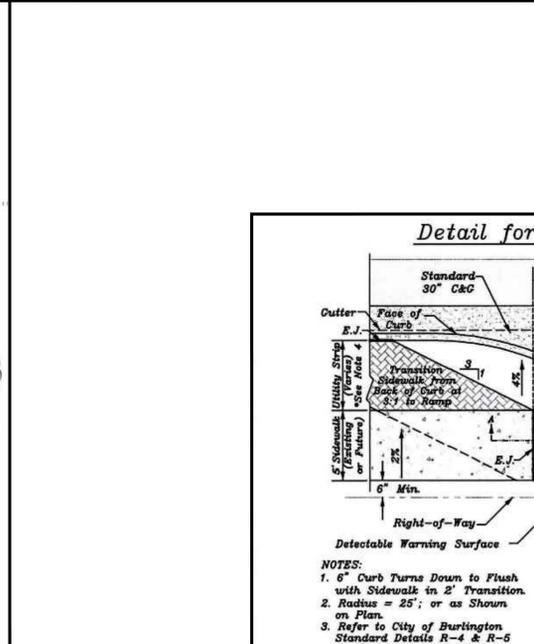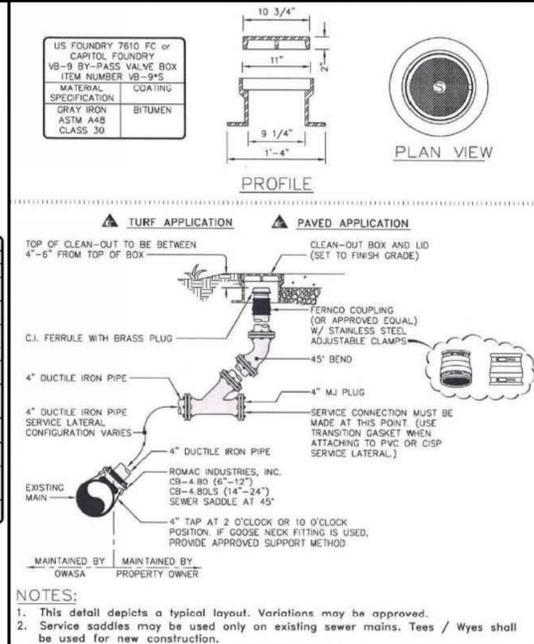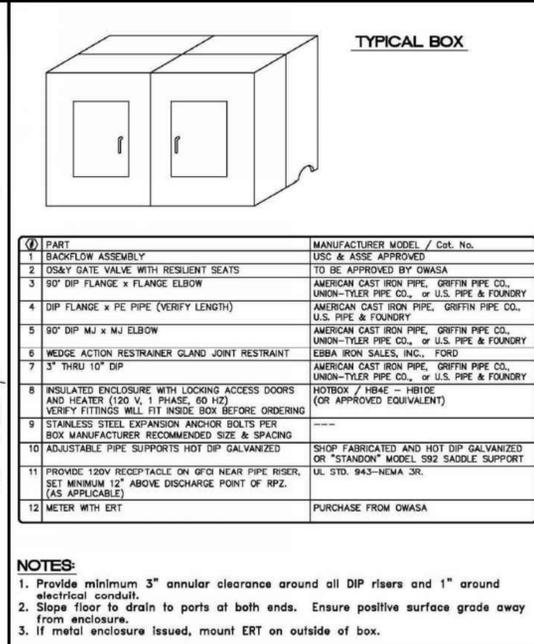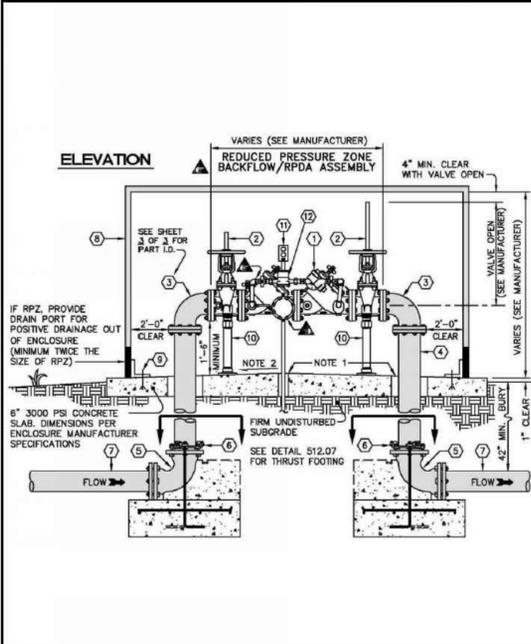

ORANGE WATER AND SEWER AUTHORITY
 400 Jones Ferry Road, PO Box 366, Cary, NC 27518-0366
 Voice: (919) 968-4421, Fax: (919) 968-4464, www.owasa.org



2 1/2" to 10" RPZ, RPDA ASSEMBLY (ABOVE GROUND)
 SCALE: Not To Scale, DETAIL # 515.10, REVISION DATE: December 20, 2016

ORANGE WATER AND SEWER AUTHORITY
 400 Jones Ferry Road, PO Box 366, Cary, NC 27518-0366
 Voice: (919) 968-4421, Fax: (919) 968-4464, www.owasa.org

2 1/2" to 10" RPZ, RPDA ASSEMBLY (ABOVE GROUND)
 SCALE: Not To Scale, DETAIL # 515.10, REVISION DATE: December 20, 2016

ORANGE WATER AND SEWER AUTHORITY
 400 Jones Ferry Road, PO Box 366, Cary, NC 27518-0366
 Voice: (919) 968-4421, Fax: (919) 968-4464, www.owasa.org

4" SEWER TAP AND STUB-OUT PAVED APPLICATION CLEAN OUT
 SCALE: Not To Scale, DETAIL # 534.01, REVISION DATE: April 18, 2017

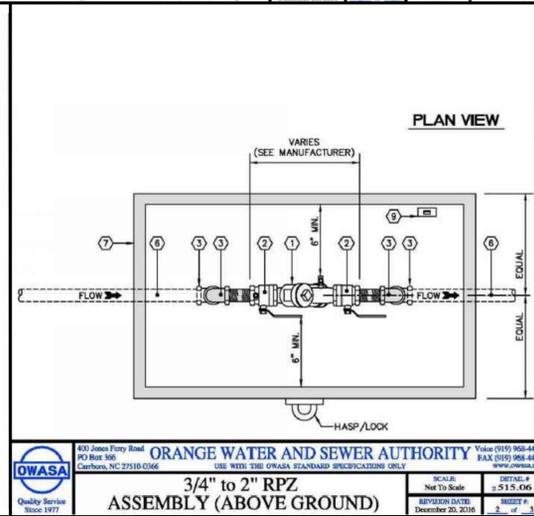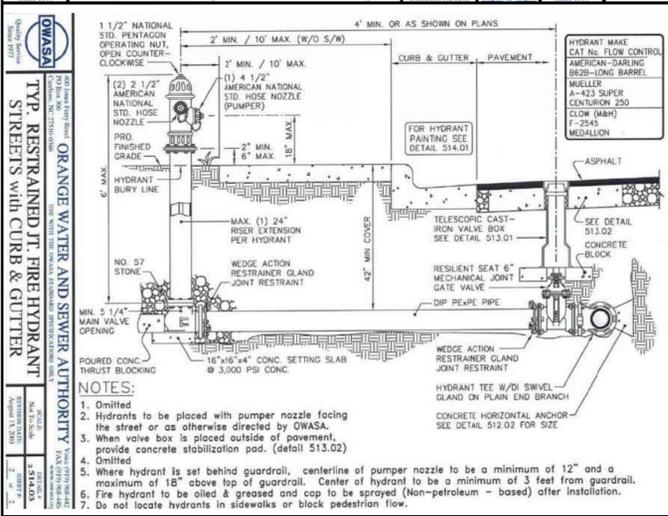

ORANGE WATER AND SEWER AUTHORITY
 400 Jones Ferry Road, PO Box 366, Cary, NC 27518-0366
 Voice: (919) 968-4421, Fax: (919) 968-4464, www.owasa.org

3/4" to 2" RPZ ASSEMBLY (ABOVE GROUND)
 SCALE: Not To Scale, DETAIL # 515.06, REVISION DATE: December 20, 2016

ORANGE WATER AND SEWER AUTHORITY
 400 Jones Ferry Road, PO Box 366, Cary, NC 27518-0366
 Voice: (919) 968-4421, Fax: (919) 968-4464, www.owasa.org

3/4" to 2" RPZ ASSEMBLY (ABOVE GROUND)
 SCALE: Not To Scale, DETAIL # 515.06, REVISION DATE: December 20, 2016

ORANGE WATER AND SEWER AUTHORITY
 400 Jones Ferry Road, PO Box 366, Cary, NC 27518-0366
 Voice: (919) 968-4421, Fax: (919) 968-4464, www.owasa.org

4" SEWER TAP AND STUB-OUT PAVED APPLICATION CLEAN OUT
 SCALE: Not To Scale, DETAIL # 534.01, REVISION DATE: April 18, 2017

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 philip.n.post@gmail.com
 PO Box 4932
 Chapel Hill, NC 27515

PHILIP POST ENGINEERING FIRM, C-347

CHRIST COMMUNITY CHURCH
 141 ERWIN ROAD, CHAPEL HILL, N.C. 27514
 PHONE 9799-39-9116 AND 9799-46-0235

UTILITY AND DRIVEWAY ENTRANCE DETAILS

APPLICANT:
CHRIST COMMUNITY CHURCH
 1526 E. FRANKLIN STREET, SUITE 201
 CHAPEL HILL, N.C. 27514

| # | DC | #DC | DC | DC | DC | DC | BY |
|---|----|-----|----|----|----|----|----|
| 1 | | | | | | | |
| 2 | | | | | | | |
| 3 | | | | | | | |
| 4 | | | | | | | |
| 5 | | | | | | | |
| 6 | | | | | | | |

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PROJECT: 401801
 DATE: 8/28/2019
 DRAWING SCALE: -
 DRAWN BY: DC
 APPROVED BY: PP

C012
 SHEET 13 OF 16



| Curve | Radius | Length | Delta | Tan. Chord | Chord Bear. |
|-------|----------|---------|----------|------------|-----------------------|
| C-1 | 1019.46' | 185.31' | 1024°53' | 92.91' | 185.05' N 12°32'55" W |
| C-2 | 994.46' | 180.77' | 1024°53' | 90.63' | 180.52' N 12°32'55" W |

SLOPE ANALYSIS:

- 15% - 25% AREA #2 - 528 SF
THIS SMALL AREA WILL BE 100%
ELIMINATED DURING MASS GRADING
- GREATER THAN 25%:
THERE ARE NO AREAS GREATER THAN 25%
- OTHER AREAS #1 AND #3 ARE LESS THAN
400 SF AND IN THE 15% - 25% SLOPES

LEGEND

- EXISTING IRON PIPES
- EX - EXISTING IRON PIPE
- △ CONC. MON.
- CONC. MON.
- UP - UTILITY POLE
- SH - SHEDDING BEARING WALLS
- OHU - OVERHEAD UTILITY LINE

PRELIMINARY NOT FOR CONSTRUCTION

PHILIP POST ENGINEERING
 PHILIP POST ENGINEERING
 FIRM: C-347
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 philip.n.post@gmail.com
 PO Box 4912
 Chapel Hill, NC 27515

CHRIST COMMUNITY CHURCH
 141 ERWIN ROAD, CHAPEL HILL, N.C. 27514
 P/N# 9799-39-9116 AND 9799-49-0235
SLOPE ANALYSIS PLAN
 APPLICANT:
CHRIST COMMUNITY CHURCH
 1528 E. FRANKLIN STREET, SUITE 201
 CHAPEL HILL, N.C. 27514

| # | DATE | NO. | REVISIONS | BY |
|---|------------|-----|---------------------------|----|
| 1 | 11-17-2019 | | SUBMITTAL #1 COMMENTS | |
| 2 | 12-27-2019 | | OWASA 11/13/2019 COMMENTS | |
| 3 | 1-17-2020 | | SUBMITTAL #2 COMMENTS | |
| 4 | 2-9-2020 | | PROPERTY LINE SWAP | |
| 5 | 2-9-2020 | | TOWN COMMENTS | |
| 6 | 2/26/2020 | | NCDOT AND TOWN COMMENTS | |


PROJECT: 401801
 DATE: 8/28/2019
 DRAWING SCALE: 1" = 20'
 DRAWN BY: DC
 APPROVED BY: PP

C013


SHEET 14 OF 16

C:\ACAD\Folder\p\h\c\001\014.dwg PLOTTED: 2/26/2020 4:58 PM BY: Dcnah/Chap PROJECT STATUS: —


BUILDING AREA:
 UPPER FLOOR GSF: 5,510
 LOWER FLOOR GSF: 5,910
 TOTAL GSF: 11,420
 (BALCONY: 737 SF)

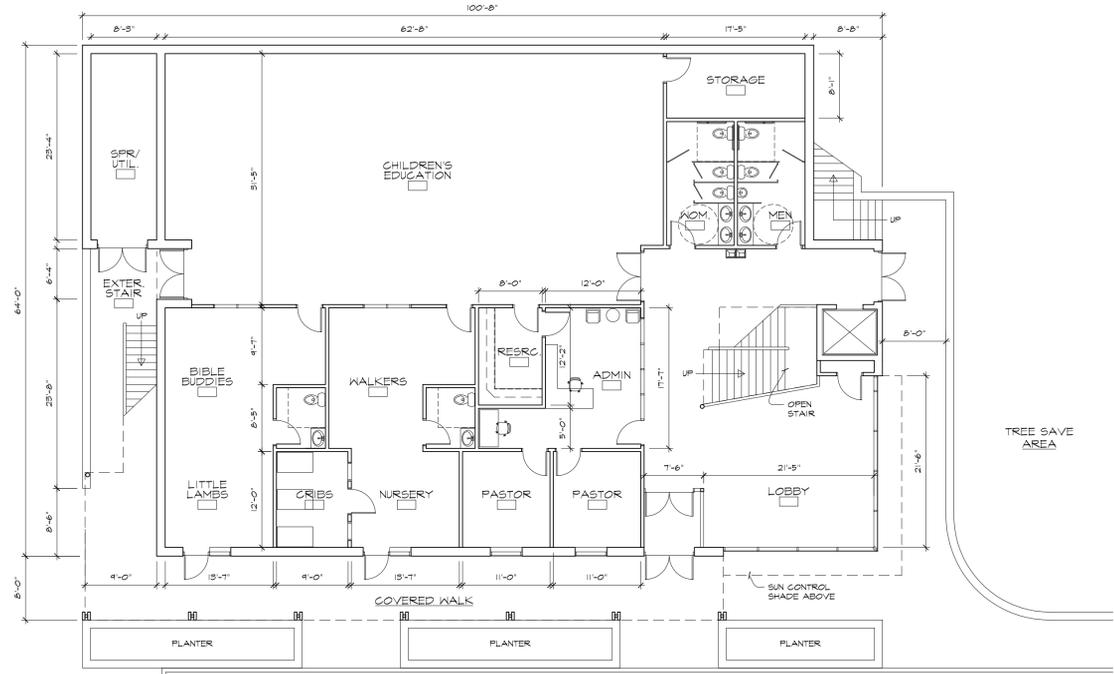



1 LOWER FLOOR PLAN
 A-003 3/32" = 1'-0"

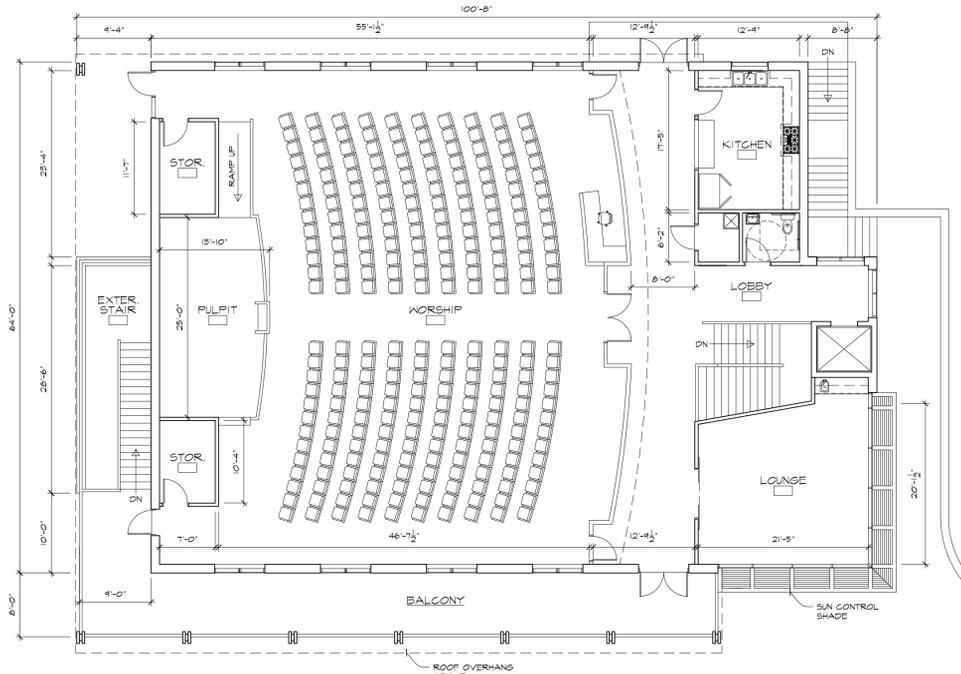


2 UPPER FLOOR PLAN
 A-003 3/32" = 1'-0"

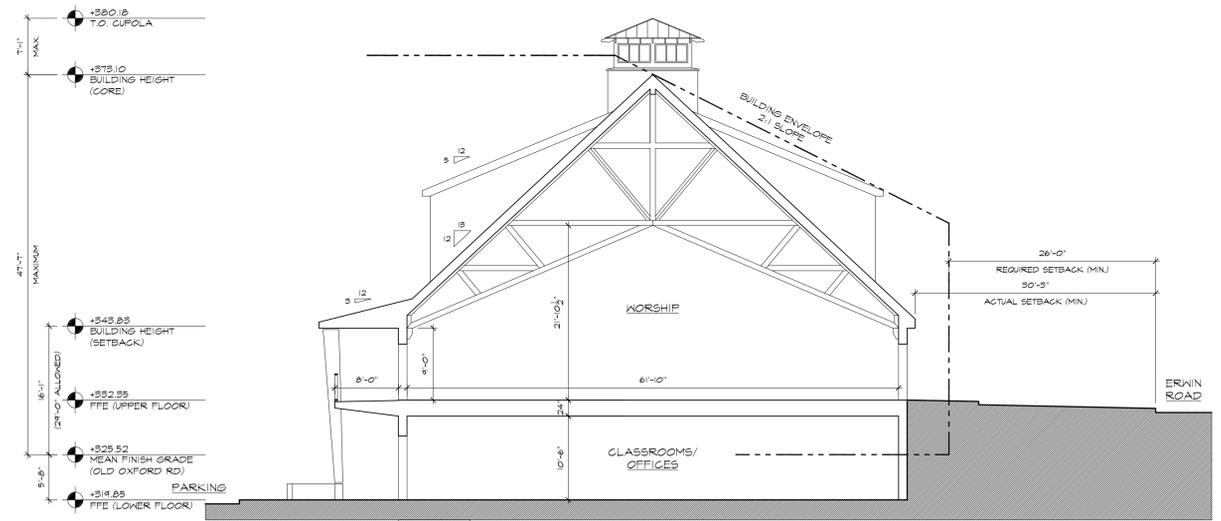

3 BUILDING SECTION
 A-003 3/32" = 1'-0"

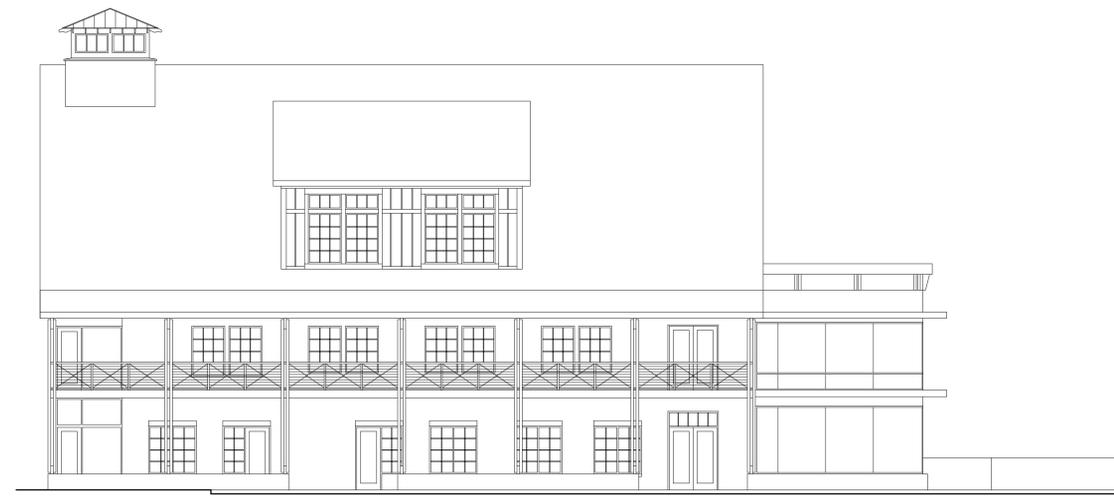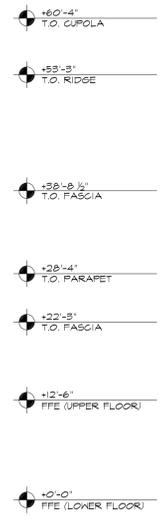


4 NE ELEVATION (PARKING)
 A-003 3/32" = 1'-0"

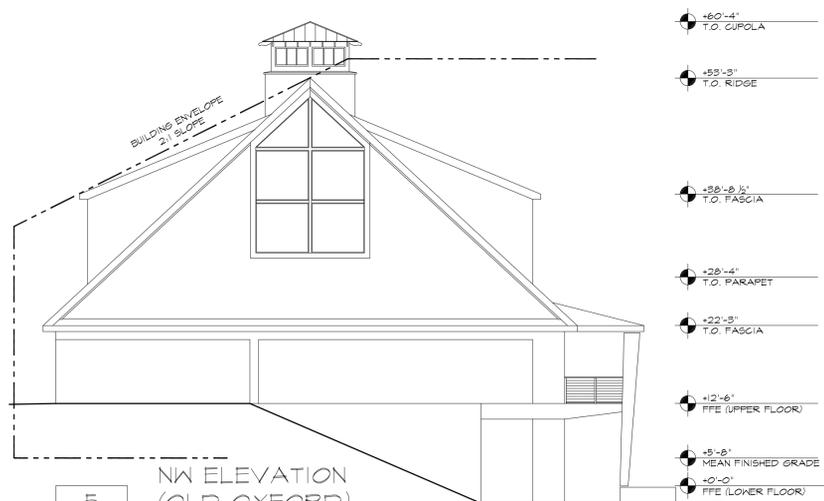

5 NW ELEVATION (OLD OXFORD)
 A-003 3/32" = 1'-0"

** MAXIMUM HEIGHT OF CUPOLA IS WITHIN 15% ABOVE BUILDING ENVELOPE AS ALLOWED BY LINKO 5.8.3(B)(1)
 ** LEADING EDGE OF CUPOLA (FACING ERWIN ROAD) IS 0.9 3/4" HIGHER THAN ALLOWED

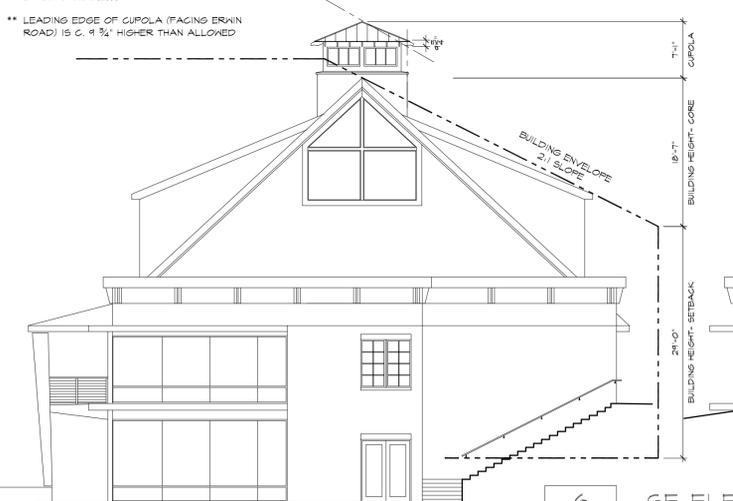

6 SE ELEVATION
 A-003 3/32" = 1'-0"



7 SW ELEVATION (ERWIN ROAD)
 A-003 3/32" = 1'-0"

FOR REVIEW ONLY
 NOT FOR CONSTRUCTION

prepared for
 SUP SUBMITTAL
 project name
CHRIST COMMUNITY CHURCH
 141 ERWIN ROAD
 CHAPEL HILL, NC 27514
 project number
 201801-CCC
 drawing title
 BLDG PLANS
 BLDG SECTION
 BLDG ELEVATIONS
 drawing scale

AS NOTED
 orientation

 revision history

| Mark | Date | Description |
|------|------------|----------------------------|
| | 11/23/2018 | CONCEPT PLAN |
| | 09/02/2019 | SUP SUBMITTAL |
| | 12/12/2019 | SUP SUBMITTAL 1st REVISION |
| | 02/05/2020 | SUP SUBMITTAL 2nd REVISION |

Issue/Revision
 CAD File Name
 Drawn By
 Checked By
 Plot Date:
 Reviewed by
 Designed by
 Submitted By
 Drawing Code

issue date
 02/05/2020
 sheet index

A 003