# PUREFOY ROAD APARTMENTS

# 111 PUREFOY ROAD, CHAPEL HILL, NC 27514

1ST FINAL PLAN SUBMITTAL: APRIL 18, 2019

APPLICANT / OWNER CONSULTANTS:

KEN GORFKLE 1436 POINSETT DRIVE CHAPEL HILL, NC 27717 PHONE: 919-942-1467

LANDSCAPE ARCHITECT: COULTER JEWELL THAMES PA 111 WEST MAIN STREET DURHAM. NC 27701 PHONE: 919-682-0368 CONTACT: ANDREW PORTER


CONTACT: PHIL KIESTER

COULTER JEWELL THAMES PA 111 WEST MAIN STREET DURHAM, NC 27701 PHONE: 919-682-0368 CONTACT: PRESTON ROYSTER

TISE-KIESTER ARCHITECTS 119 E. FRANKLIN STREET, SUITE 300 CHAPEL HILL, NC 27514 PHONF: 919-9670158

111 West Main Street **Durham, N.C. 27701** p 919.682.0368 f 919.688.5646 www.cjtpa.com

NC BOARD OF EXAMINERS FOR ENGINEERS AND SURVEYORS LIC # C-1209 NC BOARD OF LANDSCAPE ARCHITECTS LIC # C-104

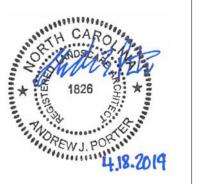

PUREFOY

APARTMENTS

111 PUREFOY ROAD

ORANGE COUNTY NC

CHAPEL HILL NC, 27514

ROAD

VICINITY MAP

. PRIOR TO A CERTIFICATE OF OCCUPANCY CONSTRUCT A 5 FOOT WIDE CONCRETE SIDEWALK TO TOWN STANDARDS BEHIND THE DITCH ALONG THE LENGTH OF THE PUREFOY ROAD FRONTAGE. 2. PRIOR TO A CERTIFICATE OF OCCUPANCY CONSTRUCT THE DRIVE AISLE AND PARKING LOT TO TOWN STANDARDS FOR 3. RIGHT-OF-WAY DEDICATION PLAT REQUIRED PRIOR TO ISSUANCE OF FINAL PLANS ZONING COMPLIANCE PERMIT. 4. SECONDARY HEIGHT, BUILDING SETBACK AND SOLAR SETBACK (25' MINIMUM) ARE ALL GOVERNED BY LUMO APPENDIX B

GENERAL CONDITIONS OF APPROVAL

DIVISION 5: MASON FARM/WHITEHEAD CIRCLE NEIGHBORHOOD CONSERVATION DISTRICT.

5. RECREATION SPACE PAYMENT IN LIEU OF \$27,897.82 IS REQUIRED PRIOR TO ISSUANCE OF A FINAL PLANS ZONING

6. 5 FOOT SIDEWALK TO BE INSTALLED ACCORDING TO APPROVED PLANS PRIOR TO ISSUANCE OF FIRST CERTIFICATE OF

7. ABOVE GROUND UTILITY LINES ARE REQUIRED TO BE BURIED IN ACCORDANCE WITH LUMO 5.12.2. UTILITY PLANS DEMONSTRATING COMPLIANCE WITH THIS REQUIREMENT SHALL BE SUBMITTED PRIOR TO ISSUANCE OF A FINAL PLANS ZONING

8. OWNER SHALL CONTRACT WITH PRIVATE TRASH COLLECTION COMPANY FOR PICK-UP OF REFUSE AND RECYCLABLES. PICK-UP SHALL OCCUR AT A FREQUENCY THAT ENSURES A SAFE AND SANITARY FACILITY APPLICANT ELECTS TO PROVIDE RECYCLING SERVICES TO RESIDENTS/TENANTS OF THIS PROPERTY IN LIEU OF BUILDING A

RECYCLING STATION CONSTRUCTED TO ORANGE COUNTY SPECIFICATIONS. THE SITE WILL NOT RECEIVE PUBLIC RECYCLING COLLECTION NOW OR IN THE FUTURE UNLESS SUCH A RECYCLING STATION IS CONSTRUCTED OR CONTINGENCY FOR SUCH A STATION IS INCLUDED ON THE DEVELOPMENT PLANS. APPLICANT MUST REQUIRE AT LEAST THE SAME LEVEL OF SERVICE (CURRENT OR FUTURE) TO ITS RESIDENTS AS THAT PROVIDED BY ORANGE COUNTY. • COUNTY FEES FOR RECYCLING AND WASTE MANAGEMENT ASSOCIATED WITH THIS PROJECT/PROPERTY WILL NOT BE WAIVED.

 APPLICANT AGREES TO ENTER INTO A SERVICE AGREEMENT WITH A PRIVATE SOLID WASTE/RECYCLING COLLECTION CONTRACTOR THAT IS ACCEPTABLE TO ORANGE COUNTY. FURTHER, THE AGREEMENT SHALL PROVIDE FOR THE COLLECTION AND RECYCLING OF CORRUGATED CARDBOARD IN ADDITION TO THE OTHER CO-MINGLED RECYCLABLES AND AN EXECUTED COPY OF THE AGREEMENT SHALL BE PROVIDED TO AND APPROVED BY ORANGE COUNTY PRIOR TO APPROVAL OF FINAL CONSTRUCTION PLANS FOR THE PROPERTY/PROJECT.

10. OWNER COMMITS TO RESERVING TWO PARKING SPACES FOR EACH DWELLING UNIT. THE REMAINING THREE PARKING SPACES IN

# NO SCALE

### LIST OF SHEETS

SD-0.0 COVER SHEET SD-0.1 AREA MAP SD-1.0 EXISTING CONDITIONS/DEMOLITION PLAN SD-2.0 SITE LAYOUT PLAN GRADING AND STORMWATER DRAINAGE PLAN STORMWATER DETAILS SD-3.2 RESERVED SD-4.0 EROSION CONTROL PLAN

SD-5.0 UTILITY PLAN SD-6.0 SITE LIGHTING PLAN SD-7.0 LANDSCAPE PLAN

SD-8.0 SITE DETAILS **EROSION CONTROL DETAILS** SD-8.1

SD-8.2 UTILITY DETAILS

APPROVAL STAMPS

Job Number 1642

Checked PBR, AJP Date 4/18/2019 Revisions \_\_

PIN. 9788419609 PID. 8801003

FINAL PLANS NOT ISSUED FOR CONSTRUCTION

Sheet Title

COVER SHEET

SD-0.0

Sheet Number

KEN GORFKLE OWNER ADDRESS: 1436 POINSETT DRIVE CHAPEL HILL, NC 27717 9788419609 PARCEL ID: 8801003 ACREAGE: 56,805.72 SF / 1.30 AC PLAT BOOK: PB3/PG40 ORANGE CO. REG.

111 PUREFOY ROAD

CHAPEL HILL, NC 27514

EXISTING LAND USE: DWELLING UNIT, SINGLE FAMILY W/ ACCESSORY APARTMENT PROPOSED LAND USE: MULTI-FAMILY RESIDENTIAL

EXISTING ZONING: R-4, MEDIUM DENSITY RESIDENTIAL, 10 UNITS / ACRE COMP. PLAN LAND USE: MEDIUM RESIDENTIAL, 4-8 UNITS PER/AC OVERLAYS:

MASON FARMS/WHITEHEAD CIRCLE NEIGHBORHOOD CONSERVATION DISTRICT PLAN ADOPTED PLANS: TOTAL PROJECT AREA: NET LAND AREA BEFORE R.O.W. DEDICATION - 56,805.72 SF / 1.30 AC

NET LAND AREA POST R.O.W. DEDICATION - 53,756.70 SF / 1.23 AC GROSS LAND AREA - 58,717.70 SF / 1.35 AC AREA OF DISTURBANCE: ON-SITE DISTURBED AREA = 36,367 SF / 0.83 AC (PRE ROW DEDICATION) ROW DISTURBED AREA = 1,731 SF / 0.04 AC (PRE ROW DEDICATION) OFF-SITE ROW DISTURBED AREA = 167 SF / 0.004 AC (PRE ROW DEDICATION) ON-SITE DISTURBED AREA = 33,318 SF / 0.76 AC (POST ROW DEDICATION) ROW DISTURBED AREA = 4,780 SF / 0.11 AC (POST ROW DEDICATION)

OFF-SITE ROW DISTURBED AREA = 167 SF / 0.004 AC (POST ROW DEDICATION) WATERSHED OVERLAY: JORDAN LAKE WATERSHED PROTECTION DISTRICT

30' (NEIGHBORHOOD CONSERVATION DISTRICT)

DESIGN STANDARDS MIN LOT SIZE: 1 ACRE GROSS LAND AREA (NEIGHBORHOOD CONSERVATION DISTRICT) 10 DWELLING UNITS MAXIMUM DENSITY:

PROJECT DATA

PARCEL A:

SITE ADDRESS:

RIVER BASIN:

MIN. LOT FRONTAGE:

MIN. LOT WIDTH: MAX. BUILDING HEIGHT 30' (LUMO 3.8.2 AND APPENDIX B, DIVISION5) PRIMARY:

40'

BUILDING SETBACKS 50' MIN. (NEIGHBORHOOD CONSERVATION DISTRICT) 25' MIN. (NEIGHBORHOOD CONSERVATION DISTRICT)

PROPOSED BLDG. AREA: BLDG #1 - 4,512 GSF (3 UNITS/ 12 BEDROOMS)

BLDG #2 - 6,016 GSF (4 UNITS/ 16 BEDROOMS) TOTAL - 10,528 GSF (7 UNITS/ 28 BEDROOMS)

PROPOSED DENSITY: 7 DU / 1.35 GLA = 5.18 DU PER AC PROPOSED

<u>PARKING</u> MIN. NUMBER OF SPACES: 2 PER DWELLING UNIT MAX. NUMBER OF SPACES: 2.50 PER DWELLING UNIT

 $2 \times 7 DU = 14 \text{ SPACES MIN.} / 2.5 \times 7 DU = 18 \text{ SPACES MAX.}$ REQUIRED: 18 PARKING SPACES INCLUDING 1 HANDICAP VAN ACCESSIBLE SPACE PROVIDED:

MIN. BICYCLE PARKING REQUIRED:

7 DU / 4 DU = 2 BICYCLE PARKING SPACES 2 TOTAL (CLASS I) BICYCLE PARKING SPACES REQUIRED 2 (CLASS I) BICYCLE PARKING SPACES (BIKE HOOKS INTERIOR) 28 (CLASS II) BICYCLE PARKING SPACES (14 BIKE RACKS EXTERIOR)

1 BICYCLE PARKING SPACE PER 4 DWELLING UNITS LUMO 5.9.7

LANDSCAPE BUFFERS

PROVIDED:

R4-R4 ZONING (CHURCH) - 20' TYPE "C" ALTERNATE LANDSCAPE BUFFER WEST PUREFOY RD (COLLECTOR STREET) — 20' TYPE "C" ALTERNATE LANDSCAPE BUFFER SOUTH R4-R4/R-LD1 ZONING - 10' TYPE "B" ALTERNATE LANDSCAPE BUFFER R4-R-LD1 ZONING - 10' TYPE "B" ALTERNATE LANDSCAPE BUFFER

RE:SD-7.0 LANDSCAPE PLAN

IMPERVIOUS SURFACE EXISTING: PROPOSED:

5,744 SF / 0.13 AC (10.69% OF SITE) 20,302 SF / 0.47 AC (37.77% OF SITE)

RECREATION AREA AND RECREATION SPACE MIN. RECREATION AREA: NONE REQUIRED


MIN. RECREATION SPACE: (R-4 ZONING) 0.039 X 58,717.70 SF (GROSS) = 2,290 SF REQUIREDO SF, APPLICANT REQUESTING PAYMENT-IN-LIEU

### **PROJECT NOTES**


• BOUNDARY AND TOPOGRAPHIC SURVEY PROVIDED BY HOLLAND LAND SURVEYING, MAY 2016.

### RESOURCE ORDINANCE COMPLIANCE

FLOODPLAIN PROTECTION: NO FLOODPLAIN AS PER REVISED PRELIMINARY FEMA MAP NUMBER 3710978800K (REVISION DATE: AUGUST 30, 2013). STEEP SLOPE PROTECTION: SEE STEEP SLOPES ON SD-1.0 EXISTING CONDITIONS PLAN. WETLANDS PROTECTION: THERE ARE NO WETLANDS ON THIS SITE. STREAM BUFFERS: THERE ARE NO STREAM BUFFERS ON THIS SITE.

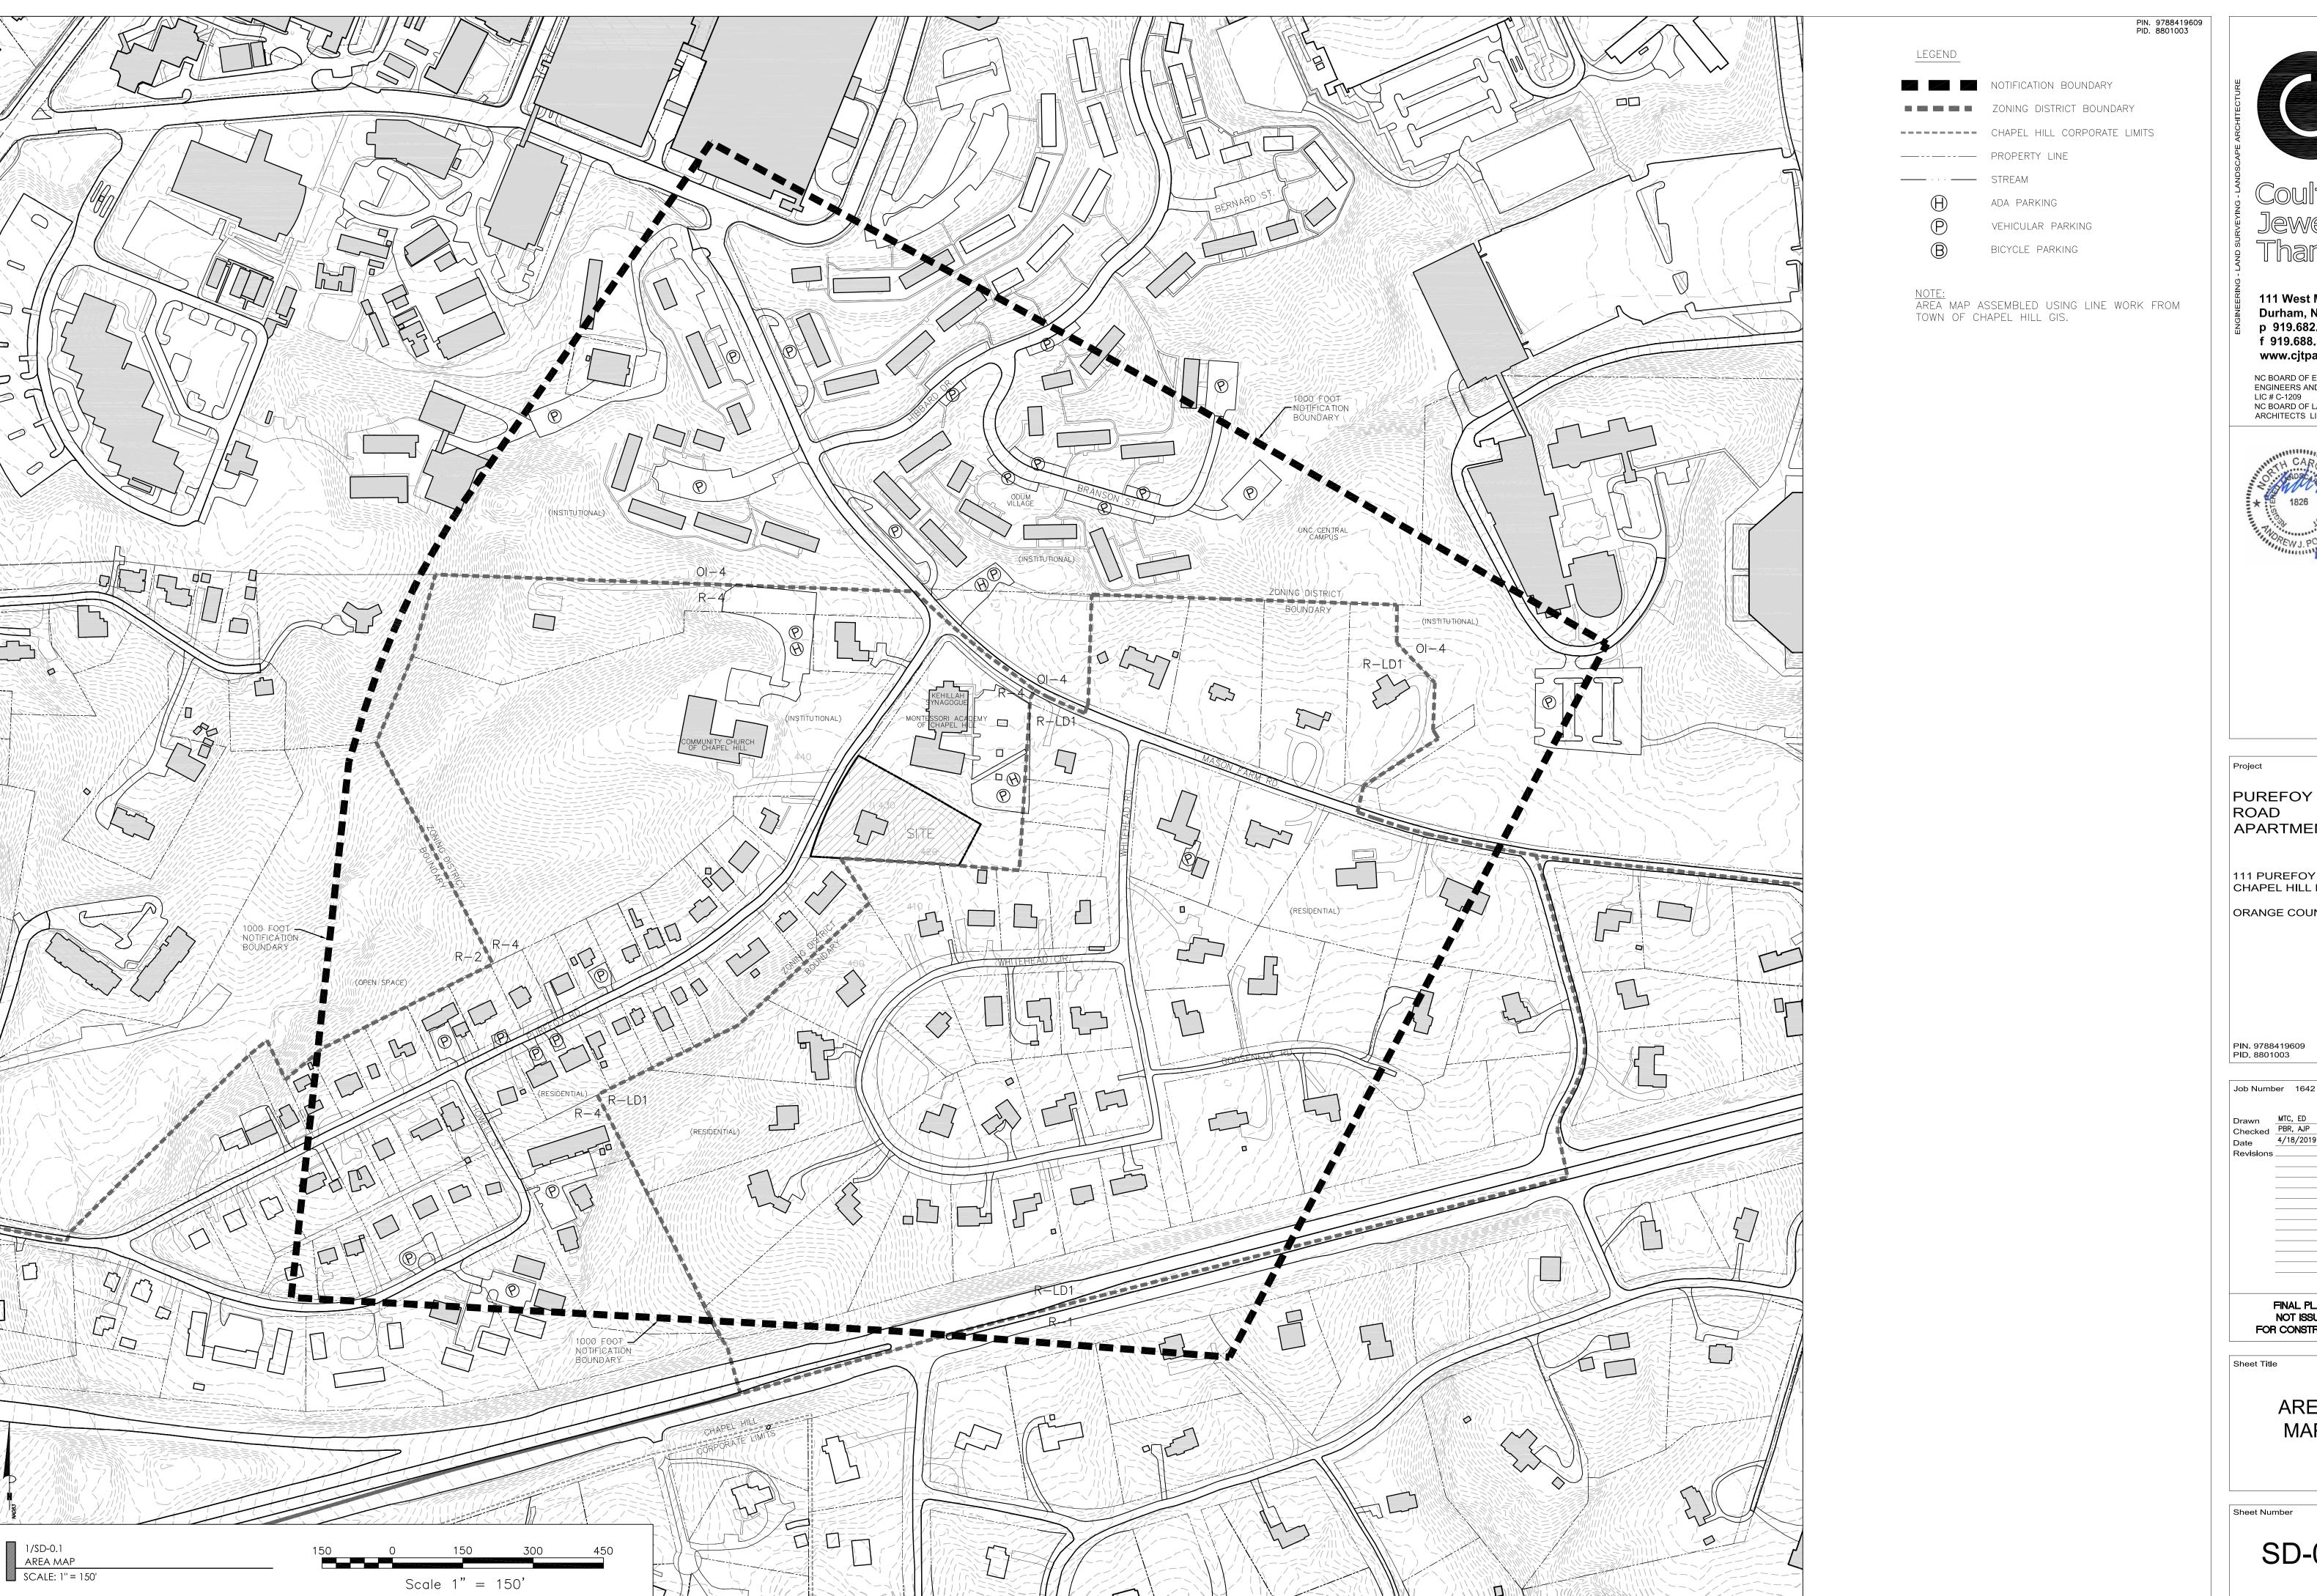

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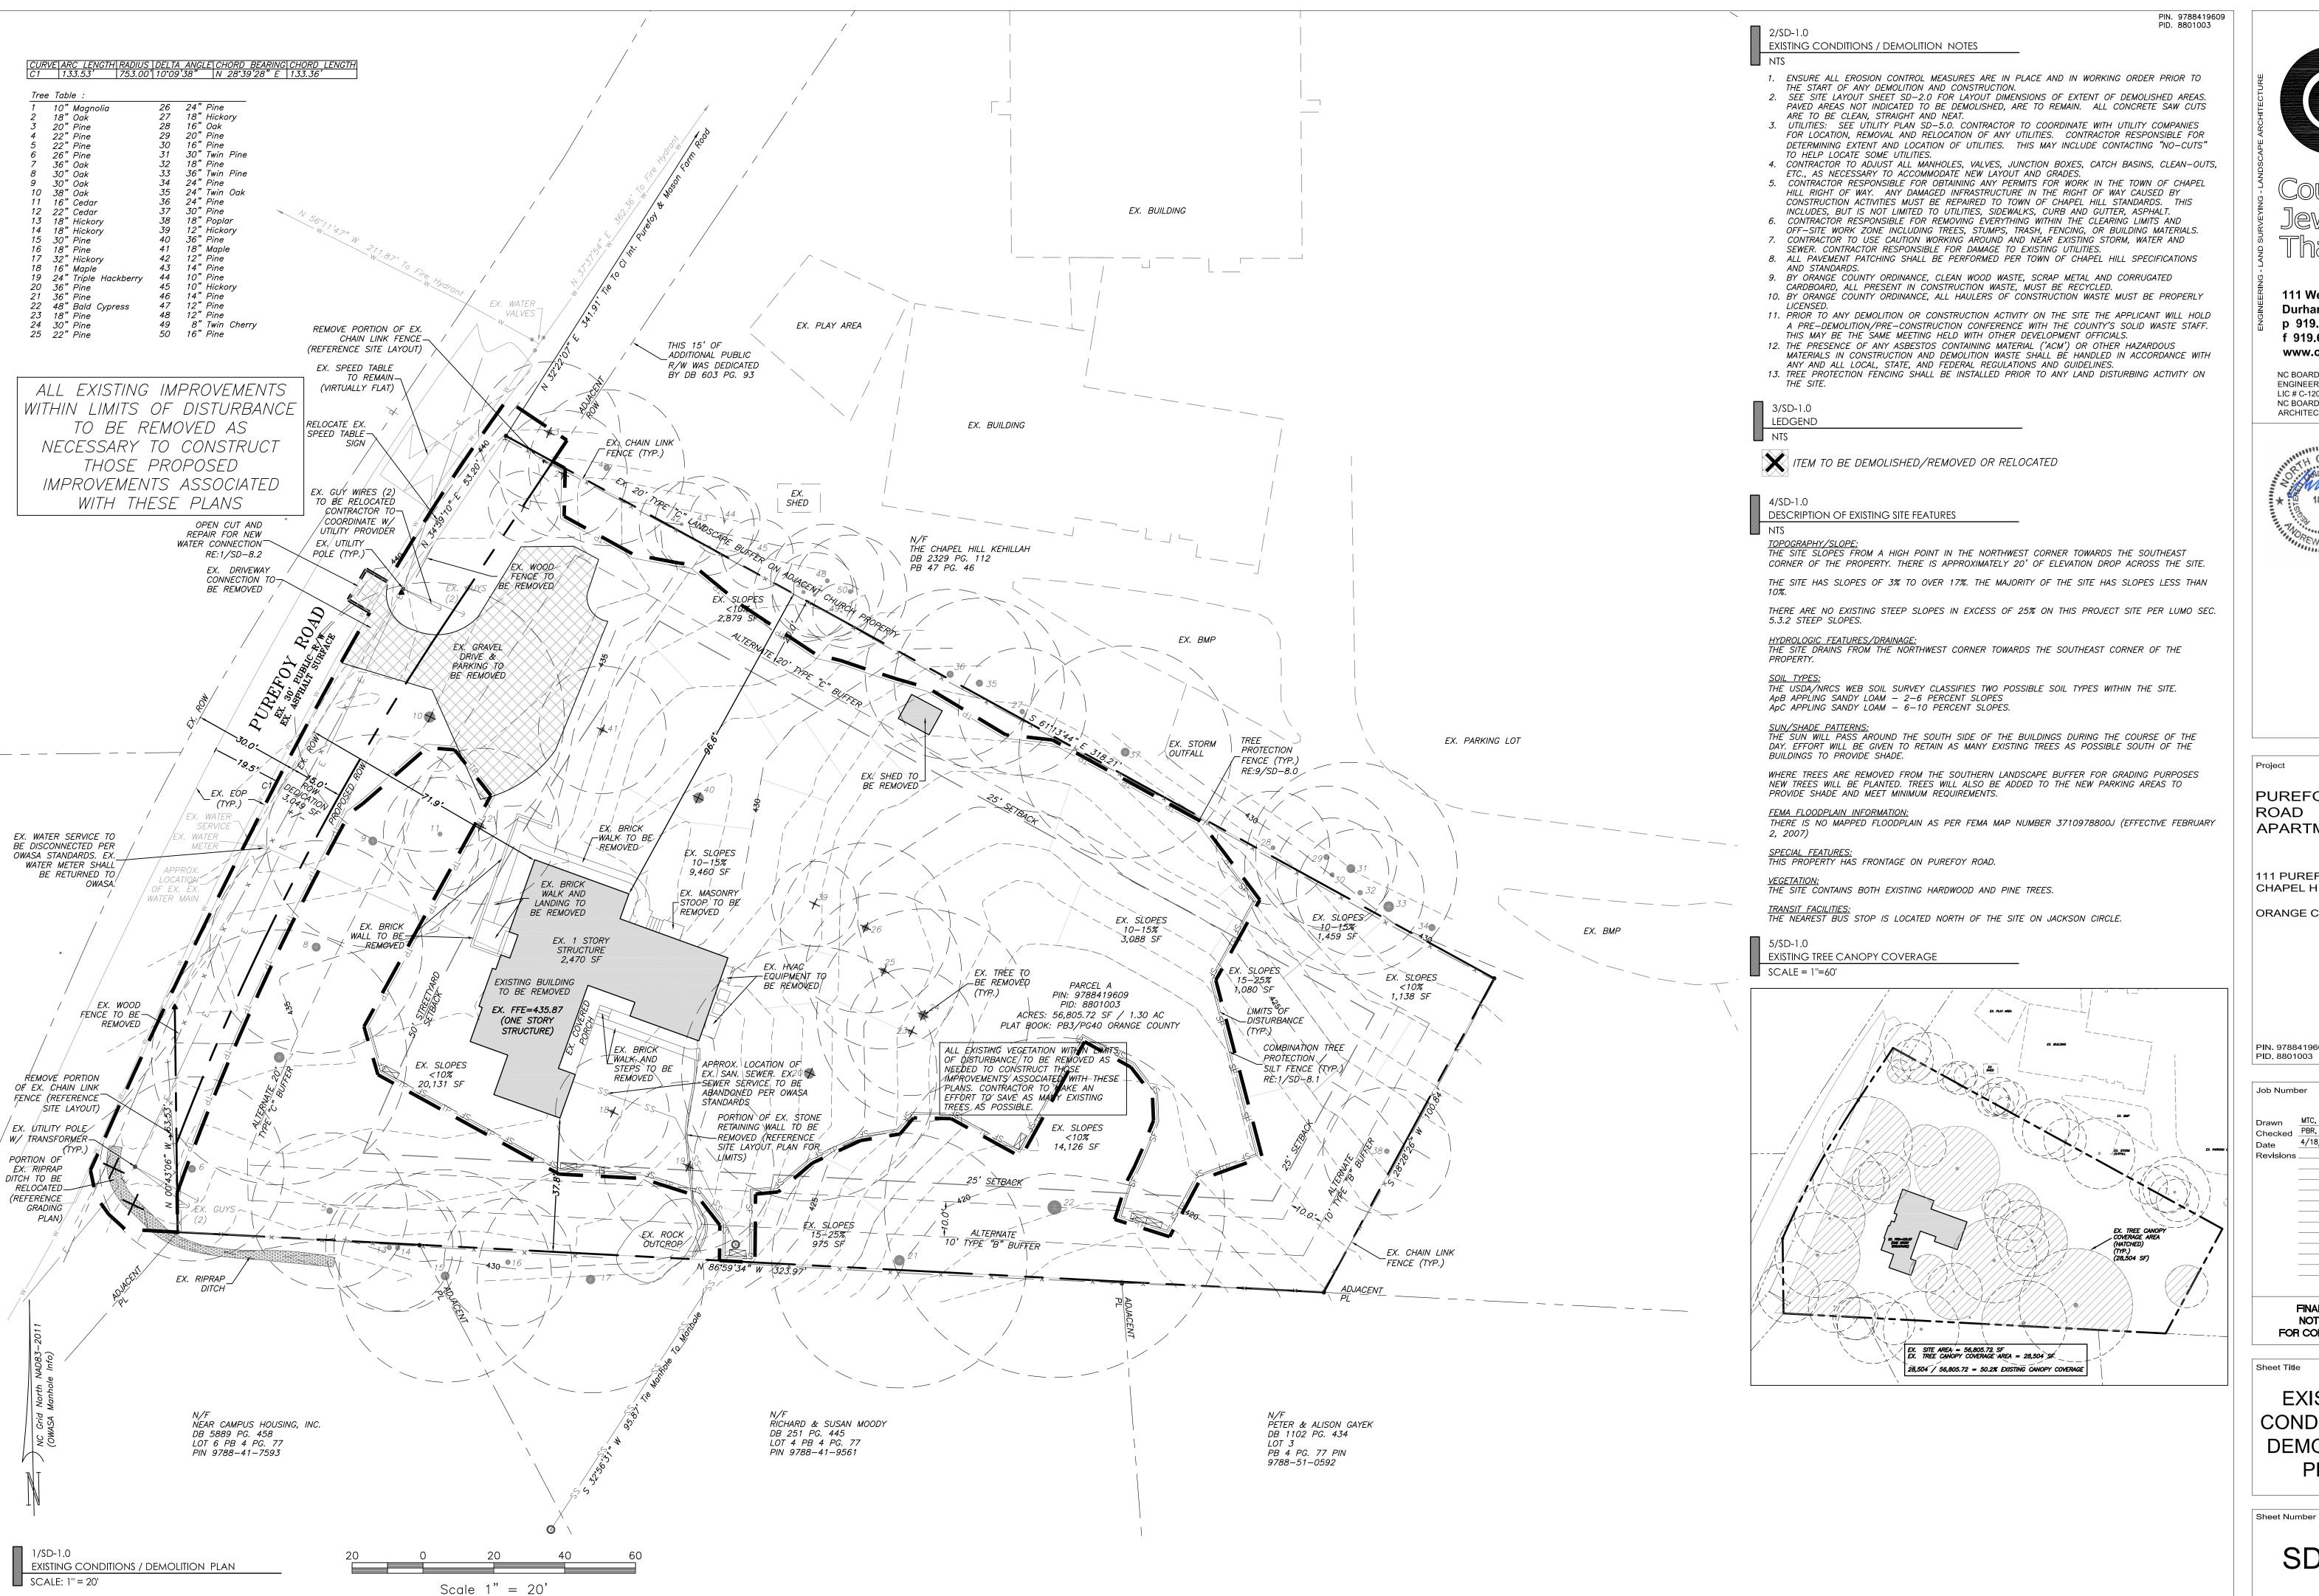
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4/18/2019
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FINAL PLANS NOT ISSUED FOR CONSTRUCTION

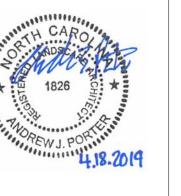Sheet Title

AREA MAP

SD-0.1





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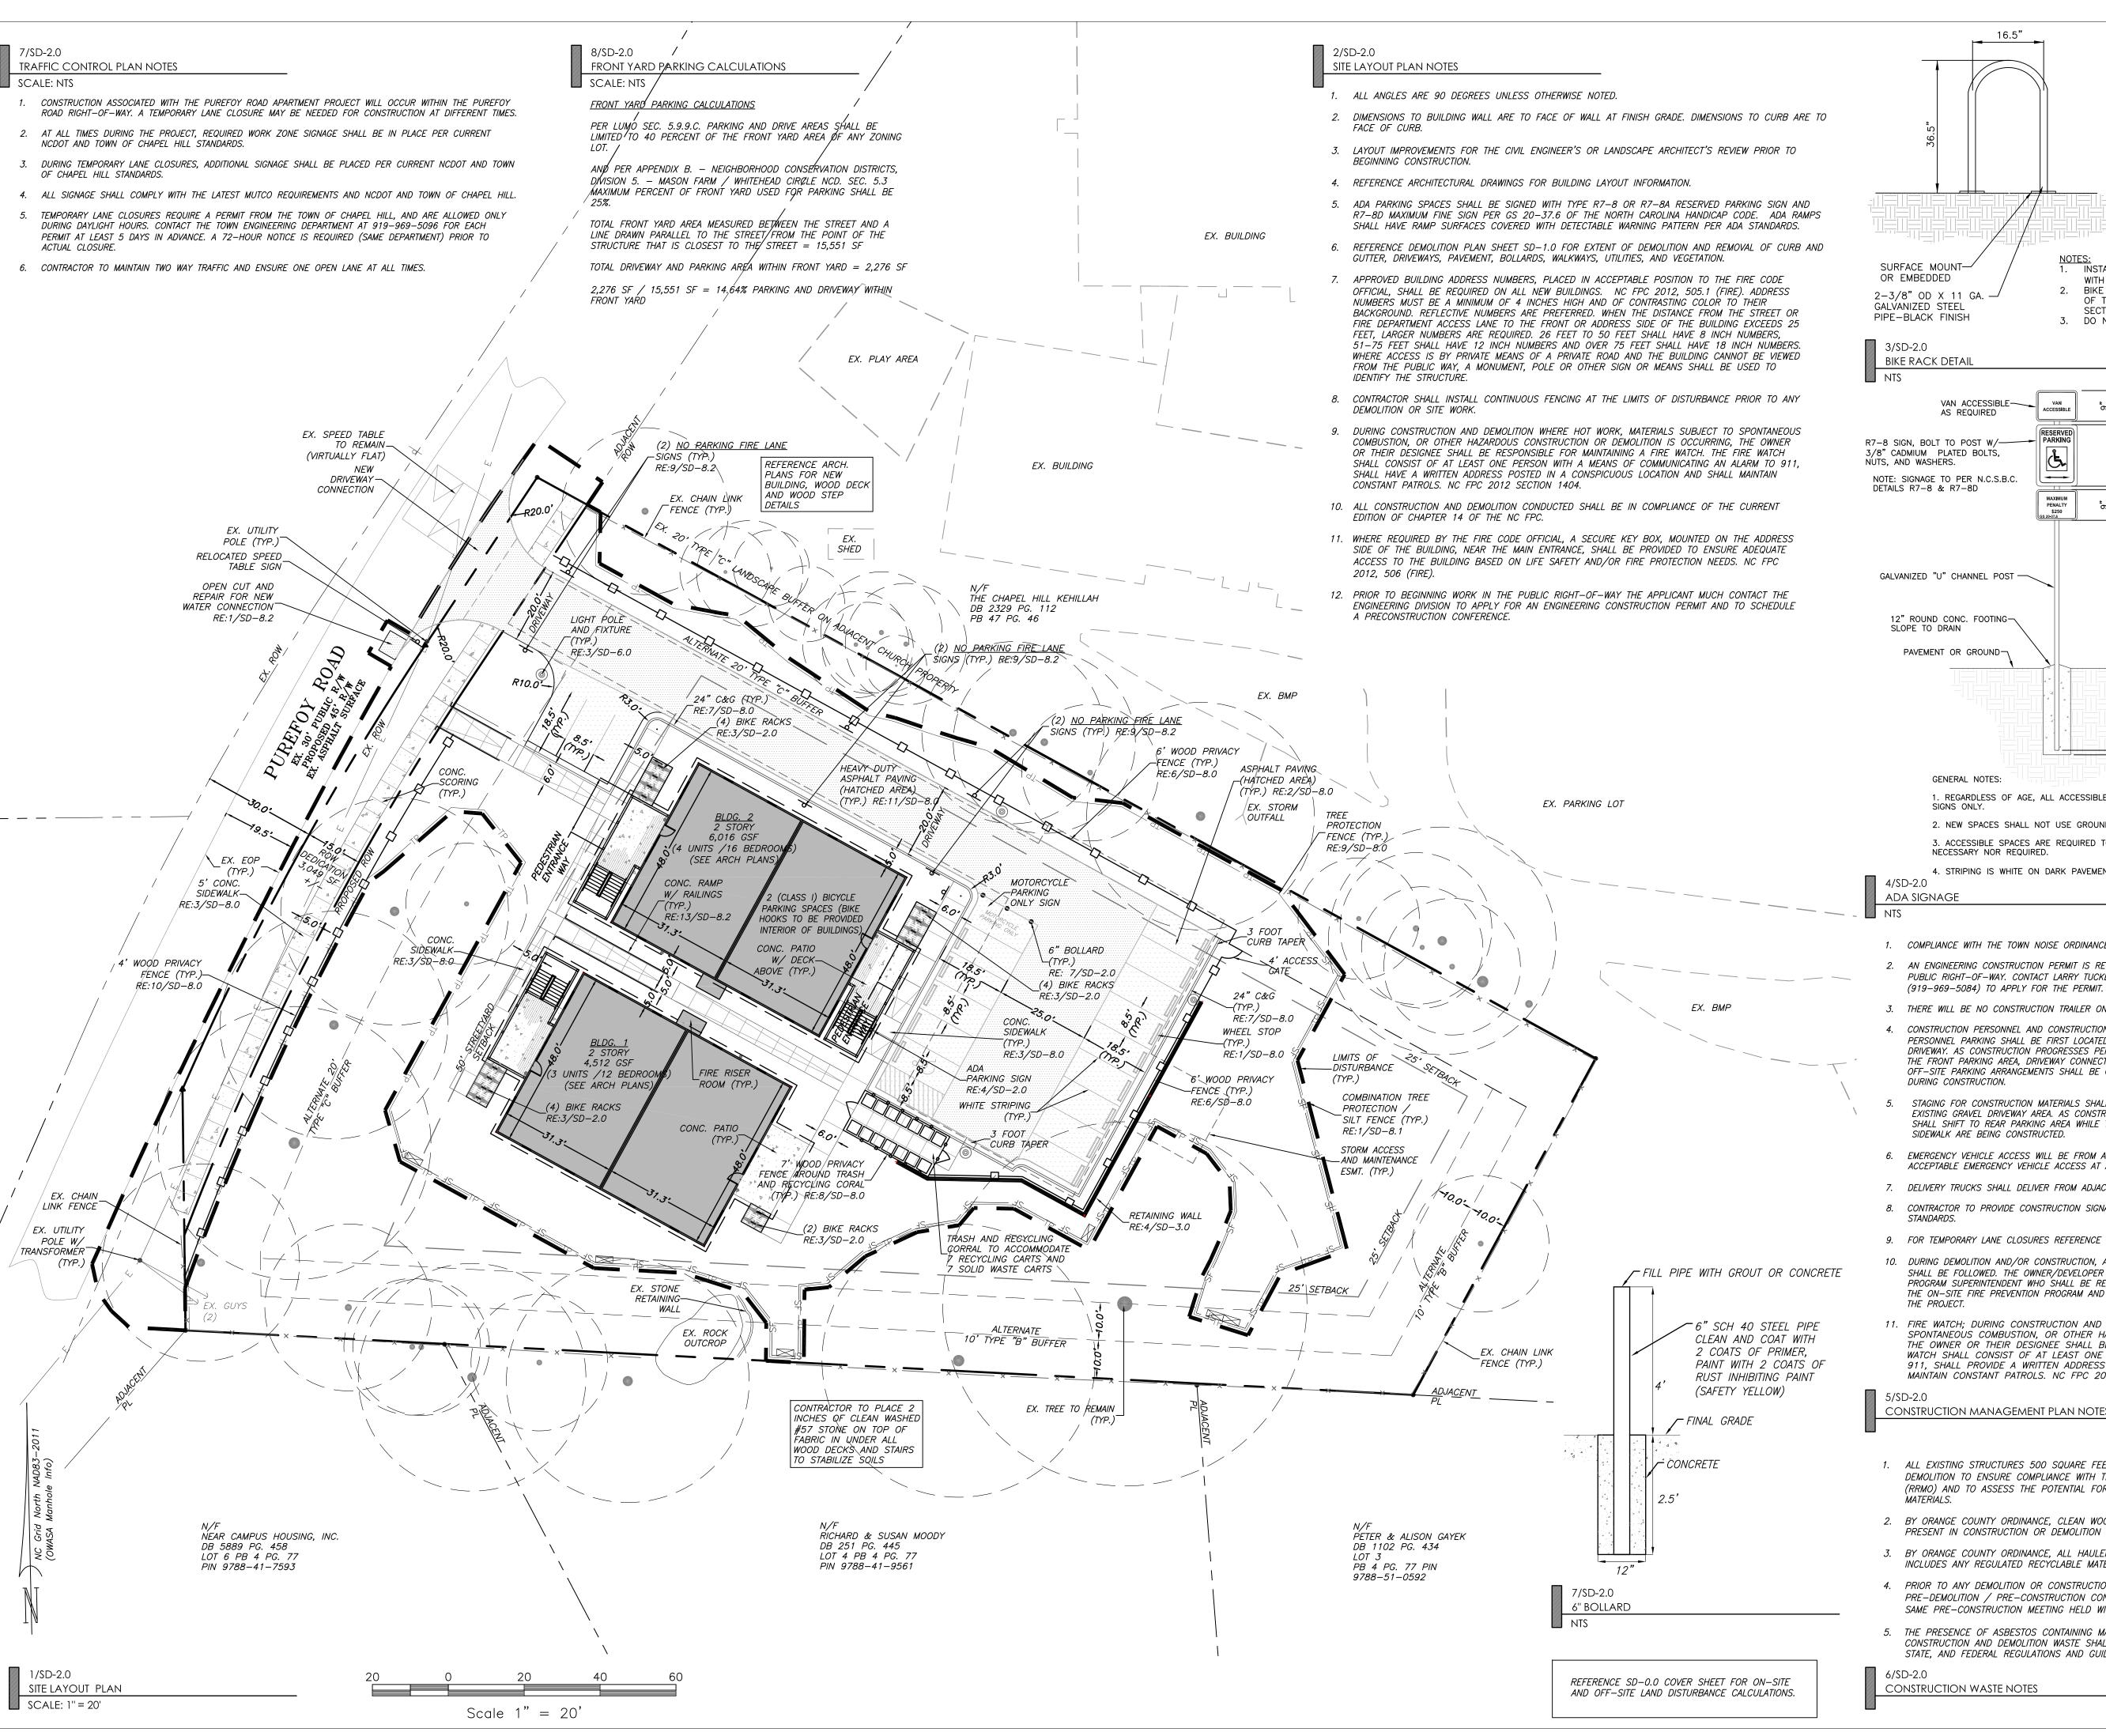
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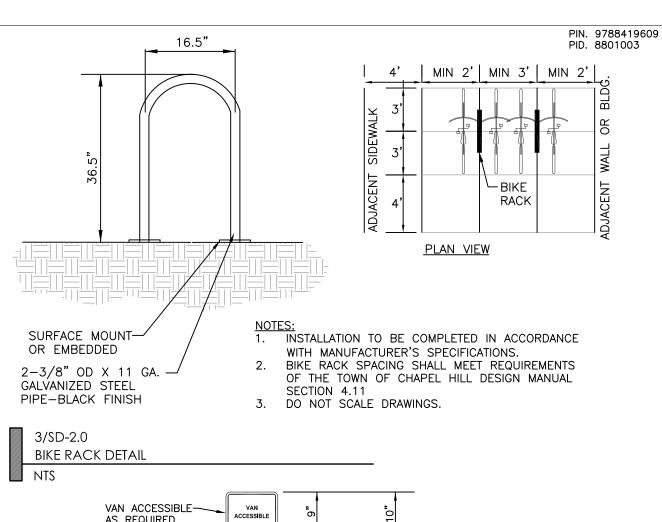
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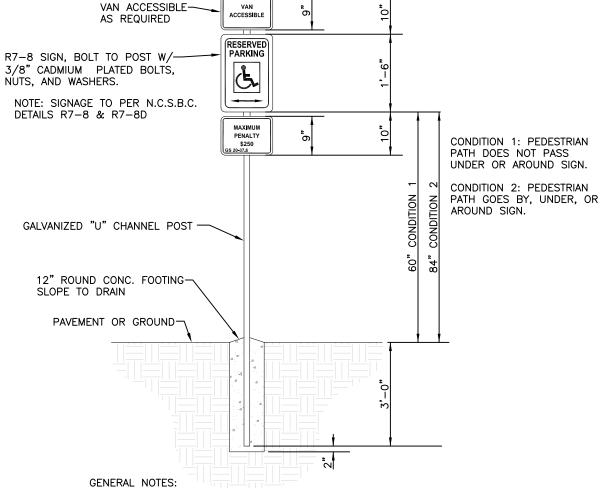
**EXISTING** CONDITIONS / **DEMOLITION** PLAN

Sheet Number

SD-1.0







GENERAL NOTES: 1. REGARDLESS OF AGE, ALL ACCESSIBLE SPACES SHALL BE IDENTIFIED BY ABOVE-GROUND

2. NEW SPACES SHALL NOT USE GROUND-PAINTED SYMBOLS.

3. ACCESSIBLE SPACES ARE REQUIRED TO BE STRIPED OFF ONLY; BLUE COLORING IS NOT NECESSARY NOR REQUIRED.

4. STRIPING IS WHITE ON DARK PAVEMENT; BLACK ON LIGHT PAVEMENT. (N.C.D.O.T.)

- 1. COMPLIANCE WITH THE TOWN NOISE ORDINANCE IS REQUIRED DURING CONSTRUCTION OF THIS PROJECT.
- 2. AN ENGINEERING CONSTRUCTION PERMIT IS REQUIRED PRIOR TO THE START OF ANY WORK IN THE PUBLIC RIGHT-OF-WAY. CONTACT LARRY TUCKER (TOWN ENGINEERING AND DESIGN SERVICES DIVISION,
- 3. THERE WILL BE NO CONSTRUCTION TRAILER ON SITE.
- 4. CONSTRUCTION PERSONNEL AND CONSTRUCTION EQUIPMENT PARKING WILL BE WITHIN THE PROPERTY LIMITS. PERSONNEL PARKING SHALL BE FIRST LOCATED WEST OF PROPOSED BLDG. #2 WITHIN EXISTING GRAVEL DRIVEWAY. AS CONSTRUCTION PROGRESSES PERSONNEL PARKING SHALL SHIFT TO REAR PARKING AREA WHILE THE FRONT PARKING AREA, DRIVEWAY CONNECTION AND NEW SIDEWALK ARE BEING CONSTRUCTED. ADDITIONAL OFF-SITE PARKING ARRANGEMENTS SHALL BE COORDINATED WITH THE TOWN IF DETERMINED TO BE NEEDED DURING CONSTRUCTION.
- STAGING FOR CONSTRUCTION MATERIALS SHALL BE FIRST LOCATED WEST OF PROPOSED BLDG. #2 WITHIN THE EXISTING GRAVEL DRIVEWAY AREA. AS CONSTRUCTION PROGRESSES STAGING FOR CONSTRUCTION MATERIALS SHALL SHIFT TO REAR PARKING AREA WHILE THE FRONT PARKING AREA, DRIVEWAY CONNECTION AND NEW
- EMERGENCY VEHICLE ACCESS WILL BE FROM ADJACENT ROW (PUREFOY ROAD). CONTRACTOR SHALL ENSURE ACCEPTABLE EMERGENCY VEHICLE ACCESS AT ALL TIMES DURING CONSTRUCTION.
- 7. DELIVERY TRUCKS SHALL DELIVER FROM ADJACENT ROW (PUREFOY ROAD).
- 8. CONTRACTOR TO PROVIDE CONSTRUCTION SIGNAGE AS NECESSARY ALONG PUREFOY ROAD PER LATEST NCDOT
- 9. FOR TEMPORARY LANE CLOSURES REFERENCE NOTES 5&6, 7/SD-2.0 TRAFFIC CONTROL PLAN NOTES.
- 10. DURING DEMOLITION AND/OR CONSTRUCTION, ALL ASPECTS OF CHAPTER 14 OF THE NC FIRE PREVENTION SHALL BE FOLLOWED. THE OWNER/DEVELOPER SHALL DESIGNATE ONE PERSON TO BE THE FIRE PREVENTION PROGRAM SUPERINTENDENT WHO SHALL BE RESPONSIBLE FOR ENFORCING CHAPTER 14 OF THE NCFPC AND THE ON-SITE FIRE PREVENTION PROGRAM AND ENSURE THAT IT IS CARRIED OUT THROUGH COMPLETION OF
- 11. FIRE WATCH; DURING CONSTRUCTION AND DEMOLITION WHERE HOT WORK, MATERIALS SUBJECT TO SPONTANEOUS COMBUSTION, OR OTHER HAZARDOUS CONSTRUCTION OR DEMOLITION IS OCCURRING, THE OWNER OR THEIR DESIGNEE SHALL BE RESPONSIBLE FOR MAINTAINING A FIRE WATCH. THE FIRE WATCH SHALL CONSIST OF AT LEAST ONE PERSON WITH A MEANS OF COMMUNICATING AN ALARM TO 911, SHALL PROVIDE A WRITTEN ADDRESS POSTED IN A CONSPICUOUS LOCATION AND SHALL MAINTAIN CONSTANT PATROLS. NC FPC 2012 SECTION 1404.

CONSTRUCTION MANAGEMENT PLAN NOTES


- 1. ALL EXISTING STRUCTURES 500 SQUARE FEET AND LARGER IN SIZE SHALL BE ASSESSED PRIOR TO DEMOLITION TO ENSURE COMPLIANCE WITH THE COUNTY'S REGULATED RECYCLABLE MATERIALS ORDINANCE (RRMO) AND TO ASSESS THE POTENTIAL FOR DE-CONSTRUCTION AND/OR THE RE-USE OF SALVAGEABLE
- 2. BY ORANGE COUNTY ORDINANCE, CLEAN WOOD WASTE, SCRAP METAL, AND CORRUGATED CARDBOARD PRESENT IN CONSTRUCTION OR DEMOLITION WASTE MUST BE RECYCLED.
- 3. BY ORANGE COUNTY ORDINANCE, ALL HAULERS OF MIXED CONSTRUCTION AND DEMOLITION WASTE THAT INCLUDES ANY REGULATED RECYCLABLE MATERIALS SHALL BE LICENSED BY ORANGE COUNTY.
- 4. PRIOR TO ANY DEMOLITION OR CONSTRUCTION ACTIVITY ON THE SITE THE APPLICANT SHALL HOLD A PRE-DEMOLITION / PRE-CONSTRUCTION CONFERENCE WITH THE SOLID WASTE STAFF. THIS MAY BE THE SAME PRE-CONSTRUCTION MEETING HELD WITH OTHER DEVELOPMENT / ENFORCEMENT OFFICIALS.
- 5. THE PRESENCE OF ASBESTOS CONTAINING MATERIALS ('ACM') AND/OR OTHER HAZARDOUS MATERIALS IN CONSTRUCTION AND DEMOLITION WASTE SHALL BE HANDLED IN ACCORDANCE WITH ANY AND ALL LOCAL, STATE, AND FEDERAL REGULATIONS AND GUIDELINES.

CONSTRUCTION WASTE NOTES



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> FINAL PLANS NOT ISSUED

FOR CONSTRUCTION

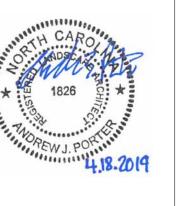Sheet Title

SITE **LAYOUT** PLAN

SD-2.0

Sheet Number

1. ALL DIMENSIONS AND GRADES SHOWN ON THE PLANS SHALL BE FIELD VERIFIED BY THE CONTRACTOR PRIOR TO CONSTRUCTION. CONTRACTOR SHALL NOTIFY THE OWNER IF ANY DISCREPANCIES EXIST PRIOR TO PROCEEDING WITH CONSTRUCTION FOR NECESSARY PLAN OR GRADE CHANGES. NO EXTRA COMPENSATION SHALL BE PAID TO THE CONTRACTOR FOR ANY WORK DONE DUE TO DIMENSIONS OR GRADES SHOWN INCORRECTLY ON THESE

- 2. ALL CONSTRUCTION SHALL BE IN ACCORDANCE WITH TOWN OF CHAPEL HILL STANDARDS AND SPECIFICATIONS.
- 3. CONTRACTOR SHALL NOTIFY "NORTH CAROLINA ONE CALL" (1-800-632-4949) AT LEAST 48 HOURS PRIOR TO BEGINNING CONSTRUCTION OR EXCAVATION TO HAVE EXISTING UTILITIES LOCATED. CONTRACTOR TO CONTACT ANY LOCAL UTILITIES THAT PROVIDE THEIR OWN LOCATOR SERVICES INDEPENDENT OF "NORTH CAROLINA ONE
- 4. CONSTRUCTION, MAINTENANCE AND REMOVAL OF ALL EROSION CONTROL DEVICES ARE THE RESPONSIBILITY OF
- 5. EXISTING UTILITIES AND STRUCTURES SHOWN, BOTH UNDERGROUND AND ABOVE GROUND, ARE BASED ON A FIELD SURVEY AND THE BEST AVAILABLE RECORD DRAWINGS. THE CONTRACTOR SHALL VERIFY FIELD CONDITIONS PRIOR TO BEGINNING RELATED CONSTRUCTION. ANY DISCREPANCIES SHALL BE REPORTED TO THE
- 6. SOIL UNDER BUILDING PAD, PAVED AREAS AND WITHIN SLOPES GREATER THAN 3:1 (H:V) SHALL BE APPROVED, PLACED AND COMPACTED AS RECOMMENDED BY THE GEOTECHNICAL ENGINEER. THÈSE SOILS SHALL BE COMPACTED AS SPECIFIED UNLESS OTHERWISE RECOMMENDED BY THE GEOTECHNICAL ENGINEER. ANY UNDERCUT OF SOILS IN THESE AREAS SHALL BE APPROVED BY THE GEOTECHNICAL ENGINEER & OWNER. THE UNDERCUT SOILS SHALL ALSO QUANTIFIED BY THE GEOTECHNICAL ENGINEER.
- 7. ALL GRADING MUST PRODUCE SURFACE DRAINAGE ADEQUATE TO PREVENT STANDING WATER OR WET LAWN AREAS, AND TO ENSURE THAT ALL STORM WATER FLOWS TO INLETS OR OTHER POINTS OF DISCHARGE.
- 8. ALL SIDEWALKS SHALL BE CONSTRUCTED WITH A MAXIMUM 1.8% CROSS SLOPE IN THE DIRECTION SHOWN ON
- 9. CONSTRUCTION DETAILS FOR PROPOSED RETAINING WALL DESIGN SHALL BE PROVIDED WITH FINAL PLANS
- 10. IN-SITU SOIL TEST RESULTS FOR THE PROPOSED UNDERGROUND DETENTION, WATER AND STORM FILTER UNIT
- 1. ALL STORM DRAINAGE PIPES SHOWN ARE TO BE CLASS III REINFORCED CONCRETE (RCP) UNLESS NOTED
- 2. ALL STORM DRAINAGE CONSTRUCTION SHALL BE IN ACCORDANCE WITH THE TOWN OF CHAPEL HILL STANDARDS.
- 3. ALL CONCRETE SHALL MEET A MINIMUM 3000 PSI COMPRESSIVE STRENGTH.
- 4. ALL PIPE IN STORM DRAIN STRUCTURES SHALL BE STRUCK EVEN WITH INSIDE WALL.
- SPECIFICATION M—198 FOR TYPE B FLEXIBLE PLASTIC GASKETS UNLESS OTHERWISE NOTED.
- 6. THE INTERIOR SURFACES OF ALL STORM DRAINAGE STRUCTURES SHALL BE POINTED AND SMOOTHED TO AN
- 7. ALL BACKFILL SHALL BE NON-PLASTIC IN NATURE, FREE FROM ROOTS, VEGETATION MATTER, WASTE CONSTRUCTION MATERIAL OR OTHER OBJECTIONABLE MATERIAL. SAID MATERIAL SHALL BE CAPABLE OF BEING COMPACTED BY MECHANICAL MEANS AND SHALL HAVE NO TENDENCY TO FLOW OR BEHAVE IN A PLASTIC
- 8. MATERIALS DEEMED BY THE OWNER'S REPRESENTATIVE AS UNSUITABLE FOR BACKFILL PURPOSES SHALL BE
- 9. BACKFILLING OF TRENCHES SHALL BE ACCOMPLISHED IMMEDIATELY AFTER PIPE IS LAID. THE FILL AROUND THE PIPE SHALL BE THOROUGHLY COMPACTED TO 95% OF THE MAXIMUM DRY DENSITY OBTAINABLE WITH THE STANDARD PROCTOR TEST. THE TOP EIGHT (8) INCHES SHALL BE COMPACTED TO 100% STANDARD PROCTOR.
- 10. UNDER NO CIRCUMSTANCES SHALL WATER BE ALLOWED TO RISE IN UNBACKFILLED TRENCHES AFTER PIPE HAS
- 11. ALL ROOF DRAINS FOR PROPOSED NEW BUILDING 2, THE NORTHWESTERN HALF FOR PROPOSED NEW BUILDING 1, AND ADDITIONAL NON-ROOF IMPERVIOUS AREA DISCHARGE INTO THE STORMWATER TREATMENT FACILITY.
- 12.THE CURB INLET HOOD AND COVER SHALL BE PRE-CAST CURB INLET HOODS AND COVERS STATING "DUMP NO WASTE! DRAINS TO JORDAN LAKE", IN ACCORDANCE WITH THE SPECIFICATIONS OF THE TOWN STANDARDS DETAIL SD-5A, FOR ALL NEW CURB INLETS FOR PRIVATE, TOWN AND STATE RIGHT-OF-WAY.
- 13.CONTRACTOR SHALL CONTACT TOWN OF CHAPEL HILL STORMWATER MANAGEMENT DIVISION TO SCHEDULE PRECONSTRUCTION MEETING PRIOR TO LAND DISTRUBANCE ON THE SITE.
- 14. HVAC CONDENSATE AND FLOOR DRAINS UNDER A ROOF SHALL NOT BE DISCHARGED INTO STORM SEWER PIPE.
- 15. ALL ROOF DRAIN PLUMBING INTENDED TO DISCHARGE TO STORM SEWER PIPE NOT SHOWN ON APPROVED PLAN SHEET ARE NOT APPROVED. ANY DISCHARGE TO STORM SEWER PIPE NOT APPROVED WILL NEED A REVIEW AND

- ADA WALK, LONGITUDINAL SLOPES TO BE A MAXIMUM 4.8%, CROSS SLOPES TO BE A MAXIMUM 1.8%.
- ADA RAMP, LONGITUDINAL SLOPES TO BE A MAXIMUM 8%, CROSS SLOPES TO BE A MAXIMUM 1.8%.
- MINIMUM 1' SHOULDER AT MAXIMUM 2% SLOPE ADJACENT TO ADA PAVED ROUTES UNLESS A HANDRAIL IS CALLED


- ALL DECKS AND WOODEN RAMPS SHALL COMPLY WITH ALL SLOPE REQUIREMENTS LISTED ABOVE. SEE
- THE CONTRACTOR SHALL VERIFY THAT CONSTRUCTION FORMS MEET ADA CODE PRIOR TO POURING CONCRETE. CONTRACTOR SHALL NOTIFY THE OWNER AND ENGINEER IF ANY DISCREPANCIES EXIST PRIOR TO PROCEEDING WITH CONSTRUCTION FOR NECESSARY PLAN OR GRADE CHANGES. NO EXTRA COMPENSATION SHALL BE PAID TO THE CONTRACTOR FOR ANY WORK DONE DUE TO DIMENSIONS OR GRADES SHOWN INCORRECTLY ON THESE PLANS IF



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Revisions \_\_

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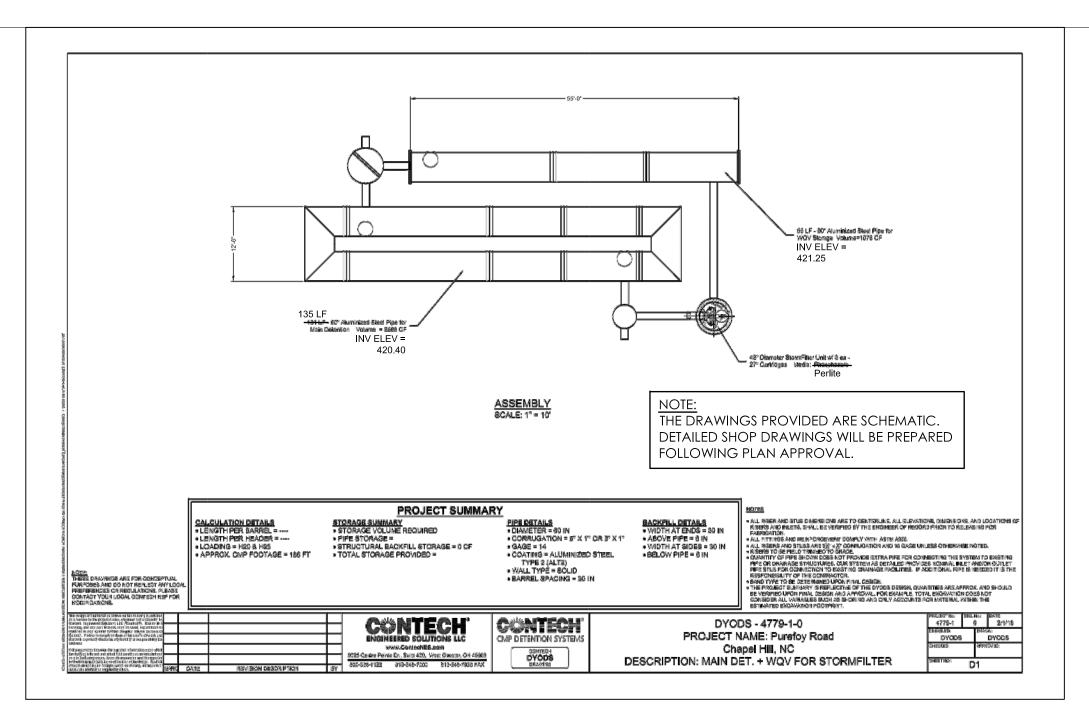
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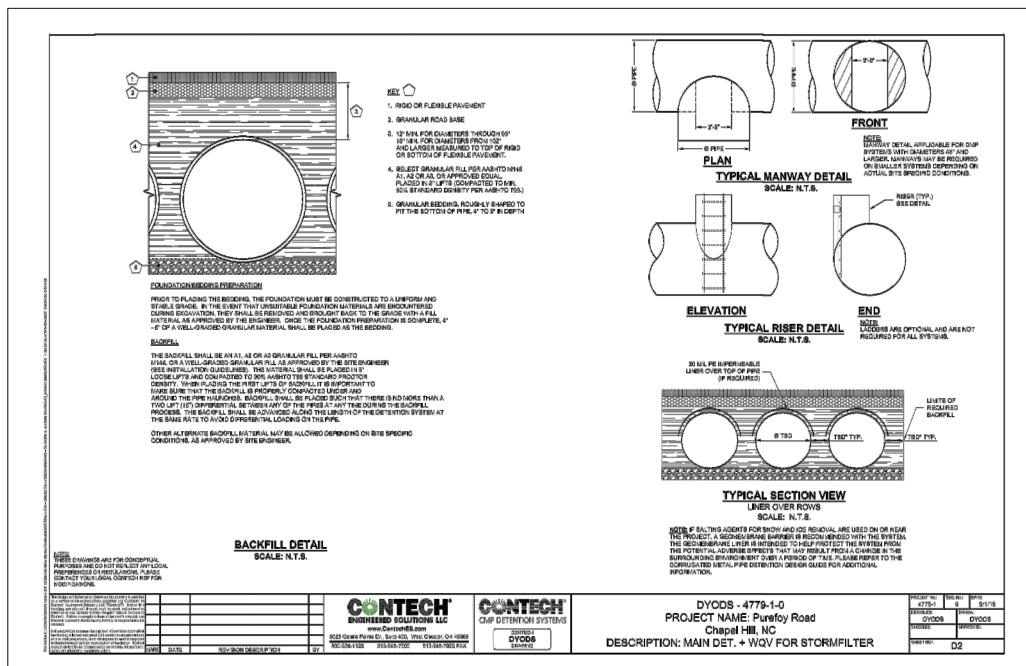
**GRADING AND** STORMWATER DRAINAGE PLAN


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Sheet Number

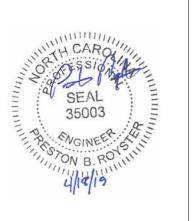SD-3.0






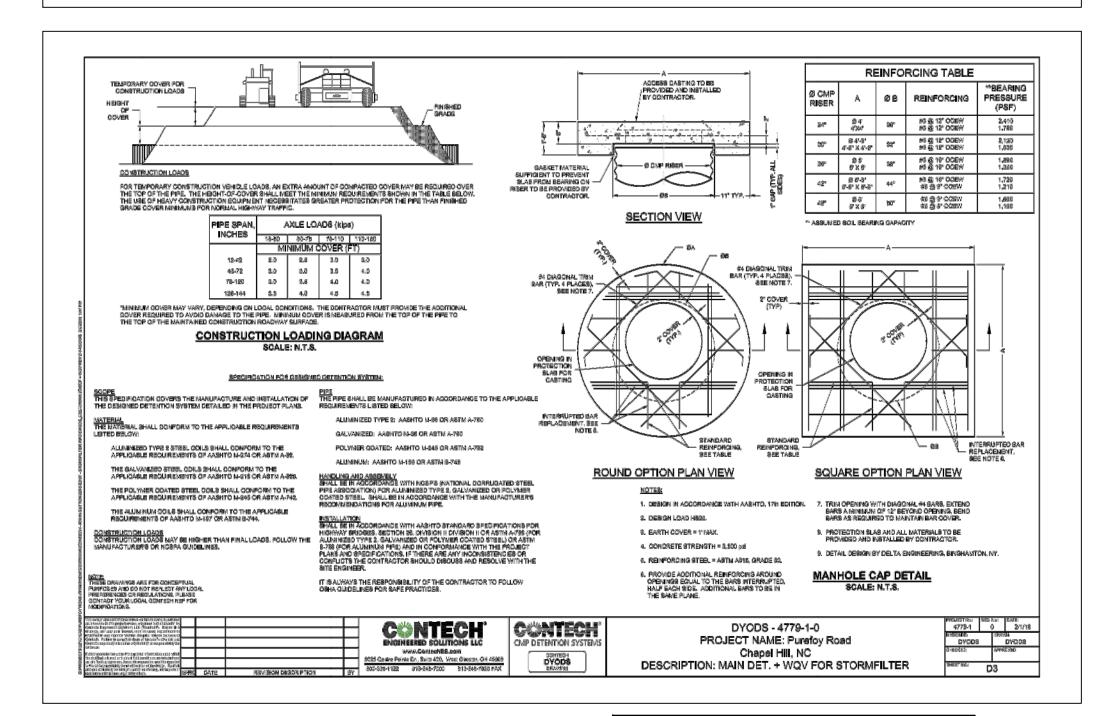

STORMFILTER AND UNDERGROUND DETENTION SYSTEM


UNDERGROUND DETENTION DETAILS ARE SCHEMATIC. DETAILED SHOP DRAWINGS WILL BE PREPARED FOLLOWING PLAN APPROVAL.

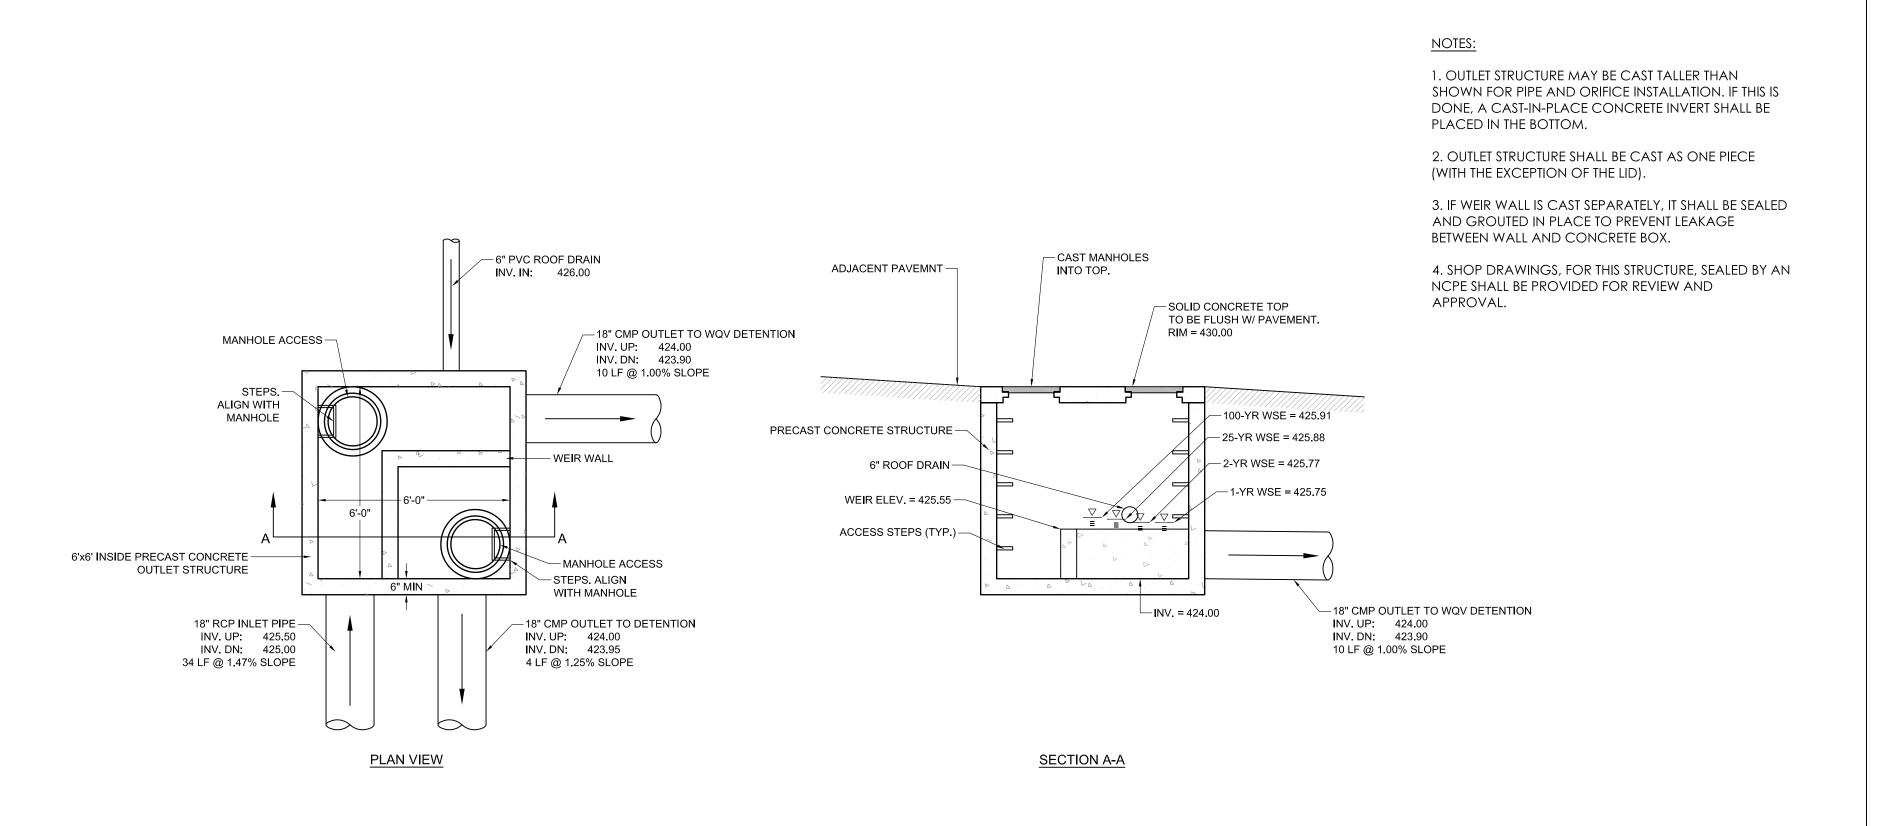

2/SD-3.1 SPLITTER BOX DETAIL


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OUTLET STRUCTURE

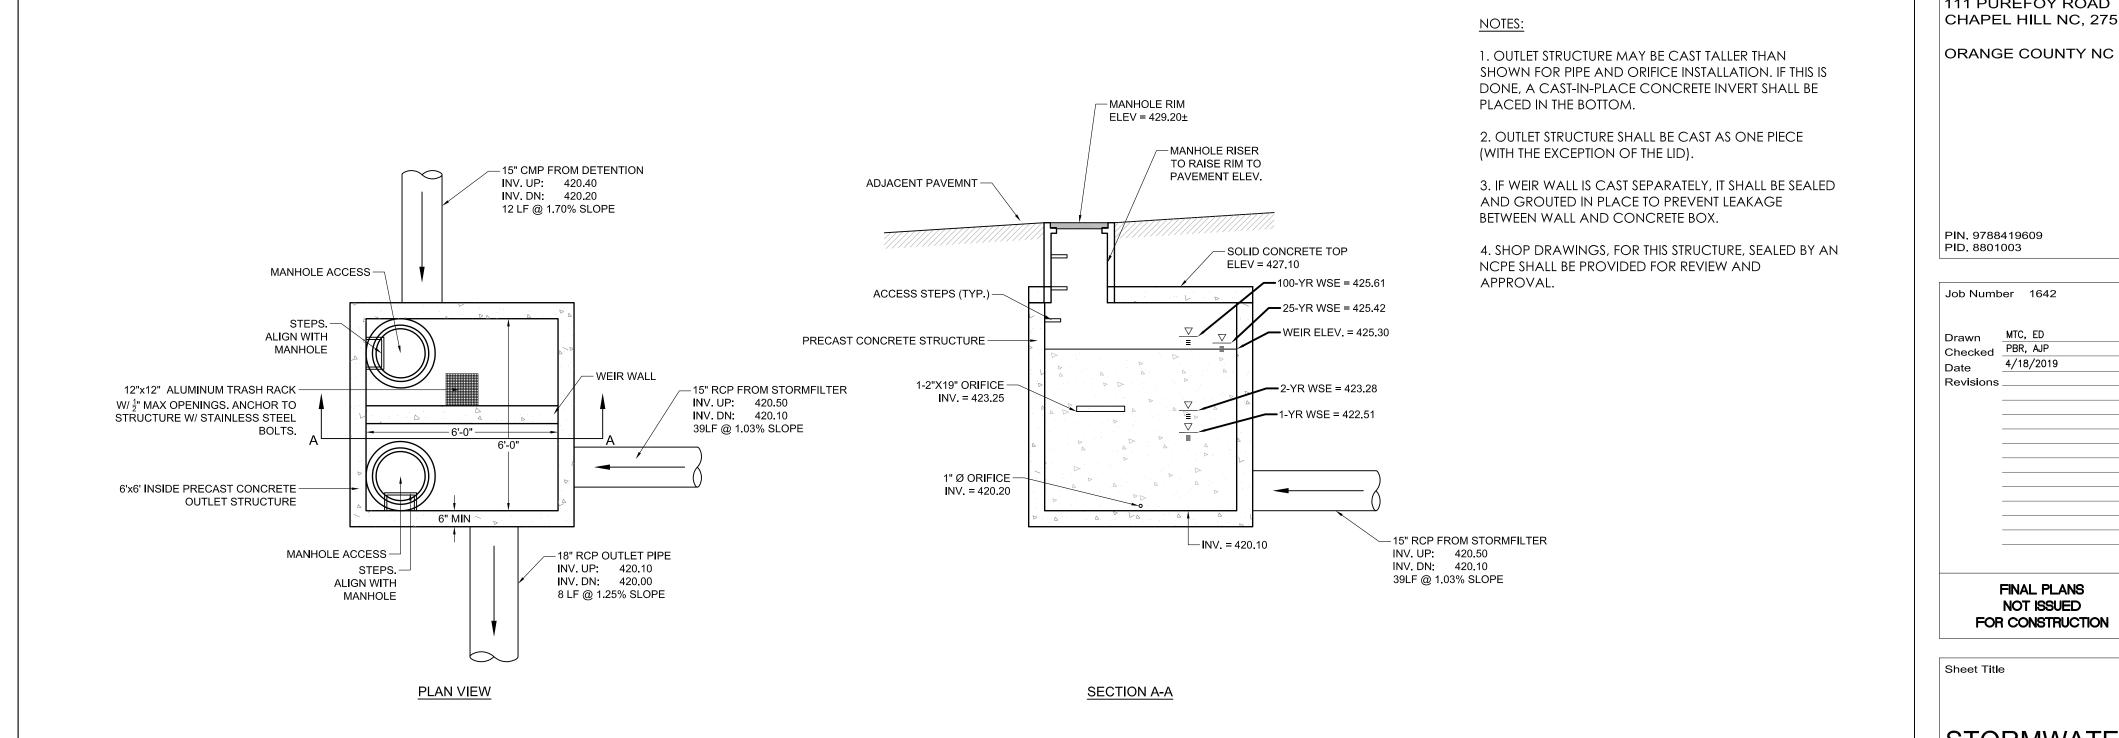

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FINAL PLANS

NOT ISSUED

FOR CONSTRUCTION

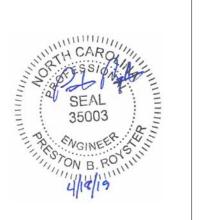Sheet Title

STORMWATER **DETAILS** 

Sheet Number

SD-3.1

SCALE: 1" = 20'

Scale 1" = 20'



Coulter
Jewell
Thames

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NC BOARD OF EXAMINERS FOR ENGINEERS AND SURVEYORS LIC # C-1209 NC BOARD OF LANDSCAPE ARCHITECTS LIC # C-104



Project

PUREFOY ROAD APARTMENTS

111 PUREFOY ROAD CHAPEL HILL NC, 27514 ORANGE COUNTY NC

PIN. 9788419609

PID. 8801003

Revisions \_

Job Number 1642

Drawn
Checked
Date

MTC, ED
PBR, AJP
4/18/2019


FINAL PLANS NOT ISSUED

FOR CONSTRUCTION

Sheet Title

EROSION CONTROL PLAN

SD-4.0

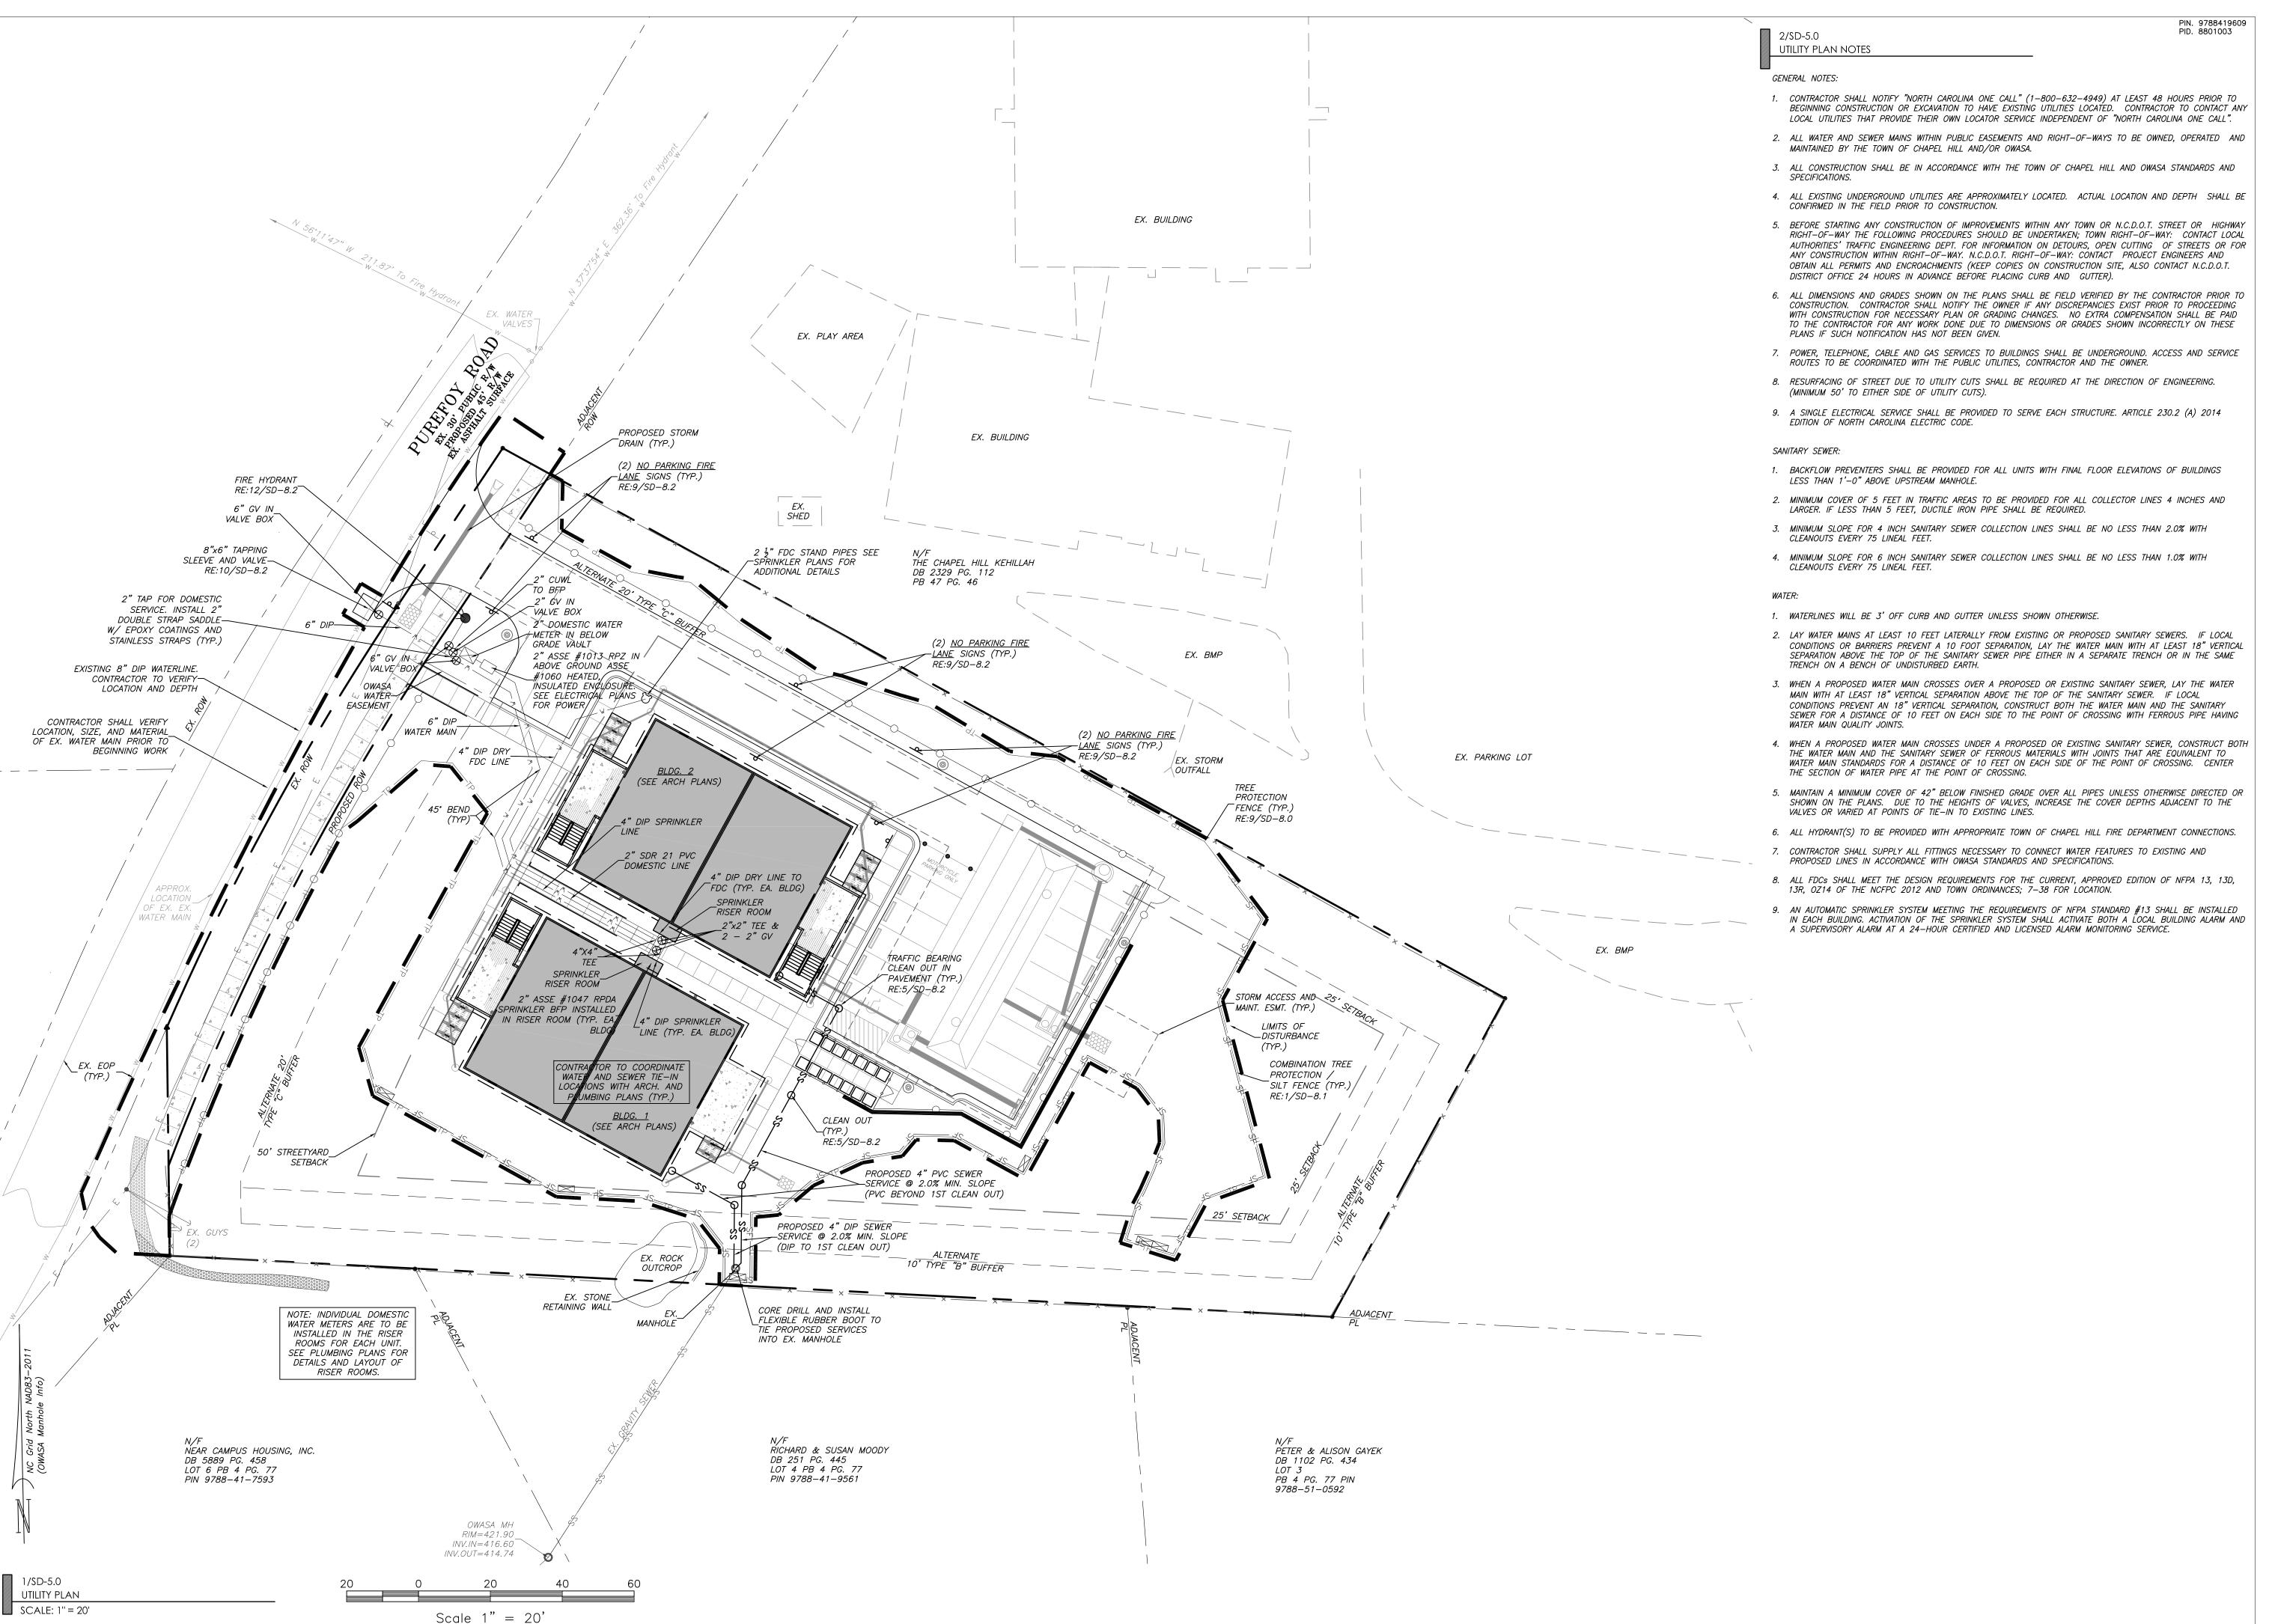



NC BOARD OF EXAMINERS FOR ENGINEERS AND SURVEYORS LIC # C-1209 NC BOARD OF LANDSCAPE ARCHITECTS LIC # C-104



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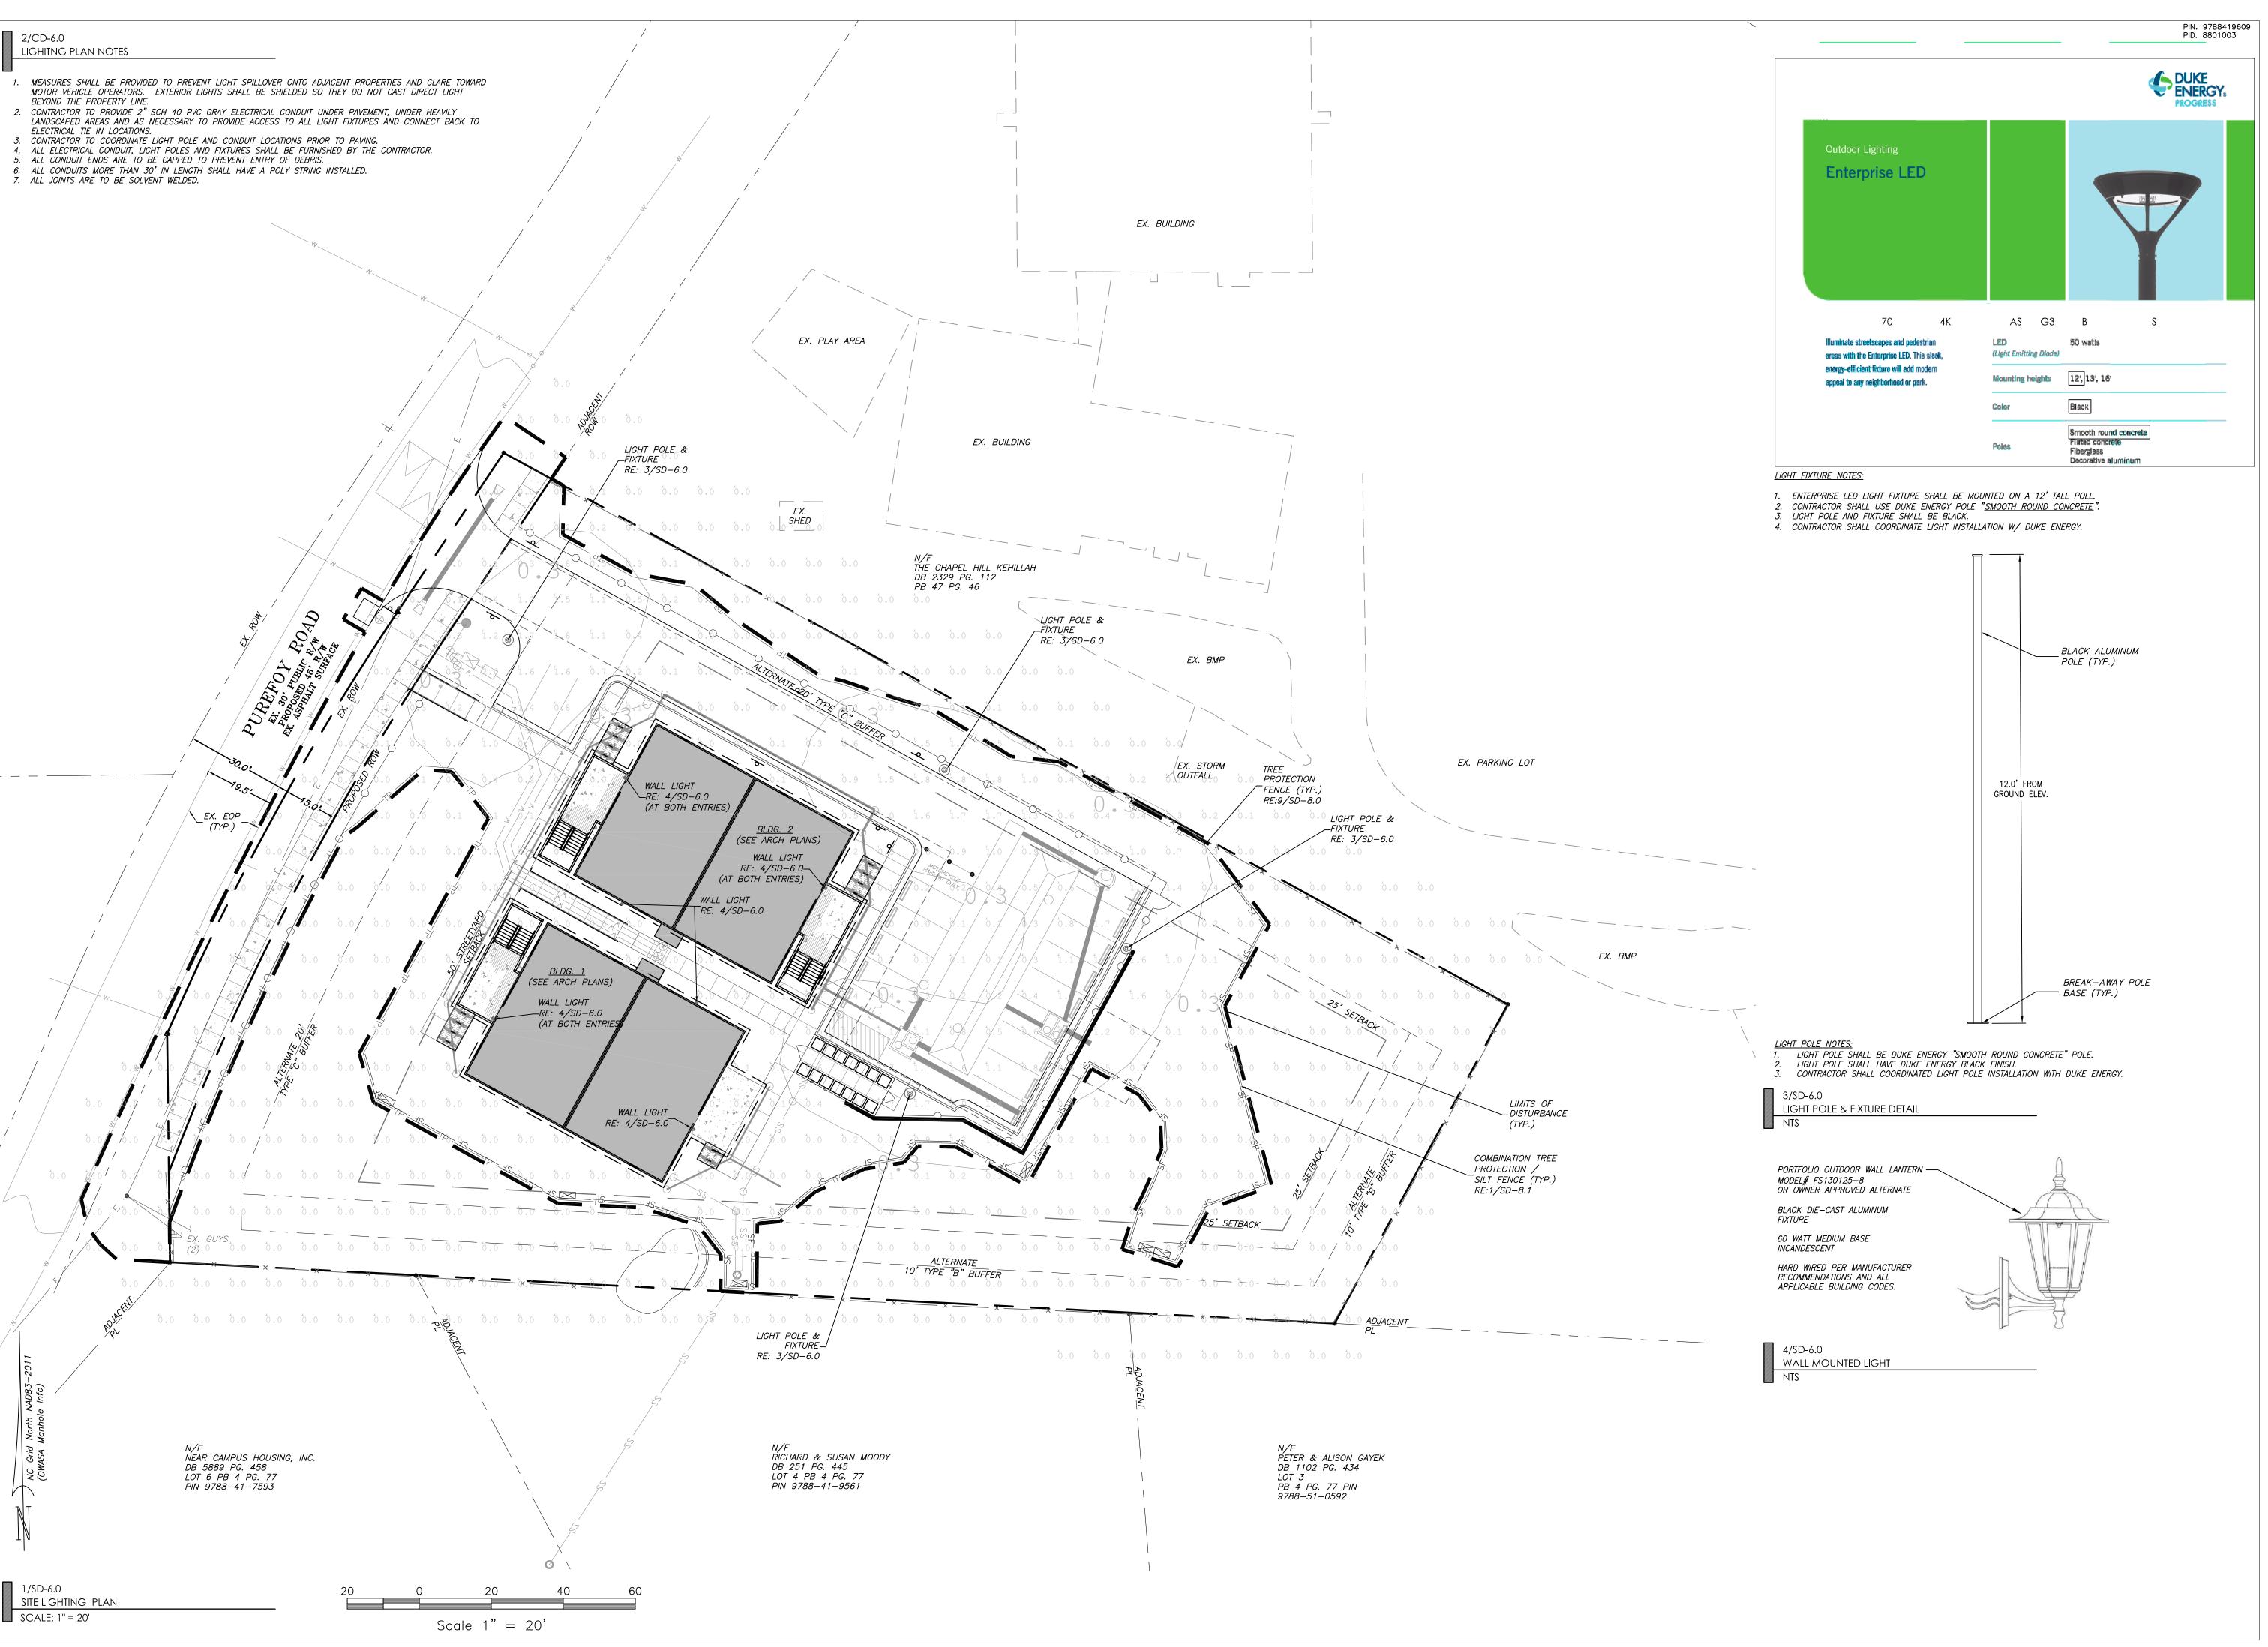
FINAL PLANS

Sheet Title

UTILITY PLAN

Sheet Number

SD-5.0





NC BOARD OF EXAMINERS FOR ENGINEERS AND SURVEYORS LIC # C-1209 NC BOARD OF LANDSCAPE ARCHITECTS LIC # C-104



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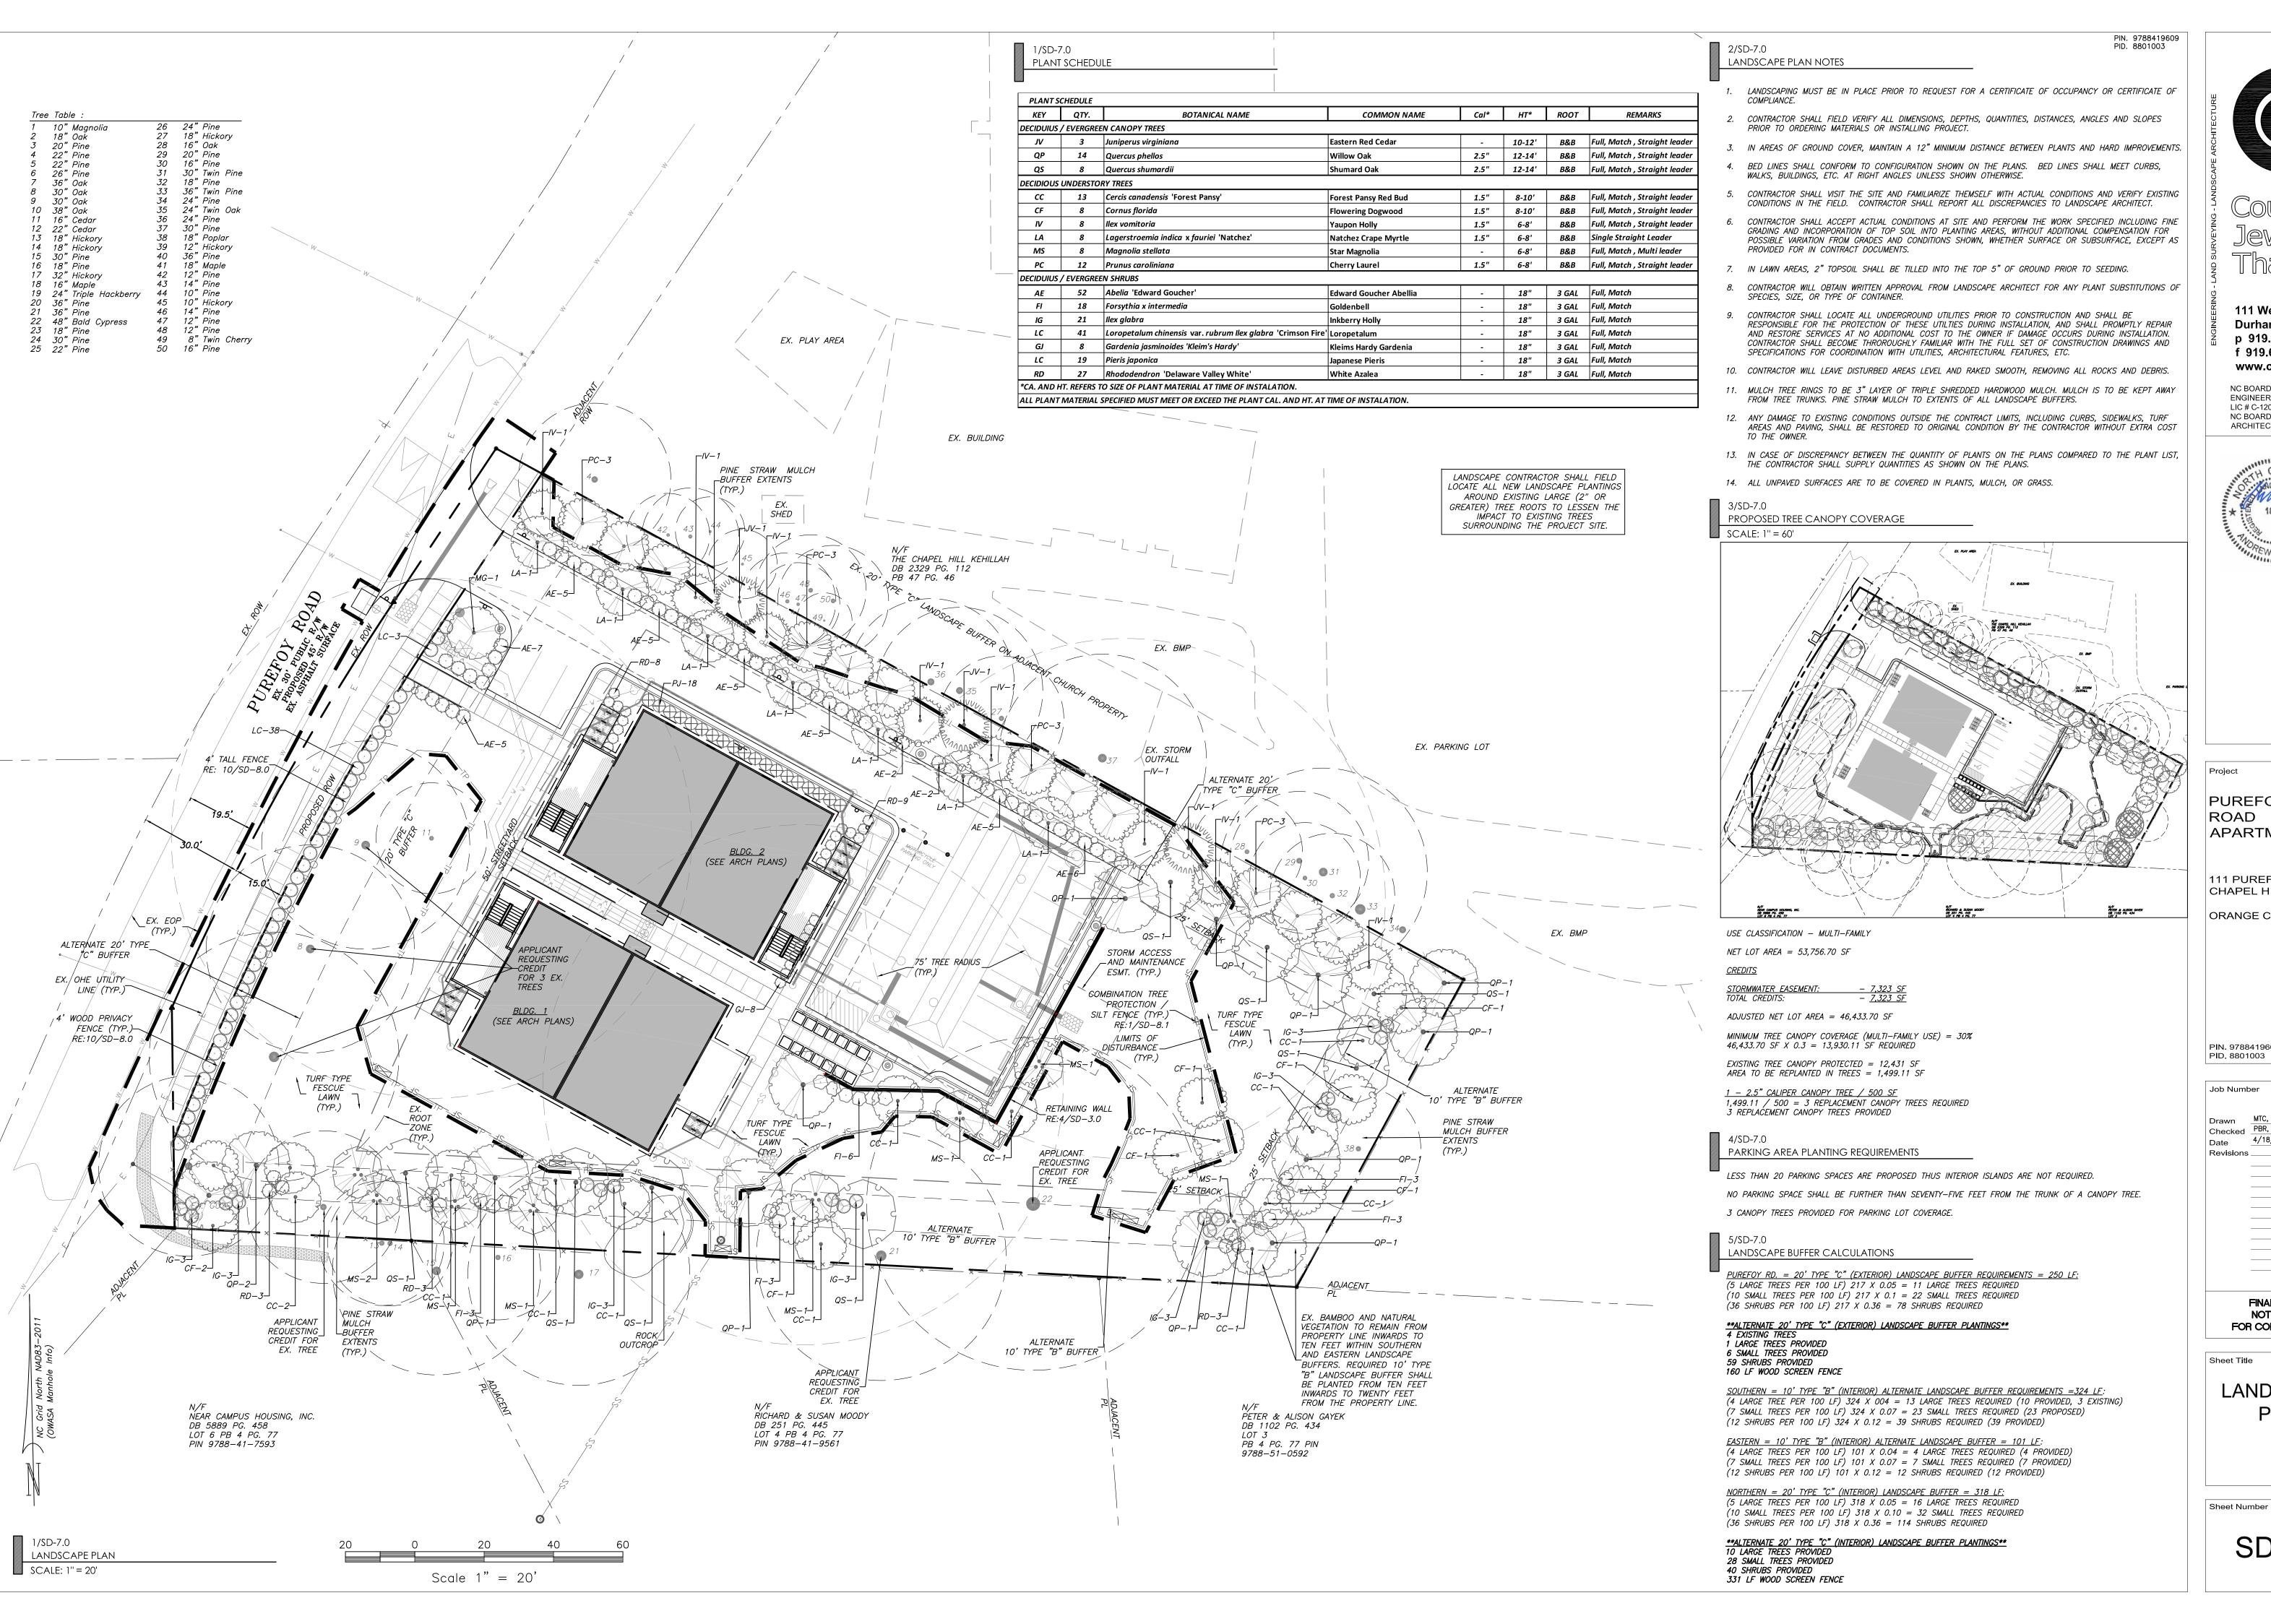
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Sheet Title
SITE

LIGHTING PLAN

SD-6.0

Sheet Number



NC BOARD OF EXAMINERS FOR ENGINEERS AND SURVEYORS LIC # C-1209 NC BOARD OF LANDSCAPE ARCHITECTS LIC # C-104



**PUREFOY** ROAD APARTMENTS

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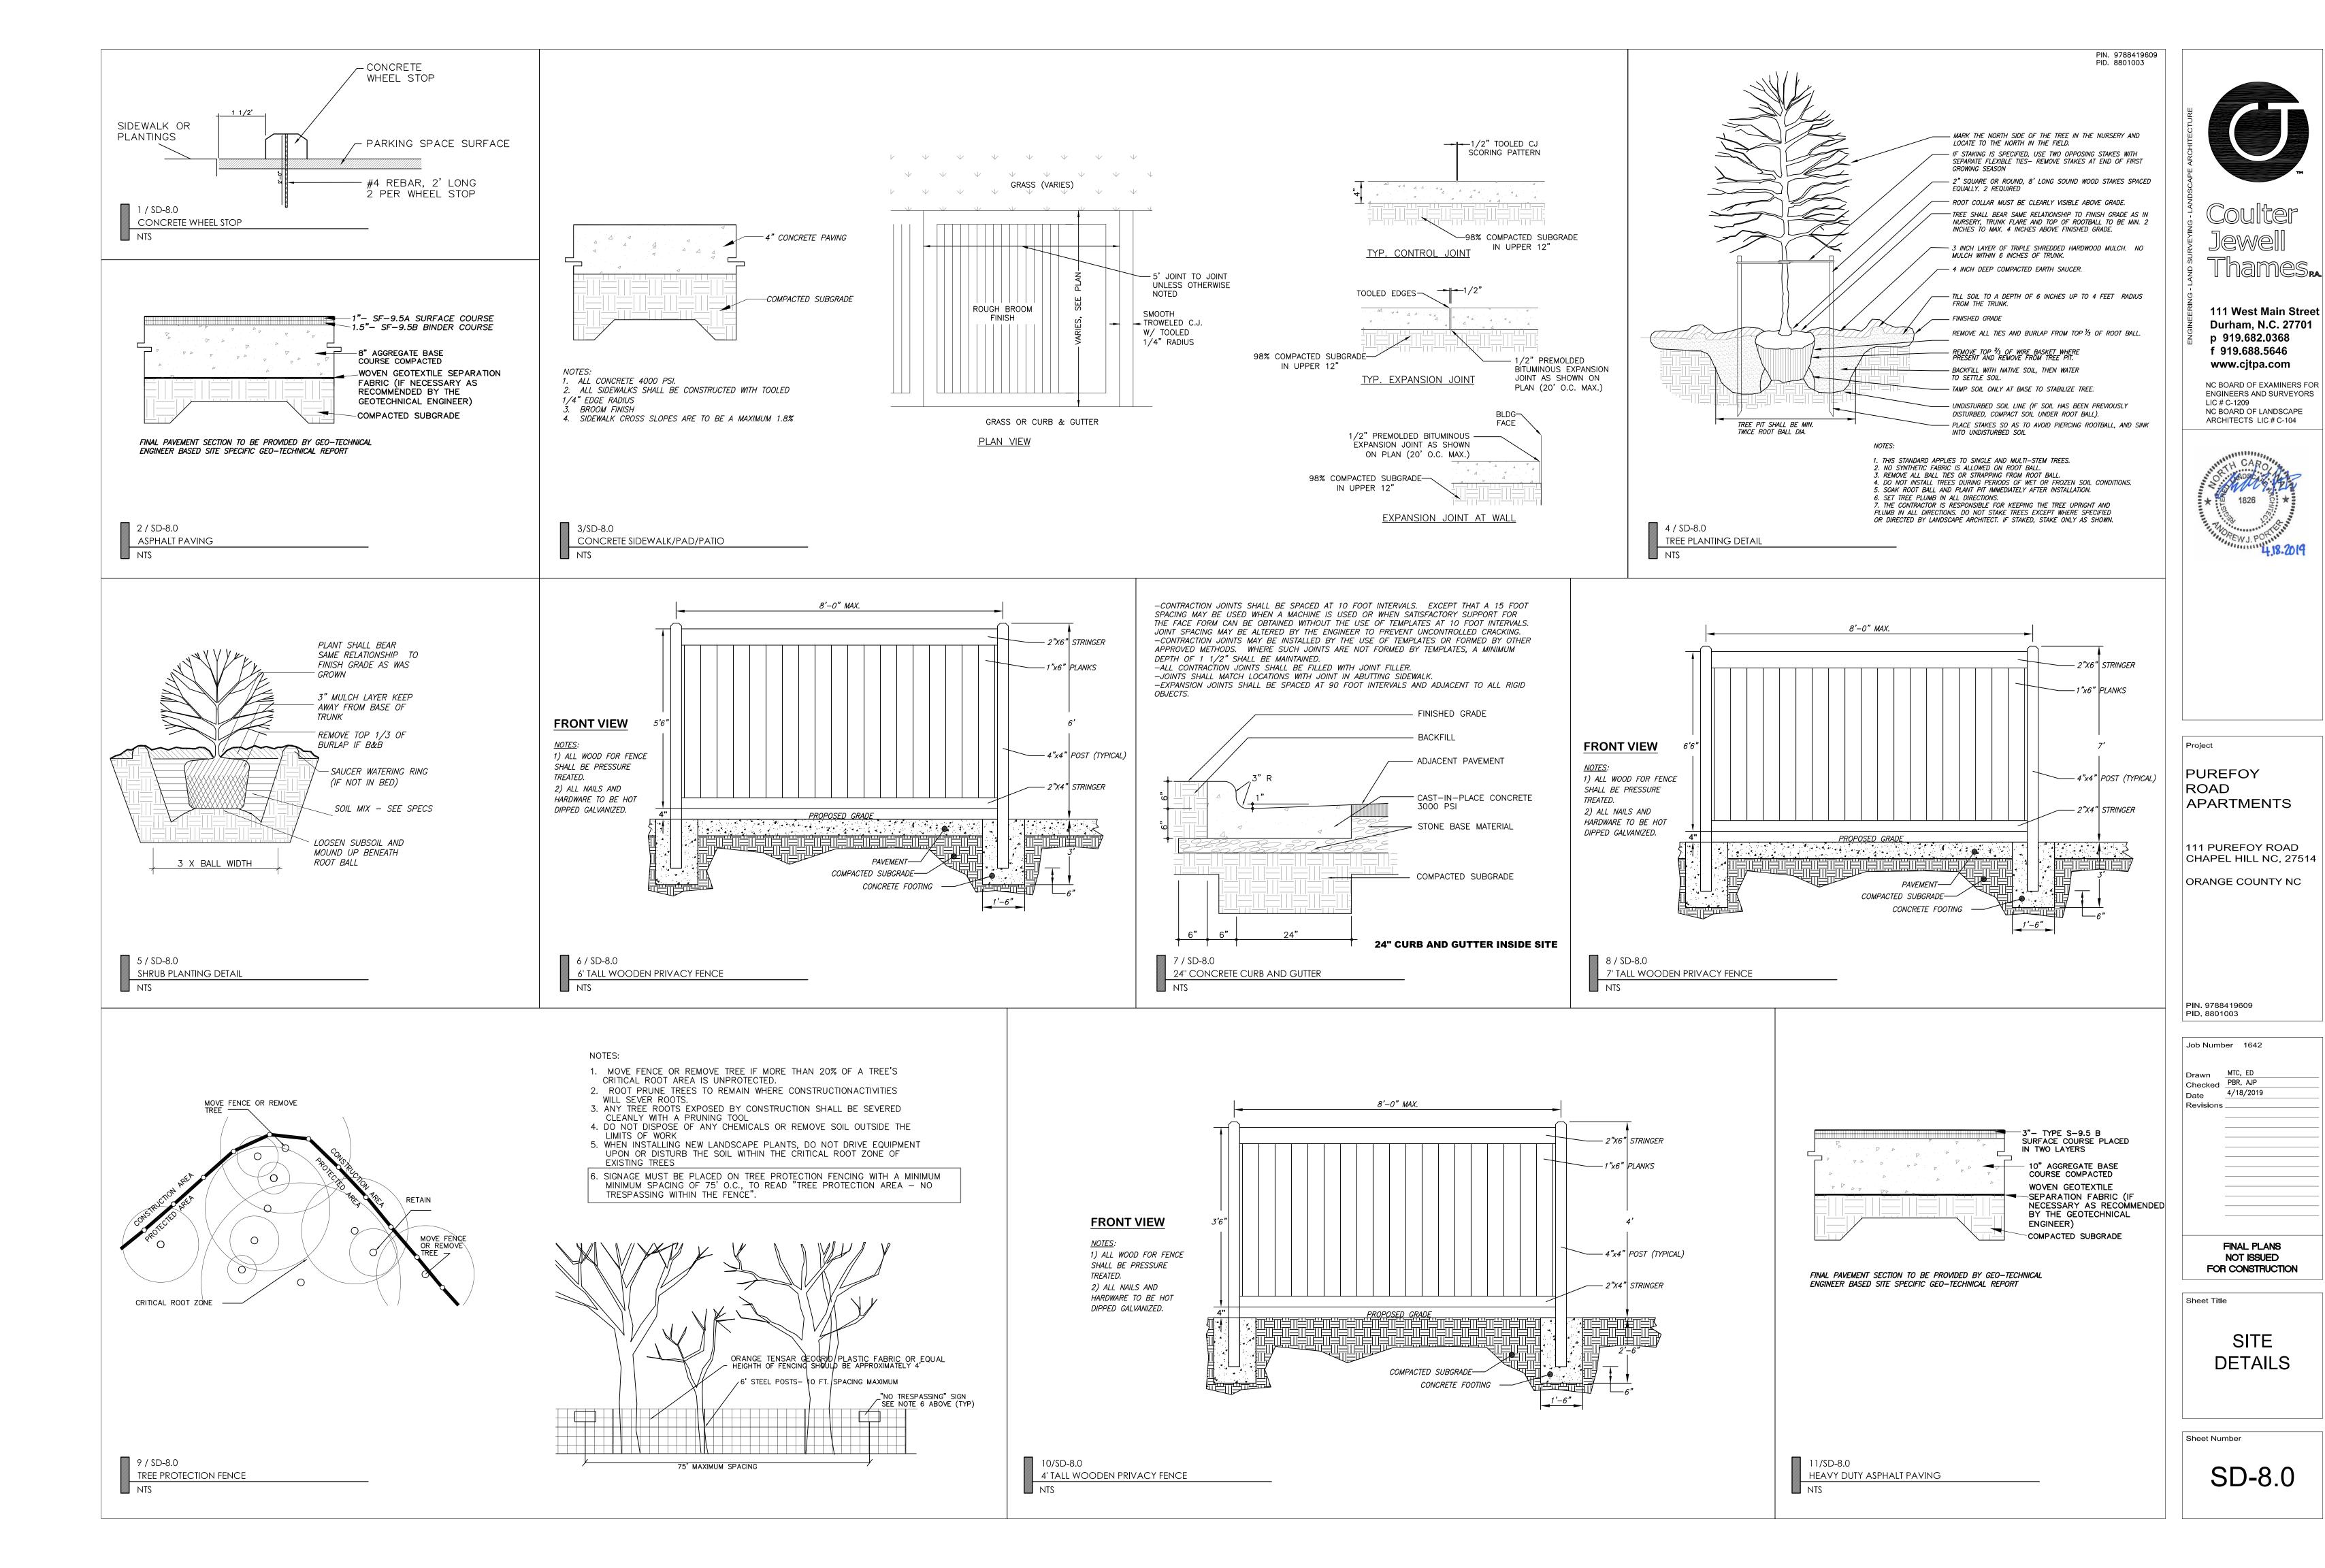
Job Number 1642 Drawn MTC, ED Checked PBR, AJP 4/18/2019 Date Revisions \_


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LANDSCAPE PLAN

Sheet Number

SD-7.0



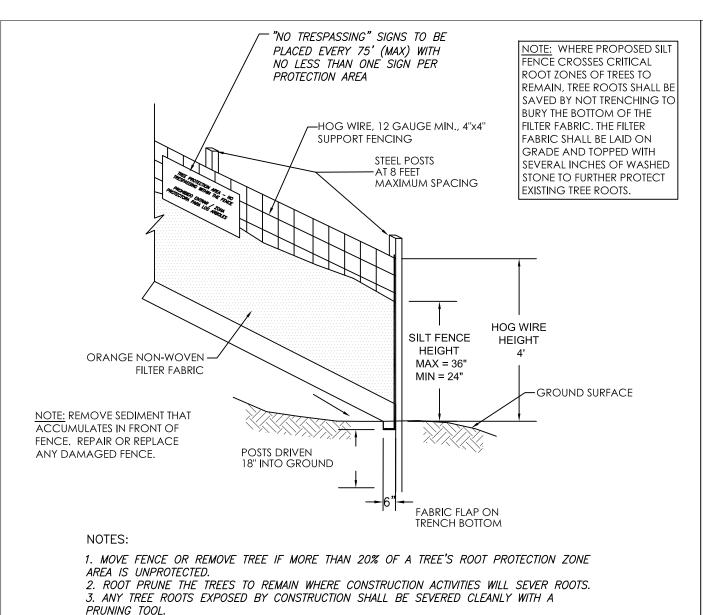


4. DO NOT DISPOSE OF ANY CHEMICALS OR REMOVE SOIL OUTSIDE THE LIMITS OF WORK. 5. WHEN INSTALLING NEW LANDSCAPE PLANTS, DO NOT DRIVE EQUIPMENT UPON OR DISTURB THE SOIL WITHIN THE ROOT ZONE PROTECTION AREA OF EXISTING TREES. 6. SIGNAGE IN BOTH ENGLISH AND SPANISH MUST BE PLACED ON TREE PROTECTION FENCING WITH A MINIMUM SPACING OF 75' O.C. SIGNAGE IS TO READ


TREE PROTECTION AREA - NO TRESPASSING WITHIN THE FENCE PROHIBIDO ENTRAR / ZONA PROTECTORA PARA LOS ARBOLES

7. INSPECT SEDIMENT FENCES AT LEAST ONCE A WEEK AND AFTER EACH RAINFALL. MAKE ANY REQUIRED REPAIRS IMMEDIATELY. 8. SHOULD THE FABRIC OF A SEDIMENT FENCE COLLAPSE, TEAR, DECOMPOSE OR BECOME INEFFECTIVE, REPLACE IT PROMPTLY. 9. REMOVE SEDIMENT DEPOSITS AS NECESSARY TO PROVIDE ADEQUATE STORAGE VOLUME FOR THE NEXT RAIN AND TO REDUCE PRESSURE ON THE FENCE. TAKE CARE TO AVOID UNDERMINING THE FENCE DURING CLEANOUT. 10. REMOVE ALL FENCING MATERIALS AND UNSTABLE SEDIMENT DEPOSITS AND BRING THE AREA TO GRADE AND STABILIZE IT AFTER THE CONTRIBUTING DRAINAGE AREA HAS BEEN PROPERLY STABILIZED.

COMBINATION TREE PROTECTION FENCE SILT FENCE

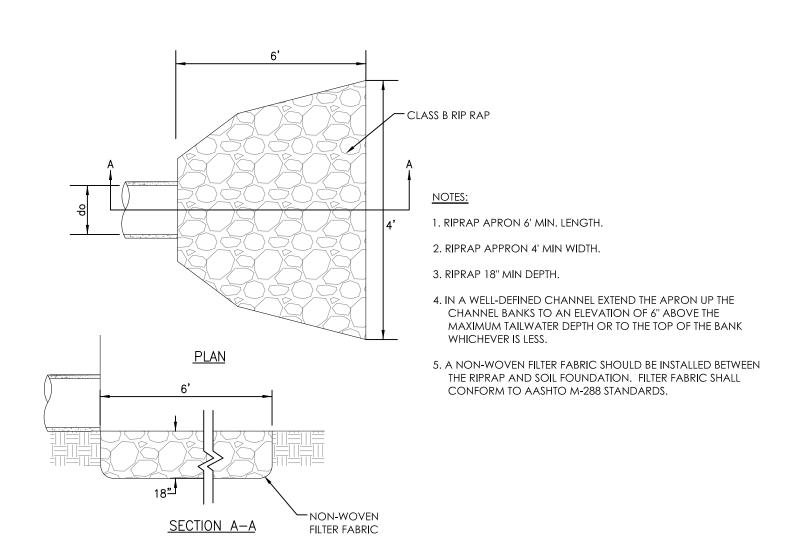


NSPECT RIPRAP OUTLET STRUCTURES WEEKLY AND AFTER SIGNIFICANT (3" OR GREATER) RAINFALL EVENTS TO SEE IF ANY EROSION AROUND OR BELOW THE RIPRAP HAS TAKEN PLACE, OR IF STONES HAVE BEEN DISLODGED. IMMEDIATELY MAKE ALL NEEDED REPAIRS TO PREVENT FURTHER DAMAGE.

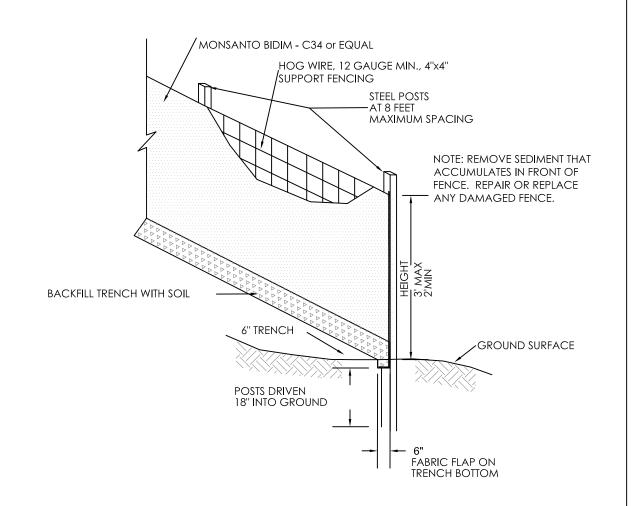

1. Inspect sediment fences at least once a week and after each rainfall. Make any required repairs immediately. 2. Should the fabric of a sediment fence collapse, tear, decompose or become ineffective, replace it promptly. 3. Remove sediment deposits as necessary to provide adequate storage volume for the next rain and to reduce pressure on the fence. Take care to avoid undermining the fence during cleanout.


4. Remove all fencing materials and unstable sediment deposits and bring the area to grade and stabilize it after the contributing drainage area has been properly stabilized.

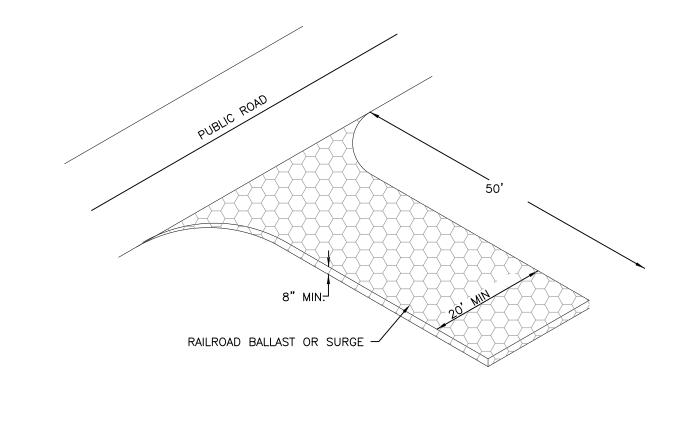

### CONSTRUCTION SPECIFICATIONS

- 1. AVOID CURVES IN PUBLIC ROADS AND STEEP SLOPES. REMOVE ALL VEGETATION AND OTHER OBJECTIONABLE MATERIAL FROM FOUNDATION AREA. GRADE AND CROWN
- FOUNDATION FOR POSITIVE DRAINAGE. 2. IF THE SLOPE TOWARD THE ROAD EXCEEDS 2%, CONSTRUCT A RIDGE, 6 TO 8 INCHES HIGH WITH 3:1 SIDE SLOPES, ACROSS THE FOUNDATION APPROXIMATELY 1.5 FT FROM THE
- ENTRANCE TO DIVERT RUNOFF AWAY FROM THE PUBLIC ROAD. 3. PLACE NON-WOVEN GEO-TEXTILE FABRIC ON GRADED FOUNDATION TO IMPROVE STABILITY, ESPECIALLY WHERE WET CONDITIONS ARE ANTICIPATED.
- 4. PLACE STONE TO DIMENSIONS AND GRADE SHOWN ON PLANS. LEAVE SURFACE SMOOTH
- AND SLOPED FOR DRAINAGE. 5. INSTALL PIPE UNDER PAD IF NEEDED TO MAINTAIN PROPER PUBLIC ROAD DRAINAGE.

MAINTAIN THE GRAVEL PAD IN A CONDITION TO PREVENT MUD OR SEDIMENT FROM LEAVING THE CONSTRUCTION SITE. THIS MAY REQUIRE PERIODIC REMOVAL AND REPLACEMENT OF STONE, AS NECESSARY. IMMEDIATELY REMOVE ALL OBJECTIONABLE MATERIALS SPILLED WASHED, OR TRACKED ONTO PUBLIC ROADWAYS.

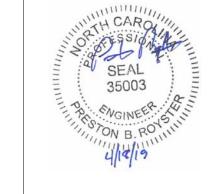

PUREFOY

PIN. 9788419609

Job Number 1642

Checked PBR, AJP

Revisions \_

MTC, ED

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APARTMENTS

111 PUREFOY ROAD

ORANGE COUNTY NC

CHAPEL HILL NC, 27514

ROAD

111 West Main Street

**Durham, N.C. 27701** 

NC BOARD OF EXAMINERS FOR

ENGINEERS AND SURVEYORS

NC BOARD OF LANDSCAPE

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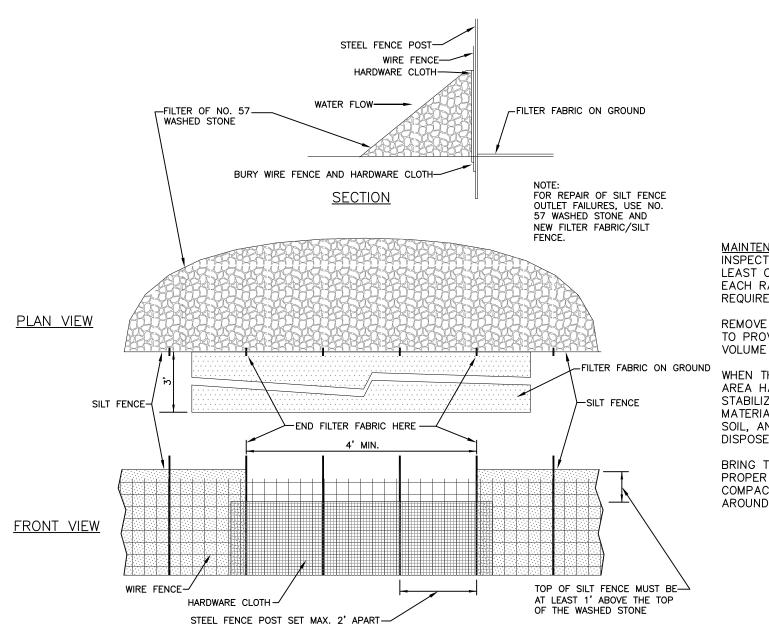
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LIC # C-1209

PIN. 9788419609

3 / SD-8.1 SILT FENCE

4 / SD-8.1 GRAVEL CONSTRUCTION ENTRANCE



MAINTENANCE INSPECT SILT FENCE OUTLETS AT LEAST ONCE A WEEK AND AFTER EACH RAINFALL. MAKE ANY REQUIRED REPAIRS AS NEEDED. REMOVE SEDIMENT AS NECESSARY TO PROVIDE ADEQUATE STORAGE VOLUME FOR SUBSEQUENT RAINS.

2 / SD-8.1

NTS

RIP RAP APRON

WHEN THE CONTRIBUTING DRAINAGE AREA HAS BEEN ADEQUATELY STABILIZED, REMOVE ALL MATERIALS AND ANY UNSTABLE SOIL, AND EITHER SALVAGE OR DISPOSE OF IT PROPERLY.

BRING THE DISTURBED AREA TO PROPER GRADE, THEN SMOOTH AND COMPACT IT. STABILIZE AREAS AROUND THE OUTLET.

FALL/WINTER/SPRING TEMPORARY COVER AUGUST 15 - MAY 1 100 lbs/1000 sf 25 lbs/1000 sf 2 lbs/1000 sf 10-10-10 Fertilizer Rye Grain Seed 1 lbs/1000 sf 100 lbs/1000 sf Straw Mulch \* MAY 1 - AUGUST 15 SUMMER TEMPORARY COVER 100 lbs/1000 sf 10-10-10 Fertilizer 15 lbs/1000 sf Browntop Millet Seed 100 lbs/1000 sf Straw Mulch \* SPRING/FALL PERMANENT COVER Lime 100 lbs/1000 sf 8 lbs/1000 sf Improved Turf Type Fine Fescue Seed Straw Mulch \* 100 lbs/1000 sf SUMMER PERMANENT COVER APRIL1 - AUGUST 15 SPRIGS STOLONS BERMUDAGRASS APRL-JULY 1-2 .75 3-5 BERMUDAGRASS(HYBRID) APRL-JULY .75 3-5 MARCH-JULY .25-.50 CENTIPDEGRASS ST.AUGISTINEGRASS 1.0 APRIL-JULY TALL FESCUE SEPT.-OCT.15 .50-1.0 .25 ZOYSIAGRASS MAY-JULY

1. OPTIMUM DATE OF PLANTING. SEEDING BEYOND THESE DATES INCREASES THE CHANCE OF FAILURE. 2. POUNDS PER 1000 SQ.FT. 3. BUSHELS PER 1000 SQ.FT.

Seedbed Preparation: Remove rocks, stumps, roots, etc. Apply lime and fertilizer then rip the soil 4 to 6 inches to mix the nutrients into the soil and to loosen and roughen it to recieve seed.

Seed Temporary cover to stabilize temporary sedimentation control measures and other accomplished. If planting season is not suitable for installation of permanent cover. Contractor shall install temporary cover suitable for that season and reseed with permanent grass at earliest possible date. \* Anchor straw mulch by applying an asphalt binder emulsion at a rate of 10 gallons per 1000 SF, or install jute, paper or twine netting or excelsior mats staked to ground according to the manufacturer's instructions.

STABILIZATION TIME TABLE

I. All permanent dikes, swales, ditches, perimeter slopes, and all slopes steeper than 3:1 shall be provided with temporary or permanent stabilization with groundcover as soon as practicable but within 7 calendar

2. All other disturbed areas shall be provided with temporary or permanent stabilization with groundcover as soon as practicable but in any event within 14 calendar days from last land-disturbing activity.

"EXPOSED" AREAS INCLUDE, BUT ARE NOT LIMITED TO:

 AREAS CLEARED FOR ROADWAY CONSTRUCTION. AREAS CLEARED ON RESIDENTIAL BUILDING LOTS.

• DRAINAGE EASEMENTS AND OPEN DRAINAGE CHANNELS. SEDIMENT AND EROSION CONTROL MEASURES (SEDIMENT TRAPS, DIVERSION DITCHES, ETC.) AND THE AREAS ADJECENT TO SUCH MEASURES.


9 / SD-8.1


6 / SD-8.1 SEEDING SCHEDULE

Ground Stabilization*		
Site Area Description	Stabilization Time Frame	Stabilization Time Frame Exceptions
imeter dikes, les, ditches, slopes	7 days	None
h Quality ter (HQW) es	7 days	None
oes steeper n 3:1	7 days	If slopes are 10' or less in length and are not steeper than 2:1, 14 days are allowed
oes 3:1 or ter	14 days	7 days for slopes greater than 50 feet in length
other areas h slopes ter than 4:1	14 days	None (except for perimeters and HWQ Zones)

\* "Extensions of time may be approved by the permitting authority based on weather or other site-specific conditions that make compliance impracticable" (Section 11.B(2)(b))

NOTE: BASE BID TO INCLUDE ANY TEMPORARY SEEDING REQUIRED

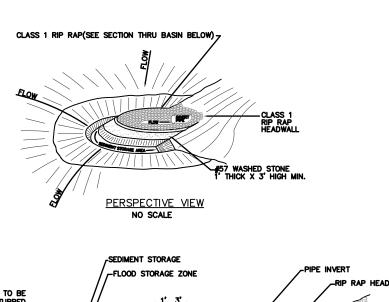

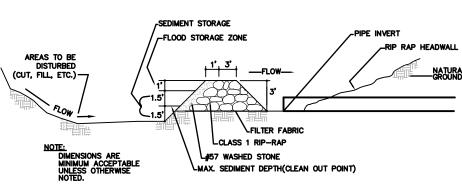


SECTION THRU BASIN, FILTER AND CULVERT PIPE

## NOTE: GRAVEL & RIP RAP FILTER BERM BASIN DETAIL IS DESIGNED TO PROTECT EXISTING PIPE INVERTS THAT DRAIN 10 ACRES OR LESS.

<u>Maintenance</u> Inspect the filter at least weekly and after each significant (½ inch or greater) rainfall and make repairs as needed. Remove sediment as necessary to provide adequate storage volume for subsequent rains. Replace stone as necessary along face of filter. When the contributing drainage area has been adequately stabilized, remove all materials and any unstable soil, and either salvage or dispose of it properly. Bring the disturbed area to proper grade, then smooth and compact it. Appropriately stabilize all bare areas around

7 / SD-8.1 ARCH FILTER ■ NTS

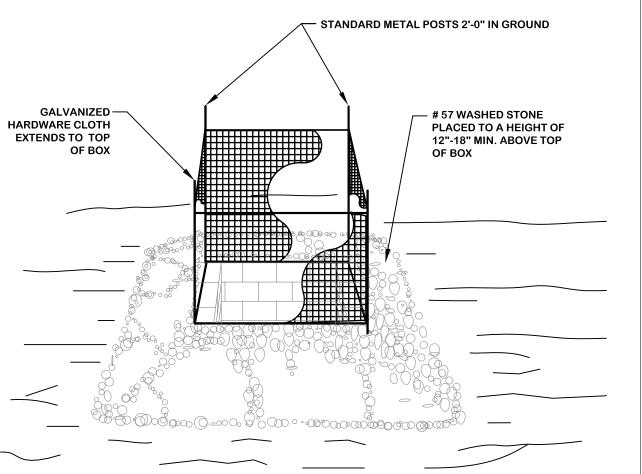

MAINTENANCE NOTES: INSPECT INLETS AT LEAST WEEKLY AND AFTER EACH SIGNIFICANT () INCH OR GREATER) RAINFALL EVENT. CLEAR THE MESH WIRE OF ANY DEBRIS OR OTHER OBJECTS TO PROVIDE ADEQUATE FLOW FOR SUBSEQUENT RAINS. TAKE CARE NOT TO DAMAGE OR UNDERCUT THE WIRE MESH DURING SEDIMENT REMOVAL. REPLACE STONE AS NEEDED.

10 / SD-8.1 TEMPORARY INLET PROTECTION

■ NTS

1. Prepare soil before installing blankets, including any necessary application of lime, fertilizer, 2. Begin at the top of the channel by anchoring the blanket in a 6" deep x 6" wide trench. Anchor the blanket with a row of staples/stakes approximately 12" apart in the bottom of the trench. Backfill and compact the trench after stapling. Apply seed to compacted soil and fold remaining 12" portion of blanket back over seed and compacted soil. Secure blanket over compacted soil with a row of staples/stakes spaced approximately 12" apart across the width of the blanket. 3. Roll center blanket in direction of water flow in bottom of channel. Unroll blankets with appropriate side against the soil surface. All blankets must be securely fastened to soil surface by placing staples/stakes in appropriate locations as shown by manufacturer.

4. Place consecutive blankets end over end (shingle style) with a 4"-6" overlap. Use a double row of staples staggered 4" apart and 4" on center to secure blankets. 5. Full length edge of blankets at top of side slopes must be anchored with a row of staples/stakes approximately 12" apart in a 6" deep x 6" wide trench. Backfill and compact


the trench after stapling. 6. Adjacent blankets must be overlapped approximately 2"-5" (depending on blanket type) and 7. A staple check slot is recommended at 30 to 40 foot intervals. Use a double row of staples staggered 4" apart and 4" on center over entire width of the channel. 8. The terminal end of the blankets must be anchored with a row of staples/stakes approximately 12" apart in a 6" deep x 6" wide trench. Backfill and compact the trench after


8 / SD-8.1 TURF REINFORCING MAT

NTS

5 / SD-8.1

SILT FENCE OUTLET

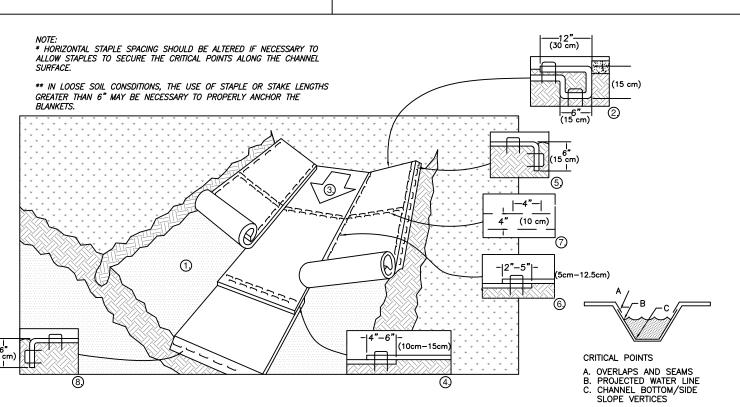


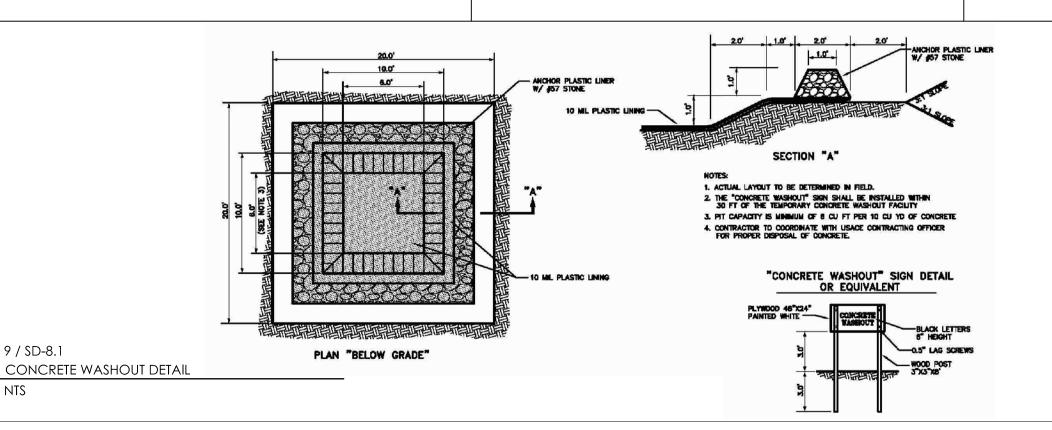


FINAL PLANS NOT ISSUED FOR CONSTRUCTION Sheet Title

> **EROSION** CONTROL **DETAILS**

Sheet Number SD-8.1

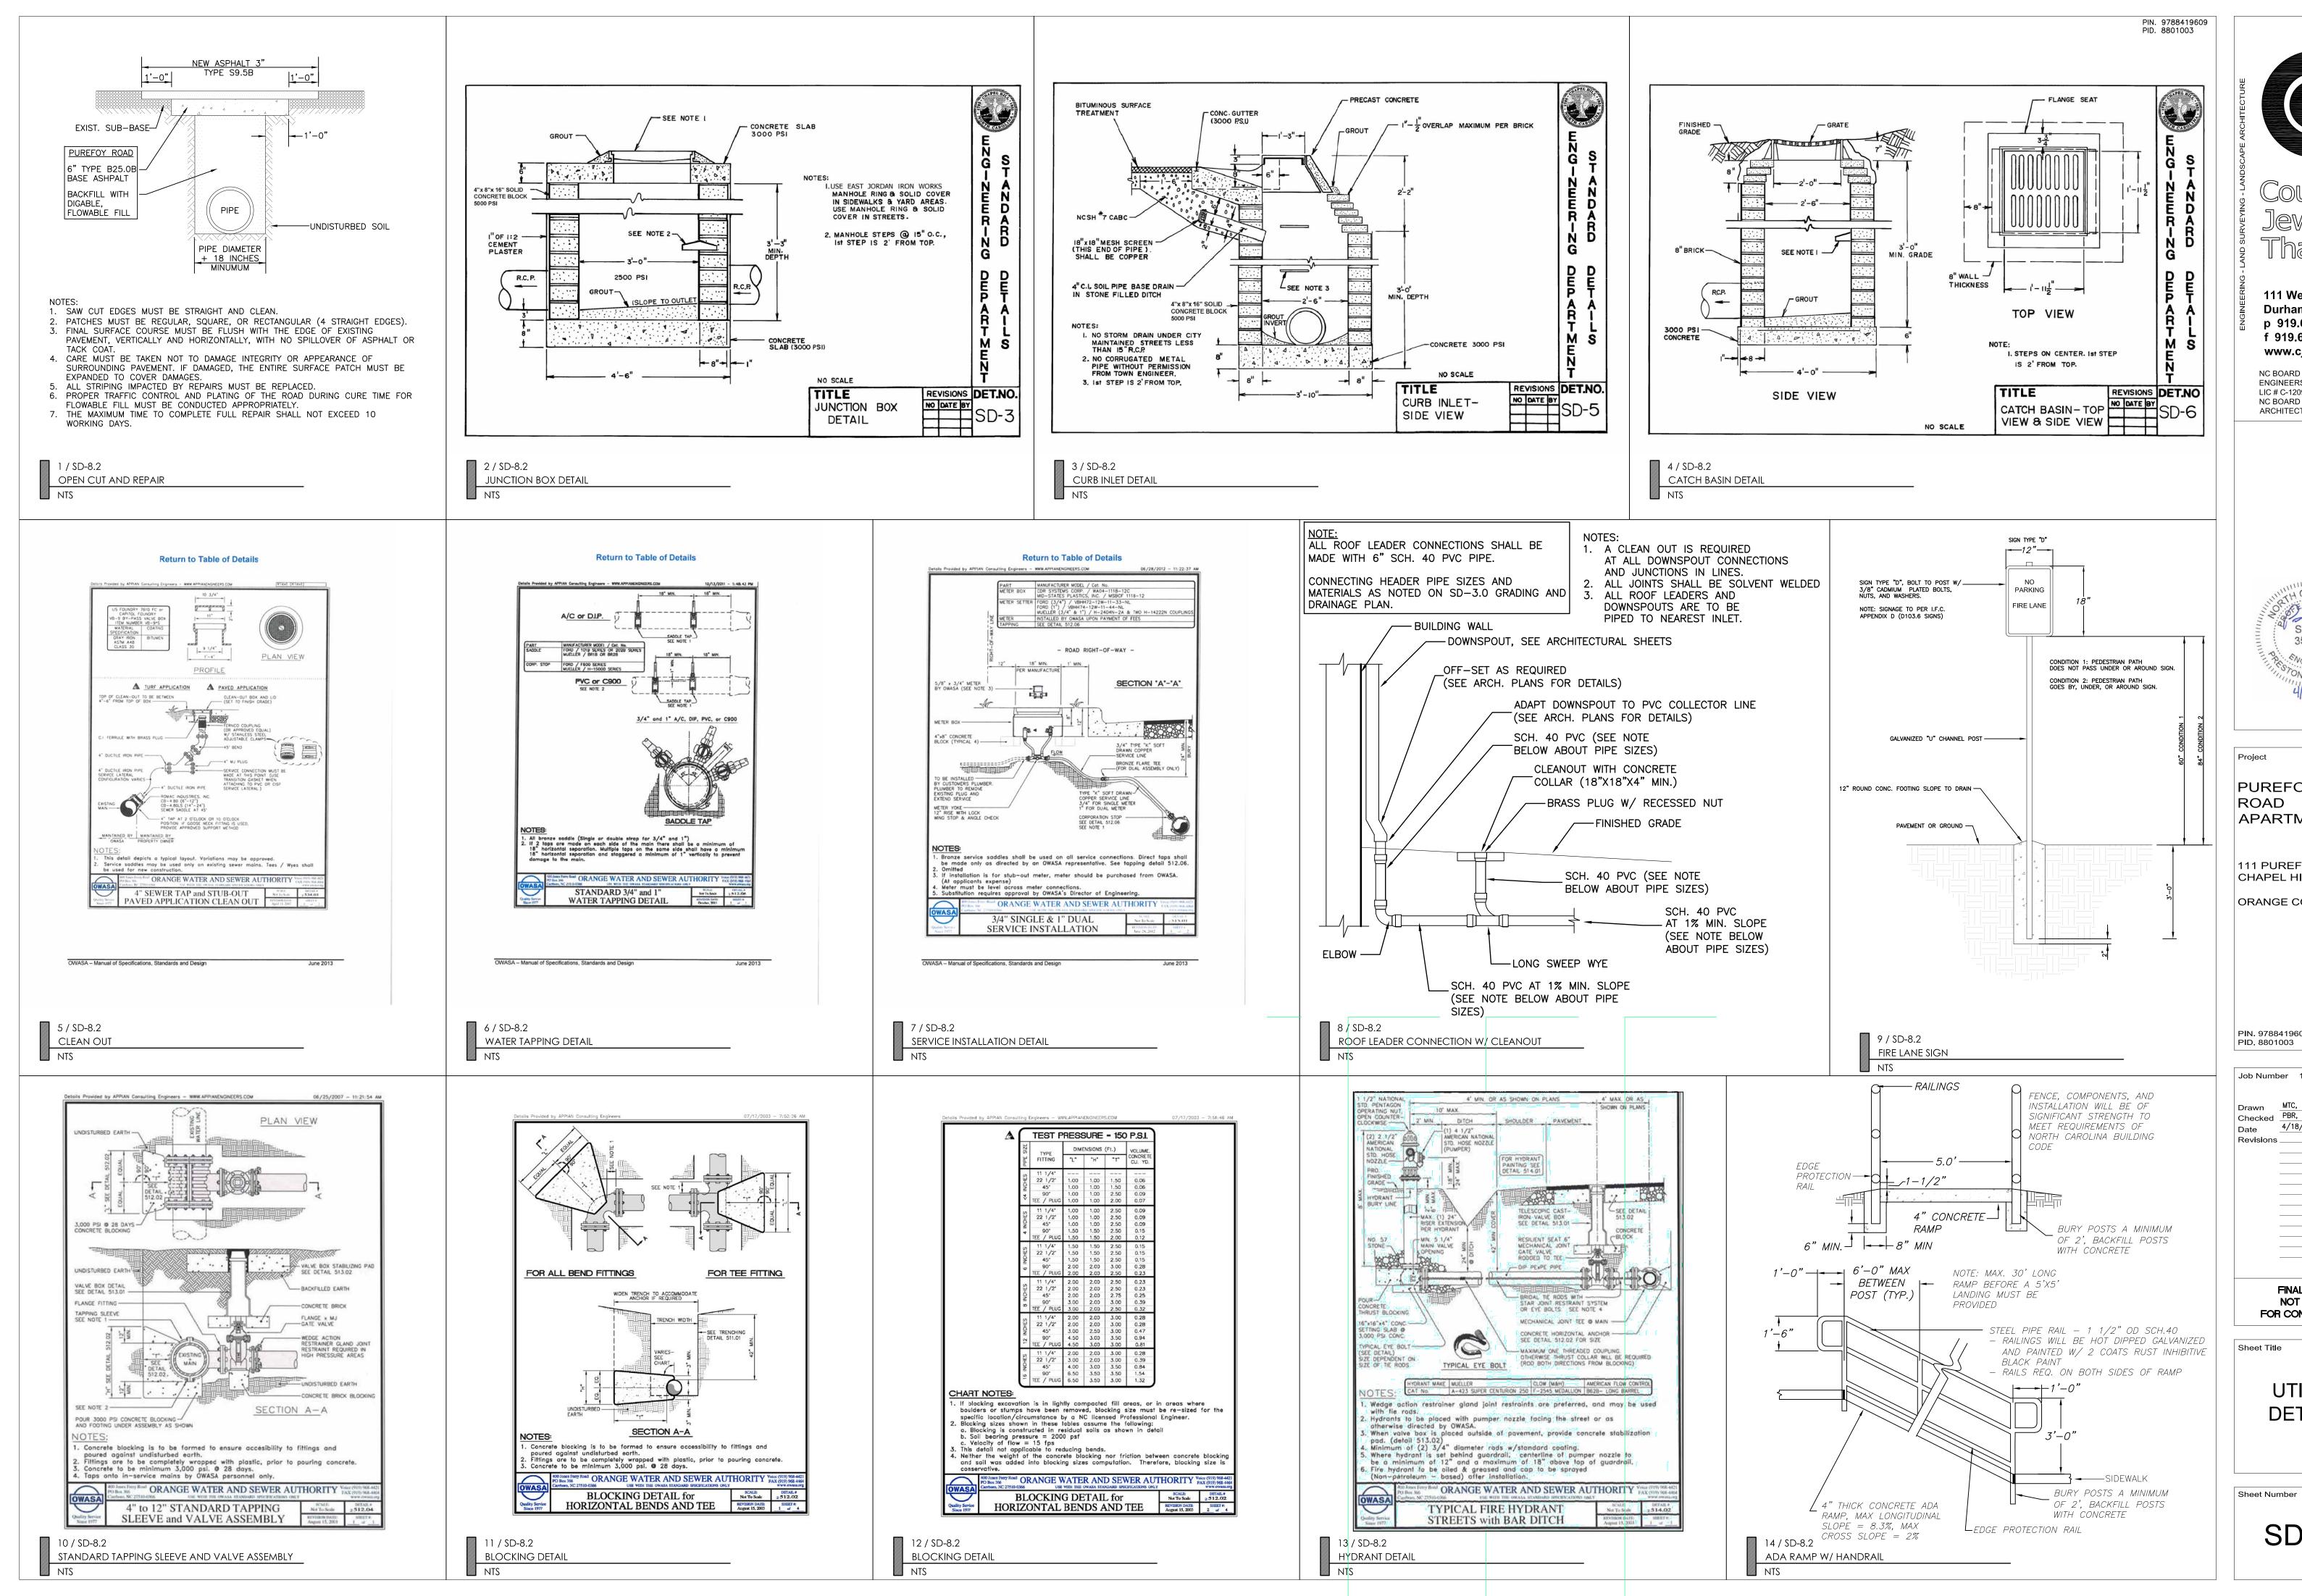

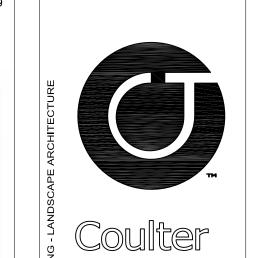

NC BOARD OF EXAMINERS FOR ENGINEERS AND SURVEYORS LIC # C-1209 NC BOARD OF LANDSCAPE ARCHITECTS LIC # C-104

35003

PUREFOY ROAD APARTMENTS

111 PUREFOY ROAD CHAPEL HILL NC, 27514 ORANGE COUNTY NC

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Job Number 1642 MTC, ED Checked PBR, AJP Date 4/18/2019 Revisions \_\_

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UTILITY **DETAILS** 

SD-8.2