SITE PLAN REVIEW APPLICATION



TOWN OF CHAPEL HILL **Planning Department**

405 Martin Luther King Jr. Blvd. phone (919) 969-5066 fax (919 969-2014 www.townofchapelhill.org

Parcel Identifier Number (PIN): 9788068190 Date: **REV. 2.4.19 Section A: Project Information** Project Name: YELLOW HOUSE TACO Zip Code: 2<u>7516</u> **Property Address:** 104 NORTH GRAHAM STREET TC-2 Use Groups (A, B, and/or C): C (RESTAURANT) **Existing Zoning District:** <u>UPFIT EXISTING BUILDING INTO RESTAURANT WITH ON SITE COMMERCIAL</u> **Project Description:** KITCHEN AND DINING (INDOOR + OUTDOOR) Section B: Applicant, Owner, and/or Contract Purchaser Information **Applicant Information** (to whom correspondence will be mailed): JIM SPENCER, AIA, LEED BD+C - JIM SPENCER ARCHITECTS, PA Name: Address: PO BOX 385 City: State: Zip Code: NC. 27510 CARRBORO 919-960-6680 jspencerjsa@gmail.com Email: Phone: The undersigned applicant herby certifies that, to the best of their knowledge and belief, all information supplied with this application is true and accurate. Date: FEB. 4, 2019 Signature: **Owner/Contract Purchaser Information: Owner Contract Purchaser** IF 4 WERE 9 LLC (SAMMY MARTIN, REPRESENTATIVE) Name: 1525 EAST FRANKLIN STREET SUITE 4 Address: CHAPEL HILL NC 27514 City: State: Zip Code: 919-608-3417 Phone: Email: sidproquo@gmail.com The undersigned applicant herby certifies that, to the best of their knowledge and belief, all information supplied with this application is true and accurate. for Sammy Martin Date: FEB. 4, 2019 Signature: Click here for application submittal instructions.

Page **1** of **10**



PROJECT FACT SHEET

TOWN OF CHAPEL HILL Planning Department

Section A: Project Information								
Use Type: (check/list all that apply)								
Office/Institutional	Office/Institutional Residential Mixed-Use X Other: (RESTAURANT)							
Overlay District: (check all that apply)								
Historic District	Historic District Neighborhood Conservation District Airport Hazard Zone							
Section B: Land Area								
Net Land Area (NLA): Area wi	thin zoning bounda	ries			NLA=	6,058	sq. ft.	
Choose one, or both, of the following (a or b), not to	right-of-way		frontage) x ½ width of p		CSA=	+/- 3,000	sq. ft.	
exceed 10% of NLA	b) Credited Perma or dedicated open		tal adjacent frontage) x	½ public	COS=		sq. ft.	
TOTAL: NLA + CSA and/or COS	S = Gross Land Area	(not to exceed NLA	+ 10%)		GLA=	6,664	sq. ft.	
Section C: Special Protect Special Protection Areas: Jordan Buffer F	<u> </u>	at apply)	_	Watershe	d Protec	tion District		
Land Disturbance						Total (sq. ft.)	
Area of Land Disturbance (Includes: Footprint of proposed grading, including off-site clearing)		ea envelope, staging a	rea for materials, access/e	quipment բ	oaths, and	^{1 all} 1,74	0 SF	
Area of Land Disturbance with	nin RCD					0		
Area of Land Disturbance with	nin Jordan Buffer					0		
			·					
Impervious Areas		Existing (sq. ft.)	Demolition (sq. ft.)	Proposed (sq. ft.)		t.) Total	(sq. ft.)	
Impervious Surface Area (ISA)		5,154 SF		366 S	F	5,520	SF	
Impervious Surface Ratio: Per Surface Area of Gross Land Ar	ea (ISA/GLA)%	77.3%		(NEW	PAD F	OR 82.8%)	
If located in Watershed Prote of impervious surface on 7/1/	·				C)			



PROJECT FACT SHEET

TOWN OF CHAPEL HILL Planning Department

Section D: Dimensions

Dimensional Unit (sq. ft.)	Existing (sq. ft.)	Demolition (sq. ft.)	Proposed (sq. ft.)	Total (sq. ft.)
Number of Buildings	1 (1,127 SF)	0	96 SF	1 (1,223 SF)
Number of Floors	1			1
Recreational Space				

Residential Space						
Dimensional Unit (sq. ft.)	Existing (sq. ft.)	Demolition (sq. ft.)	Proposed (sq. ft.)	Total (sq. ft.)		
Floor Area (all floors – heated and unheated)						
Total Square Footage of All Units						
Total Square Footage of Affordable Units						
Total Residential Density						
Number of Dwelling Units	1 (1,127) CHAN	IGE OF USE TO RES	TAURANT (SHELL RE	MAINS)		
Number of Affordable Dwelling Units						
Number of Single Bedroom Units						
Number of Two Bedroom Units						
Number of Three Bedroom Units						

Non-Residential Space (Gross Floor Area in Square Feet)							
Use Type	Existing	Proposed	Uses	Existing	Proposed		
Commercial							
Restaurant		1,223 SF	# of Seats		77(35 Inside, 42 Outside)		
Government							
Institutional							
Medical							
Office							
Hotel			# of Rooms				
Industrial							
Place of Worship			# of Seats				
Other							

Dimensional Requirements		Required by Ordinance	Existing	Proposed
	Street	0	0	0
Setbacks (minimum)	Interior (neighboring property lines)	0	3'/14'	3'/14'
(11111111111111)	Solar (northern property line)	0	3'	3'
Height	Primary	44'	18'-6"	18'-6"
(maximum)	Secondary	90'	18'-6"	18'-6"
6 1 1	Frontages	12'	100'	100'
Streets	Widths	15'		

DE



PROJECT FACT SHEET

TOWN OF CHAPEL HILL Planning Department

Section D: Dimensions

(Note: For approval of proposed street names, contact the Engineering Department)

Street Name	Right-of-Way Width	Pavement Width	Number of Lanes	Existing Sidewalk*	Existing Curb/Gutter
NORTH GRAHAM STREET	60'	38'-6"	2	PAR764AL	PART IMes
WEST FRANKLIN STREET	100'	58'-6"	4	ৄ Yes	X Yes

List Proposed Points of Access (Ex. Number, Street Name):

*If existing sidewalks do not exist and the applicant is adding sidewalks, please provide the following information:

Sidewalk Information				
Street Names	Dimensions	Surface	Handicapped Ramps	
NORTH GRAHAM STREET	9' WIDE	CH GRAVEL	PARTEAL NO N/A	
			Yes No N/A	

Section G: Parking Information

Parking Spaces	Minimum	Maximum	Proposed
Regular Spaces	1	1	1
Handicap Spaces	1	1	1
Total Spaces	2		2
Loading Spaces			1
Bicycle Spaces			4
Surface Type			ASPHALT

Section H: Landscape Buffers

Location (North, South, Street, Etc.)	Minimum Width	Proposed Width	Alternate Buffer	Modify Buffer
			Yes	Yes



PROJECT FACT SHEET

TOWN OF CHAPEL HILL Planning Department

Section I: Land Use Intensity

Existing Zoning District: TC-2
Proposed Zoning Change (if any): N/A

Note: Refer to Table 3.8-1 (Dimensional Matrix) in the Land Use Management Ordinance for help completing this table.

Zoning – Area – Ratio		Impervious Surface Thresholds			Minimum and Maximum Limitations		
Zoning District(s)	Floor Area Ratio (FAR)	Recreation Space Ratio (RSR)	Low Density Residential (0.24)	High Density Residential (0.50)	Non- Residential (0.70)	Maximum Floor Area (MFA) = FAR x GLA	Minimum Recreation Space (MSR = RSR x GLA)
TC-2-C	1.97	N/A			.787	13,130 SF	N/A
TOTAL							
RCD Streamside		0.01					
RCD Managed		0.019					
RCD Upland							

Section J: Utility Service

Check all that apply:								
Water		☐ Individual Well	Community Well	Other				
Sewer		☐ Individual Septic Tank	Community Package Plant	Other				
Electrical	Underground	X Above Ground						
Telephone	Underground	X Above Ground						
Solid Waste	Town	X Private						



TOWN OF CHAPEL HILL Planning Department

The following must accompany your application. Failure to do so will result in your application being considered incomplete. For assistance with this application, please contact the Chapel Hill Planning Department (Planning) at (919) 969-5066 or at planning@townofchapelhill.org. For detailed information, please refer to the Description of Detailed Information handout.

Application Fee (including Engineering Review Fee) – refer to fee schedule Amount	: Paid \$				
Pre-application meeting –with appropriate staff					
Digital Files – provide digital files of all plans and documents					
Recorded Plat or Deed of Property					
Project Fact Sheet					
Traffic Impact Statement – completed by Town's consultant (or exemption)					
Mailing list of owners of property within 1,000 feet perimeter of subject property (see GIS notificat	ion tool)				
Mailing fee for above mailing list (mailing fee is double due to 2 mailings) Amount	Paid \$				
Written Narrative describing the proposal					
Resource Conservation District, Floodplain, & Jordan Buffers Determination – necessary for all subn	nittals				
Jurisdictional Wetland Determination (if applicable)					
Resource Conservation District Encroachment Exemption or Variance (determined by Planning)					
Jordan Buffer Authorization Certificate or Mitigation Plan Approval (determined by Planning)					
Reduced Site Plan Set (reduced to 8.5" x 11")					

Stormwater Impact Statement (1 copy to be submitted)

- a) Written narrative describing existing & proposed conditions, anticipated stormwater impacts and management structures, and strategies to mitigate impacts
- b) Description of land uses and area (in square footage)
- c) Existing and proposed impervious surface area in square feet for all subareas and project area
- d) Ground cover and uses information
- e) Soil information (classification, infiltration rates, depth to groundwater and bedrock)
- f) Time of concentration calculations and assumptions
- g) Topography (2-foot contours)
- h) Pertinent on-site and off-site drainage conditions
- i) Upstream and/or downstream volumes
- j) Discharges and velocities
- k) Backwater elevations and effects on existing drainage conveyance facilities
- I) Location of jurisdictional wetlands and regulatory FEMA Special Flood Hazard Areas
- m) Water quality volume calculations
- n) Drainage areas and sub-areas delineated
- o) Peak discharge calculations and rates (1, 2, and 25-year storms)
- p) Hydrographs for pre- and post-development without mitigation, post-development with mitigation
- q) Volume calculations and documentation of retention for 2-year storm
- r) 85% TSS removal for post-development stormwater run-off



TOWN OF CHAPEL HILL Planning Department

- s) Nutrient loading calculations
- t) BMP sizing calculations
- u) Pipe sizing calculations and schedule (include HGL & EGL calculations and profiles)

Plan Sets (10 copies to be submitted no larger than 24" x 36")

Plans should be legible and clearly drawn. All plan set sheets should include the following:

- Project Name
- Legend
- Labels
- North Arrow (North oriented toward top of page)
- Property boundaries with bearing and distances
- Scale (Engineering), denoted graphically and numerically
- Setbacks
- Streams, RCD Boundary, Jordan Riparian Buffer Boundary, Floodplain, and Wetlands Boundary, where applicable
- Revision dates and professional seals and signatures, as applicable

Area Map

- a) Project name, applicant, contact information, PIN, & legend
- b) Dedicate open space, parks, greenways
- c) Overlay Districts, if applicable
- d) Property lines, zoning district boundaries, land uses, project names of site and surrounding properties, significant buildings, & corporate limit lines
- e) Existing roads (public & private), rights-of-way, sidewalks, driveways, vehicular parking areas, bicycle parking, handicapped parking, street names
- f) 1,000' notification boundary

Existing Conditions Plan

- a) Slopes, soils, environmental constraints, existing vegetation, and any existing land use features
- b) Location of all existing structures and uses
- c) Existing property line and right-of-way lines
- d) Existing utilities & easements including location & sizes of water, sewer, electrical, & drainage lines
- e) Nearest fire hydrants
- f) Nearest bus shelters and transit facilities
- g) Existing topography at minimum 2-foot intervals and finished grade
- h) Natural drainage features & water bodies, floodways, floodplain, RCD, Jordan Buffers, & Watershed boundaries



TOWN OF CHAPEL HILL Planning Department

Detailed Site Plan

- a) Existing and proposed building locations
- b) Description & analysis of adjacent land uses, roads, topography, soils, drainage patterns, environmental constraints, features, existing vegetation, vistas (on & off-site)
- c) Location, arrangement, & dimension of vehicular parking, width of aisles and bays, angle of parking, number of spaces, handicapped parking, bicycle parking. Typical pavement sections and surface type.
- d) Location of existing and proposed fire hydrants
- e) Location and dimension of all vehicle entrances, exits, and drives
- f) Dimensioned street cross-sections and rights-of-way widths
- g) Pavement and curb & gutter construction details
- h) Dimensioned sidewalk and tree lawn cross-sections
- i) Proposed transit improvements including bus pull-off and/or bus shelter
- j) Required landscape buffers (or proposed alternate/modified buffers)
- k) Required recreation area/space (including written statement of recreation plans)
- I) Refuse collection facilities (existing and proposed) or shared dumpster agreement
- m) Construction parking, staging, storage area, and construction trailer location
- n) Sight distance triangles at intersections
- o) Proposed location of street lights and underground utility lines and/or conduit lines to be installed
- p) Easements
- q) Clearing and construction limits
- r) Traffic Calming Plan detailed construction designs of devices proposed & associated sign & marking plan

Detailed Site Plan

- a) Topography (2-foot contours)
- b) Existing drainage conditions
- c) RCD and Jordan Riparian Buffer delineation and boundary (perennial & intermittent streams, note ephemeral streams on site)
- d) Proposed drainage and stormwater conditions
- e) Drainage conveyance system (piping)
- f) Roof drains
- g) Easements
- h) BMP plans, dimensions, details, and cross-sections
- i) Planting and stabilization plans and specifications

Detailed Site Plan

- a) Rare, specimen, and significant tree survey within 50 feet of construction area
- b) Rare and specimen tree critical root zones
- c) Rare and specimen trees proposed to be removed
- d) Certified arborist tree evaluation, if applicable
- e) Significant tree stand survey
- f) Clearing limit line
- g) Proposed tree protection/silt fence location
- h) Pre-construction/demolition conference note
- i) Landscape protection supervisor note
- j) Existing and proposed tree canopy calculations, if applicable



TOWN OF CHAPEL HILL Planning Department

Planting Plan

- a) Dimensioned and labeled perimeter buffers
- b) Off-site buffer easement, if applicable
- c) Landscape buffer and parking lot planting plan (including planting strip between parking and building, entryway planting, and 35% shading requirement

Steep Slope Plan

- a) Classify and quantify slopes 0-10%, 10-15%, 15-25%, and 25% and greater
- b) Show and quantify areas of disturbance in each slope category
- c) Provide/show specialized site design and construction techniques

Grading and Erosion Control Plan

- a) Topography (2-foot contours)
- b) Limits of disturbance
- c) Pertinent off-site drainage features
- d) Existing and proposed impervious surface tallies

Streetscape Plan, if applicable

- a) Public right-of-way existing conditions plan
- b) Streetscape demolition plan
- c) Streetscape proposed improvement plan
- d) Streetscape proposed utility plan and details
- e) Streetscape proposed pavement/sidewalk details
- f) Streetscape proposed furnishing details
- g) Streetscape proposed lighting details

Solid Waste Plan

- a) Preliminary Solid Waste Management Plan
- b) Existing and proposed dumpster pads
- c) Proposed dumpster pad layout design
- d) Proposed heavy duty pavement locations and pavement construction detail
- e) Preliminary Shared dumpster agreement, if applicable



TOWN OF CHAPEL HILL Planning Department

Construction Management Plan


- a) Construction trailer location
- b) Location of construction personnel parking and construction equipment parking
- c) Location and size of staging and materials storage area
- d) Description of emergency vehicle access to and around project site during construction
- e) Delivery truck routes shown or noted on plan sheets

Energy Management Plan

- a) Description of how project will be 20% more energy efficient than ASHRAE standards
- b) Description of utilization of sustainable forms of energy (Solar, Wind, Hydroelectric, and Biofuels)
- c) Participation in NC GreenPower program
- d) Description of how project will ensure indoor air quality, adequate access to natural lighting, and allow for proposed utilization of sustainable energy
- e) Description of how project will maintain commitment to energy efficiency and reduced carbon footprint over time
- f) Description of how the project's Transportation Management Plan will support efforts to reduce energy consumption as it affects the community

Exterior Elevations

a) An outline of each elevation of the building, including the finished grade along the foundation (height of building measured from mean natural grade)

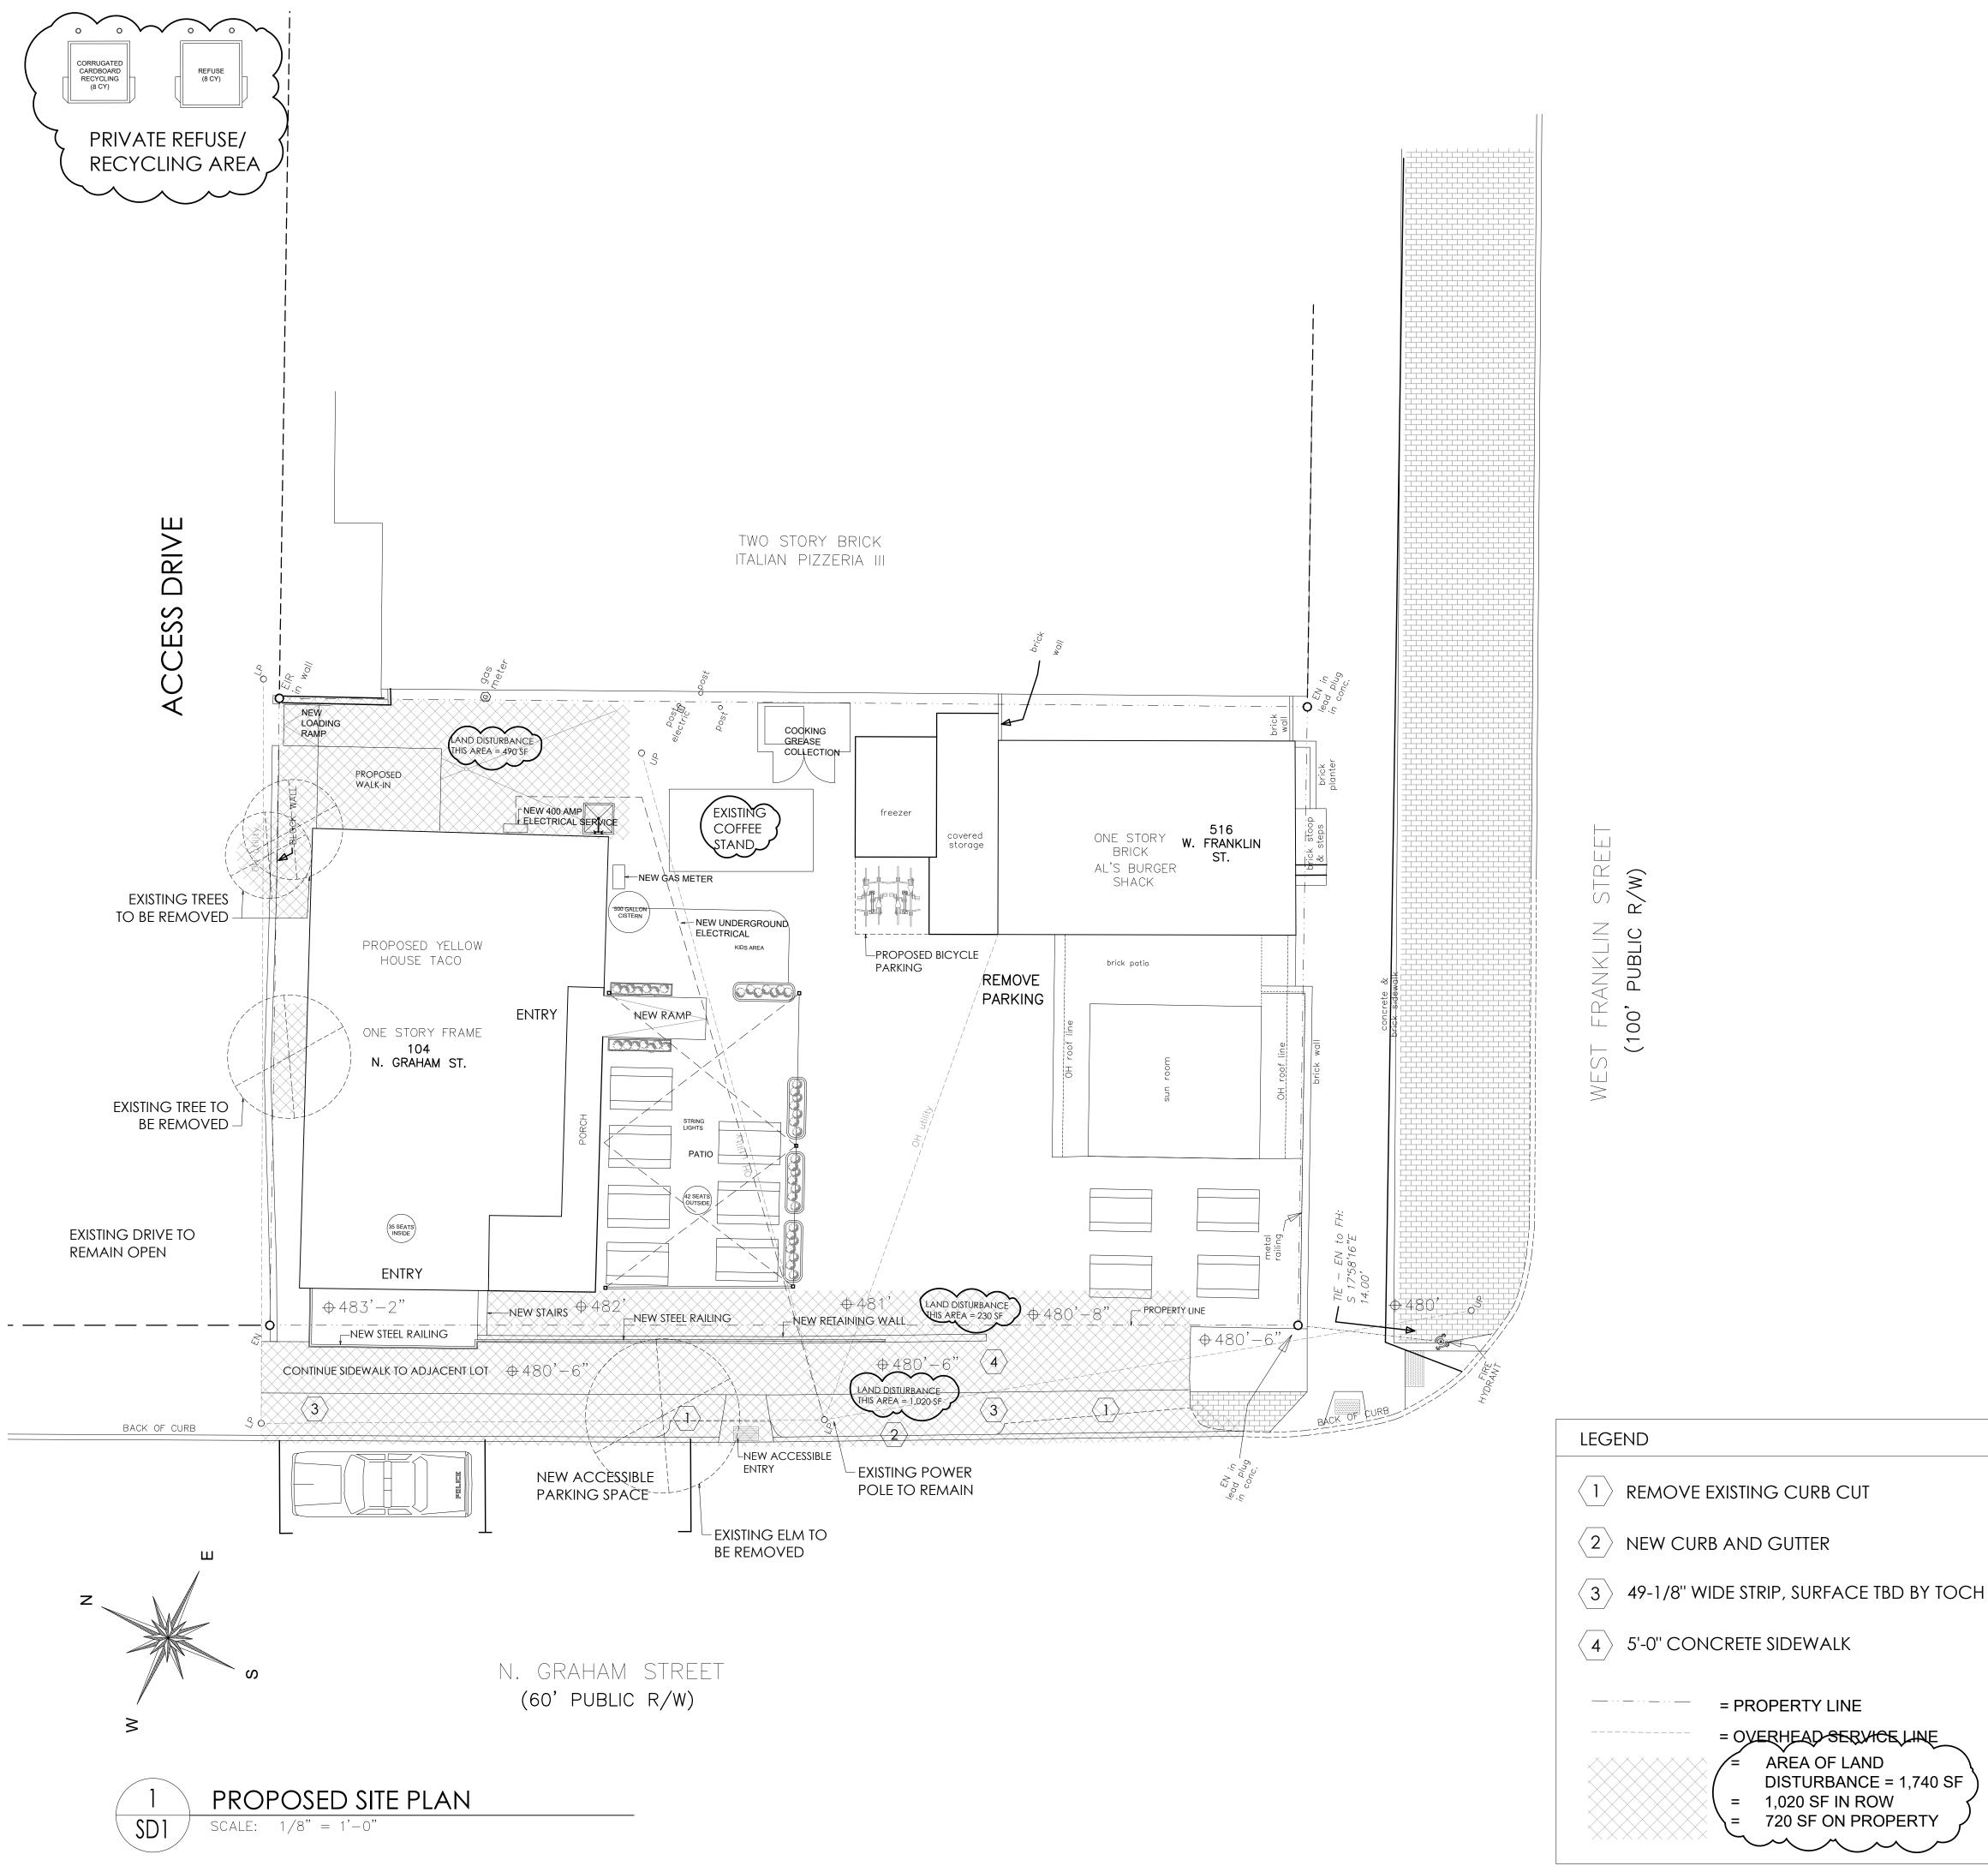

R/W

= PROPERTY LINE

= OVERHEAD SERVICE LINE

DISTURBANCE = 1,740 SF

AREA OF LAND

1,020 SF IN ROW

720 SF ON PROPERTY

GENERAL SITE NOTES


- 1. NORTH WALL OF BUILDING MUST COMPLY WITH APPLICABLE BUILDING AND FIRE CODES.
- 2. OUTDOOR/SIDEWALK DINING PERMIT TO BE ACQUIRED FROM TOWN OF CHAPEL HILL PRIOR TO C.O.
- ORANGE COUNTY HEALTH DEPARTMENT APPROVAL WILL BE OBTAINED PRIOR TO C.O.
- OWASA APPROVAL WILL BE OBTAINED FOR RPZ AND GREASE TRAP INSTALLATIONS WITH PERMITTING.
- ACCESSIBLE ROUTES, PARKING AND SIDEWALKS WILL BE COMPLIANT WITH ICC A 117.1.
- PROPERTY OWNER TO GRADE ALONG N. GRAHAM ST. AND INSTALL RETAINING WALL THAT ACCOMMODATES 5' SIDEWALK SET BACK 49-1/8" FROM BACK OF CURB. ARCHITECT TO COORDINATE CONSTRUCTION OF SIDEWALK WITH TOCH PUBLIC WORKS.
- CONSTRUCTION DETAILS OF RETAINING WALL AND ASSOCIATED RAILING TO BE PROVIDED WITH PERMIT DRAWINGS.
- PER SITE PLAN APPROVAL, ARCHITECT WILL COORDINATE AN ENCROACHMENT AGREEMENT WITH TOCH FOR PRIVATE IMPROVEMENTS WITHIN THE PUBLIC ROW.
- FOUR SPACES OF BICYCLE PARKING WILL BE PROVIDED IN ACCORDANCE WITH LUMO REQUIREMENTS. FIXTURE TYPE DETAIL WILL BE INCLUDED WITH PERMIT DRAWINGS.
- 10. PROHIBITED ILLICIT CONNECTIONS INCLUDE, BUT ARE NOT LIMITED TO: 1) ANY CONNECTION CONVEYING DISHCARGES OF SANITARY SEWERAGE, PROCESS WASTEWATER, DUMPSTER RUNOFF, COOLING OR BOILER WATER. 2) AREA (FLOOR) DRAINS SERVING INTERIOR COVERED SPACES (SUCH AS PARKING DECKS OR GARAGES). 3) SUMP PITS RELATED TO HYDRAULIC OR MECHANICAL EQUIPMENT (ELEVATORS) 4) CHLORINATED WATERS OR SALTWATER FROM
- 11. ANY CONNECTION TO THE TOWN'S STORM DRAINAGE NETWORK THAT IS NOT SHOWN ON THE APPROVED PLAN SET IS NOT APPROVED BY THE STORMWATER MANAGEMENT DIVISION.

POOL DISCHARGE; POOL FILTER BACKWASH.

- 12. OUTDOOR LIGHTS WILL BE WARM LED LIGHTS, NOT TO EXCEED .3 FOOTCANDLES AT PROPERTY LINE.
- 13. NEW CURB AND GUTTER CONSTRUCTION TO BE DONE BY TOCH PUBLIC WORKS. TOCH COMMERCIAL DRIVEWAY DETAIL, NUMBER D-5 TO BE INCLUDED IN PERMIT SET.
- 14. SOLID WASTE, MIXED RECYCLING AND CARDBOARD RECYCLING WILL ALL BE PROVIDED THROUGH A JOINT-USE AGREEMENT WITH THE ADJACENT BUSINESSES AL'S BURGER SHACK AND ITALIAN PIZZERIA III. THESE ARE PRIVATELY HAULED SERVICES AND ARE ACCESSED FROM THE SERVICE DRIVE DIRECTLY TO THE NORTH OF THE SITE.

PUBLIC RECYCLING WAIVER:

- APPLICANT ELECTS TO PROVIDE RECYCLING SERVICES TO RESIDENTS/TENANTS OF THIS PROPERTY IN LIEU OF BUILDING A RECYCLING STATION CONSTRUCTED TO ORANGE COUNTY SPECIFICATIONS. THE SITE WILL NOT RECEIVE PUBLIC RECYCLING COLLECTION NOW OR IN THE FUTURE UNLESS SUCH A RECYCLING STATION IS CONSTRUCTED OR CONTINGENCY FOR SUCH A STATION IS INCLUDED ON THE DEVELOPMENT PLANS.
- APPLICANT MUST REQUIRE AT LEAST THE SAME LEVEL OF SERVICE (CURRENT OR FUTURE) TO ITS RESIDENTS AS THAT PROVIDED BY ORANGE COUNTY.
- COUNTY FEES FOR RECYCLING AND WASTE MANAGEMENT ASSOCIATED WITH THIS PROJECT/PROPERTY WILL NOT BE WAIVED.
- APPLICANT AGREES TO ENTER INTO A SERVICE AGREEMENT WITH A PRIVATE SOLID WASTE/RECYCLING COLLECTION CONTRACTOR THAT IS ACCEPTABLE TO ORANGE COUNTY. FURTHER, THE AGREEMENT SHALL PROVIDE FOR THE COLLECTION AND RECYCLING OF CORRUGATED CARDBOARD IN ADDITION TO THE OTHER CO-MINGLED RECYCYLABLES AND AN EXECUTED COPY OF THE AGREEMENT SHALL BE PROVIDED TO AND APPROVED BY ORANGE COUNTY PRIOR TO APPROVAL OF FINAL CONSTRUCTION PLANS FOR THE PROPERTY/PROJECT.

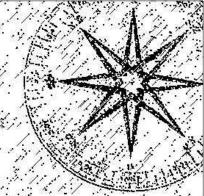

JIM SPENCER ARCHITECTS, PA

109-A BREWER LANE CARRBORO, NC 27510

919.960.6680 o 919.960.6682 f jspencerjsa@gmail.com

Project:

UPFIT FOR:


Yellow House Taco

104 NORTH **GRAHAM STREET**

CHAPEL HILL, NORTH CAROLINA 27516

JIM SPENCER ARCHITECTS, PA AND ARE NSTRUMENTS OF SERVICE AND AS SUCH HALL REMAIN THE PROPERTY OF THE RCHITECT. THEY HAVE BEEN PREPARED FOR A SPECIFIC PROJECT AND SHALL NOT USED IN CONJUNCTION WITH ANY OTHER PROJECT WITHOUT THE PRIOR WRITTEN
PERMISSION OF THE ARCHITECT. ALL

2018 JIM SPENCER ARCHITECTS

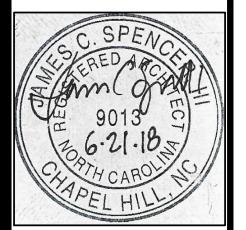


ZONING COMPLIANCE


Job Number:


Drawn	JCS, HLF
Checked	JSA
DATE	JUNE 26, 2018
REVISED:	DEC 18, 2018
	JAN 31, 20 19
	FEBRUARY 6, 2019

Sheet Title:

Sheet Number

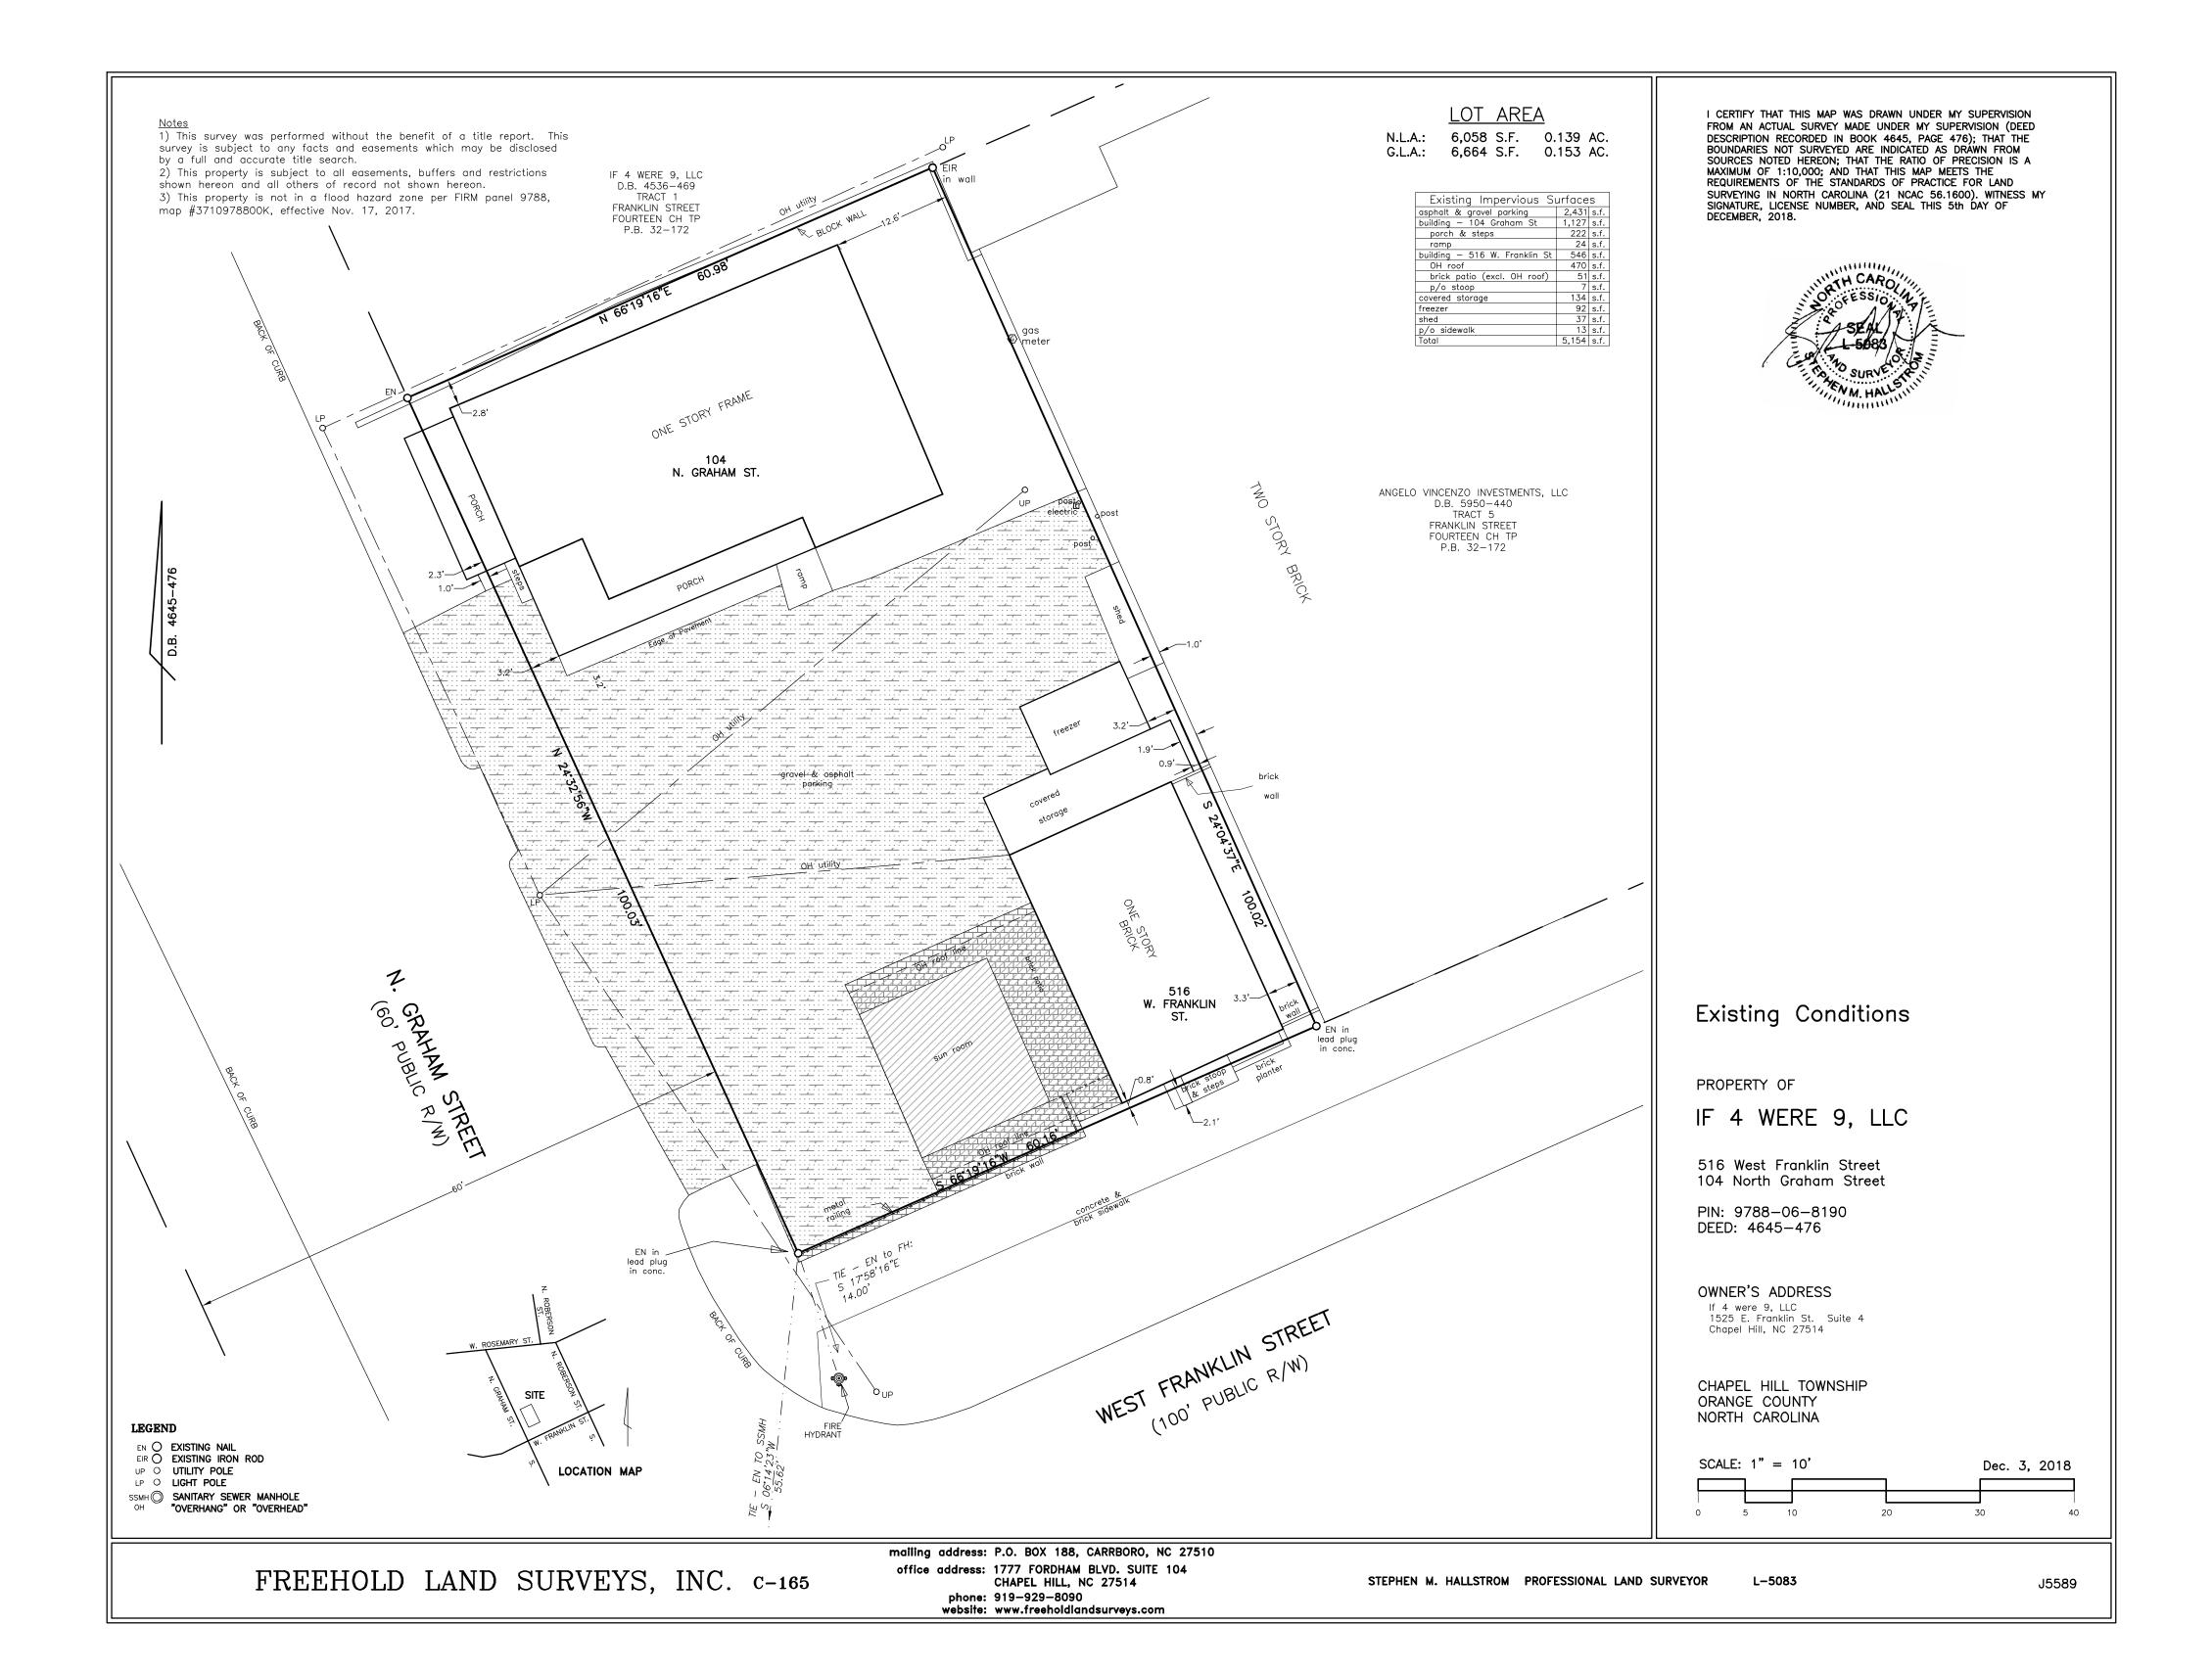

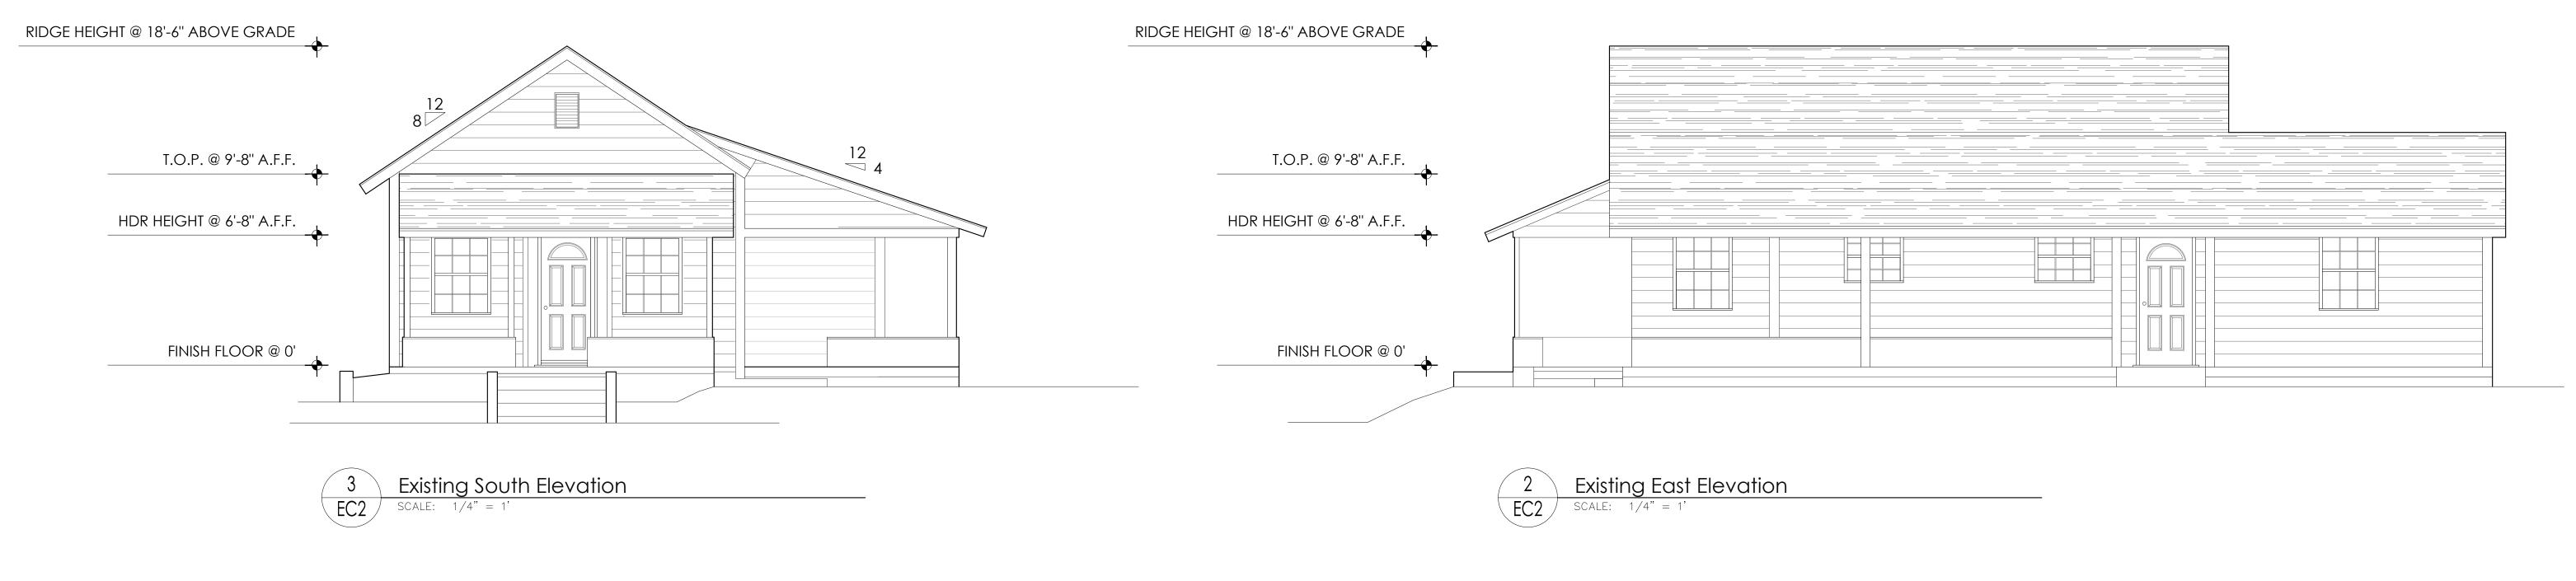

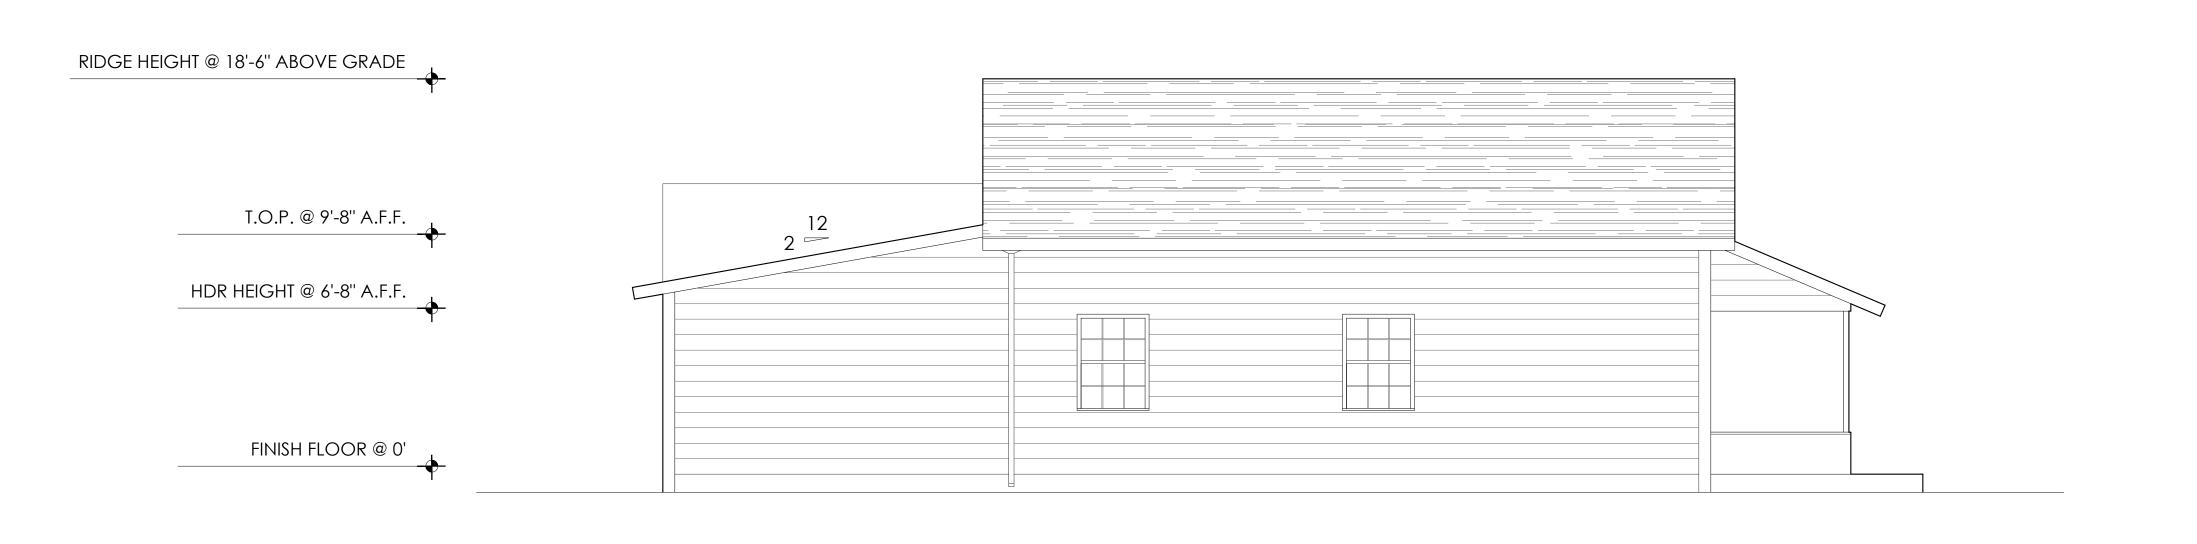

Existing West Elevation

SCALE: 1/4" = 1'

IIM SPENCER

JIM SPENCER ARCHITECTS, PA

109-A BREWER LANE CARRBORO, NC 27510

919.960.6680 o 919.960.6682 f jspencerjsa@gmail.com

Project:

UPFIT FOR:


Yellow House Taco

104 NORTH GRAHAM STREET

CHAPEL HILL, NORTH CAROLINA 27516

THESE DRAWINGS ARE THE PROPERTY OF JIM SPENCER ARCHITECTS, PA AND ARE INSTRUMENTS OF SERVICE AND AS SUCH SHALL REMAIN THE PROPERTY OF THE ARCHITECT. THEY HAVE BEEN PREPARED FOR A SPECIFIC PROJECT AND SHALL NOT BE USED IN CONJUNCTION WITH ANY OTHER PROJECT WITHOUT THE PRIOR WRITTEN PERMISSION OF THE ARCHITECT. ALL RIGHTS RESERVED.

© 2018 JIM SPENCER ARCHITECTS

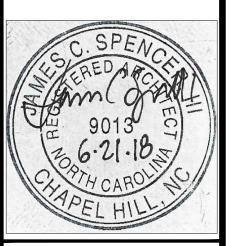

PERMIT PLANS


Job Numbe	Job Number:		
Drawn	JCS, HLF		
Checked	JSA		
DATE	JUNE 26, 201		


ATE JUNE 26, 2018

Sheet Title:

EC2


Sheet Number

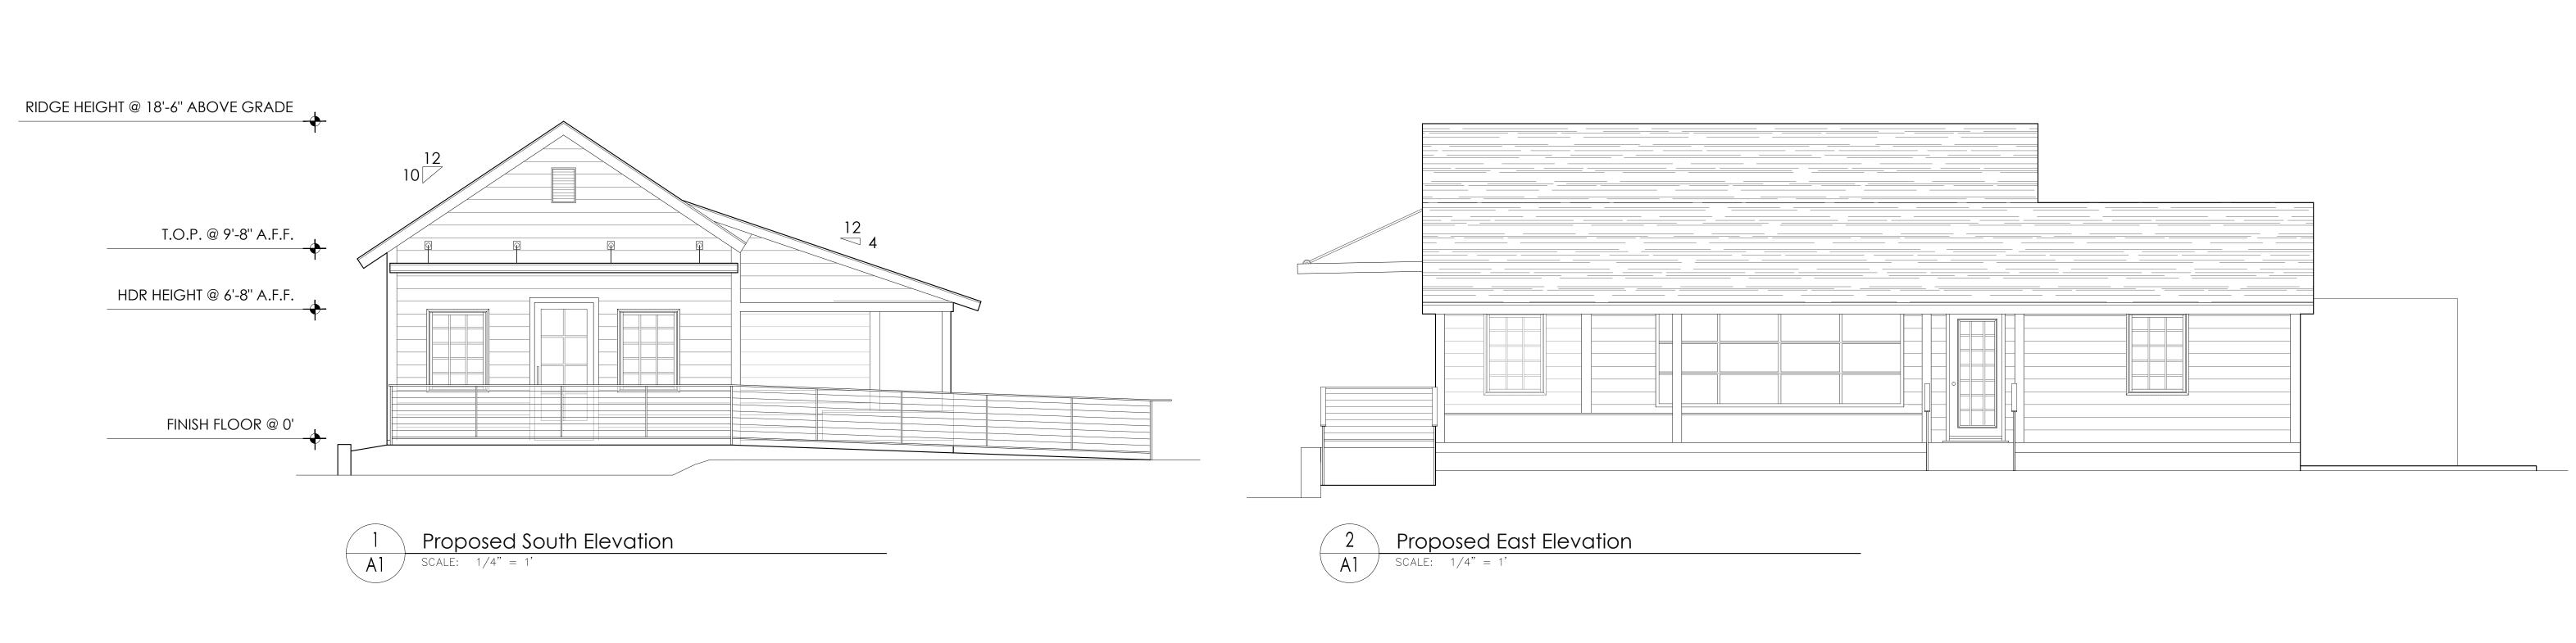

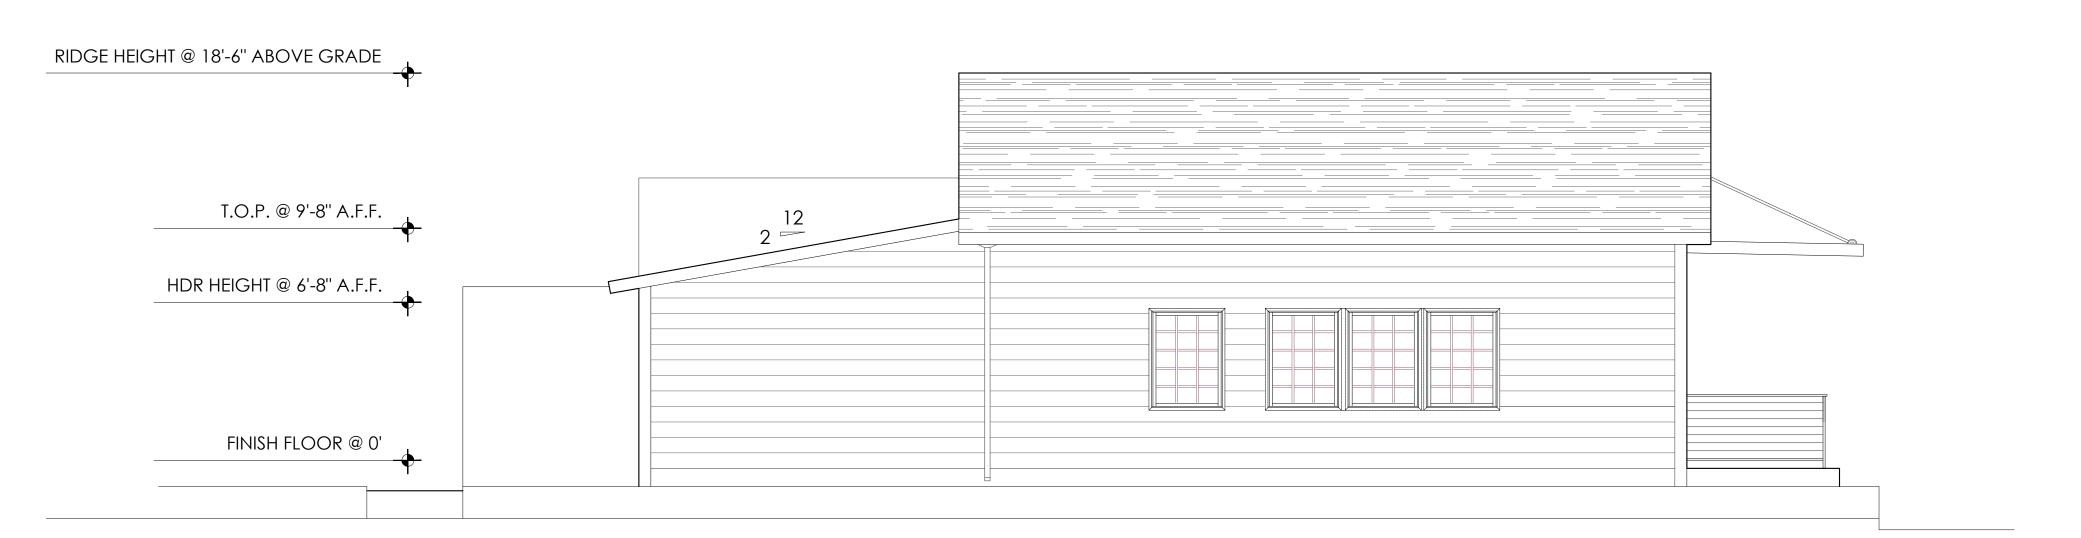

Proposed West Elevation

SCALE: 1/4" = 1'

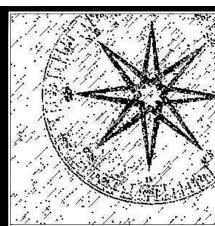

JIM SPENCER ARCHITECTS, PA

109-A BREWER LANE CARRBORO, NC 27510

919.960.6680 o 919.960.6682 f jspencerjsa@gmail.com

Project:

UPFIT FOR:

Yellow House Taco

104 NORTH GRAHAM STREET

CHAPEL HILL, NORTH CAROLINA 27516

THESE DRAWINGS ARE THE PROPERTY OF JIM SPENCER ARCHITECTS, PA AND ARE INSTRUMENTS OF SERVICE AND AS SUCH SHALL REMAIN THE PROPERTY OF THE ARCHITECT. THEY HAVE BEEN PREPARED FOR A SPECIFIC PROJECT AND SHALL NOT BE USED IN CONJUNCTION WITH ANY OTHER PROJECT WITHOUT THE PRIOR WRITTEN PERMISSION OF THE ARCHITECT. ALL RIGHTS RESERVED.

© 2018 JIM SPENCER ARCHITECTS



PERMIT PLANS

Job Number:	
Drawn	JCS, HLF
Checked	JSA
DATE	JUNE 26, 2018

Sheet Title:



Sheet Number



December 13, 2018

SOLID WASTE SHARED USE AGREEMENT

To	Whom	it	May	Concern:
	7 7 1 1 0 1 1 1		1 V 1 CM 9	

The undersigned parties agree to share the use, cost and maintenance of the solid waste (trash) and recycling facilities for the below listed businesses and addresses. See attached diagram for locations and access to facilities.

Al's Burger Shack 516 West Franklin Street PIN# 9788153958
Al Bowers, Owner
Italian Pizzeria III 508 West Franklin Street PIN# 9788069143
Angelo and Vinny Marrone, Owners
If 4 Were 9, LLC Access Drive at 106 North Graham Street PIN# 9788069275
Sammy Martin, Owner



December 13, 2018

SHARED DRIVE ACCESS AGREEMENT

To Whom it May Concern:

The undersigned parties agree to share the use of the access drive indicated on the attached site plan SD-1. This drive will provide access to solid waste, recycling, and grease collection facilities. for See attached diagram for locations and access to facilities.

Al's Burger Shack
516 West Franklin Street PIN# 9788153958
Al Bowers, Owner
Italian Pizzeria III
508 West Franklin Street PIN# 9788069143
Angelo and Vinny Marrone, Owners
If 4 Were 9, LLC
Access Drive at 106 North Graham Street PIN# 9788069275
Sammy Martin, Owner

Yellow House Taco 919-260-6851 104 North Graham Street Chapel Hill, North Carolina 27516

TRANSPORTATION MANAGEMENT PLAN

Title of Building: Yellow House Taco

Yellow House Taco is located at 104 North Graham Street. Building has on-site parking for staff and visitors. The parking is sufficient to meet all daily needs. Note: There is no on-site parking for staff and visitors in this part of downtown Chapel Hill. The corner lot houses Al's Burger Shack and this existing building. Staff will mostly arrive by walking or biking – those that drive will park in nearby town or private lots (see 1.0-B & C below).

The facility is owned by *Yellow House Taco, LLC*. The Transportation Management Plan (TMP) is binding upon the Owner and will be the responsibility of the designated coordinator. The following is the plan.

1.0 Plan Goals

- A. Promote the Town's Transportation policy
- B. Reduce private automobile use
- C. Encourage the use of alternative transportation forms, including public transportation, pedestrian and bicycle use.

2.0 Administration and Reporting

A. Administration

The **Yellow House Taco** will designate an individual to be responsible for administering and reporting our plans and will be designated as the Transportation Coordinator

B. Duties

TMP Champion responsibilities will include:

- Promote participation in the Transportation Management Plan.
- Attend the annual TMP Conference and/or workshops
- Coordinate and carry out any survey provided by the Town of Chapel Hill to evaluate the effectiveness of the TMP
- Analyze the survey results and suggest modifications to the Plan in order to increase its effectiveness.
- Conduct a biennial survey. This survey form (provided by the Town of Chapel Hill), will include employee residence location, current mode of travel to and from work and hours of work
- Offer information to those using the building regarding alternative transportation options.

C. Reporting Date

The TMP Champion will be responsible for preparing and providing the Transportation Report to the Town of Chapel Hill by September 30 of each year (or other deadline agreed upon with the Town of Chapel Hill).

D. Reporting Items

The report will include:

- A description of the Transportation Management Plan and the changes made to the plan within the last year.
- Results from the survey, provided by the Town of Chapel Hill and conducted by the TMP Champion

3.0 PLAN COMPONENTS

Please see attached letter for details.

- A. Provision of information and promotion of alternative transportation methods on a bulletin board. Information includes public transit bus routes and schedules, volunteer ride-sharing contact information.
- B. Provision for bicycle racks at or near the building.
- C. Encouragement of walking to the adjacent buildings and other downtown business needs.
- D. Encouragement of limiting automobile use as much as possible as well as car-pooling.
- E. Offer incentives for employees alternative transportation use.
- F. Have employees register for Go Triangle FREE Emergency Ride Home program.
- G. Provide transit route information to all staff/visitors.

Yellow House Taco agrees to:

- 1. **Appoint a Transportation Management Plan Champion** should be by position, rather than specific person. Name and contact information must be sent to Len Cone, lcone@townofchapelhill.org before the business opens. TMP Champion responsibilities include:
 - a. Attendance of annual Go Chapel Hill TMP Conference
 - b. Conduct Employee and Business Surveys as called for by Town (usually bi-annually)
 - c. Regular employee communication regarding TMP information sent by Town
 - d. Attendance & Support of related TMP Trainings or Information
 - e. Coordinate TMP implementation with tenants or employees.
- 2. Discuss the TMP, annually, with all employees to encourage alternative transportation use.
- 3. Offer other measures such as direct deposit of paychecks, and employee use of company mailroom facilities, bicycles and company car for work related use.
- 4. Make available for employees:
 - a. Offer a flexible work schedule to meet needs of bus schedule.
- 5. Encourage employees and staff to join air quality coalition, bike coalition and/or other related organizations.
 - a. Emergency Ride Home Program Employer Registration
 - b. Share the Ride NC Program
 - c. <u>Best Workplaces for Commuters Program</u>

- 6. Make available bike racks
- 7. Communications:
 - a. Send to all employees in building Go Chapel Hill Newsletters, Promotional Campaigns/Contests, Special Events, Announcements, etc.
 - b. Provide a communication board for posting information from the Town and Go Chapel Hill program related to using alternative transportation such as Carpooling (Rideshare NC) and Bicycling including Maps, Safety Guides, healthy living and other green tips, etc.
 - c. Communicate route, schedule, holiday and changes information regarding:
 - Chapel Hill Transit
 - Go Triangle
 - Go Raleigh
 - Go Durham



December 18, 2018

Town of Chapel Hill Planning Department 405 Martin Luther King Junior Boulevard Chapel Hill, North Carolina 27516

Transportation Management Plan – Yellow House Taco – PIN# 9788153958

Dear Town of Chapel Hill Transportation Management:

We are submitting this narrative as a Transportation Management Plan for Yellow House Taco, a proposed restaurant in an existing building at 104 North Graham Street in Chapel Hill. As you are likely aware, the corner or North Graham and West Franklin Streets has been improved with several restaurants and other businesses in recent years. This particular site is shared with Al's Burger Shack (516 West Franklin) and Tin Cup Joe (coffee stand). Adjacent to the north is a service drive and then Beer Study (bottle shop). Italian Pizzeria III is the business directly to the east. The owners of IP3, Angelo and Vincenzo Marrone are partners in this new restaurant venture with Al Bowers of Al's Burger Shack.

Transportation Management for the Site:

We propose eliminating the accessible parking spot beside Al's, which causes conflict in the lot and is a danger to pedestrians on site. We have proposed and talked with Town staff about moving this space to one of two street spaces directly west of the site, with new sidewalks and accessible ramps (see attached site plan). We propose elimination of the two (vehicular) curb cuts along North Graham as well and will coordinate retaining wall/sidewalk/curb and gutter work with the Town's Public Works department. Other parking for the restaurant will be public (street parking and the town lots across the way on South Graham Street).

We will provide 4 new bicycle parking spaces per the Town's standards on site (see attached site plan). As mentioned above, sidewalk and interior paving and ramps on site will be improved to increase pedestrian access to the businesses. The corner already encourages and provides service to a tremendous amount of walking traffic from both the east and west. Additionally, Chapel Hill transit bus routes J, F, and CW all run adjacent to the site and stop nearby.



Though this is a relatively small project, we believe it greatly enhances Chapel Hill's goals of decreased SOV vehicle use, and increase pedestrian, bus and bicycle use downtown. The addition of locally owned business helps people reduce the travel required to eat and shop local. Many employees and patrons will likely live nearby as well.

Please let us know if you need additional information regarding the project. We have also attached a revised existing conditions site survey, a proposed site plan, and comment responses to other departments for your use. Thanks for your assistance with this project.

Sincerely,

Jim Spencer, AIA, LEED BD+C Jim Spencer Architects, PA