

A-20 EXTEND 24-HOUR VESTIBULE PARTITION AND

FLOOR STRUCTURE ABOVE.

A-26 | SUPPORTED CONCRETE STOOP:

RESPONSIBILITY.

A-22 EXISTING ROOF DRAIN TO REMAIN AS IS.

A-23 QMI DOOR OVERRIDE SWITCH. SEE ELECTRICAL DRAWINGS FOR ADDITIONAL INFORMATION.

BULKHEAD FRAME AND FINISH TO UNDERSIDE OF

A-21 SPANDREL GLASS: OPACI-COAT #3-0770 WARM GREY (FOR USE WITH PPG). SEE SPECIFICATIONS.

A-24 RECESS FOR DIGITAL DISPLAY; SEE DETAILS ON A5.5.3

PLUMBING DRAWINGS FOR ADDITIONAL INFORMATION.

ACCESSIBILITY-COMPLIANT CONTINUOUS PAVING TO PUBLIC R.O.W. REQD. FROM ALL EXITS. BY LANDLORD

A-25 WATER HEATER ON FLOOR PEDESTAL. REFER TO

A-27 SOUTHEAST LEAF TO BE INACTIVE AND DISABLED.

WALL LEGEND

EXISTING WALL

WALL TO REMAIN

CONSTRUCTION TO REMAIN

NEW WALL CONSTRUCTION

NEW 1 HR TENANT DEMISING

EXISTING 1 HR TENANT DEMISING

FLOOR PLAN NOTES

SHEET A2.2 FOR ADDITIONAL INFORMATION)

A-2 POWER DATA FLOOR BOX: REFER TO ELECTRICAL DRAWINGS FOR ADDITIONAL INFORMATION,

A-1 EXISTING STRUCTURAL COLUMN.

ALL INTERIOR WALL PARTITIONS TO BE 'WJ' U.N.O. (SEE

ALL DOOR FRAMES TO HAVE 5" RETURN ON HINGE SIDE

CORE STATES

GROUP

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ARCHITECT OF RECORD

THESE DRAWINGS ARE NOT COMPLETE WITHOUT THE SEPARATE TYPE WRITTEN SPECIFICATIONS MANUAL WHICH ARE PART OF THE CONTRACT DOCUMENTS.

DATE DESCRIPTION

2018.11.26 PERMIT/ BID SET

1 2018.12.14 BID DESIGN CHANGES

PROJECT INFORMATION
PROJECT NO: JPN
DATE: 11/2

PROJECT NO: JPM.25244

DATE: 11/26/2018

PROTOTYPE: 18.3

DRAWN BY: F.MOLINA

CHECKED BY: V.ALVAREZ


VERSION: 1.00

NOTED FLOOR PLAN

SHEET NUMBER

SHEET TITLE

A1.1.1

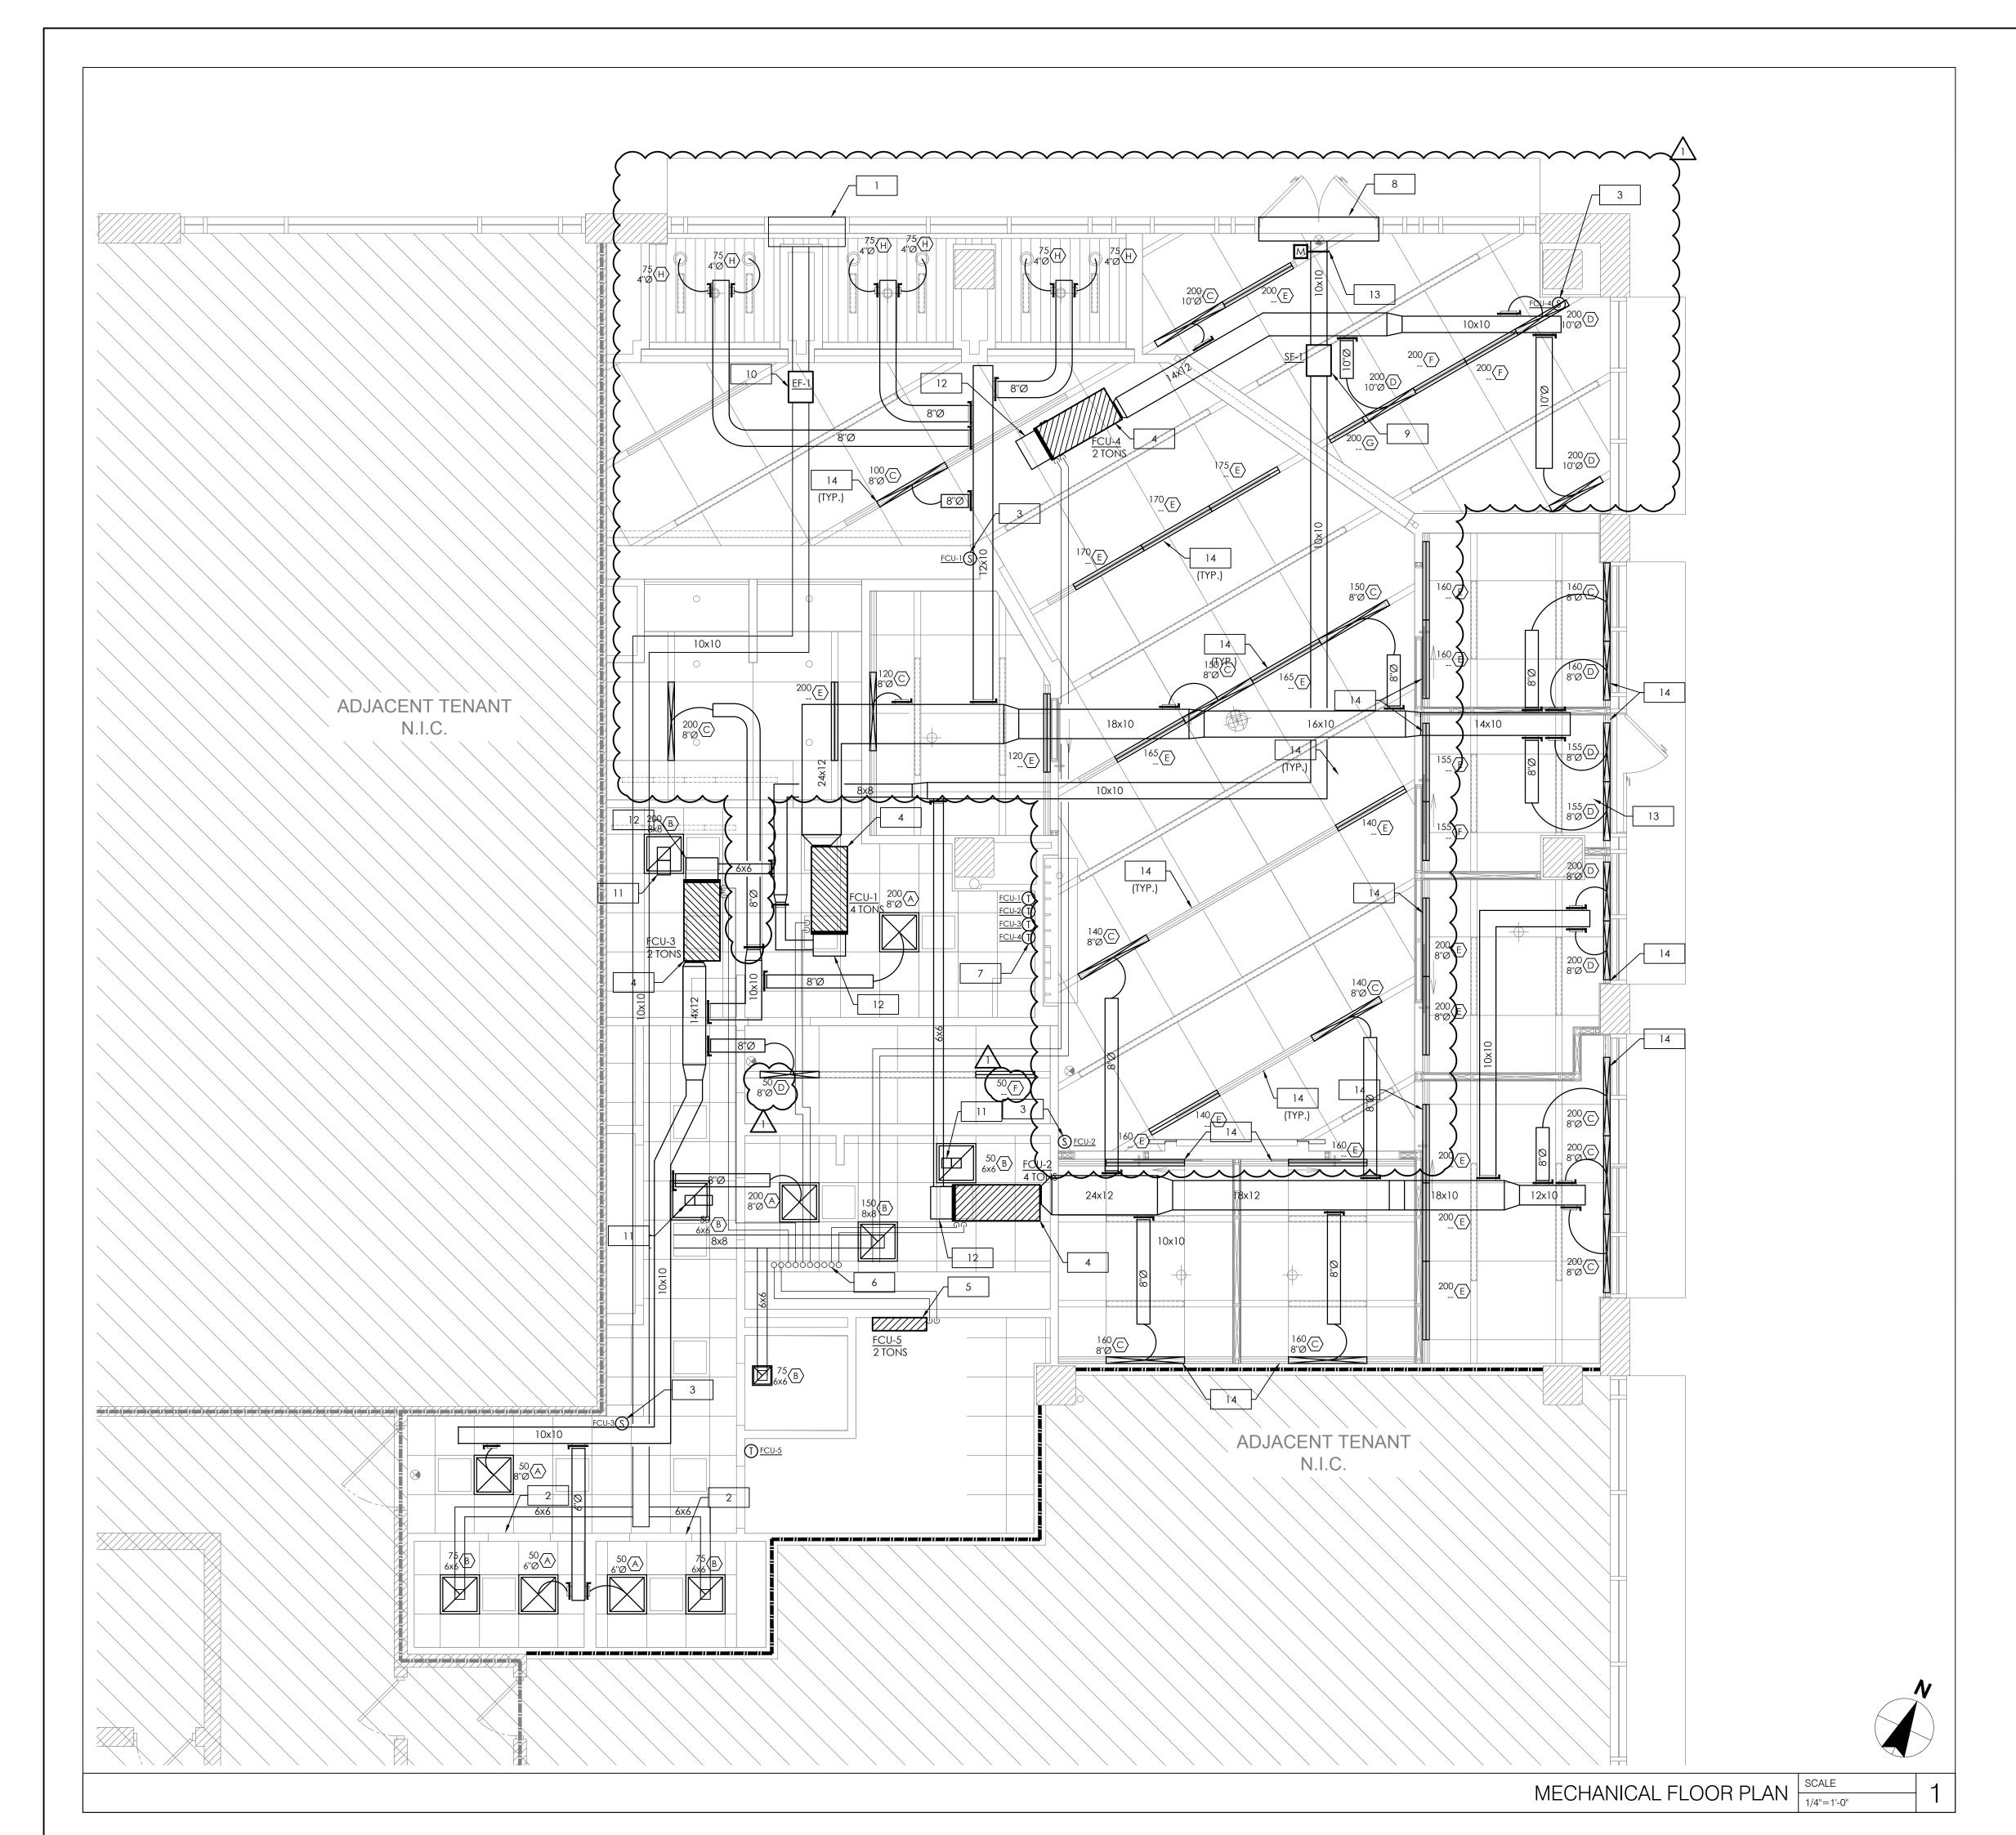

MECHANICAL NOTES:

- 1. CONTRACTOR TO CONNECT NEW 10x10 MINIMUM 24 GAUGE GALVANIZED STEEL EXHAUST DUCT TO DISCHARGE AT NEW LOUVER, SIMILAR TO GREENHECK ESD-635X OR EQUAL. CONNECT TO LOUVER WITH INSULATED PLENUM BOX. COORDINATE INSTALLATION WITH EXISTING CONSTRUCTION.
- 2. PROVIDE 1" DOOR UNDERCUT.
- 3. CONTRACTOR TO INSTALL STANDARD DAINTREE WIRELESS REMOTE TEMPERATURE SENSOR SERVING FCU-1,2,3,4. MOUNT ON WALL 60" ABOVE FINISHED FLOOR AND COORDINATE EXACT LOCATION WITH ARCHITECT/OWNER. REFER TO HVAC CONTROLS TABLE ON SHEET M2.0 FOR ADDITIONAL INFORMATION.
- 4. DUCTED FAN COIL UNIT (FCU-1, FCU-2, FCU-3, & FCU-4) LOCATED JUST ABOVE CEILING. SUSPEND UNIT FROM STRUCTURE. PROVIDE DRAIN PAN AND CONDENSATE PUMP. INSTALL UNIT SUCH THAT ALL MAINTENANCE PANELS ARE IN AN ACCESSIBLE LOCATION. MAINTAIN MANUFACTURER'S CLEARANCE REQUIREMENTS. SEE PLUMBING PLANS FOR CONDENSATE ROUTING. VERIFY ADEQUATE CLEARANCE REQUIREMENTS.
- 5. WALL MOUNTED DUCTLESS FAN COIL UNIT (FCU-5), COORDINATE ACTUAL INSTALLATION LOCATION IN FIELD WITH OWNER, INSTALL CONDENSATE PUMP ON WALL ABOVE DROP CEILING AS CLOSE AS POSSIBLE TO FAN COIL. SEE PLUMBING DRAWINGS FOR CONDENSATE PIPE ROUTING.
- RUN REFRIGERANT SUCTION AND LIQUID LINES IN PROVIDED RISER LOCATION TO REMOTE ROOF MOUNTED CONDENSING UNITS (CU-1, CU-2, CU-3, CU-4, CU-5). ROUTE LINES ABOVE ROOF AS STRAIGHT AS POSSIBLE, PROVIDE WITH MINIMUM 1" THICK INSULATION. CONTRACTOR TO COORDINATE EXACT REFRIGERANT PIPE ROUTING WITH LANDLORD PRIOR TO COMMENCING WORK.
- 7. CONTRACTOR TO INSTALL NEW STANDARD DAINTREE 5-WIRE WIF-FI COMMUNICATING THERMOSTAT. THERMOSTAT SHALL BE WIRED FOR CONTROL OF FCU-1,2,3,4 WITH REMOTE SENSOR INPUT. MOUNT ON WALL 48" ABOVE FINISHED FLOOR AND COORDINATE EXACT LOCATION WITH ARCHITECT/OWNER. REFER TO HVAC CONTROLS TABLE ON SHEET M2.0 FOR ADDITIONAL INFORMATION.
- 8. CONTRACTOR TO CONNECT NEW 10x10 OUTSIDE AIR DUCT TO DISCHARGE AT NEW LOUVER, SIMILAR TO GREENHECK ESD-635X OR SIMILAR. CONNECT TO LOUVER WITH INSULATED PLENUM BOX. COORDINATE INSTALLATION WITH EXISTING CONSTRUCTION.
- PROVIDE AND INSTALL NEW IN-LINE SUPPLY FAN SF-1 IN OUTSIDE AIR DUCTWORK. FIELD VERIFY EXACT LOCATION TO ENSURE NO CONFLICT WITH EQUIPMENT AND ENSURE LOCATION PROVIDES ADEQUATE SPACE FOR SERVICING.
- 10. PROVIDE AND INSTALL NEW IN-LINE EXHAUST FAN EF-1 IN EXHAUST DUCTWORK. FIELD VERIFY EXACT LOCATION TO ENSURE NO CONFLICT WITH EQUIPMENT AND ENSURE LOCATION PROVIDES ADEQUATE SPACE FOR SERVICING.
- FOR SERVICING.

 11. CONTRACTOR TO PROVIDE AND INSTALL SOUND ATTENUATION RETURN BOOT ON RETURN GRILLE. REFER TO DETAIL ON SHEET M3.0 FOR MORE INFORMATION. DUCT SIZE SHALL MATCH SIZE INDICATION ON DIFFUSER
- 12. CONTRACTOR TO PROVIDE AND INSTALL FILTER BOX ON FAN COIL UNIT. EXTEND FULL SIZE RETURN PLENUM AND CONNECT WITH OUTSIDE AIR.
- 13. PROVIDE MOTORIZED DAMPER SIMILAR TO GREENHECK MODEL VCD-40 WITH BELIMO TFB24-S ACTUATOR. INTERLOCK WITH ASSOCIATED FAN TO OPEN WHEN FAN IS INITIATED. SEE SEQUENCE OF OPERATION ON SHEET M2.0 FOR ADDITIONAL INFORMATION.
- 14. CONTRACTOR TO PROVIDE AND INSTALL FULL-LENGTH LINEAR SLOT DIFFUSER. PROVIDE PLENUM BOX FOR ACTIVE SECTIONS SHOWN ON PLANS. INSTALL BLANK-OFF PLATES ON ALL UNUSED SECTIONS OF LINEAR SLOT DIFFUSER.





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PROJECT INFORMATION

PROJECT NO: JPM.25244

DATE: 11/26/2018

PROTOTYPE: 18.3

DRAWN BY: M. LAFFERTY

CHECKED BY: S. VAZ

MECHANICAL


FLOOR PLAN

SHEET NUMBER

M1.0

D1 EXISTING METAL PANEL TO BE REMOVED. PREPARE OPENING FOR NEW LOUVER. STOREFRONT FRAMING TO REMAIN AS IS.



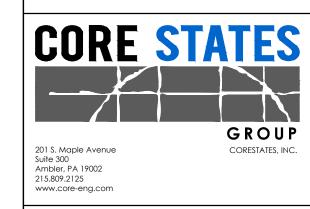

ARCHITECT OF RECORD



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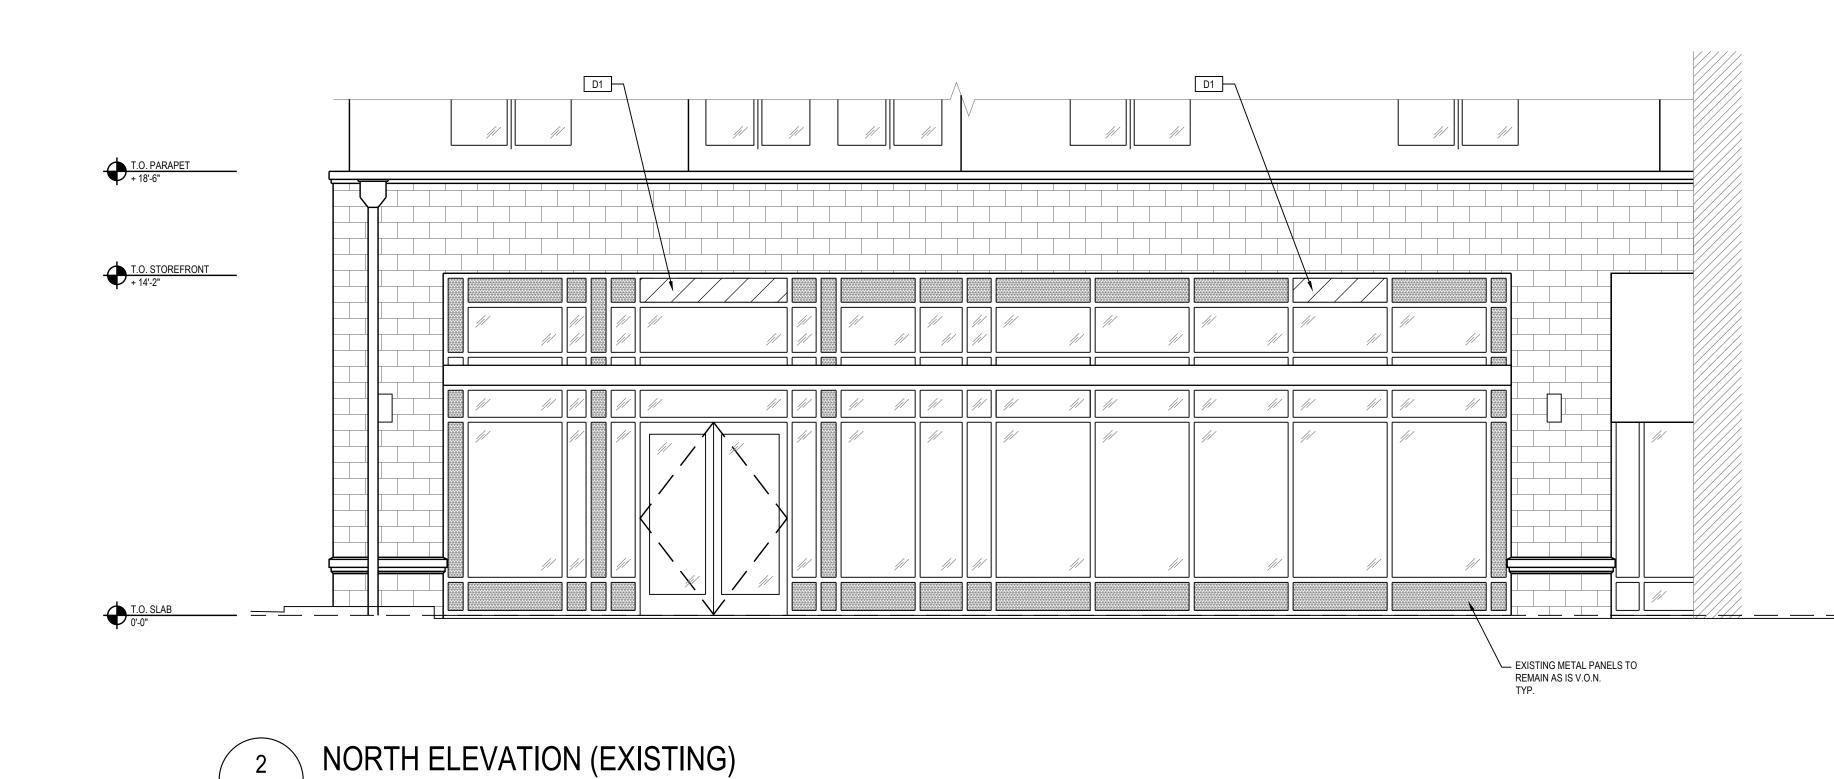
ISSUE	DATE	DESCRIPTION

PRO.	JECT INFO	ORMATION	
PRO	OJECT NO:		JPM.25244
DA	TE:		12/27/2018
PRO	OTOTYPE:		18.3
DR.	AWN BY:		A. KLINKE
CH	ECKED BY:		V.ALVAREZ
VE	rsion:		1.00
SHEET	TITLE		
			·

EXISTING ELEVATIONS

SHEET NUMBER

D.1





1 EAST ELEVATION (EXSTING TO REMAIN AS IS)

D.1 1/4" = 1'-0"

hase\Chapel Hill, NC (133 W Franklin)-JPM.25244\AMBS_Drawings\Archive\CDC Submittal 12.28.2018\D2.1_CHAPEL HILL, NC_JI r 28, 2018 8:56:29 AM

DEMO KEYNOTES

E1 NEW LOUVER. SIMILAR TO GREENHECK ESD-635X OR EQUAL. REFER TO MECHANICAL DRAWINGS





ARCHITECT OF RECORD




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PRO	IECT INIEC	DRMATION!


PROJECT INFORMATION	
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PROTOTYPE:	18.3
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CHECKED BY:	V.ALVAREZ
VERSION:	1.00
SHEET TITLE	

PROPOSED ELEVATIONS

SHEET NUMBER



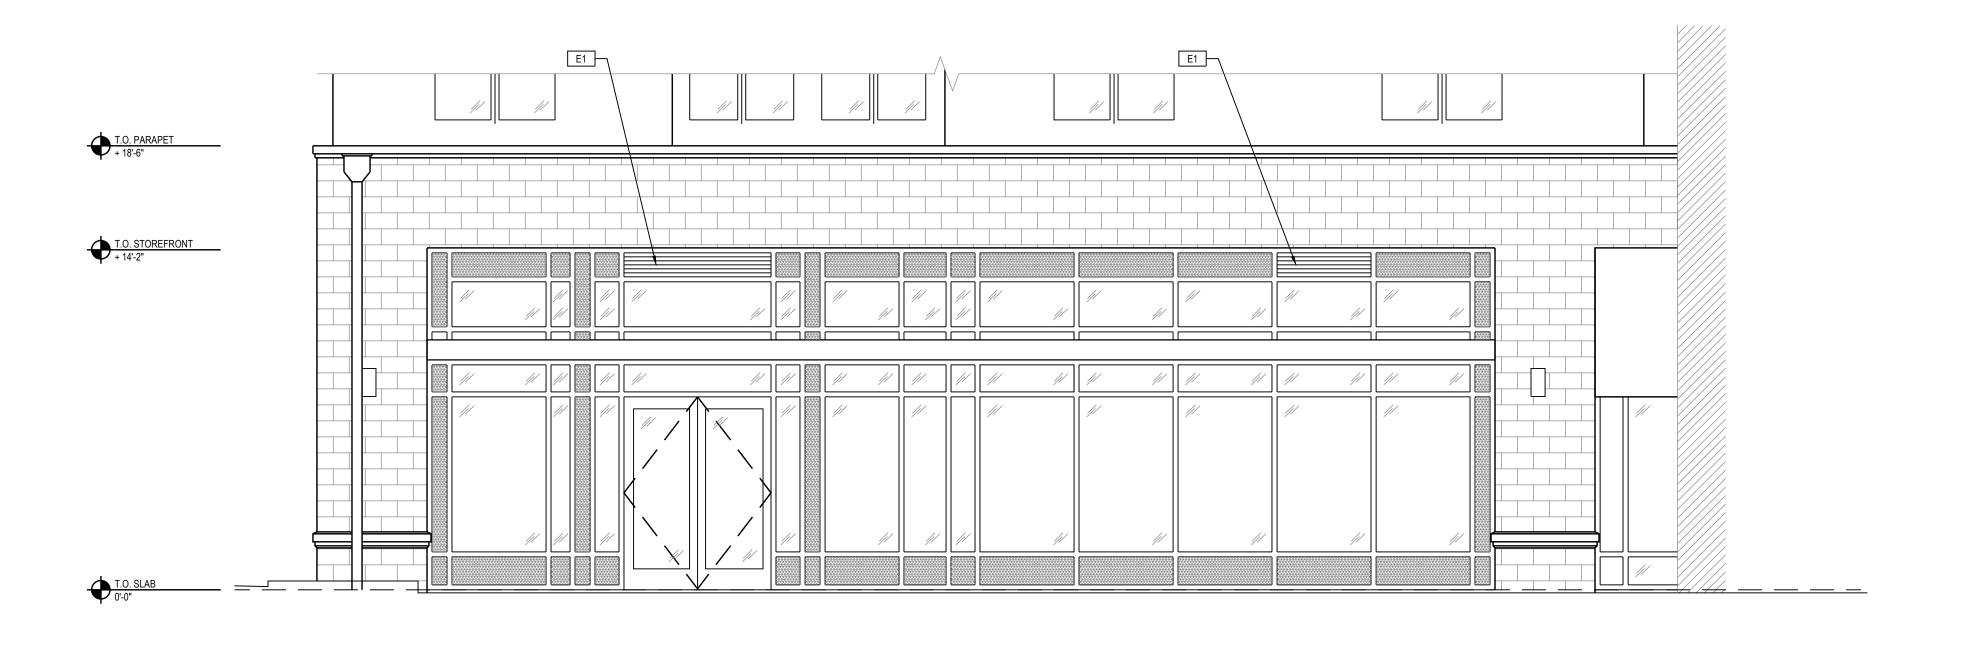

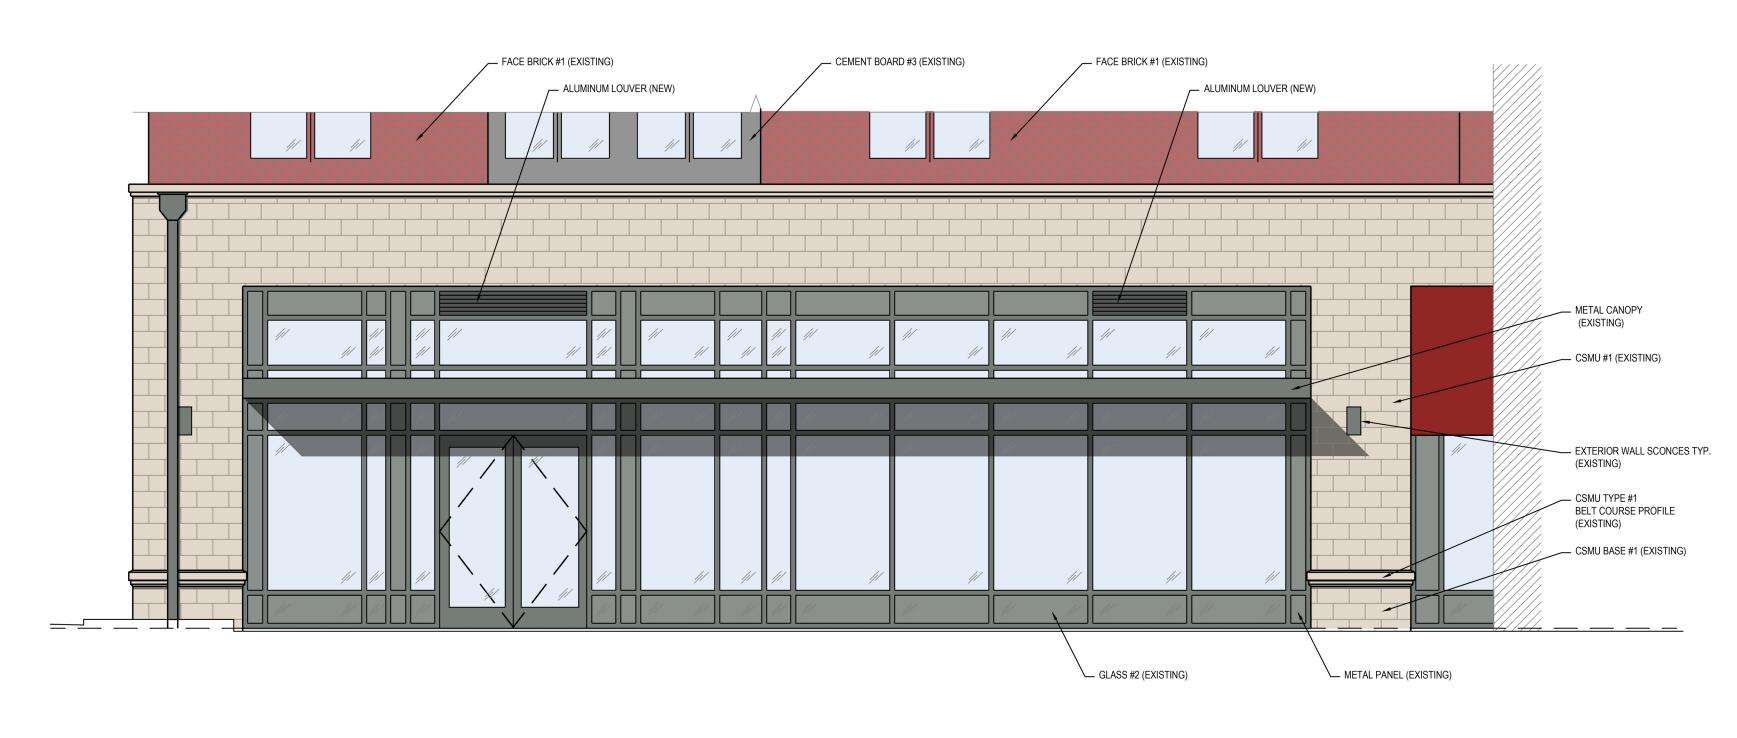

NORTH ELEVATION (PROPOSED)

A2.1 //4" = 1'-0"

FACE BRICK #1 LEE #60 PINEHURST MORTAR: COOSA FROSTY



CSMU #1 SANDCASTLE MORTAR: COOSA ANTIQUE BUFF



CEMENT BRD PAINT #3 BM 979 STAMPEDE



GLASS #2 PAINTED ALUMINUM WINDOW WALL WITH PPG SOLARBAN 72 CLEAR GLASS



ALUMINUM LOUVER GREENHECK ESD-635X OR EQUAL

1. MATERIALS SPECIFIED FOR AVAILABILITY OR APPROVED

EQUAL 2. REFER TO MATERIAL MANUFACTURER SAMPLER FOR ACTUAL TEXTURE AND FINISH



GROUP

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ISSUE DATE DESCRIPTION

PROJECT INFORMATION PROJECT NO: JPM.25244 12/27/2018 PROTOTYPE: A. KLINKE DRAWN BY: CHECKED BY: V.ALVAREZ VERSION: SHEET TITLE

> PROPOSED COLORED **ELEVATIONS**

SHEET NUMBER

A2.1