THE OAKS CONDOMNUMS

SPECIAL USE PERMIT PLANS

LOCATED AT THE INTERSECTION OF BURNING TREE DRIVE & NC 54 (RALEIGH ROAD) PROJECT NUMBER: CAS-10000

DATE: JULY 24, 2018

OWNER:

CAS, INC.

5915 FARRINGTON ROAD, SUITE 104 CHAPEL HILL, NORTH CAROLINA 27517 CONTACT: ED BEDFORD

PHONE: (919) 403-1400 EMAIL: edbedford@casnc.com

SHEET INDEX

EXISTING CONDITIONS AND DEMOLITION PLAN

SITE GRADING AND STORM DRAINAGE PLAN **C-2** EROSION CONTROL PLAN

P-1 PLAN & PROFILE - STORM OUTFALL "A"

D-1 SITE DETAILS


D-2 STORM DRAINAGE DETAILS

D-3 **EROSION CONTROL DETAILS**

OVERALL LANDSCAPE PLAN

LS-2 LANDSCAPE PLAN AREA 'A'

LANDSCAPE PLAN AREA 'B'

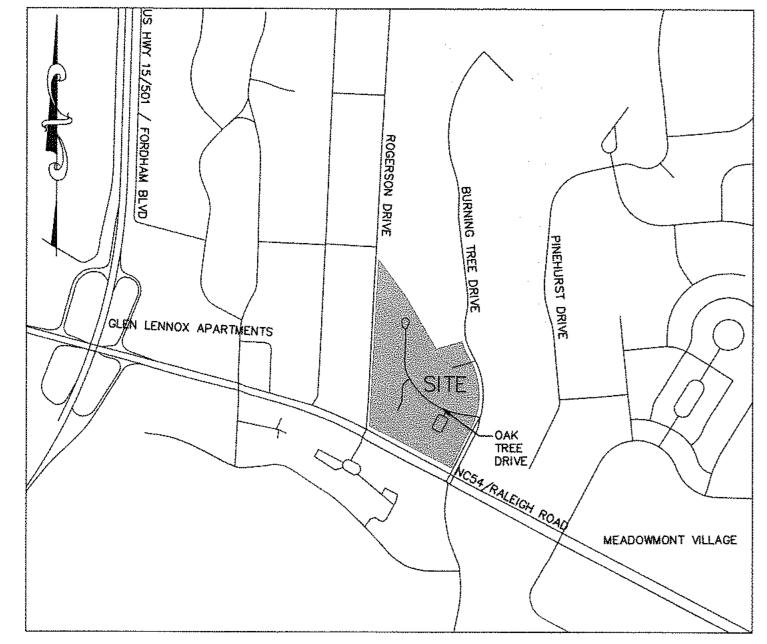

VICINITY MAP NTS



CONTRACTOR SHALL NOTIFY "NC811" (811) OR (1-800-632-4949) AT LEAST 3 FULL BUSINESS DAYS PRIOR TO BEGINNING CONSTRUCTION CONTRACTOR SHALL CONTACT ANY LOCAL UTILITIES THAT PROVIDE THEIR OWN LOCATOR SERVICES INDEPENDENT OF "NC811". REPORT ANY DISCREPANCIES TO THE ENGINEER IMMEDIATELY






THE JOHN R. McADAMS COMPANY, INC.


2905 Meridian Parkway Durham, North Carolina 27713 License No.: C-0293 MCADAMS

(800) 733-5646 McAdamsCo.com

Contact: D. Amos Clark DE clark@mcadamsco.com

FINAL DRAWING - NOT RELEASED FOR CONSTRUCTIO

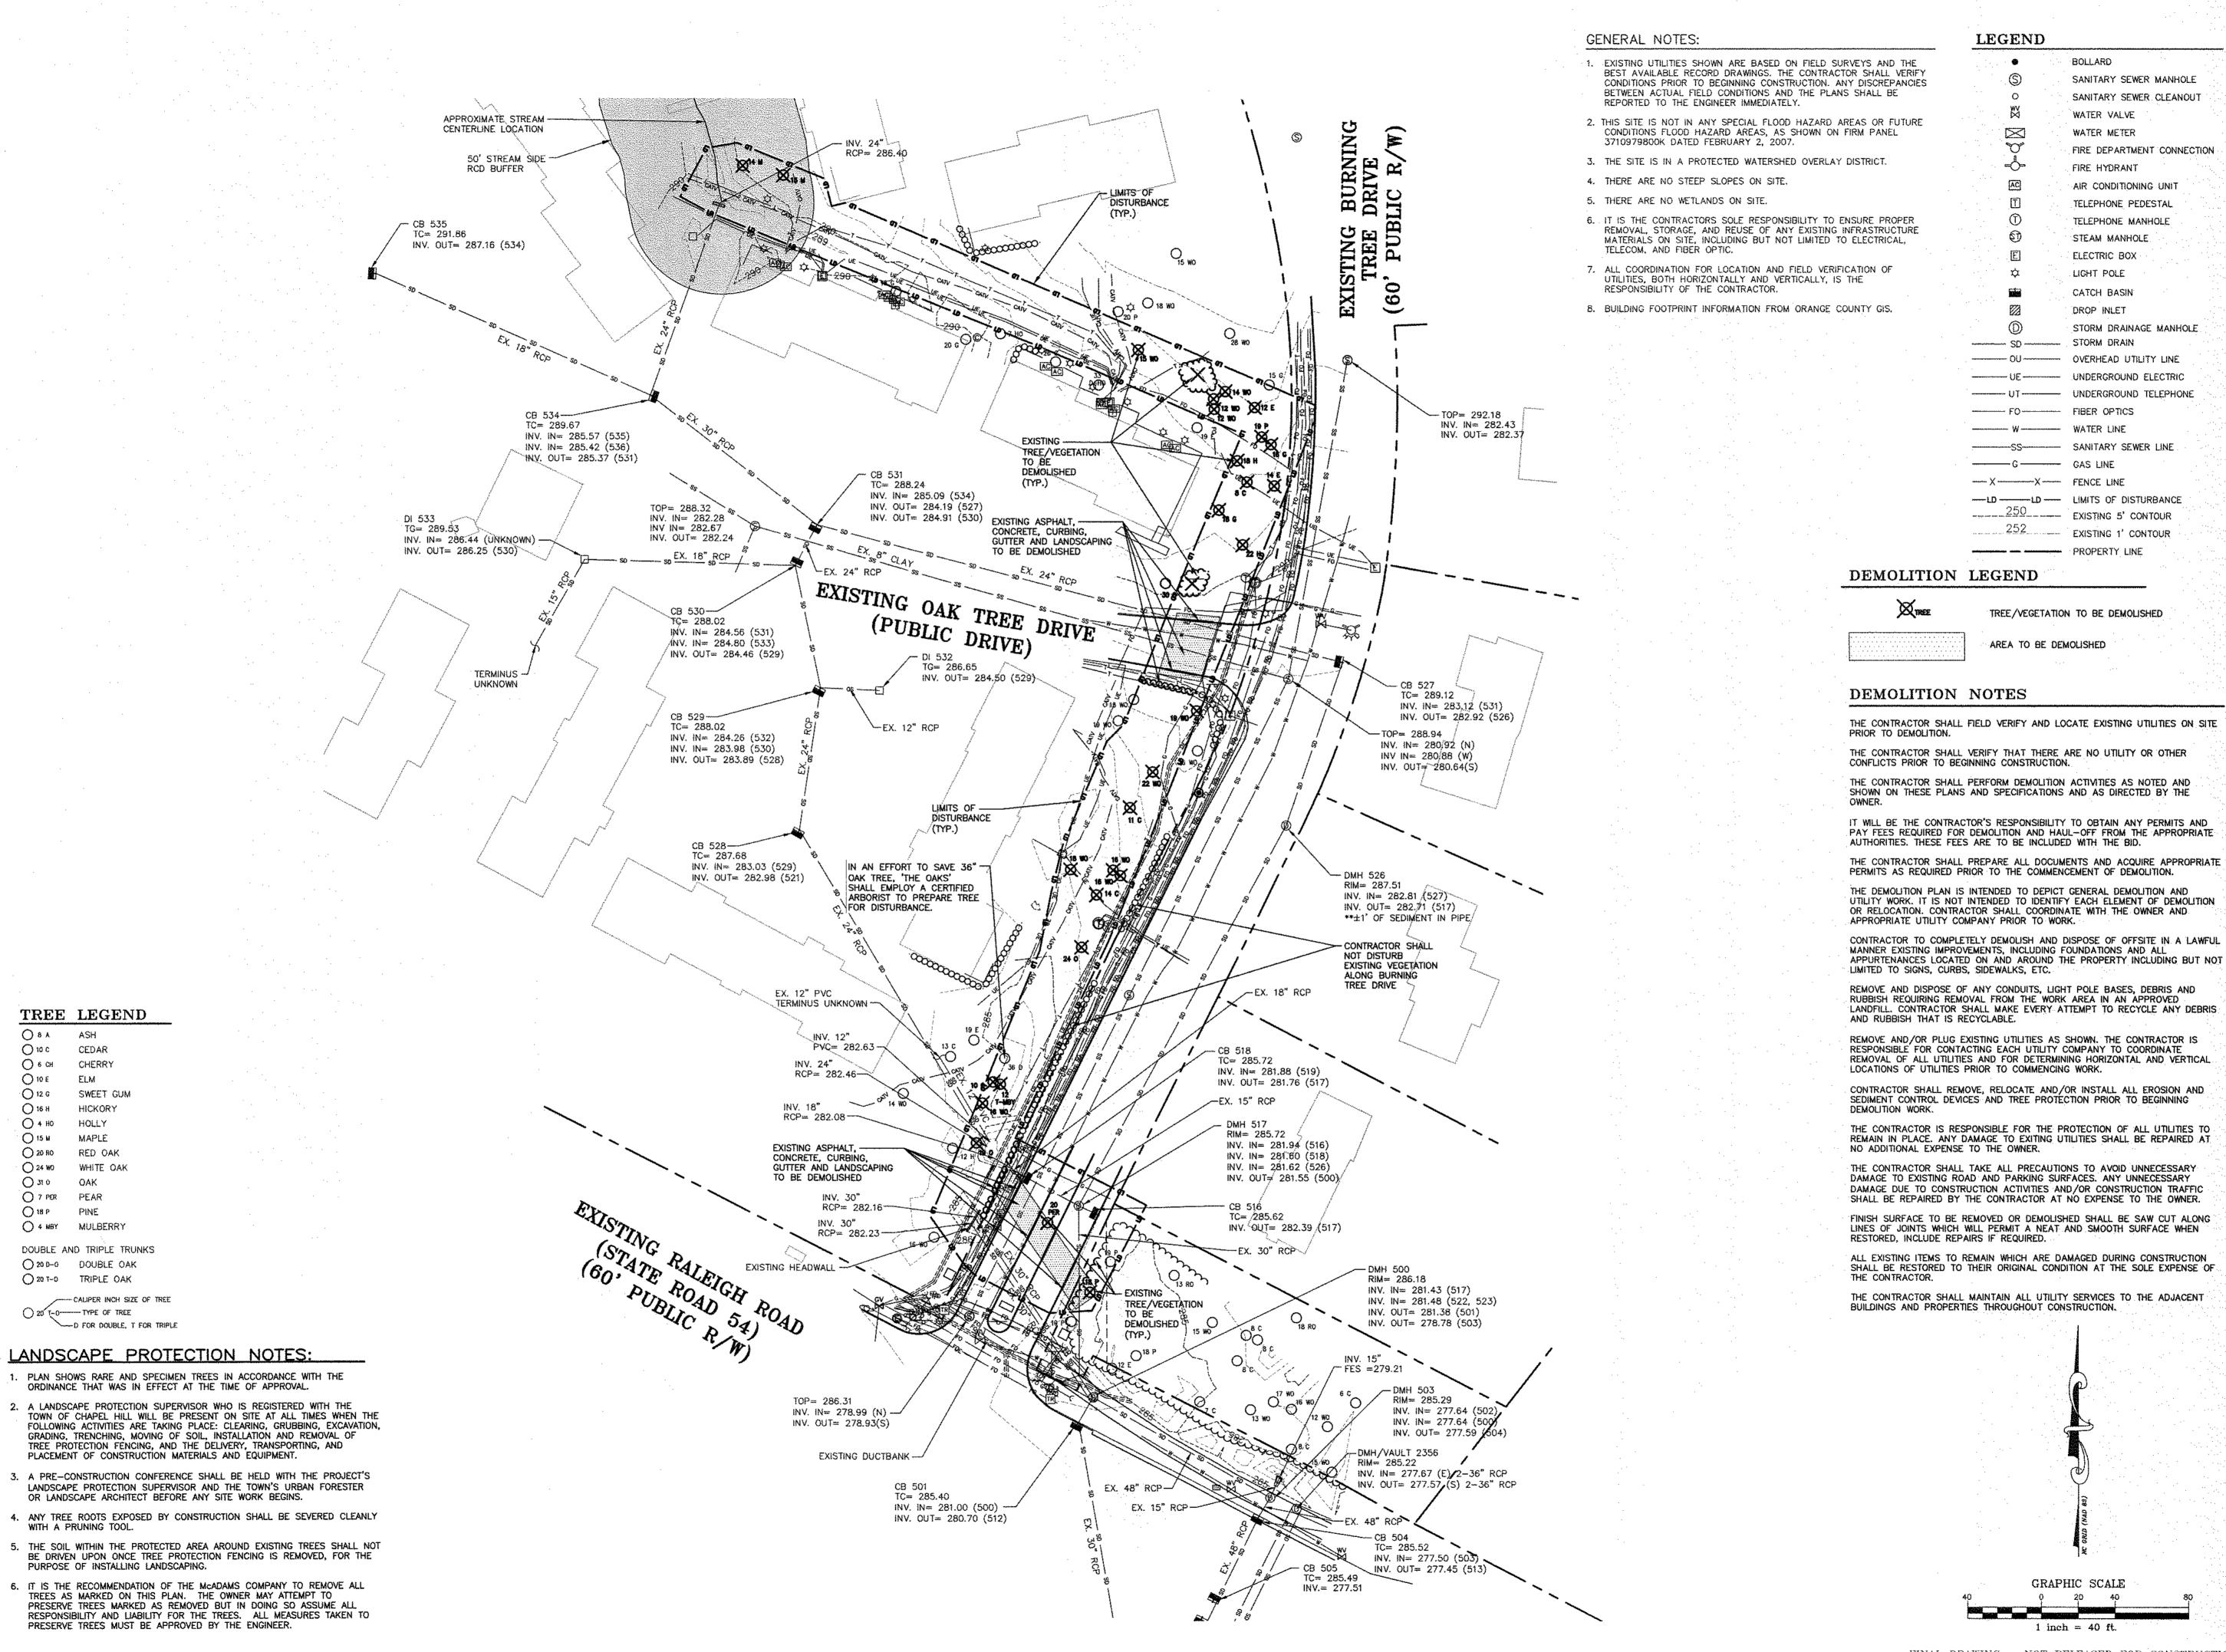

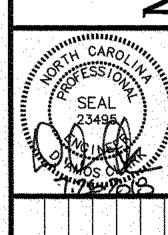

ORP ON RO

MINIO


ONO

DIECT NO. CAS-10000 TIENAME: CAS10000-X

CHECKED BA: DAC DRAWN BY: SMP/NB 1" = 40'07-24-2018

UMCADAMS

FINAL DRAWING - NOT RELEASED FOR CONSTRUCTION

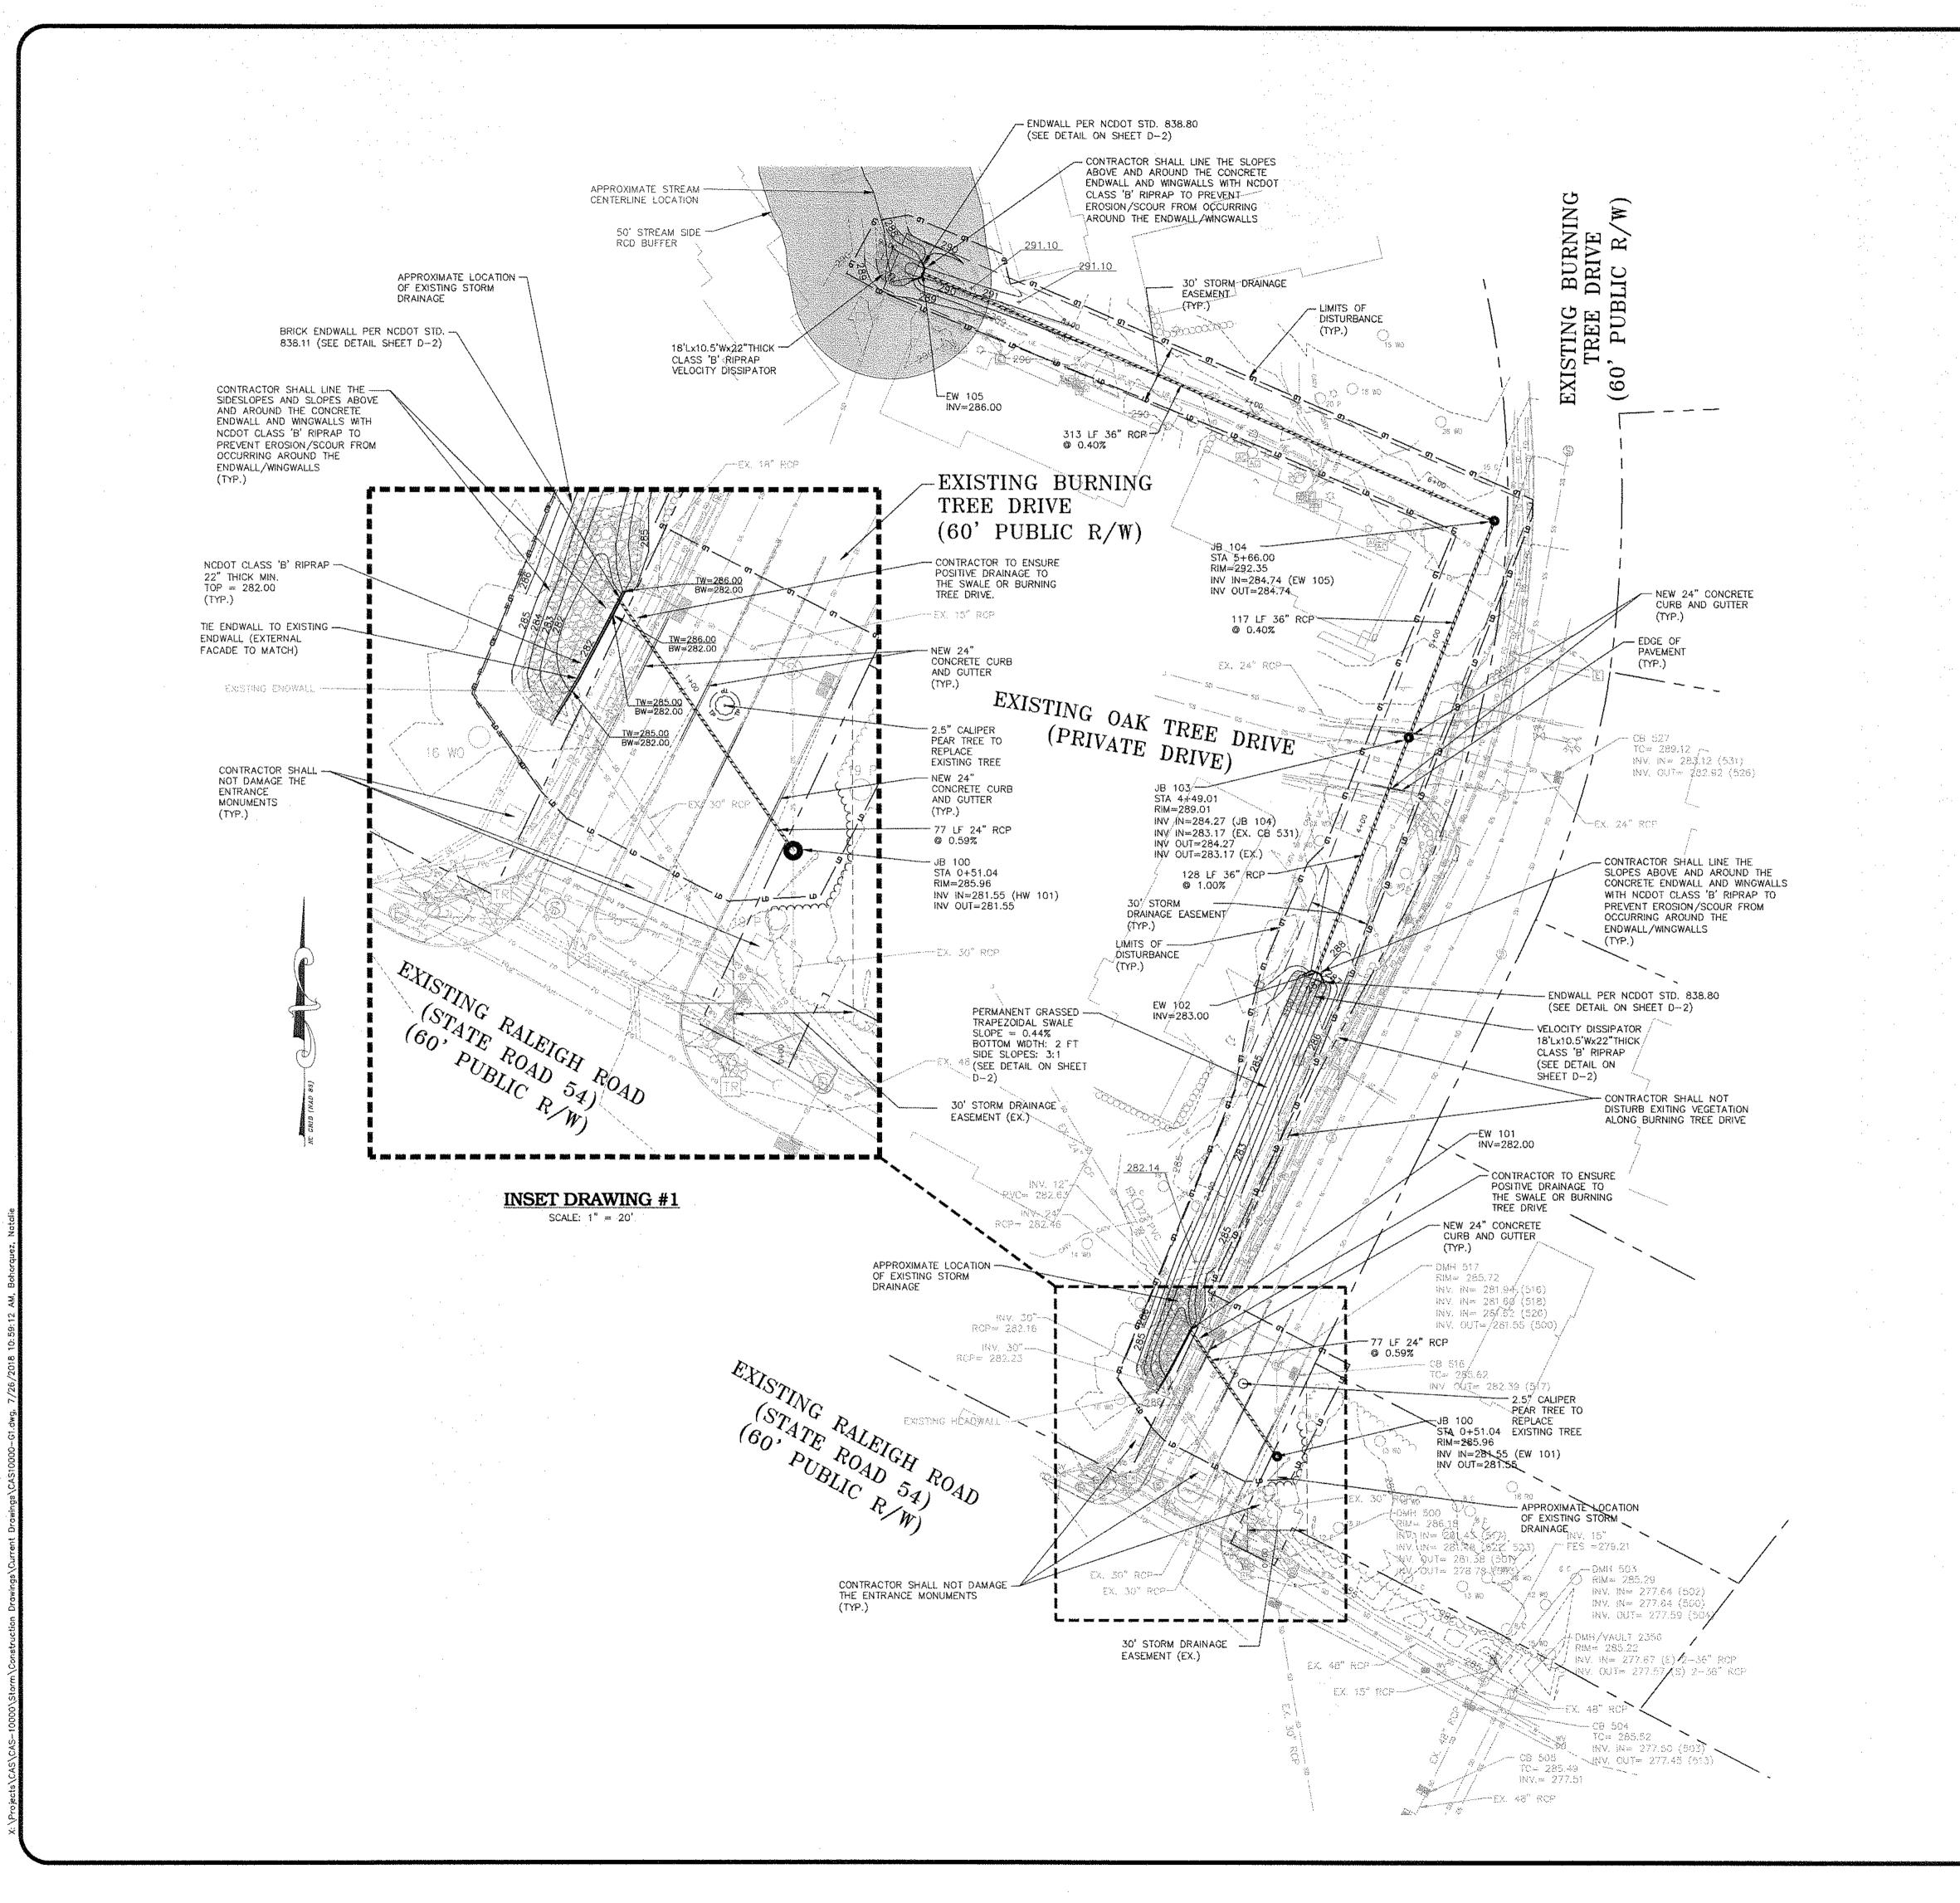


GRADING/STORM DRAINAGE NOTES:

- 1. IT IS THE CONTRACTOR'S SOLE RESPONSIBILITY TO ENSURE PROPER REMOVAL. STORAGE, AND REUSE OF ANY EXISTING INFRASTRUCTURE MATERIALS ON SITE, INCLUDING BUT NOT LIMITED TO ELECTRICAL, TELECOM, FIBER OPTIC, AND IRRIGATION.
- 2. ALL COORDINATION FOR LOCATION AND FIELD VERIFICATION OF UTILITIES IS THE RESPONSIBILITY OF THE CONTRACTOR.
- 3. ALL COORDINATION WITH APPLICABLE UTILITY OWNERS FOR RELOCATION (I.E. NATURAL GAS, FIBER OPTIC, ETC.), DUE TO CONFLICTS WITH PROPOSED CONSTRUCTION IS THE RESPONSIBILITY OF THE CONTRACTOR AT NO ADDITIONAL EXPENSE TO THE OWNER.
- 4. CONTRACTOR IS RESPONSIBLE FOR A TRAFFIC DIVERSION AND CONTROL PLAN.
 CONTRACTOR IS RESPONSIBLE FOR COORDINATING ALL TRAFFIC DIVERSION AND CONTROL MEASURES WITH THE HOA AND THE TOWN.
- 5. CONTRACTOR IS RESPONSIBLE FOR ENSURING NO SEDIMENT SHALL LEAVE THE SITE WHILE PAYING STRICT ADHERENCE TO THE EROSION CONTROL PLAN. ADDITIONAL MEASURES MAY NEED TO BE PLACED TO ENSURE NO SEDIMENT LADEN RUNOFF EXITS THE SITE AT NO ADDITIONAL EXPENSE TO THE OWNER,
- 6. THE CONTRACTOR IS RESPONSIBLE FOR HIRING AN ON-SITE GEOTECHNICAL ENGINEER AS PART OF THE PROJECT. THE ON-SITE GEOTECHNICAL ENGINEER SHALL BE A SUB TO THE CONTRACTOR AND PROVIDE FIELD TESTING REPORTS. AND CERTIFICATIONS FOR ALL GEOTECHNICAL, BEDDING, COMPACTION, AND PAVEMENT ASPECTS OF THE PROJECT.
- 7. THE ON-SITE GEOTECHNICAL ENGINEER IS RESPONSIBLE FOR ENSURING AND CERTIFYING THAT THE BEDDING AND BACKFILL CONDITIONS FOR THE PROPOSED CULVERT AND HEADWALLS ARE ADEQUATELY TESTED AT AN APPROPRIATE FREQUENCY.
- 8. THE CONTRACTOR SHALL REPLACE ALL DISTURBED SUBGRADE AND PAVEMENT PER THE TOWN OF CHAPEL HILL DETAIL SHOWN ON SHEET D-1 UNLESS DIRECTED OTHERWISE BY THE ON-SITE GEOTECHNICAL ENGINEER.
- 9. THE CONTRACTOR IS RESPONSIBLE FOR FOLLOWING ALL APPLICABLE OSHA REQUIREMENTS DURING THE PROJECT, INCLUDING BUT NOT LIMITED TO BARRICADES, EXCAVATIONS, TRENCH SHORING, CONFINED SPACE ENTRY, MATERIALS HANDLING, PERSONAL PROTECTIVE EQUIPMENT, AND EMERGENCY
- 10. ALL JUNCTION BOXES TO BE 4' DIAMETER.

STORM DRAINAGE LEGEND

HEADWALL JUNCTION BOX STORM DRAINAGE STORM DRAINAGE EASEMENT -----------------------EXISTING 1' CONTOUR PROPERTY LINE



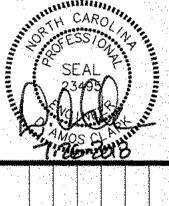


ECT NO. CAS-10000 TLENAME: CAS10000-C нескей ву: DAC DRAWN BY: SMP/NB AS NOTED

07-24-2018

벨MCADAMS

FINAL DRAWING - NOT RELEASED FOR CONSTRUCTION

1 inch = 40 ft.

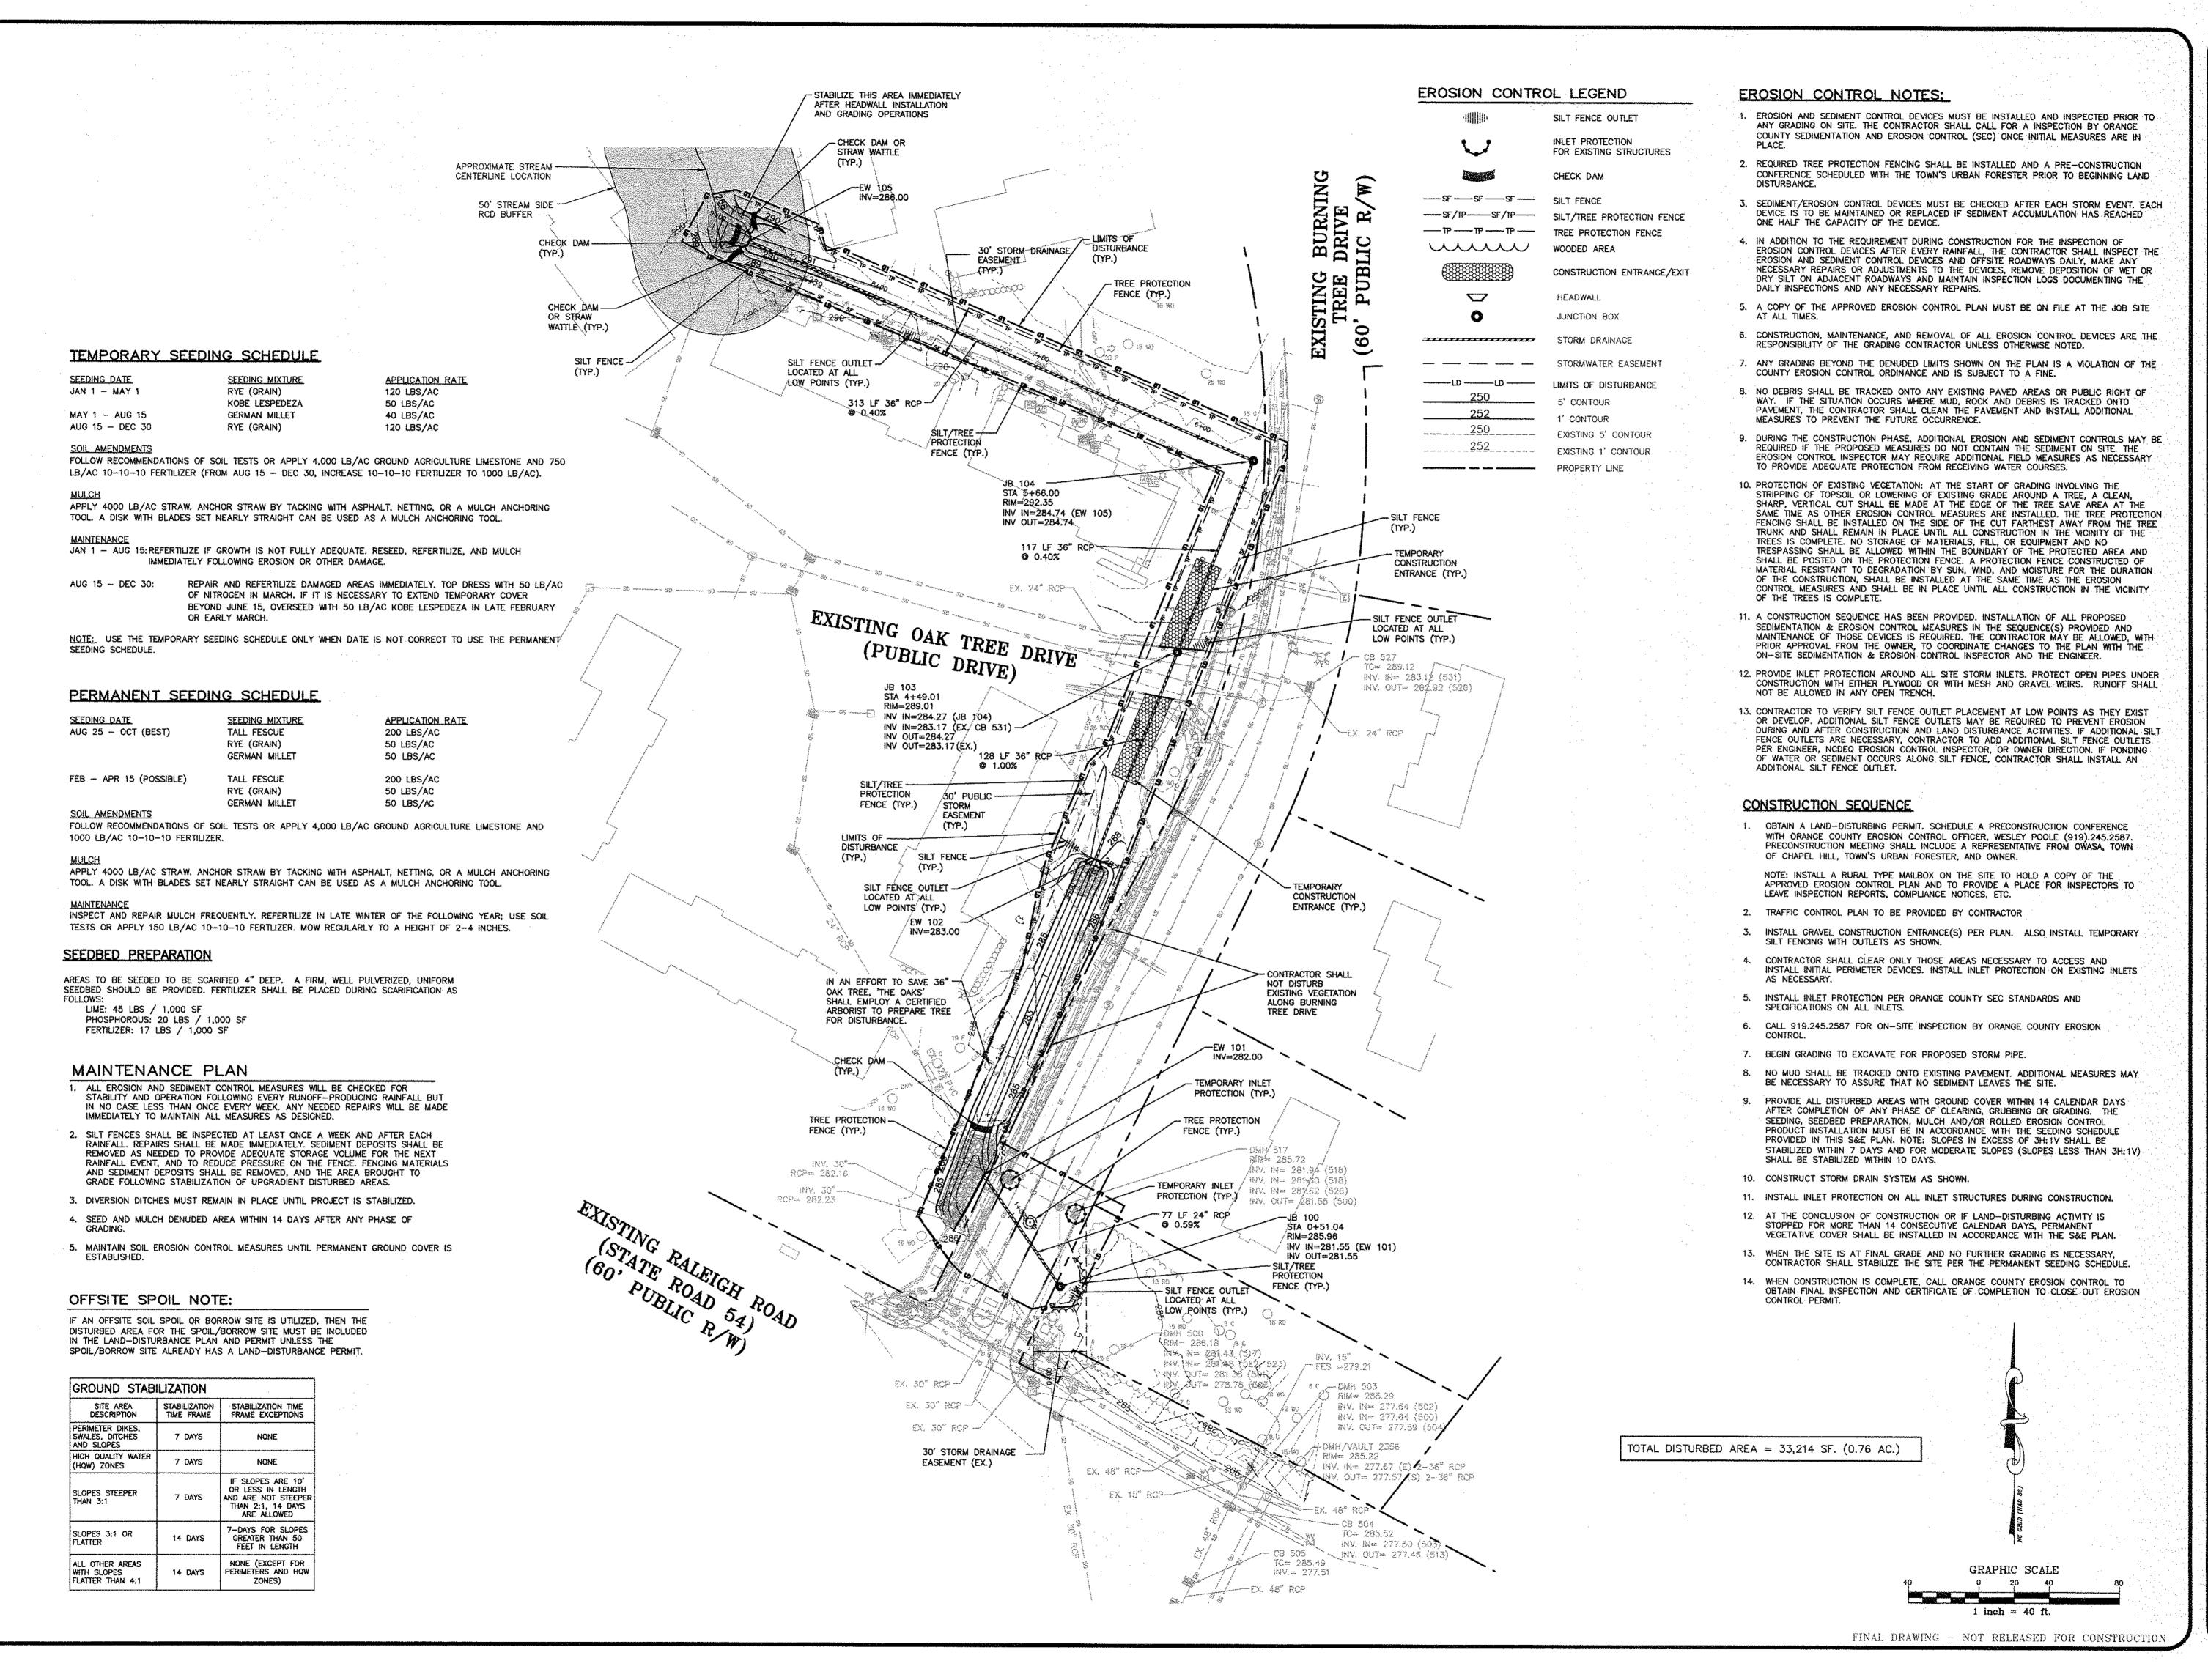



ROJECT NO. CAS-10000


ENAME: CAS10000-EC CHECKED BY: DAC SMP / NB 1'' = 40'


07-24-2018

凹 MCADAMS

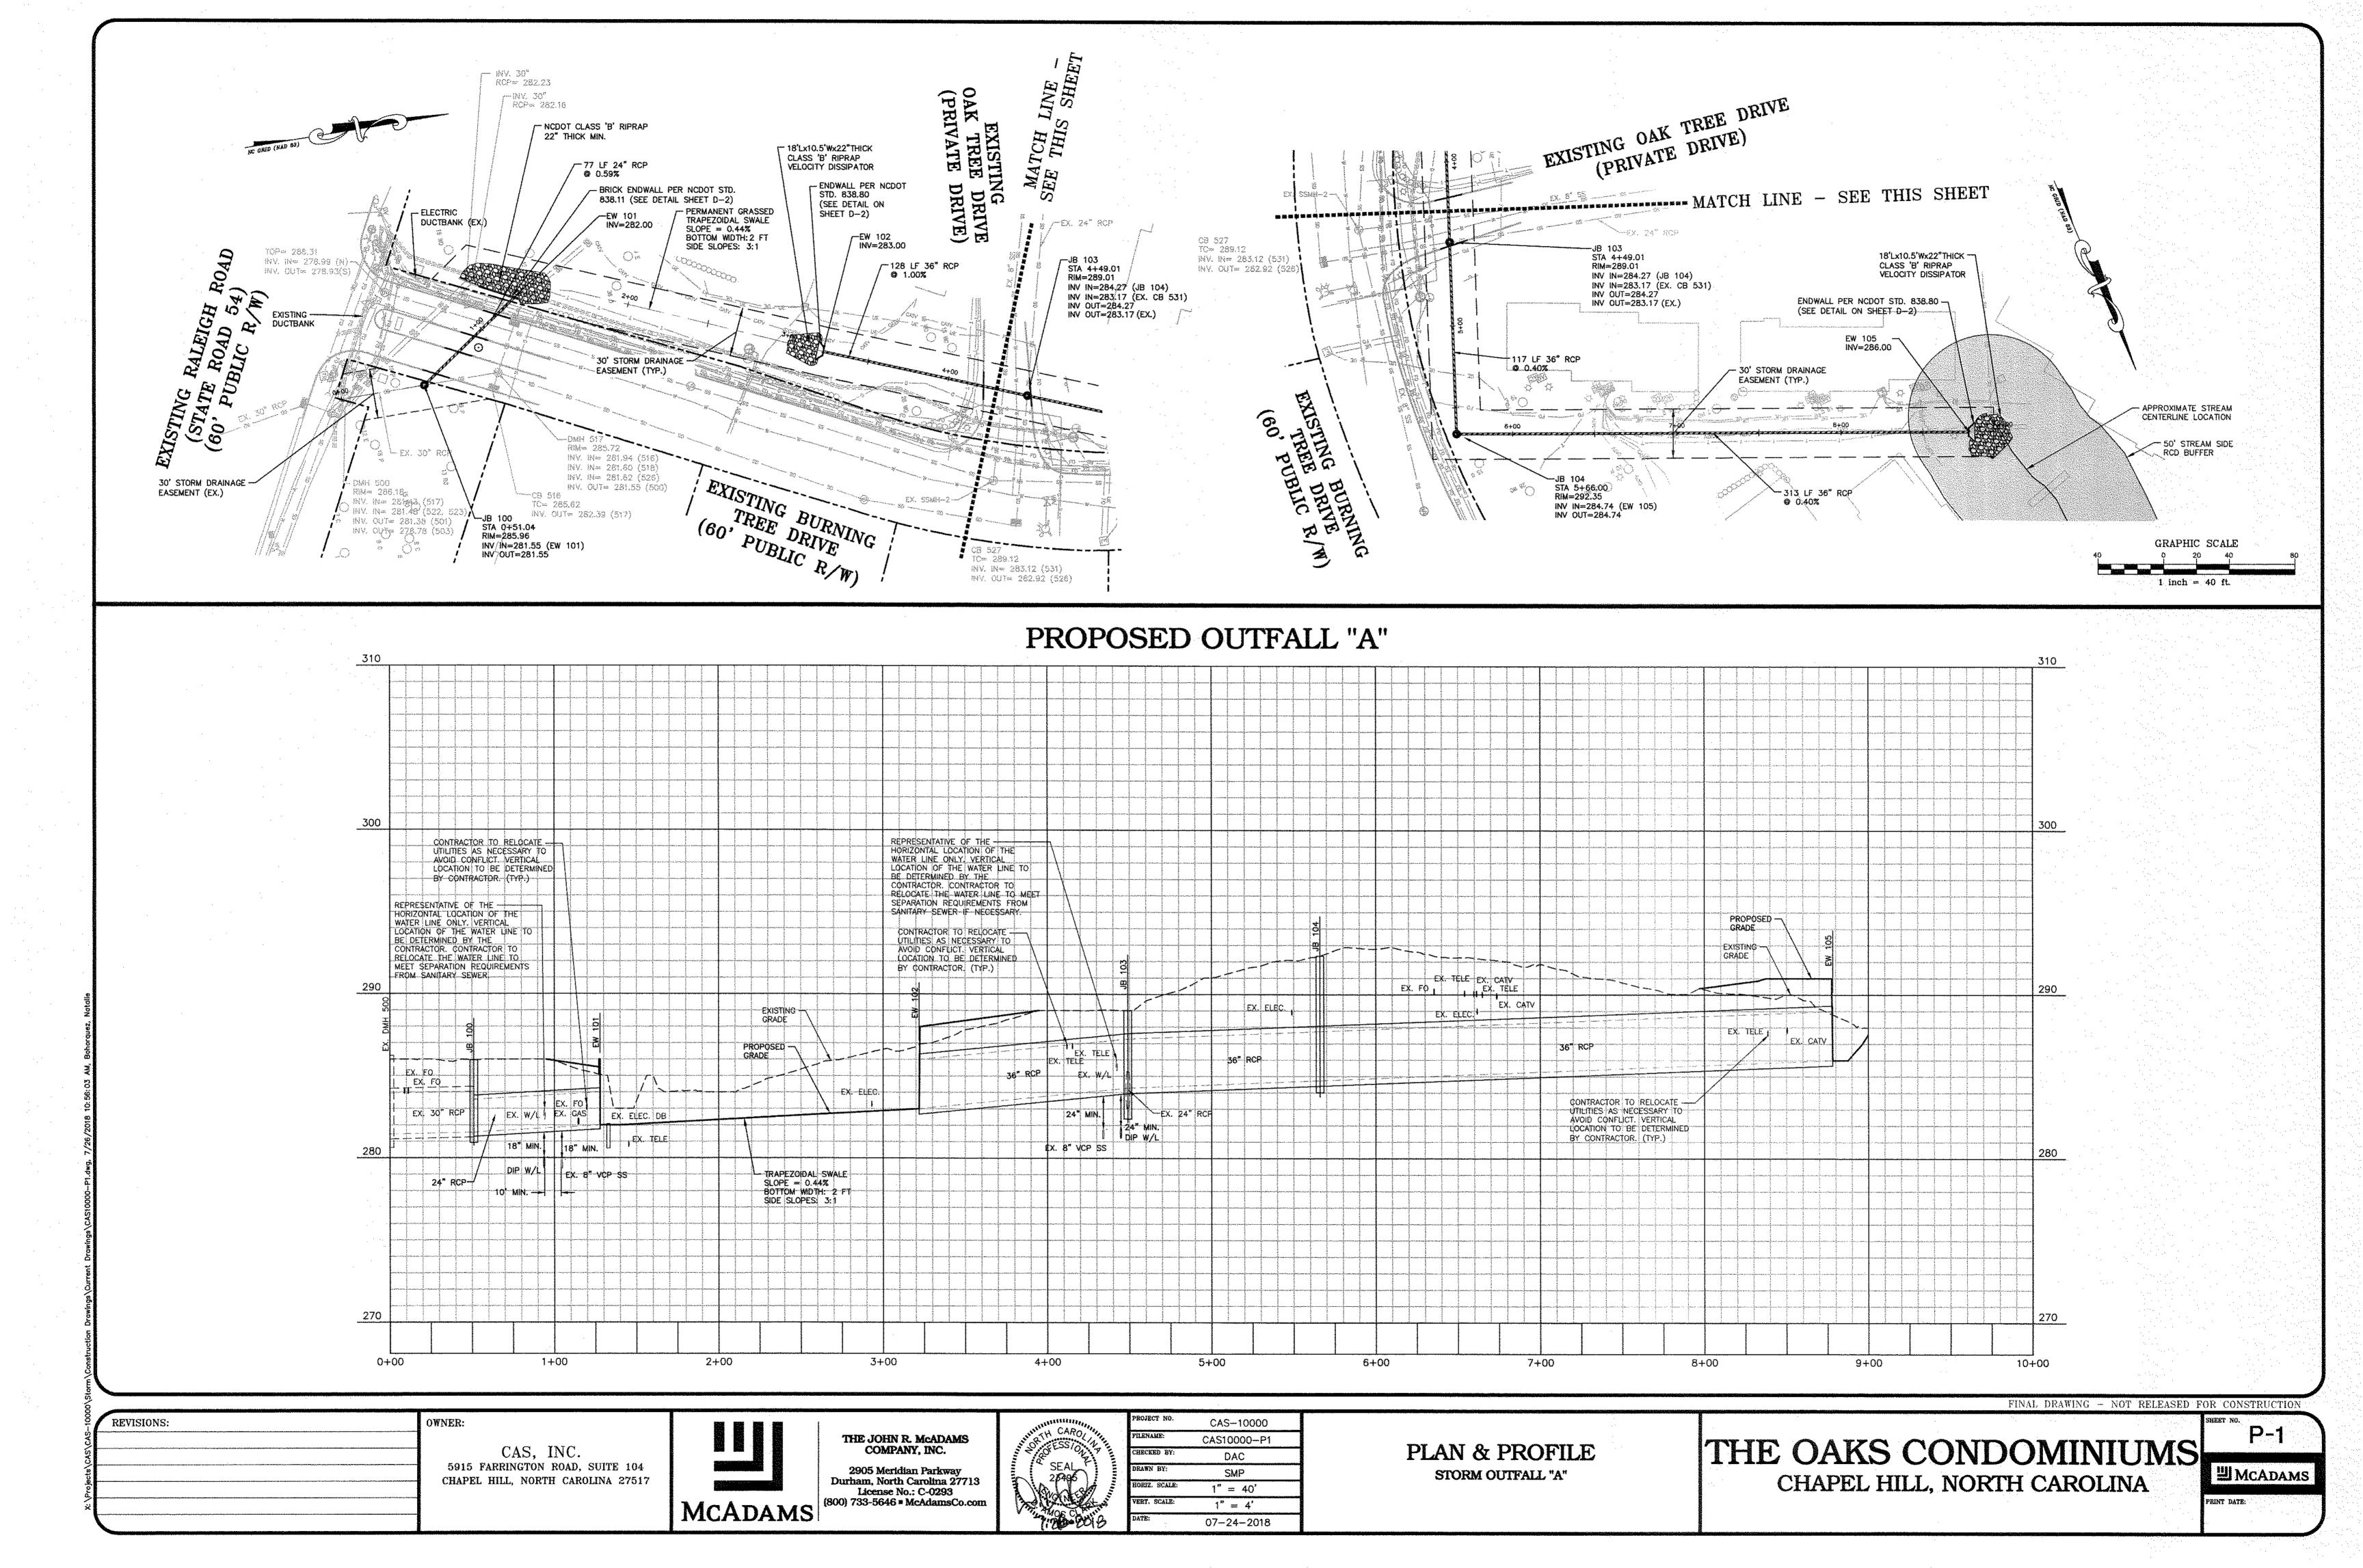

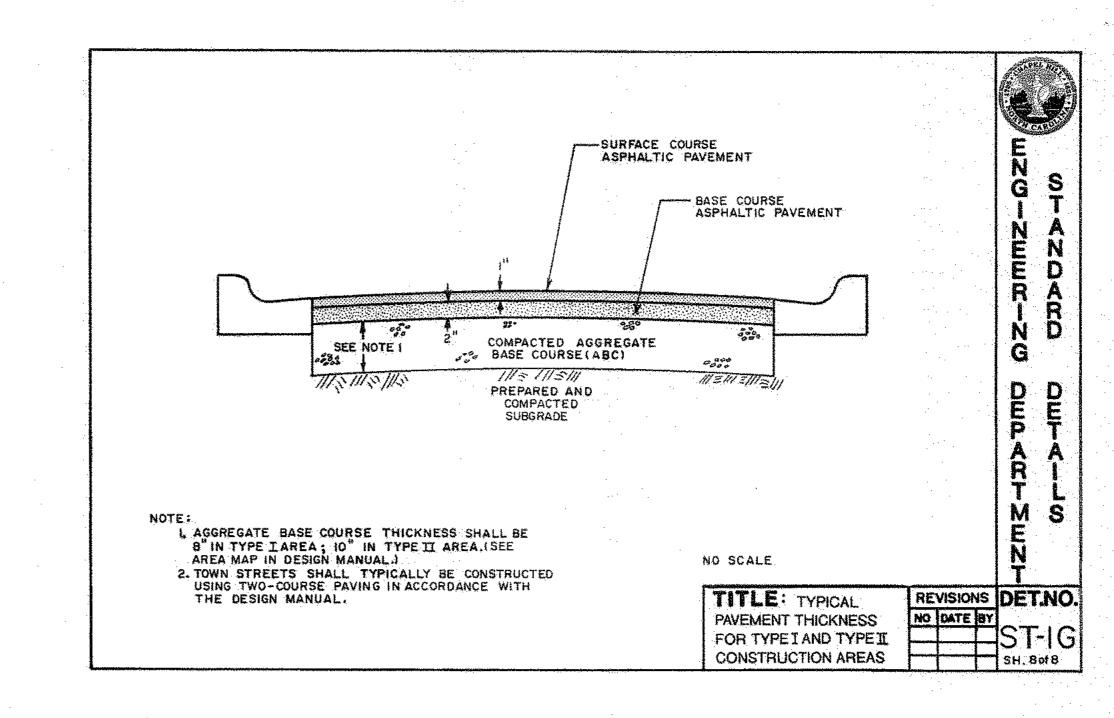

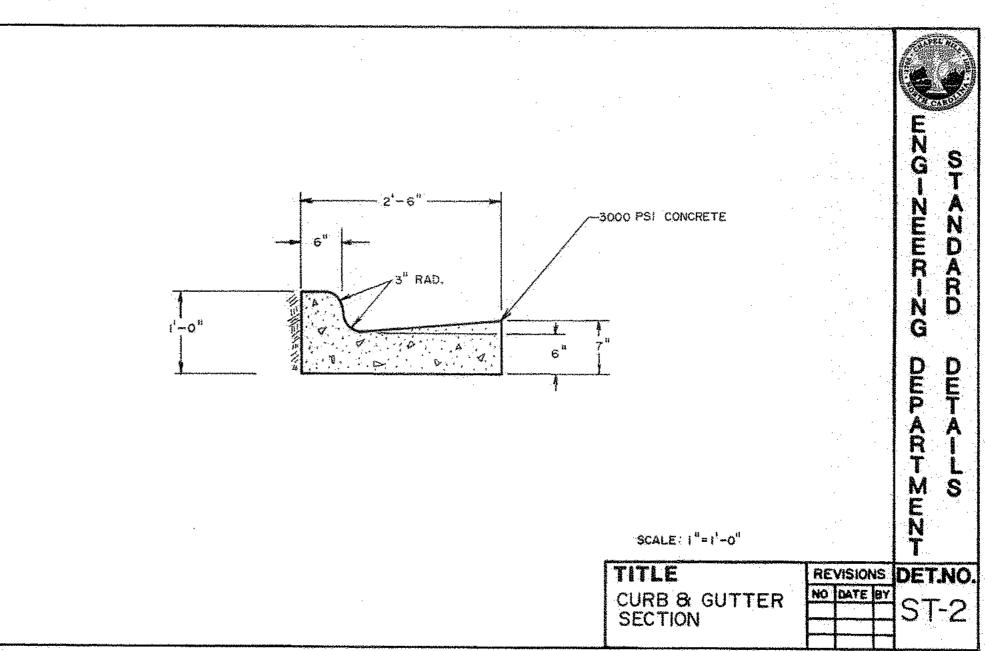

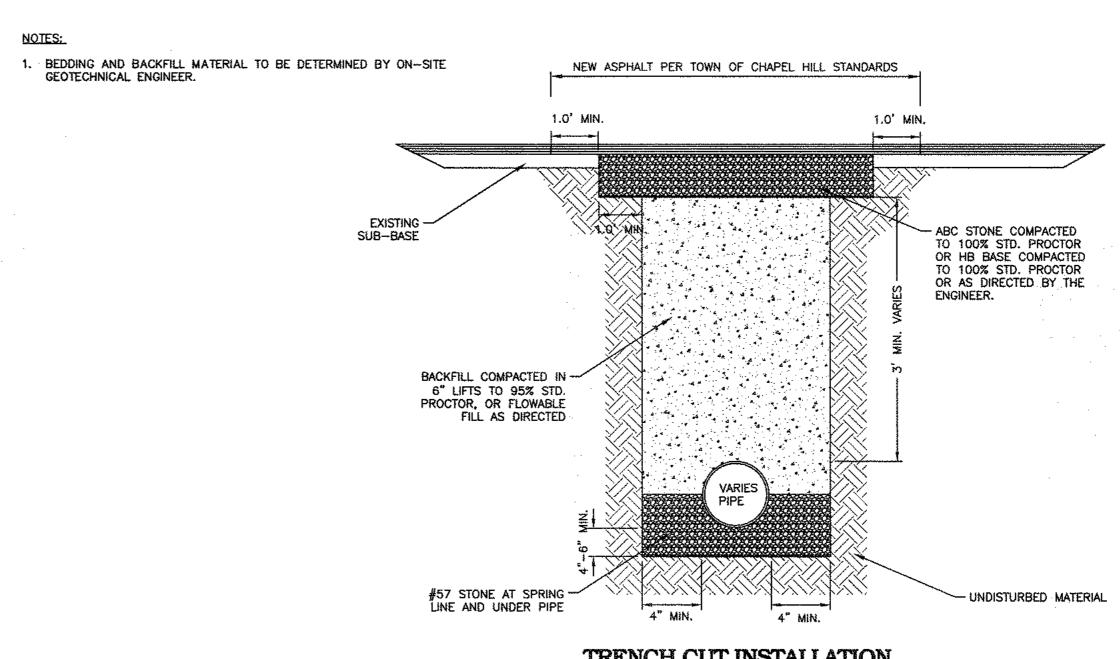

TRENCH CUT INSTALLATION
N.T.S.

FINAL DRAWING - NOT RELEASED FOR CONSTRUCTION


CONDOMINIUMS


PROJECT NO. CAS-10000
PILENAME: CAS10000-D1
CHECKED BY: DAC
DRAWN BY: SMP


NTS


DATE: 07-24-2018
SHEET NO. D-1

Ш McAdams

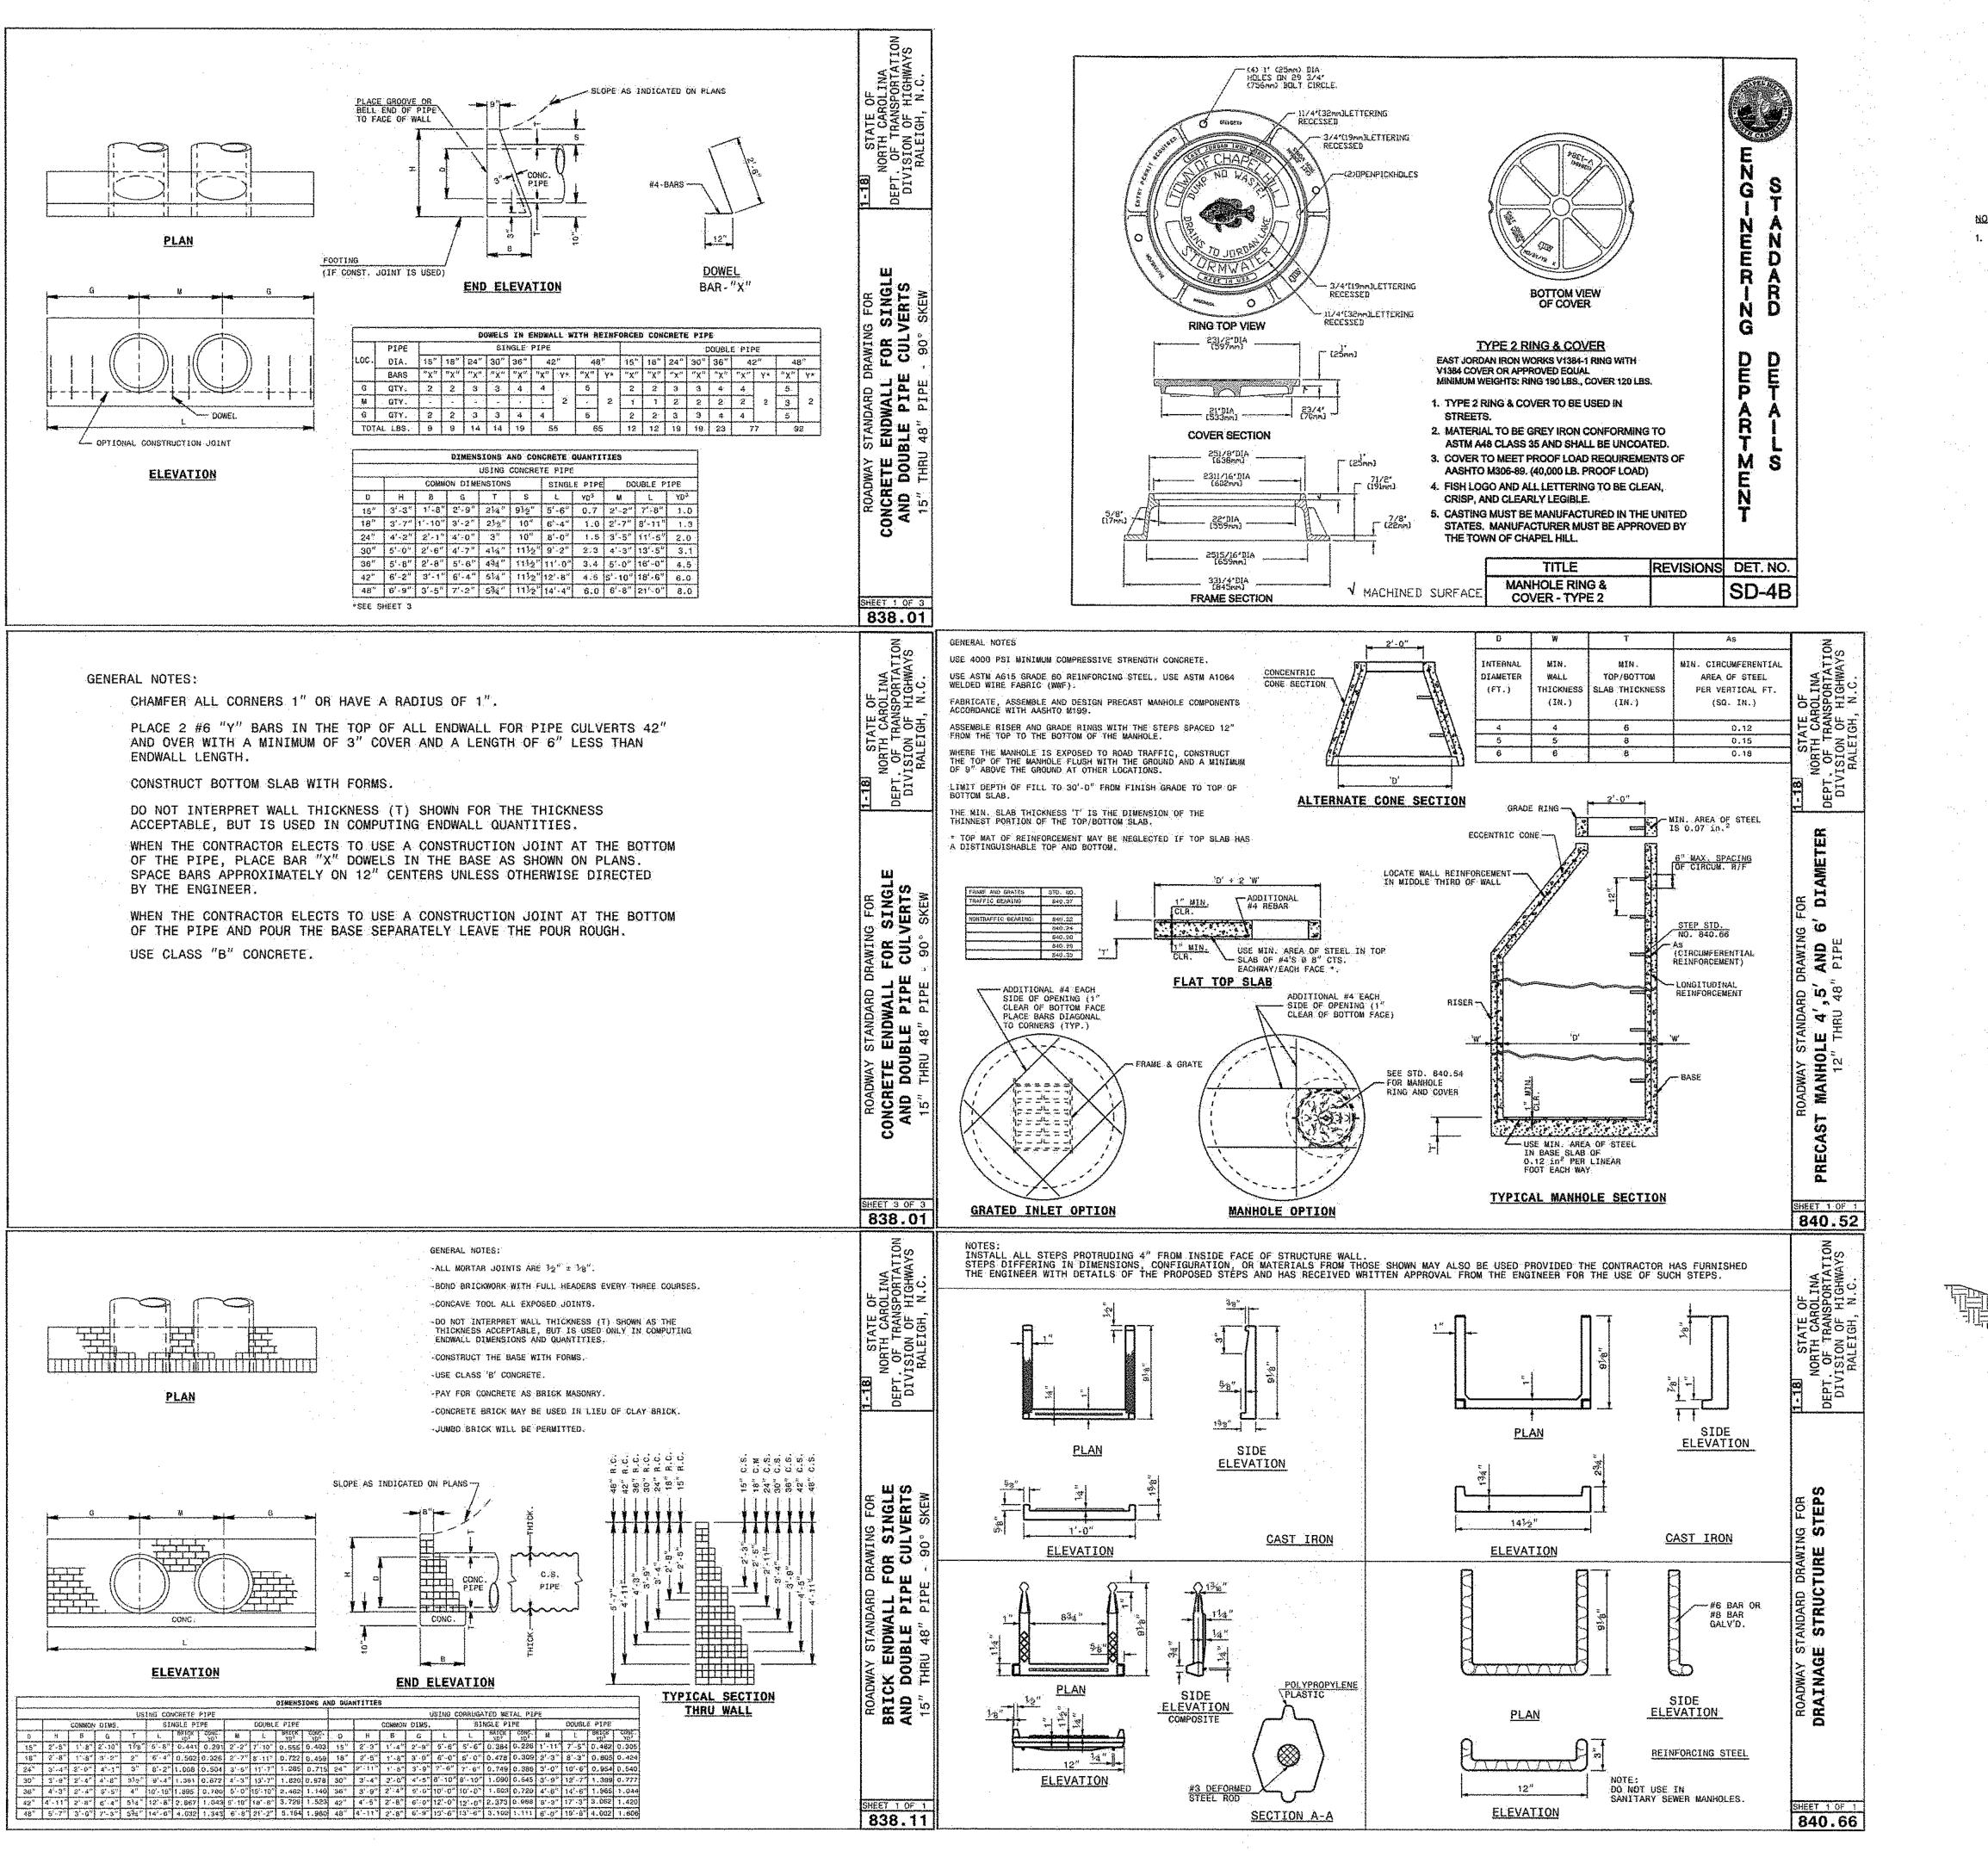


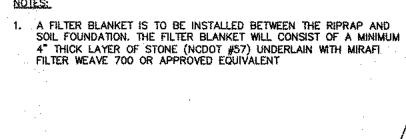

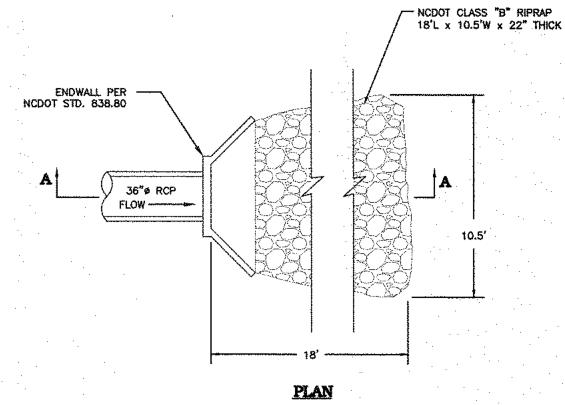

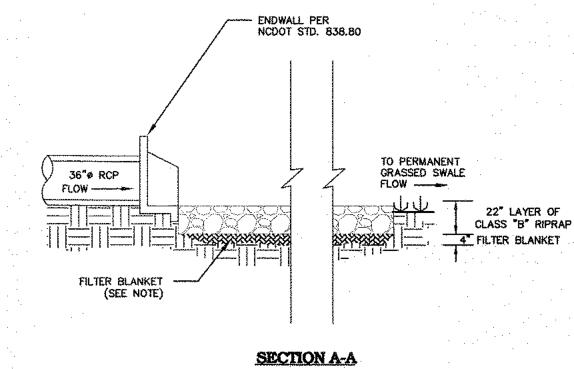

36"ø DIVERSION PIPE VELOCITY DISSIPATOR

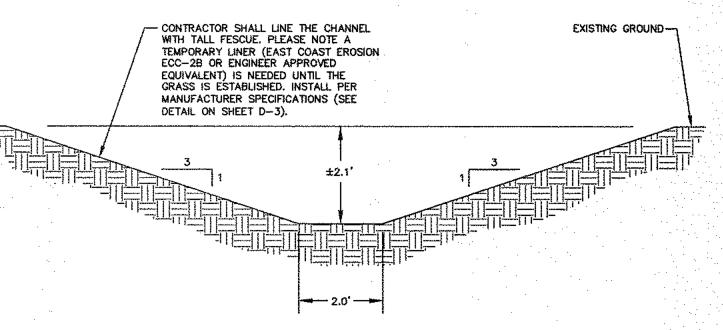

PERMANENT GRASSED TRAPEZOIDAL SWALE DETAIL
N.T.S.

CONDOMINIUMS
CHAPEL HILL, NORTH CAROLINA
STORM DRAINAGE DETAILS

PROJECT NO. CAS-10000

FILENAME: CAS10000-D1


CHECKED BY: DAC

DRAWN BY: SMP

NTS

DATE: 07-24-2018
SHEET NO. D-2

MCADAMS

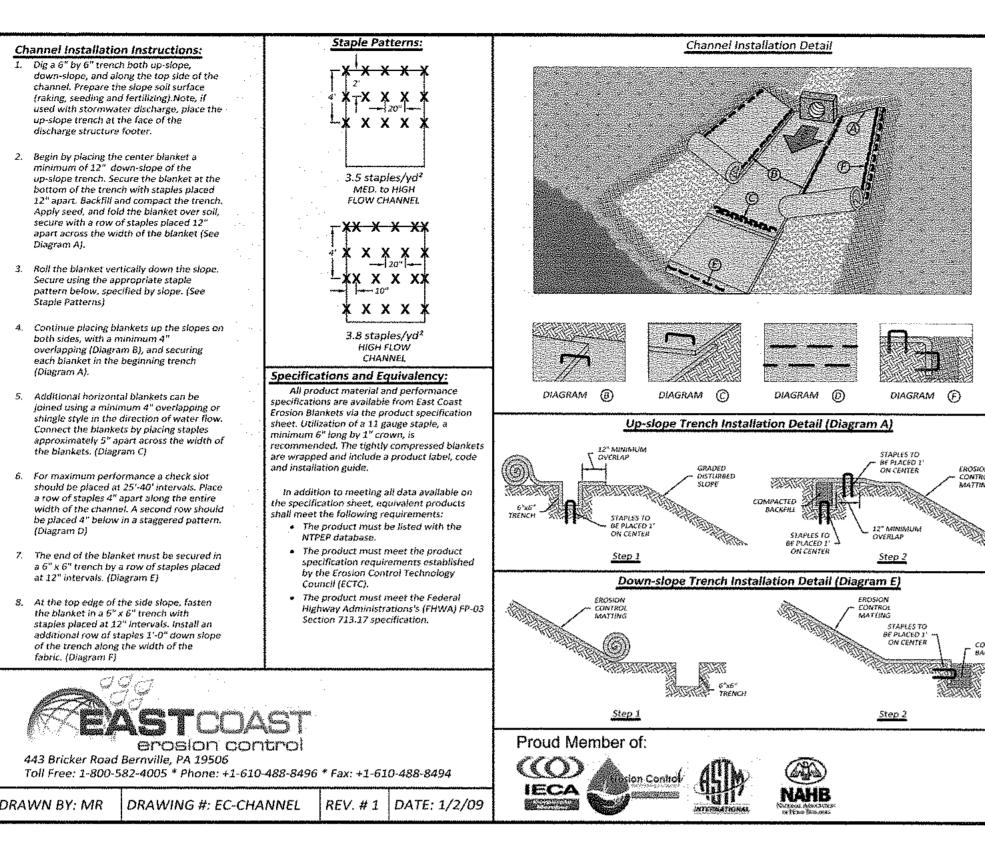

Slope Installation Guidelines:

seeding and fertilizing).

the blanket. (See Diagram A)

hese guidelines are recommendations only. Any questions with the installation should be onfirmed with your local distributor.

Dig a 6" by 6" trench both up-slope and down-slope of the area the matting is to be applied. Prepare the slope soil surface (raking,

Begin by placing the blanket a minimum of

and compact the trench. Apply seed, and fold

the blanket over soil, secure with a row of staples placed 12" apart across the width of

Roll the blanket vertically down the slope. Secure using the appropriate staple pattern

below, specified by slope. (See Staple

Parallel blankets must be overlapped by a minimum of 4", and secured with a row of

Additional vertical blankets can be joined

using a minimum 4" overlapping or shingle style (See Diagrams C) in the direction of

water flow. Connect the blankets by placing

staples approximately 12" apart across the width of the blankets.

For maximum performance a check slot should

be placed at 25'-40' intervals. Place a row of staples 4" apart along the entire width of the

slope. A second row should be placed 4"

below in a staggered pattern. Then continue with general installation. (See Diagrams D)

The end of blanket must be secured in a 6" x

6" trench with a row of staples placed at 12"

443 Bricker Road Bernville, PA 19506

DRAWN BY: MR | DRAWING #: EC-SLOPE

erosion control

Toll Free: 1-800-582-4005 * Phone: +1-610-488-8496 * Fax: +1-610-488-8494

intervals. (Diagram E)

staples placed approximately 3'-0" apart. (See

12" down-slope of the up-slope trench.

Secure the blanket at the bottom of the trench with staples placed 12" apart. Backfill 0.7 staples/yd²

2:1 SLOPES

Specifications and Equivalency:

All product material and performance

product label, code and installation guide.

neet the following requirements:

ecifications are available from East Coast

sion Blankets via the product specification

pecification sheet, equivalent products shall

The product must meet the Type 2.C

The product must meet the Federal

specification requirements established by

the Erosion Control Technology Council

REV. # 1 | DATE: 1/2/09

4:1 5LOPES

1.2 staples/yd²


3:1 SLOPES


4 X X X X


3.8 staples/yd2


2:1 SLOPES


IECA Sion

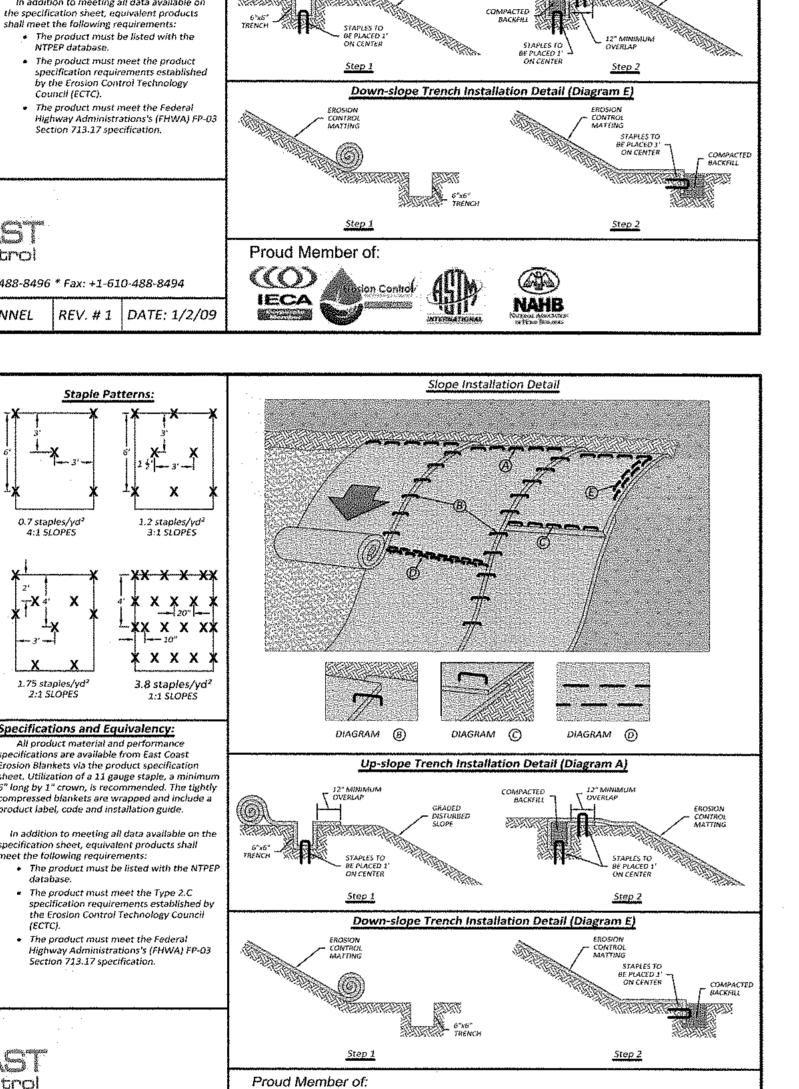


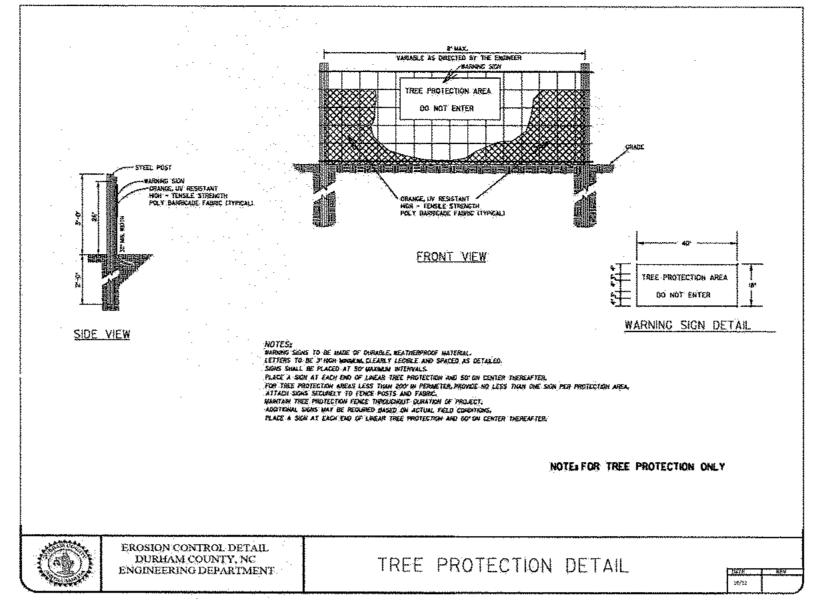


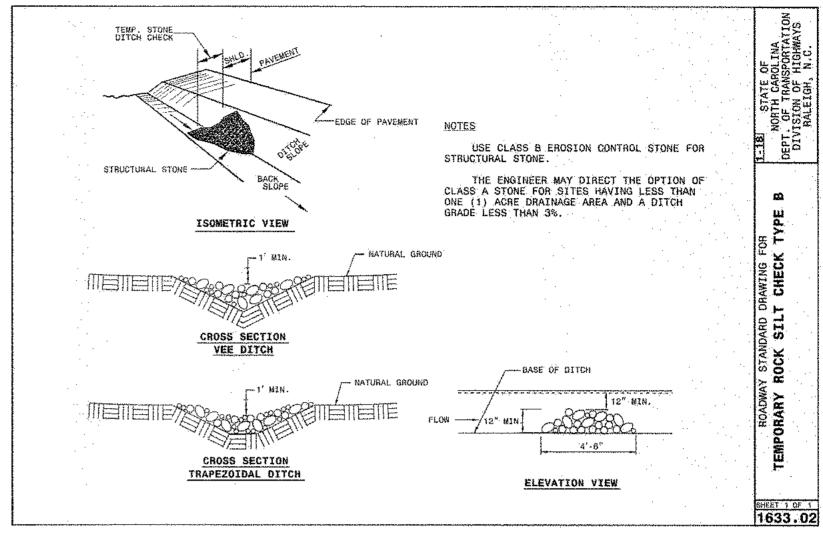


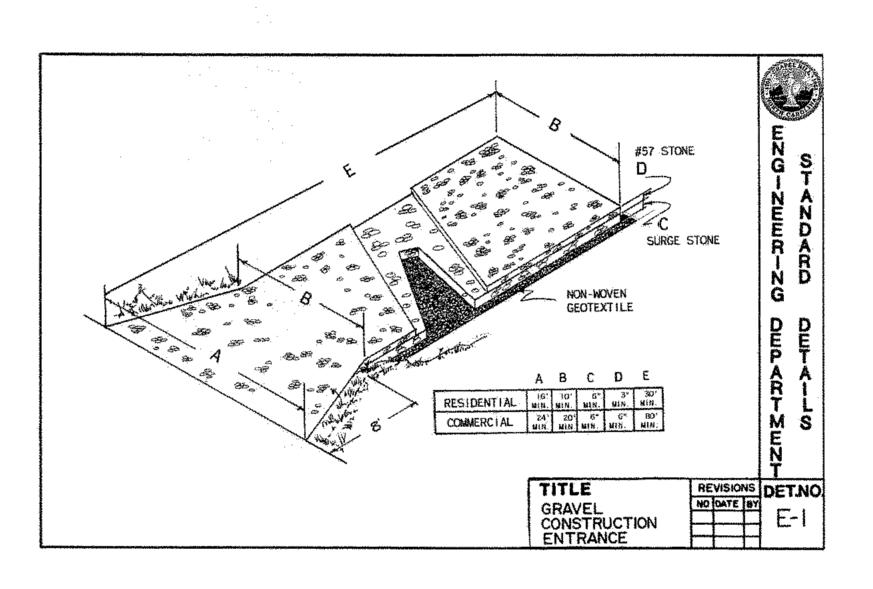


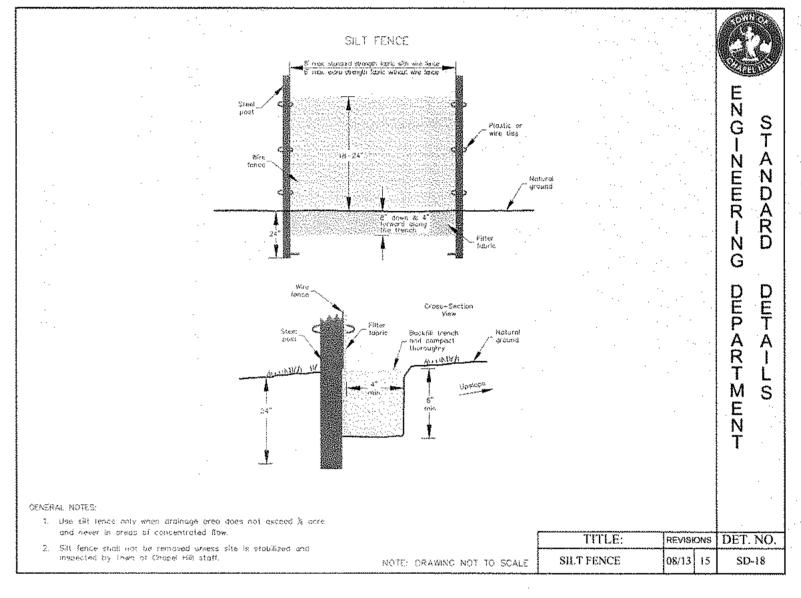

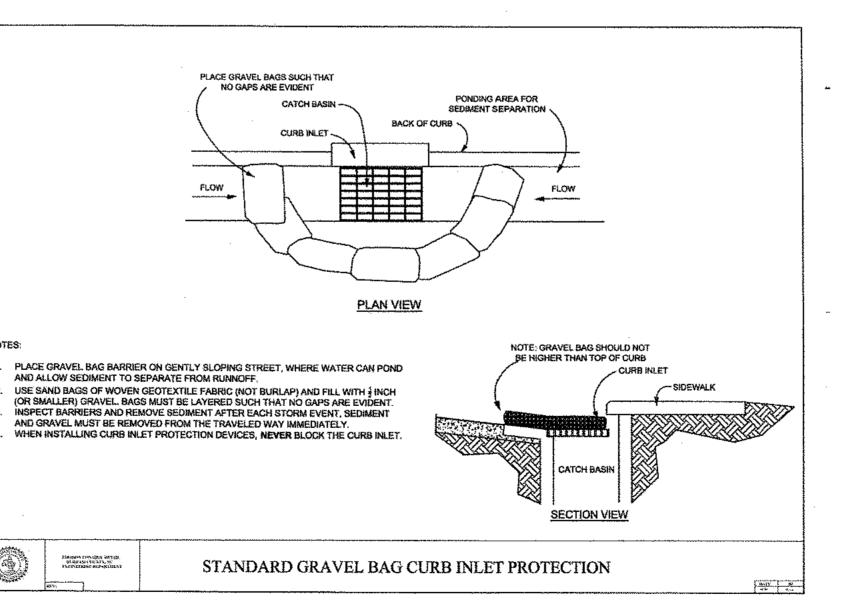

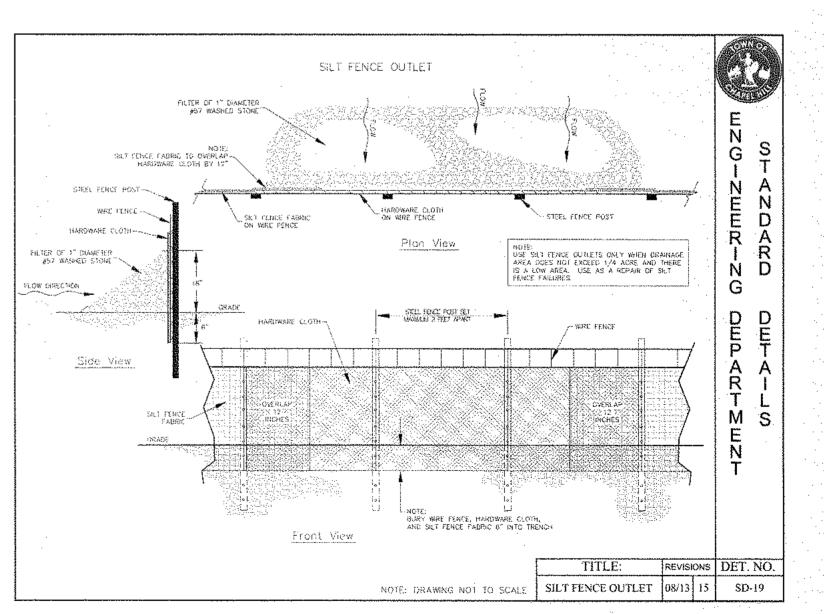

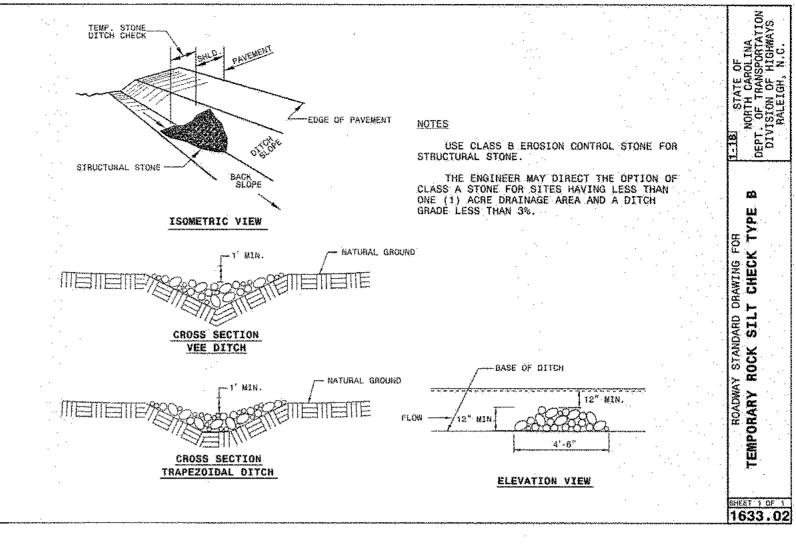

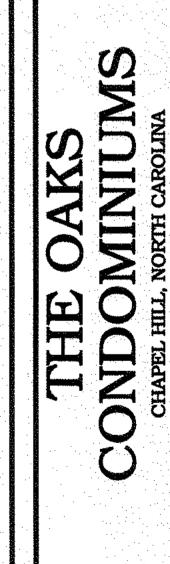


ROJECT NO. CAS-10000 FILENAME: CAS10000-E1

当McAdams

SMP NTS 07-24-2018

CHECKED BA: DAC

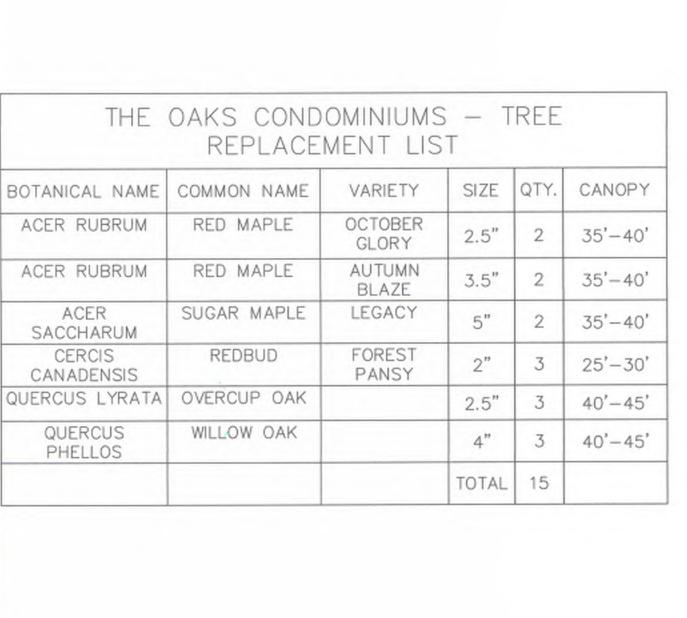

TREE LEGEND O 8 A ASH O 10 C CEDAR O 6 CH CHERRY O 10 E ELM O 12 0 SWEET GUM O 16 H HICKORY O 4 HO HOLLY O 15 M MAPLE O 20 RO RED OAK O 24 WO WHITE OAK O 31 0 OAK O 7 PER PEAR O 18 P PINE O 4 MBY MULBERRY { + } 2.500M OCTOBER GLORY RED MAPLE + \$ 3.5 ABM AUTUMN BLAZE RED MAPLE 5 LSW LEGACY SUGAR MAPLE 2 FPR FOREST PANSY REDBUD OVERCUP OAK 4 WO WILLOW OAK DOUBLE AND TRIPLE TRUNKS O 20 D-0 DOUBLE OAK O 20 T-0 TRIPLE OAK


LANDSCAPE PROTECTION NOTES:

CALIPER INCH SIZE OF TREE

D FOR DOUBLE, T FOR TRIPLE

O 20 T-0-TYPE OF TREE

- PLAN SHOWS RARE AND SPECIMEN TREES IN ACCORDANCE WITH THE ORDINANCE THAT WAS IN EFFECT AT THE TIME OF APPROVAL.
- 2. A LANDSCAPE PROTECTION SUPERVISOR WHO IS REGISTERED WITH THE TOWN OF CHAPEL HILL WILL BE PRESENT ON SITE AT ALL TIMES WHEN THE FOLLOWING ACTIVITIES ARE TAKING PLACE: CLEARING, GRUBBING, EXCAVATION, GRADING, TRENCHING, MOVING OF SOIL, INSTALLATION AND REMOVAL OF TREE PROTECTION FENCING, AND THE DELIVERY, TRANSPORTING, AND PLACEMENT OF CONSTRUCTION MATERIALS AND EQUIPMENT.
- A PRE-CONSTRUCTION CONFERENCE SHALL BE HELD WITH THE PROJECT'S LANDSCAPE PROTECTION SUPERVISOR AND THE TOWN'S URBAN FORESTER OR LANDSCAPE ARCHITECT BEFORE ANY SITE WORK BEGINS.
- ANY TREE ROOTS EXPOSED BY CONSTRUCTION SHALL BE SEVERED CLEANLY WITH A PRUNING TOOL.
- THE SOIL WITHIN THE PROTECTED AREA AROUND EXISTING TREES SHALL NOT BE DRIVEN UPON ONCE TREE PROTECTION FENCING IS REMOVED, FOR THE PURPOSE OF INSTALLING LANDSCAPING.
- 6. IT IS THE RECOMMENDATION OF THE McADAMS COMPANY TO REMOVE ALL TREES AS MARKED ON THIS PLAN. THE OWNER MAY ATTEMPT TO PRESERVE TREES MARKED AS REMOVED BUT IN DOING SO ASSUME ALL RESPONSIBILITY AND LIABILITY FOR THE TREES. ALL MEASURES TAKEN TO PRESERVE TREES MUST BE APPROVED BY THE ENGINEER.
- SYMBOL SIZE FOR PROPOSED TREES REPRESENTS TREES AT 15 YEARS OF GROWTH, CANOPY DIAMETERS ARE REPRESENTATIVE OF TREES AT FULL

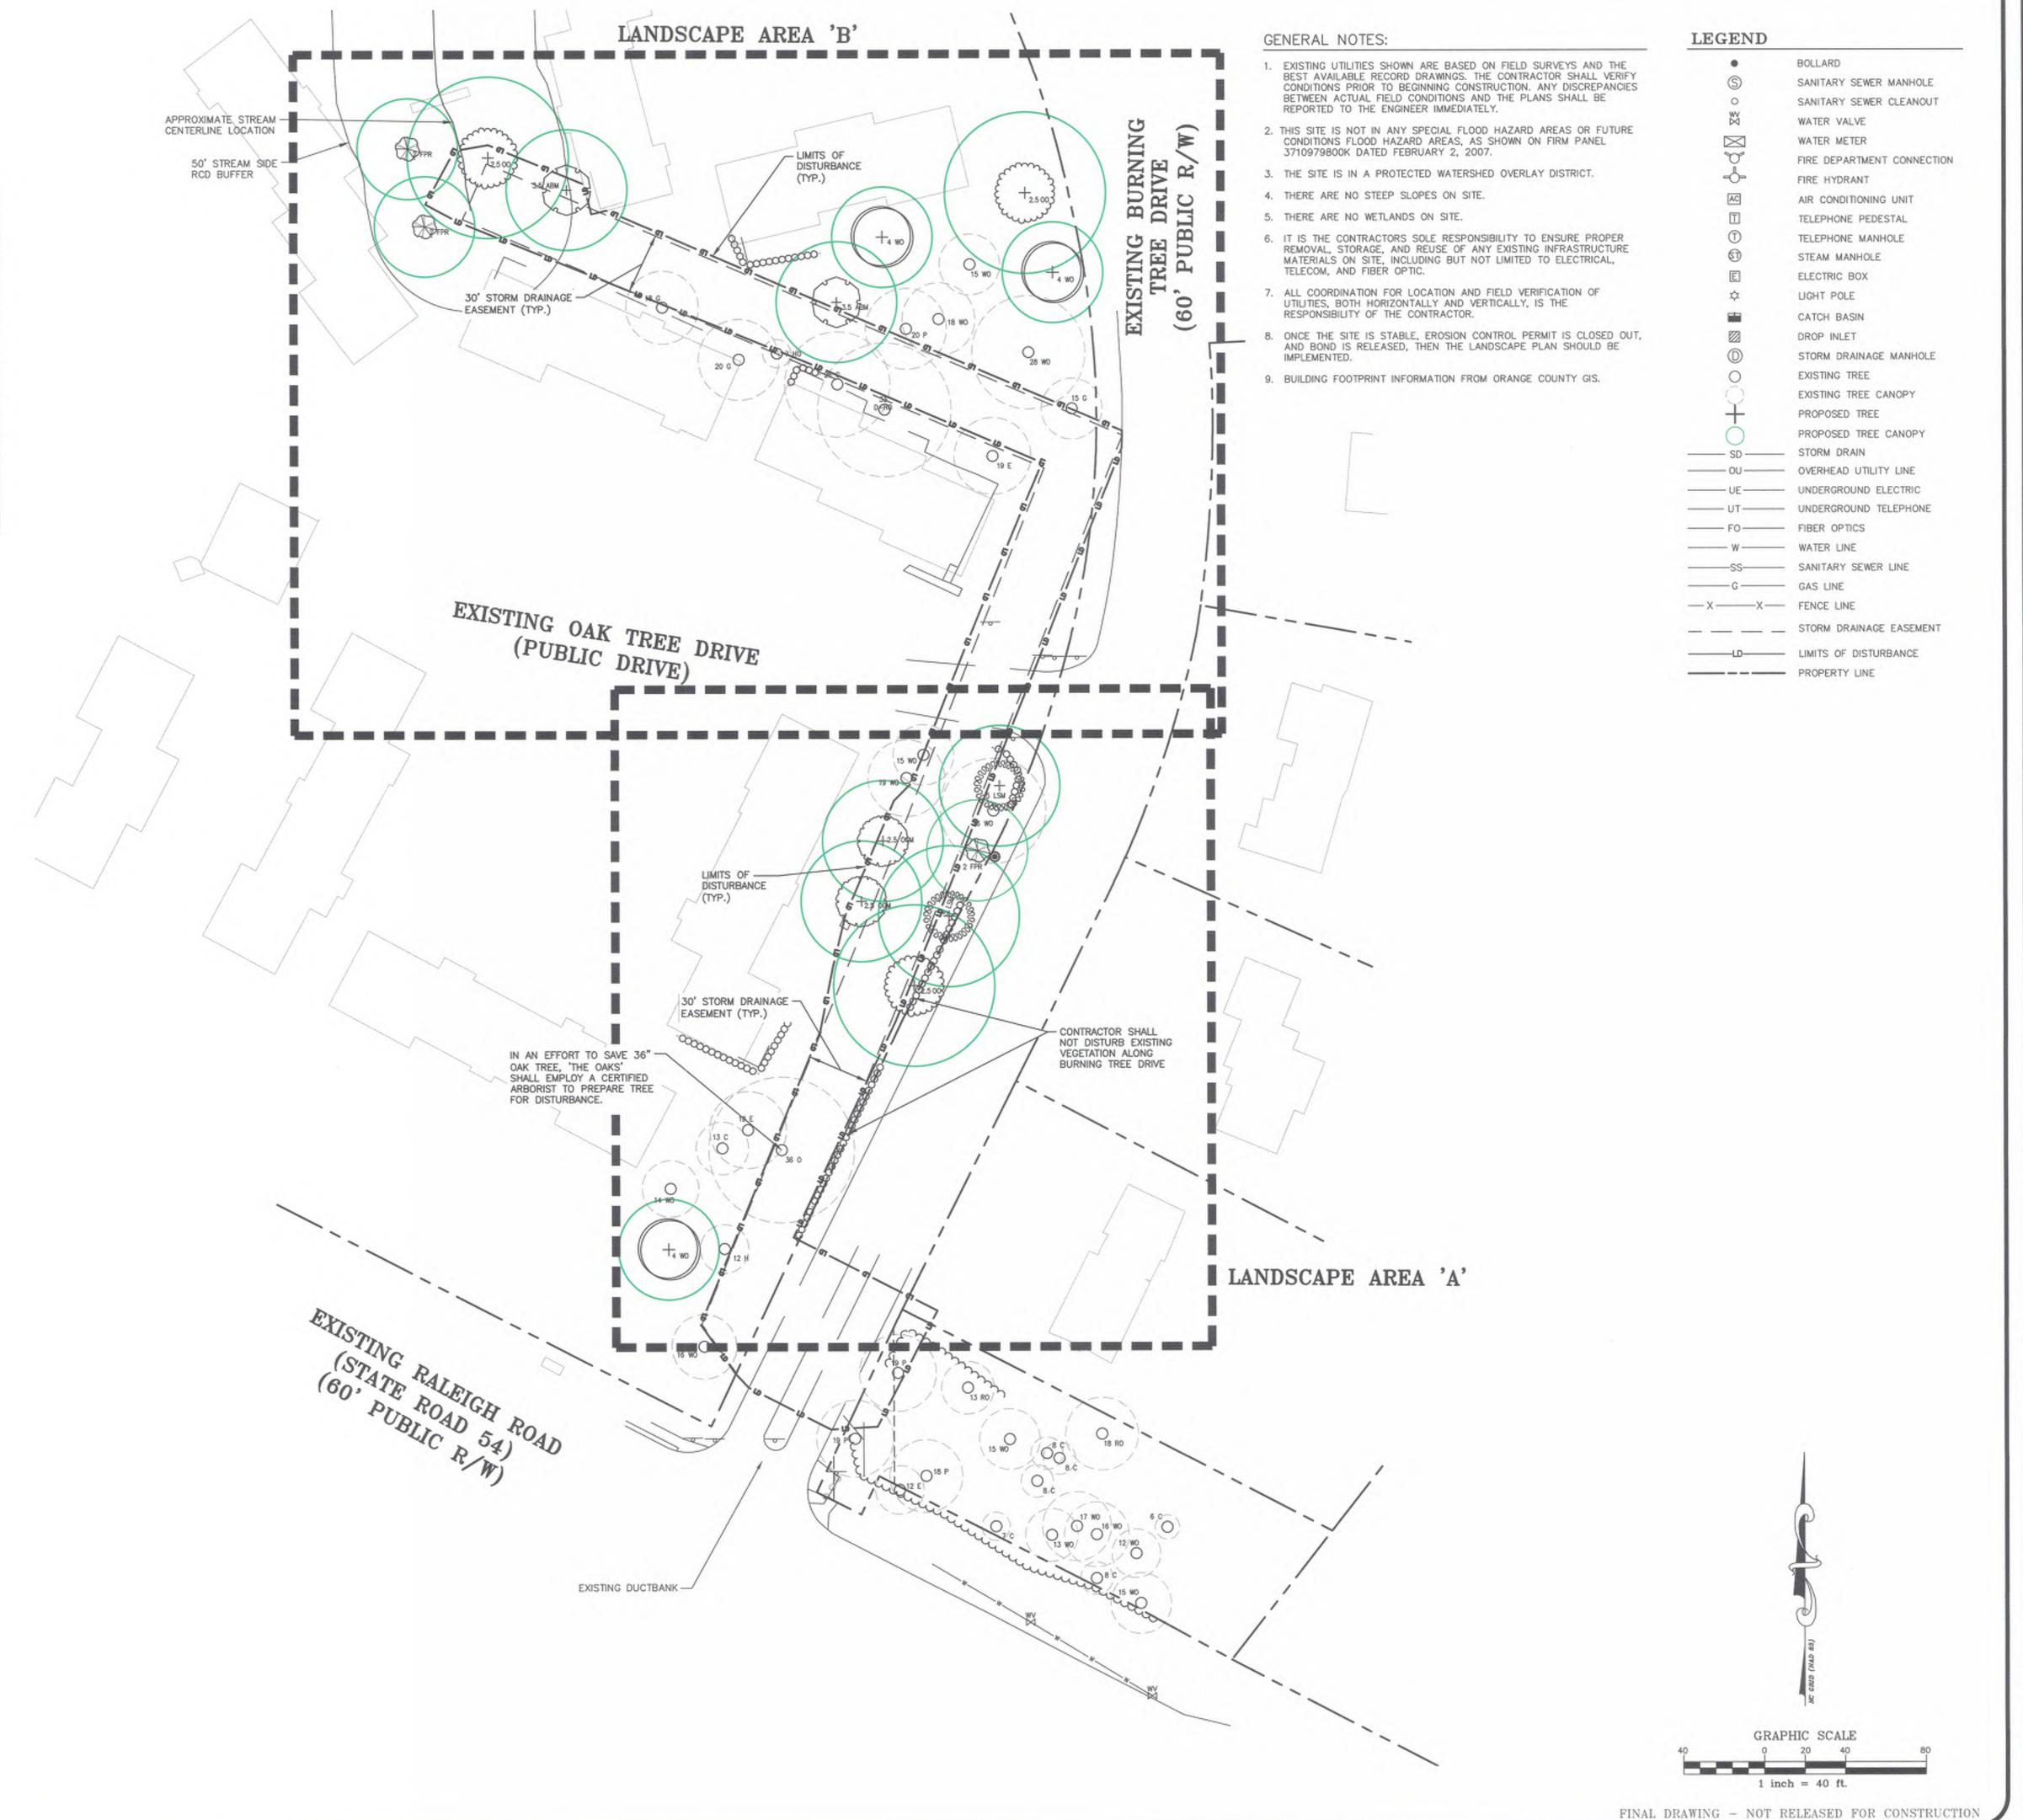


PROJECT NO. CAS-10000 FILENAME: CAS10000-L CHECKED BY: DAC/DAF SMP/NB

1" = 40'

07-24-2018

LS-1

MCADAMS

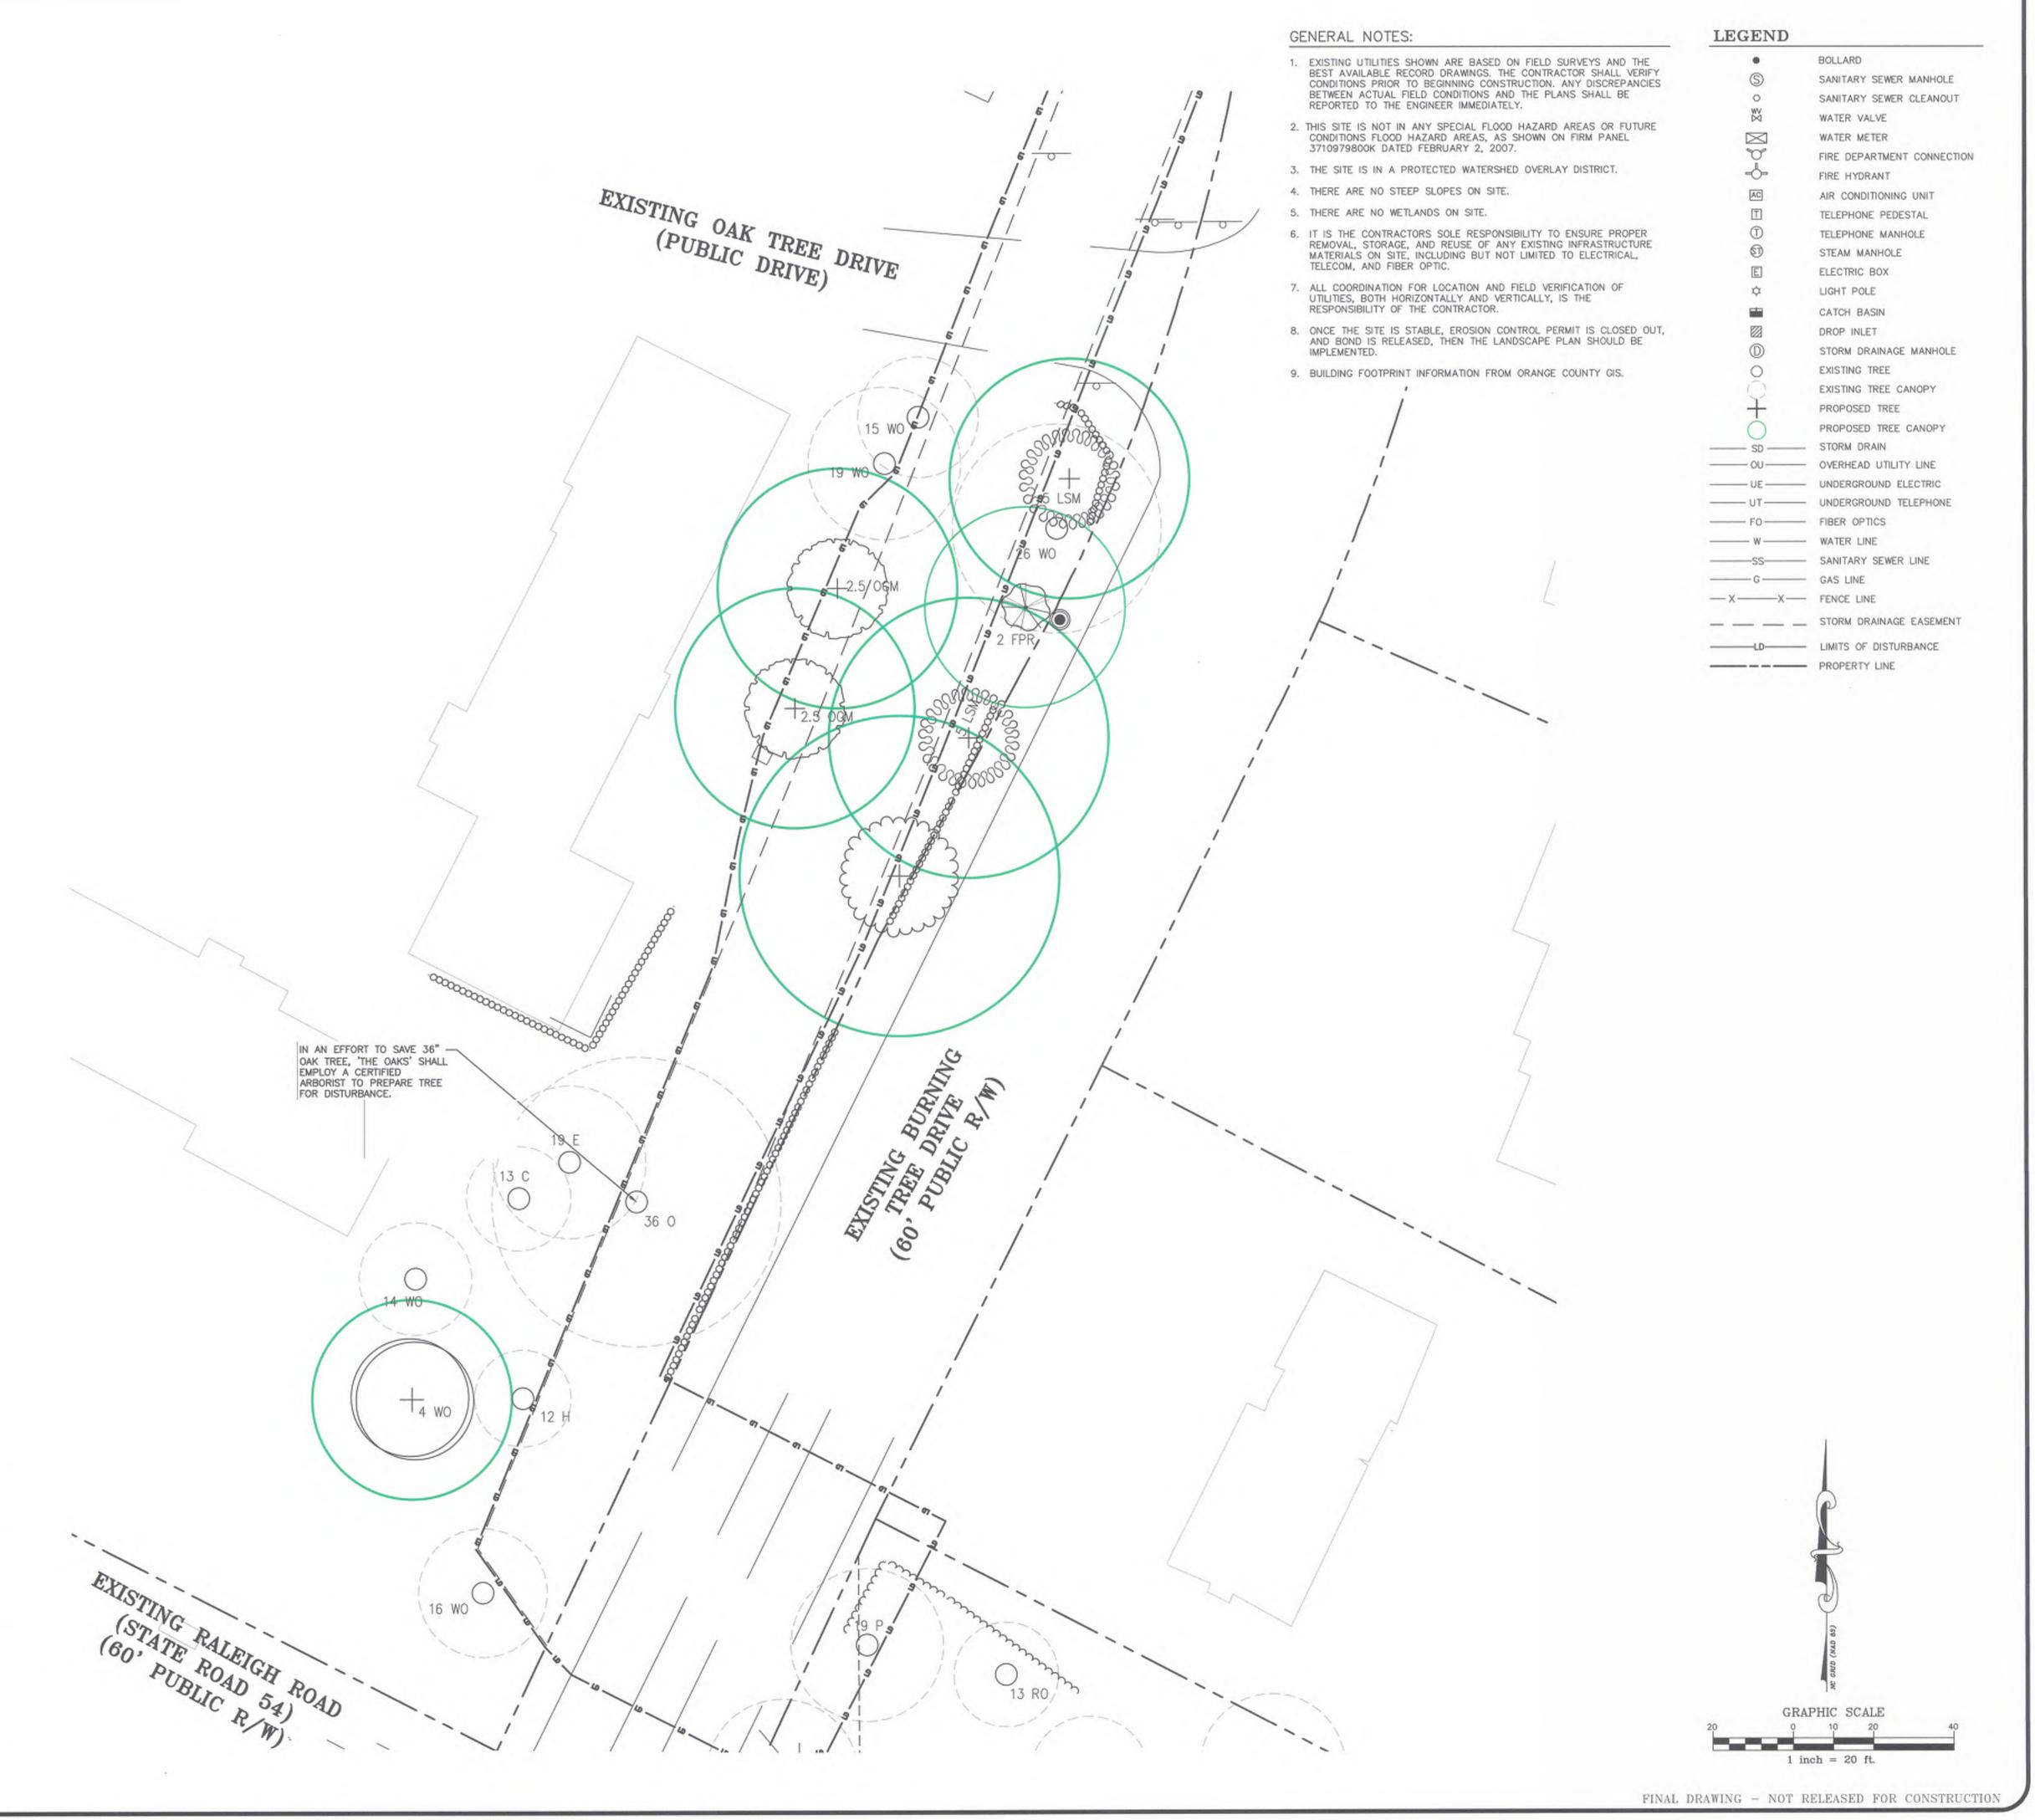

TREE LEGEND

WHITE OAK

+ \$ 2.500M OCTOBER GLORY RED MAPLE

+ 3.5 ABN AUTUMN BLAZE RED MAPLE

5 LSM LEGACY SUGAR MAPLE

2 FPR FOREST PANSY REDBUD

2.500 OVERCUP OAK

4 WO WILLOW OAK

CALIPER INCH SIZE OF TREE

D FOR DOUBLE, T FOR TRIPLE

LANDSCAPE PROTECTION NOTES:

PLACEMENT OF CONSTRUCTION MATERIALS AND EQUIPMENT.

OR LANDSCAPE ARCHITECT BEFORE ANY SITE WORK BEGINS.

1. PLAN SHOWS RARE AND SPECIMEN TREES IN ACCORDANCE WITH THE ORDINANCE THAT WAS IN EFFECT AT THE TIME OF APPROVAL.

 A LANDSCAPE PROTECTION SUPERVISOR WHO IS REGISTERED WITH THE TOWN OF CHAPEL HILL WILL BE PRESENT ON SITE AT ALL TIMES WHEN THE FOLLOWING ACTIVITIES ARE TAKING PLACE: CLEARING, GRUBBING, EXCAVATION, GRADING, TRENCHING, MOVING OF SOIL, INSTALLATION AND REMOVAL OF TREE PROTECTION FENCING, AND THE DELIVERY, TRANSPORTING, AND

3. A PRE-CONSTRUCTION CONFERENCE SHALL BE HELD WITH THE PROJECT'S LANDSCAPE PROTECTION SUPERVISOR AND THE TOWN'S URBAN FORESTER

4. ANY TREE ROOTS EXPOSED BY CONSTRUCTION SHALL BE SEVERED CLEANLY

THE SOIL WITHIN THE PROTECTED AREA AROUND EXISTING TREES SHALL NOT BE DRIVEN UPON ONCE TREE PROTECTION FENCING IS REMOVED, FOR THE PURPOSE OF INSTALLING LANDSCAPING.

6. IT IS THE RECOMMENDATION OF THE McADAMS COMPANY TO REMOVE ALL TREES AS MARKED ON THIS PLAN. THE OWNER MAY ATTEMPT TO

PRESERVE TREES MARKED AS REMOVED BUT IN DOING SO ASSUME ALL RESPONSIBILITY AND LIABILITY FOR THE TREES. ALL MEASURES TAKEN TO PRESERVE TREES MUST BE APPROVED BY THE ENGINEER.

SYMBOL SIZE FOR PROPOSED TREES REPRESENTS TREES AT 15 YEARS OF GROWTH. CANOPY DIAMETERS ARE REPRESENTATIVE OF TREES AT FULL MATURITY.

DOUBLE AND TRIPLE TRUNKS O 20 D-0 DOUBLE OAK O 20 T-0 TRIPLE OAK

O 20 T-0-TYPE OF TREE

WITH A PRUNING TOOL.

O 8 A ASH O 10 C CEDAR O 6 CH CHERRY O 10 E ELM O 12 G SWEET GUM O 16 H HICKORY O 4 HO HOLLY O 15 M MAPLE O 20 RO RED OAK


O 24 W0

O 31 0 OAK O 7 PER PEAR O 18 P PINE O 4 MBY MULBERRY

INCORPORATED
RRINGTON ROAD, SUITE 10
ILL, NORTH CAROLINA 275

PROJECT NO. CAS-10000 PILENAME: CAS10000-L CHECKED BY: DAC/DAP SMP/NB 1" = 20' 07-24-2018

LS-2 **MCADAMS**

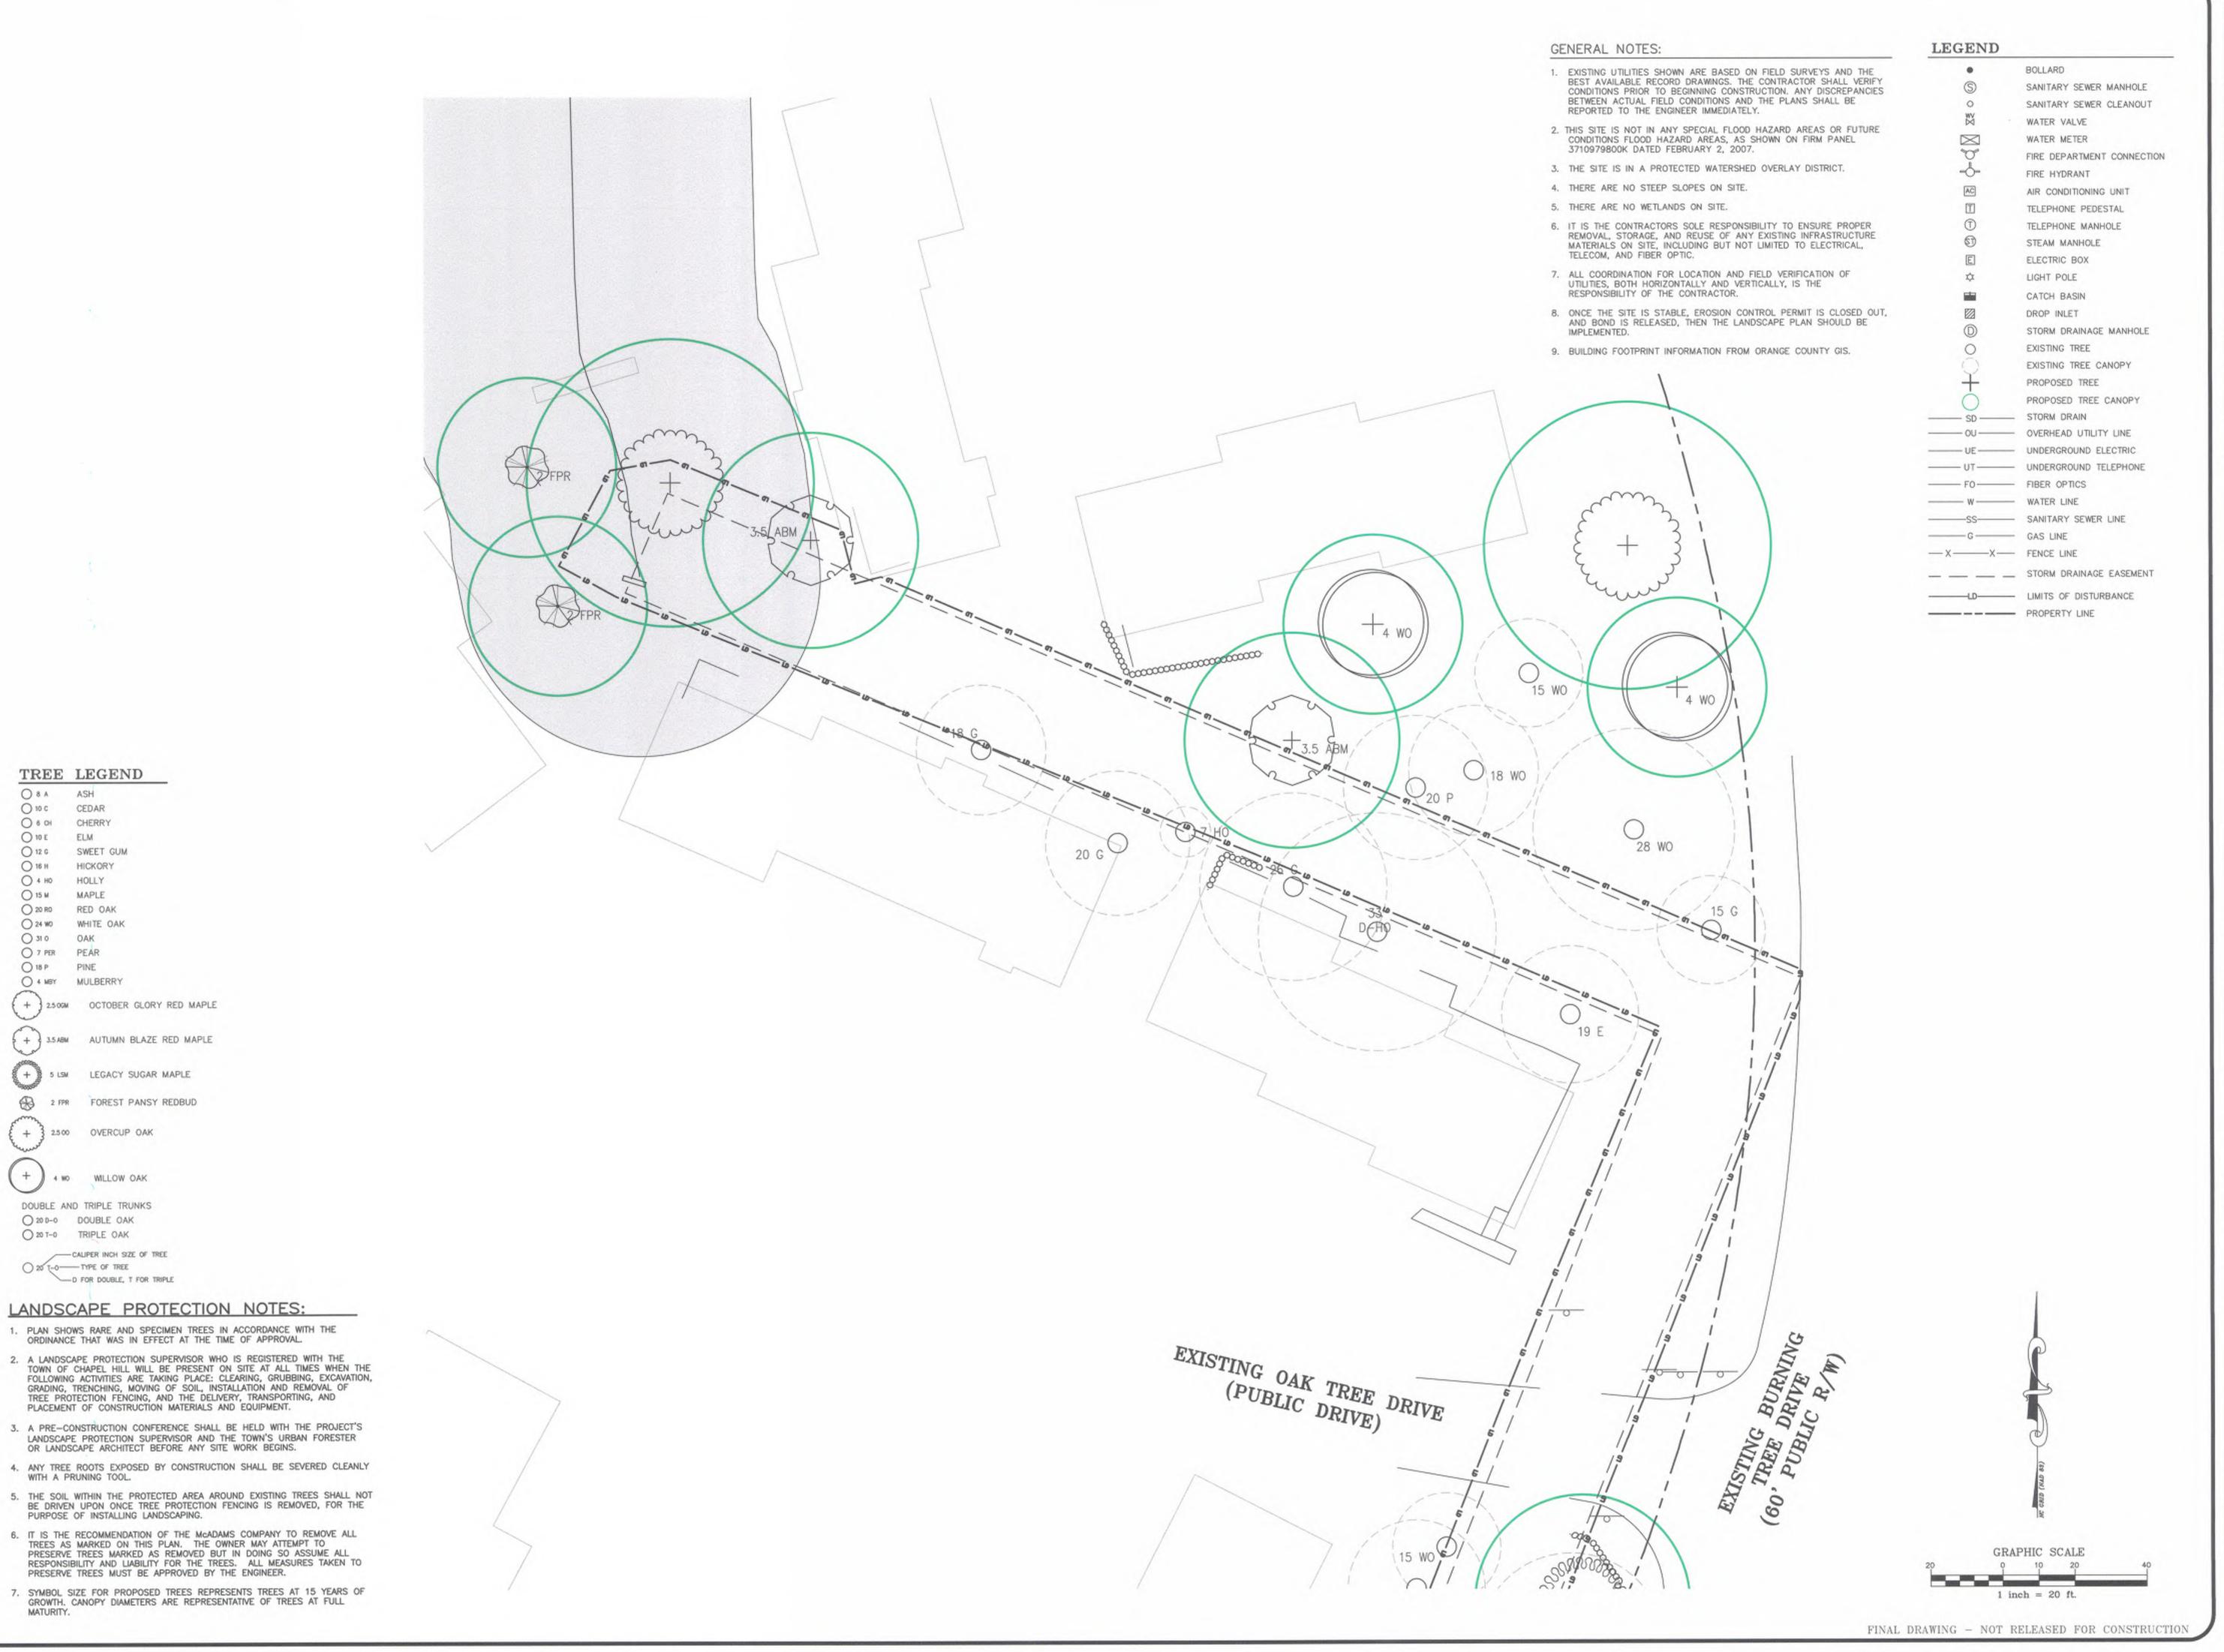

TREE LEGEND

ELM O 12 G SWEET GUM

HICKORY

MAPLE

OAK

RED OAK

2500 OVERCUP OAK

4 WO WILLOW OAK

CALIPER INCH SIZE OF TREE

D FOR DOUBLE, T FOR TRIPLE

DOUBLE AND TRIPLE TRUNKS O 20 0-0 DOUBLE OAK O 20 T-0 TRIPLE OAK

O 20 T-0-TYPE OF TREE

WITH A PRUNING TOOL.

MATURITY.

O 8 A ASH O 10 C CEDAR O 6 OH CHERRY

O 4 HO HOLLY

O 7 PER PEAR O 18 P PINE O 4 MBY MULBERRY

O 24 WO WHITE OAK

○ 10 E

O 16 H

○ 15 M

O 20 R0

O 21 0

INCORPORATED RINGTON ROAD, SUITE 10 CAS, 5915 FA

PROJECT NO. CAS-10000 FILENAME: CAS10000-L CHECKED BY: DAC/DAF SMP/NB 1" = 20' 07-24-2018

LS-3 **■** McAdams