

TOWN OF CHAPEL HILL Planning Department

405 Martin Luther King Jr. Blvd. Chapel Hill, NC 27514-5705

phone (919) 969-5066 fax (919) 969-2014 www.townofchapelhill.org

Community Design Commission Final Plan Application

This application should be used to submit Final Plan applications to the Community Design Commission including building elevations, site lighting, and alternative buffers. For assistance with this application, please contact the Chapel Hill Planning Department at (919) 969-5066 or at planning@townofchapelhill.org.

| Section A: Propert | y Information | | | | |
|---------------------|--------------------------------------------------------------------------------|-------------|------------------------|-------------|------------------|
| Property Address: | 123 Old Mason Farm Roa | d | | | |
| Zoning: | OI-2 | | | | |
| Type of Application | | | | | |
| Building Elevation | on 🗌 Al | ternative B | suffers | | |
| Section B: Applica | nt Information (for contact | purposes |) | | |
| Name: | MHAworks; Attn: Charlie | Tennant | | | |
| Address: | 501 Washington Street, Suite G | | | | |
| City: | Durham | State: | NC | Zip Code: | 27701 |
| Phone Number: | 9196822870 | Email: | ctennant@mhaworks.co | m | |
| = :: | olicant hereby certifies that: a) thorized staff; and c) to the bend accurate. | | | ormation su | pplied with this |
| | | | Parcel Identifier Numb | er (PINI) | 9788543697 |

The Community Design Commission meets regularly on the fourth Tuesday of each month. For confirmation of a meeting date and the placement of your request on the agenda, please contact the Planning Department at (919) 969-5066.

Final Plan Application

Please submit 2 sets of all materials, no later than the fourth Tuesday of the month prior to the meeting by 4 p.m. <u>Materials must be collated and folded to fit into a 12" x 15" envelope</u>. The Application Fee shall be submitted with this Application Form.

DETAILED SUMMARY OF REQUIRED INFORMATION

X 1. Application fee (refer to fee schedule) Amount Paid \$ 790

2. Digital files – provide digital files of all plans and documents

3. Approved Site Plan

The site plan for the development, as approved by the Town Council, or when applicable, the Planning Board, clearly indicating all building footprints, parking areas, sidewalks, and buffers. In particular, the site plan shall clearly indicate the specific buildings that are included in the application for building elevations approval. Finished first floor elevation (height above sea level) information shall also be provided for each building, including any applicable cross section elevation changes.

4. Detailed Exterior Building Elevations – The detailed exterior elevations shall include the following:

a) Detailed Building Elevations

- A detailed list including all materials, textures, and colors for each building. If all buildings are the same, a combined list of materials, texture, and colors is acceptable. All windows, doors, light fixtures, and other appurtenant features must indicate type, style, and color.
- A straight-on, one-dimensional view of each building façade including front, side, and rear elevations.
- Color renderings, sketches, or perspective drawings.

The applicant should bring samples of all colors and materials to the Design Commission Meeting.

b) Cross-Sections

• Provide simple, typical cross-section(s) indicating how the buildings are placed on the site in relationship to topography, public access, existing vegetation, or other significant site features.

c) Floor Plans

• Show the general interior layout of the building (this aids in understanding window locations, etc.) and the relationship of pedestrian circulation and entryways.

d) Other

• Indicate the location of all HVAC, chiller, and/or ventilation units. Show how these units will be screened from the view of any relevant public rights-of-way.

All detailed building elevation plans must be the <u>final</u> versions. Any subsequent elevation modifications or changes in materials, color, etc., must be resubmitted for approval. If the Design Commission makes decisions based on any renderings, sketches, or artists' drawings presented at the meeting, these graphics will become the property of the Town and will need to be submitted for the formal record

5. Lighting Plans

- a) <u>Site Lighting Plan</u>: A detailed lighting plan for <u>all</u> proposed lighting fixtures on the site (including parking areas, pedestrian paths, building facades, landscape uplighting, etc.). The lighting plan should clearly indicate the locations of <u>all</u> light fixtures. The lighting plan shall also provide isographs with foot-candle and uniform ratios, candlepower of lamps, and types of illumination for all proposed lighting fixtures. The isographs shall be provided for the full extent of the site lighting (to the point where the lighting reaches 0.0 foot-candles), even if this includes off-site areas. The isograph shall be calculated with 100% lighting, and also identify and incorporate a site's topography.
- b) <u>Cut Sheets</u>: A detailed drawing and description shall be provided for each type of light fixture proposed on the site. The number, height, colors, and materials for each type of fixture shall be clearly indicated.

Please note that in accordance with Section 5.11 (Lighting Standards) of the Town's Land Use Management Ordinance, lighting sources shall be shielded or arrange so as not to produce, within any public right-of-way, glare that interferes with the safe use of such right-of-way or constitutes a nuisance to the occupants of adjacent properties.

Χ

Χ

Χ


Х

| For information on illuminating canopies, please refer to the Community Design Commission's " | Design |
|-----------------------------------------------------------------------------------------------|--------|
| Standards for Canopies," which is available from the Chapel Hill Planning Department. | |

6. Alternative Buffer

a) <u>Landscaping Plan</u>: A detailed planting plan, including a plant materials table that indicates the number, size, and spacing for each plant type.

b) Other: If a fence or wall is proposed as part of the alternative buffer, a scaled drawing or rendering shall be submitted, along with a list including all materials, textures, and colors. The applicant should bring samples of such materials to the Design Commission meeting.

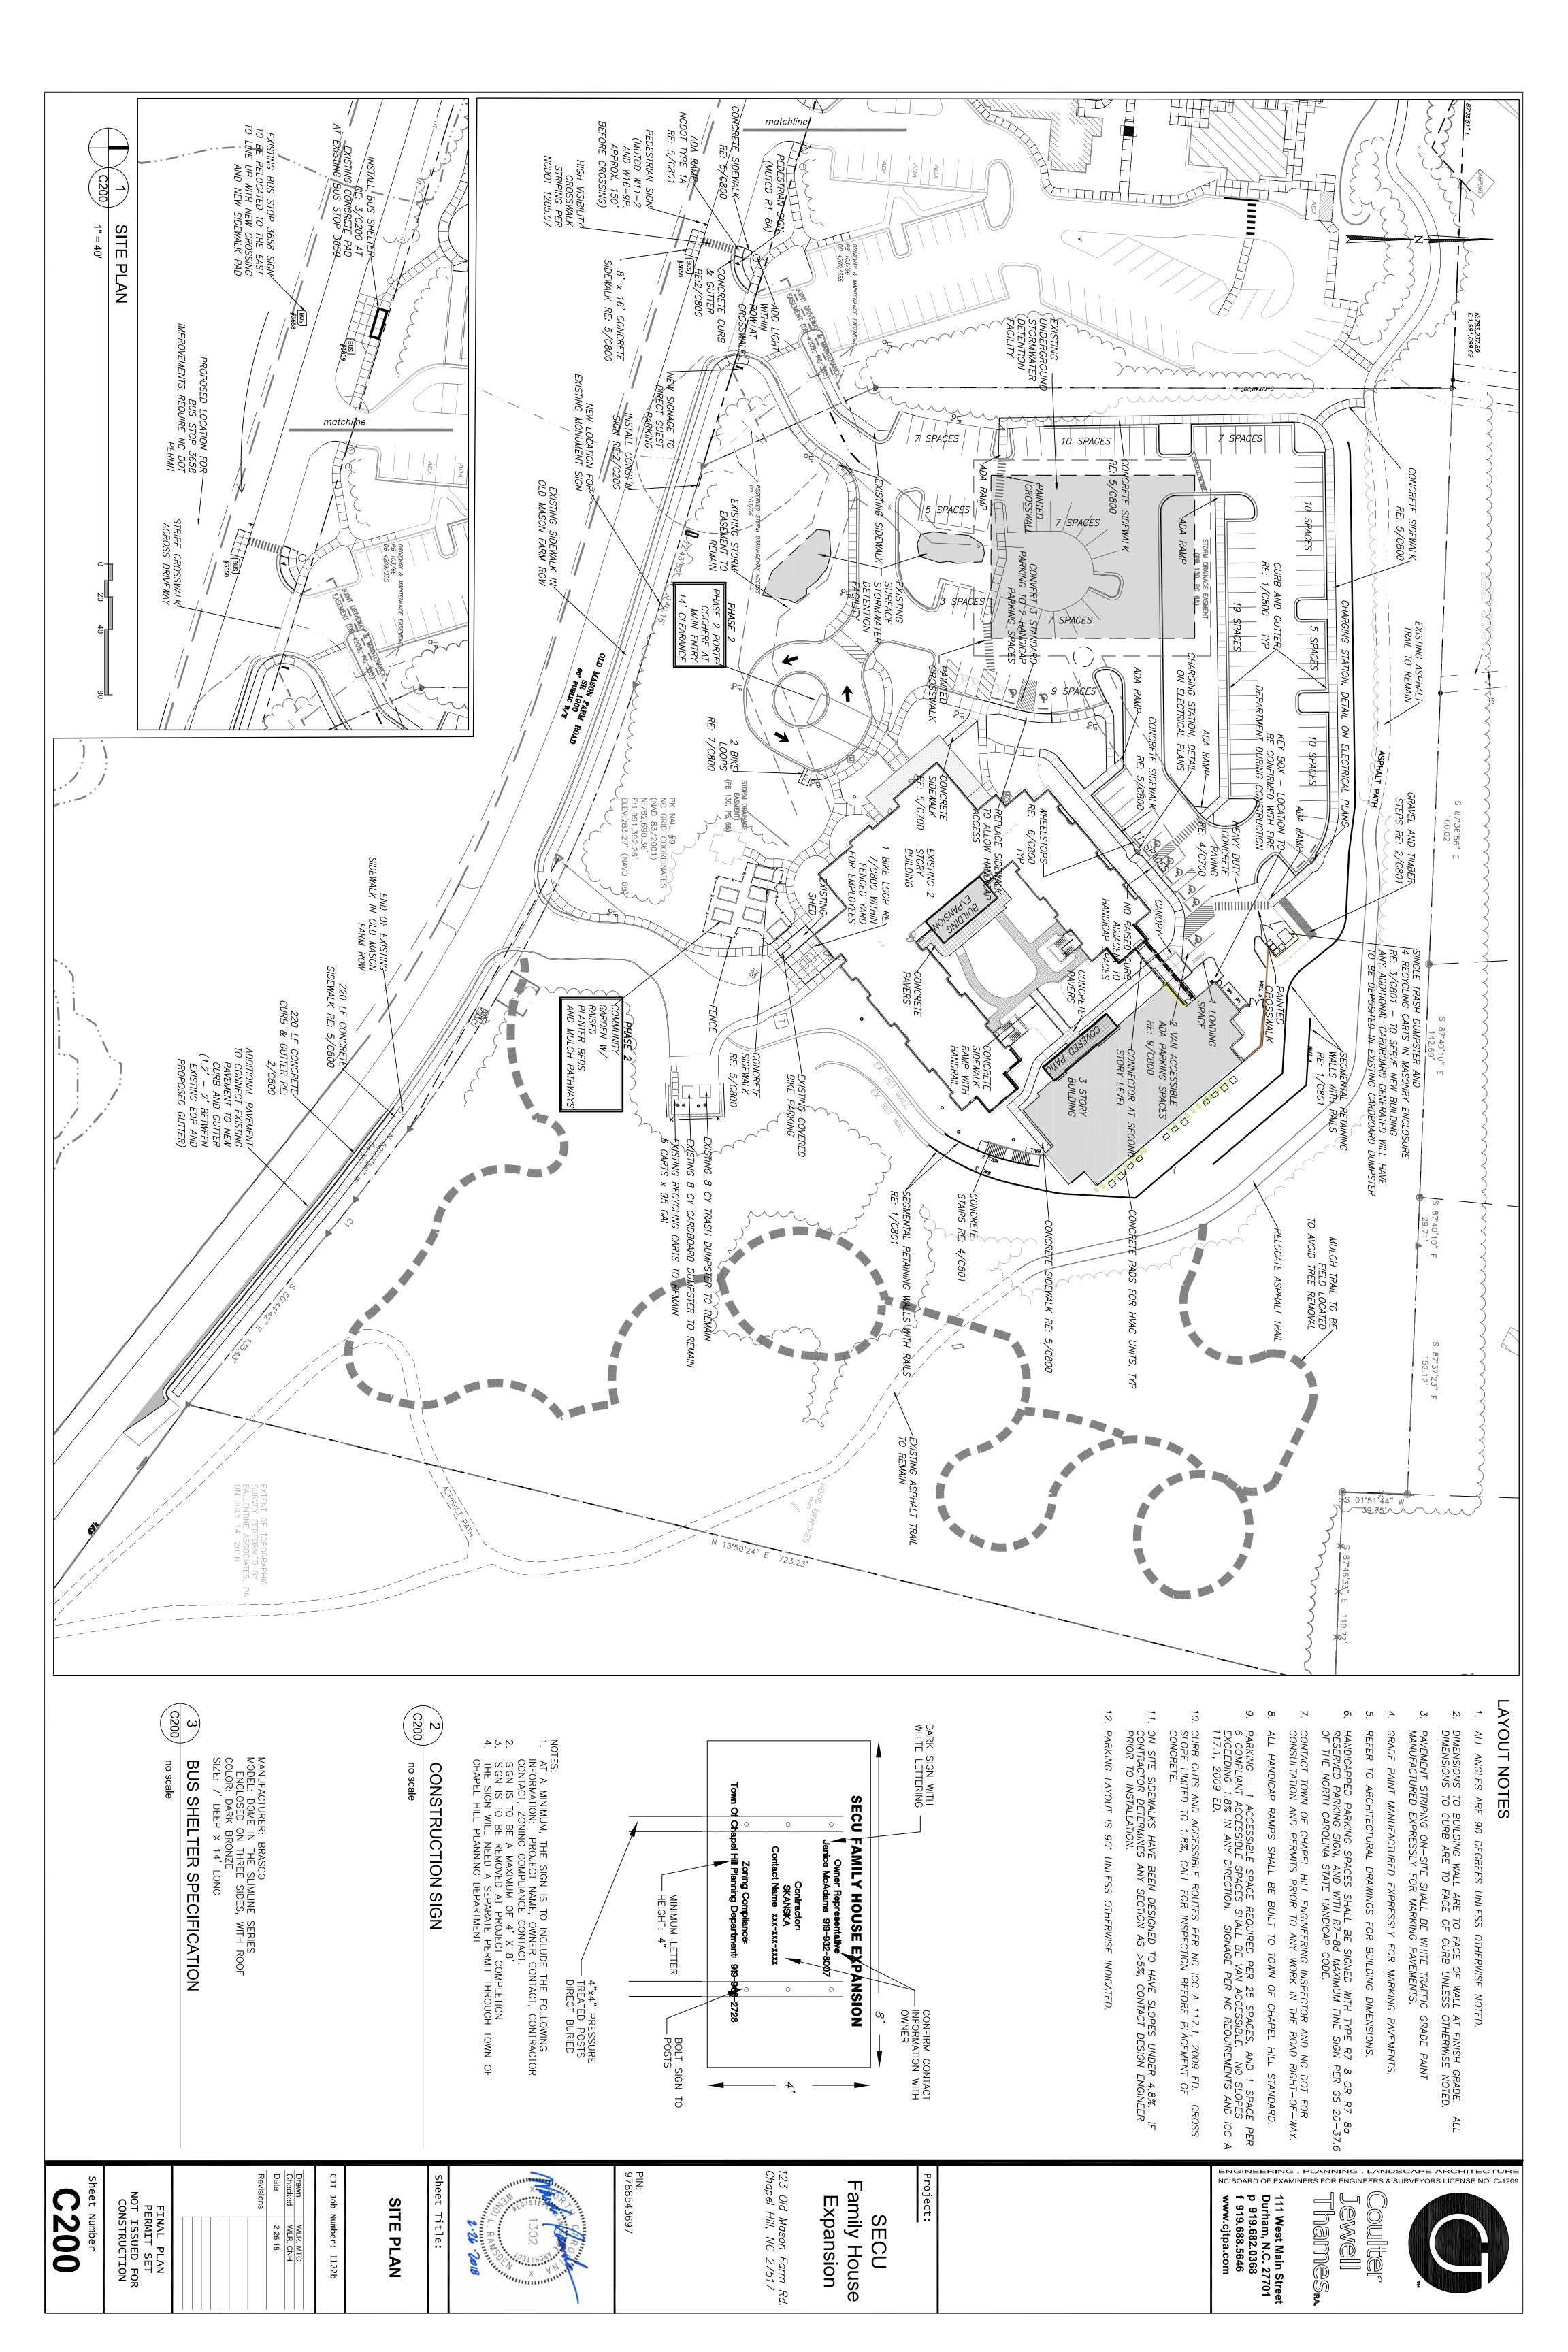

DRAWINGS AND THE ACCOMPANYING SPECIFICATIONS INSTRUMENTS OF SERVICE AND AS SUCH SHALL REMAIN ROPERTY OF THE ARCHITECT. HEY HAVE BEEN PREPARED OR A SPECIFIC PROJECT AND SHALL NOT BE USED IN JUNCTION WITH ANY OTHER PROJECTS WITHOUT PRIOR WRITTEN PERMISSION OF THE ARCHITECT.

SHEET NAME:
RENDERED PERSPECTIVE VIEW

PHASE: Final Plan Application

REVISIONS:

ISSUE DATE: **02/27/18**

PROJECT #: 15084
DRAWN BY: C.TENNANT

SHEET NUMBER

7CP3 0





MATERIAL: Fiber-Cement Siding COLOR: MATCH EXISTING STYLE: VERTICAL SIDING PANEL NOTE: Primary Field Siding













COLOR: BROWN





07 4646 Asphalt Roof Shingle



04 2113 Cast Stone Wall Cap MATERIAL: Cast Stone



UM3 04 2000 Brick Paver MANUFACTURER: MATCH EXISTING MATERIAL: BRICK MASONRY



05 7300 Metal Handrail MATERIAL: Stainless Steel



05 7300 Metal Handrail MATERIAL: Stainless Steel FINISH: Black



08 5230 Aluminum Clad Wood Windows MANUFACTURER: MATCH EXISTING YPE: MATCH EXISTING COLOR: MATCH EXISTING FINISH: MATCH EXISTING

08 8000 Glazing DESCRIPTION: Heat Strengthened Insulated Glass


MANUFACTURER: Guardian TYPE: SunGuard SNX 51/23 SIZE: 1" Unit Width NOTE: Temper as indicated on Elevations



08 4113 & Storefronts MANUFACTURER: OLD CASTLE BUILDING ENVELOPE TYPE: FG-3000 CENTER SET SIZE: 2" x 4 1/2" COLOR: MATCH EXISTING FINISH: POWDER COAT FINISH LOCATION: PRIMARY INTERIOR

GL1

DESCRIPTION: Heat Strengthened Insulated Glass MANUFACTURER: Guardian TYPE: SunGuard SNX 51/23 SIZE: 1" Unit Width NOTE: Temper as indicated on Elevations

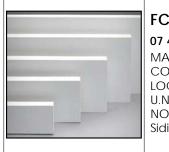


07 4646 Fiber-Cement Trim MATERIAL: Fiber-Cement Trim COLOR: WHITE LOCATION: PRIMARY EXTERIOR TRIM NOTE: Primary Trim for Windows and





MATERIAL: WOOD STYLE: WOOD FENCING NOTE: SEE CIVIL SITE PLAN

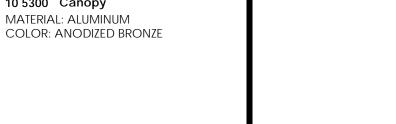



SHEET NUMBER

ARE INSTRUMENTS OF SERVICE AND AS SUCH SHALL REMAIN
THE PROPERTY OF THE ARCHITECT. THEY HAVE BEEN PREPARED
FOR A SPECIFIC PROJECT AND SHALL NOT BE USED IN
CONJUNCTION WITH ANY OTHER PROJECTS WITHOUT PRIOR
WRITTEN PERMISSION OF THE ARCHITECT.
©-MHAWORKS 2015

SHEET NAME:

ELEVATIONS

REVISIONS:

OVERALL BUILDING

FINAL PLAN APPLICATION

amily

ELEVATION AT ENTRY PORCH

1/8" = 1'-0"

1

SOUTH ELEVATION

1/8" = 1'-0"

5

UM2

TILE COLOR: To Match Existing TILE STYLE: To Match Existing NOTE: Primary Roofing Shingle










LOCATION: PRIMARY EXTERIOR WINDOW TYPE U.N.O.

NOTE: INSULATED GLASS - LOW E3 W/ ARGON







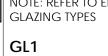

08 8000 Glazing








FINAL PLAN APPLICATION

REVISIONS:

ISSUE DATE: **02/27/18**PROJECT #: **15084**DRAWN BY: **C.TENNANT** SHEET NUMBER



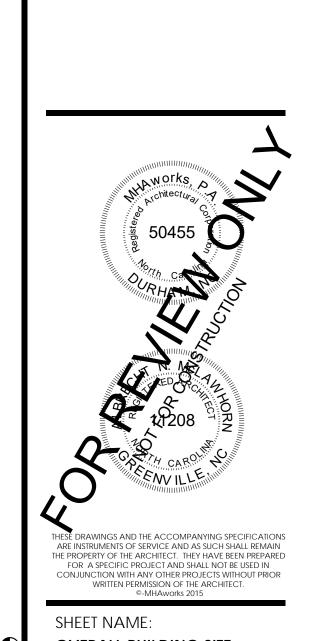

OVERALL BUILDING SITE SECTIONS

REVISIONS:

ISSUE DATE: 02/27/18
PROJECT #: 15084
DRAWN BY: KJ

OVERALL SITE SECTION

3/32" = 1'-0"

1

SHEET NUMBER ZCP2.1



FLOOR PLAN - OVERALL

PHASE:
FINAL PLAN APPLICATION


REVISIONS:


REVISIONS:


ISSUE DATE: 02/27/18
PROJECT #: 15084
DRAWN BY: KJ

SHEET NUMBER

ZCP1.0

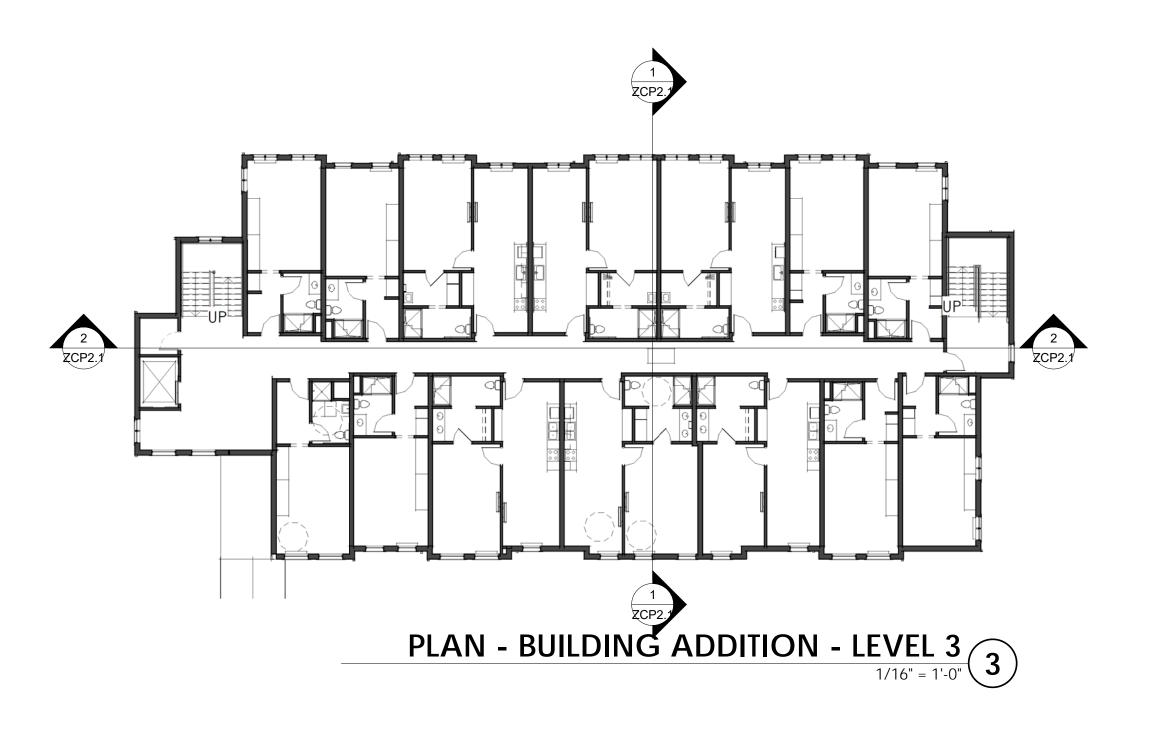

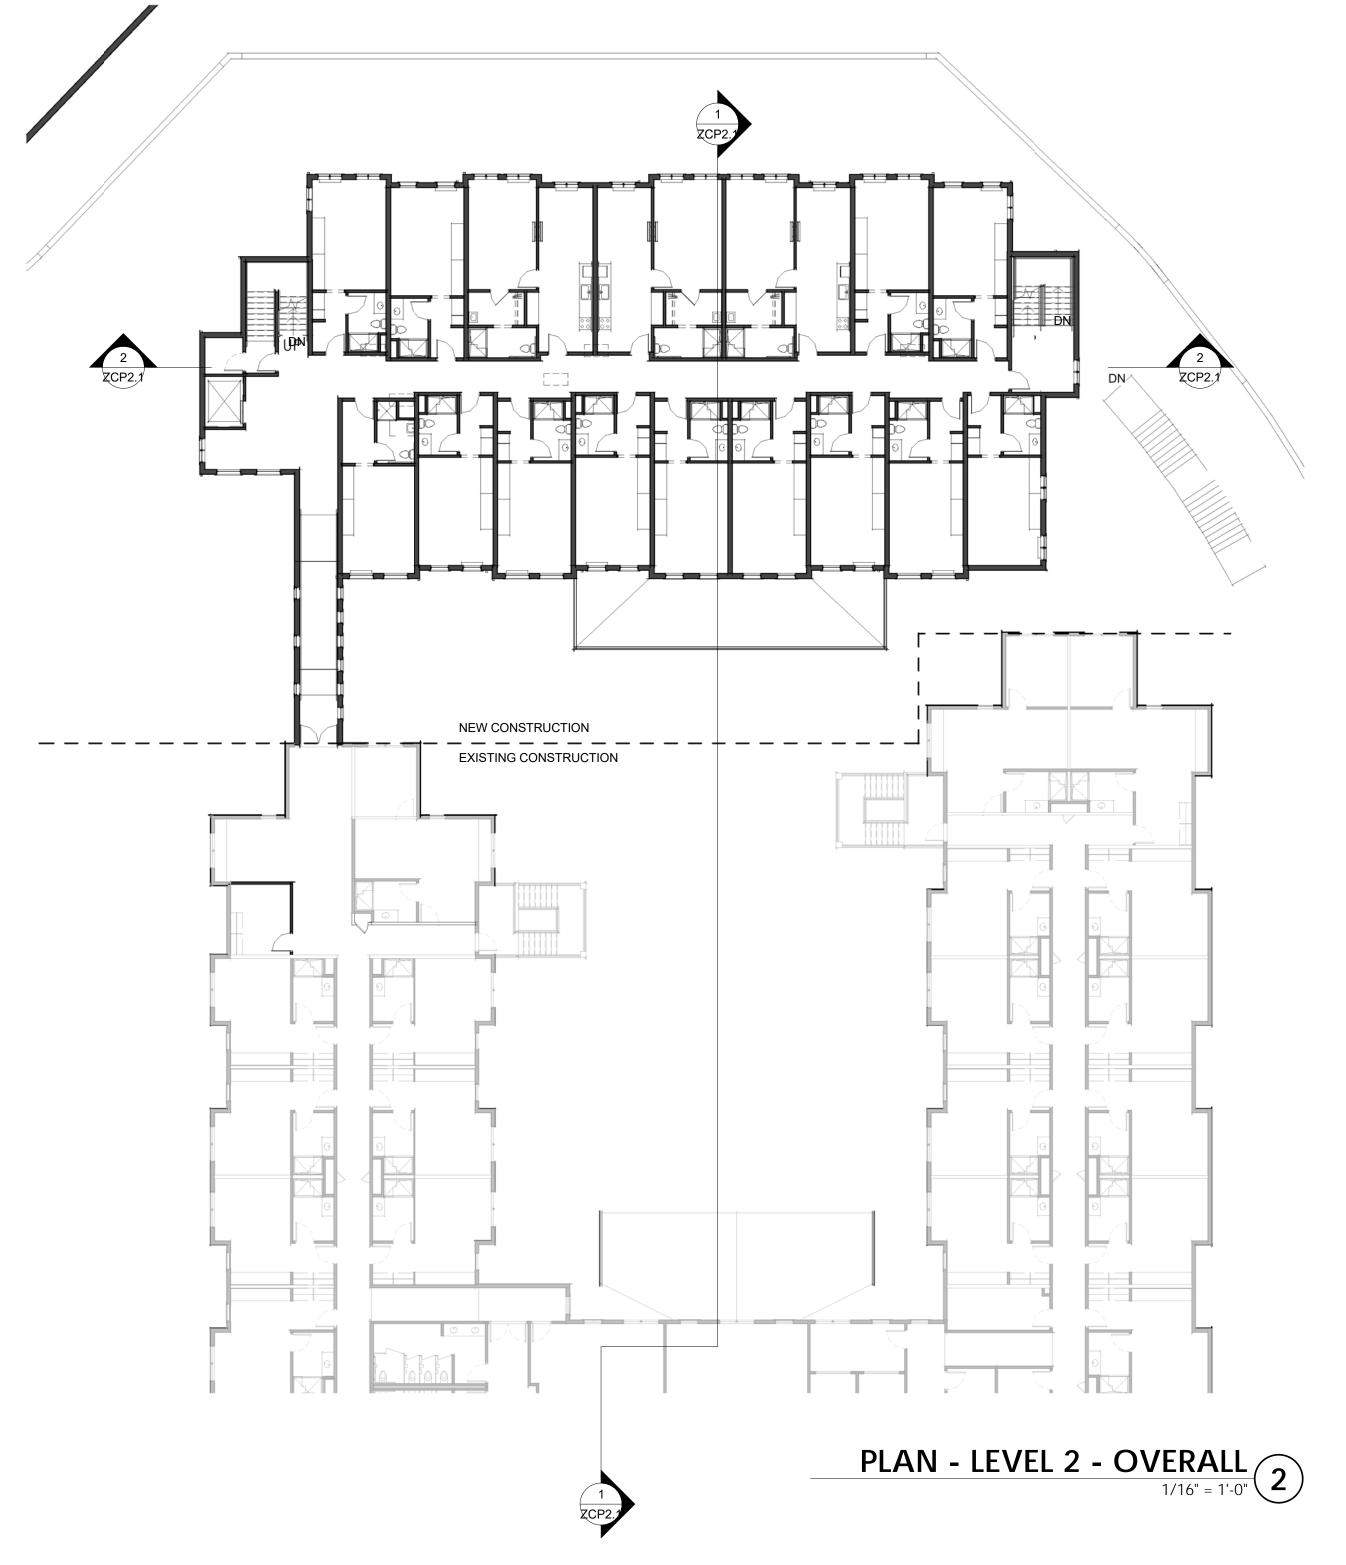

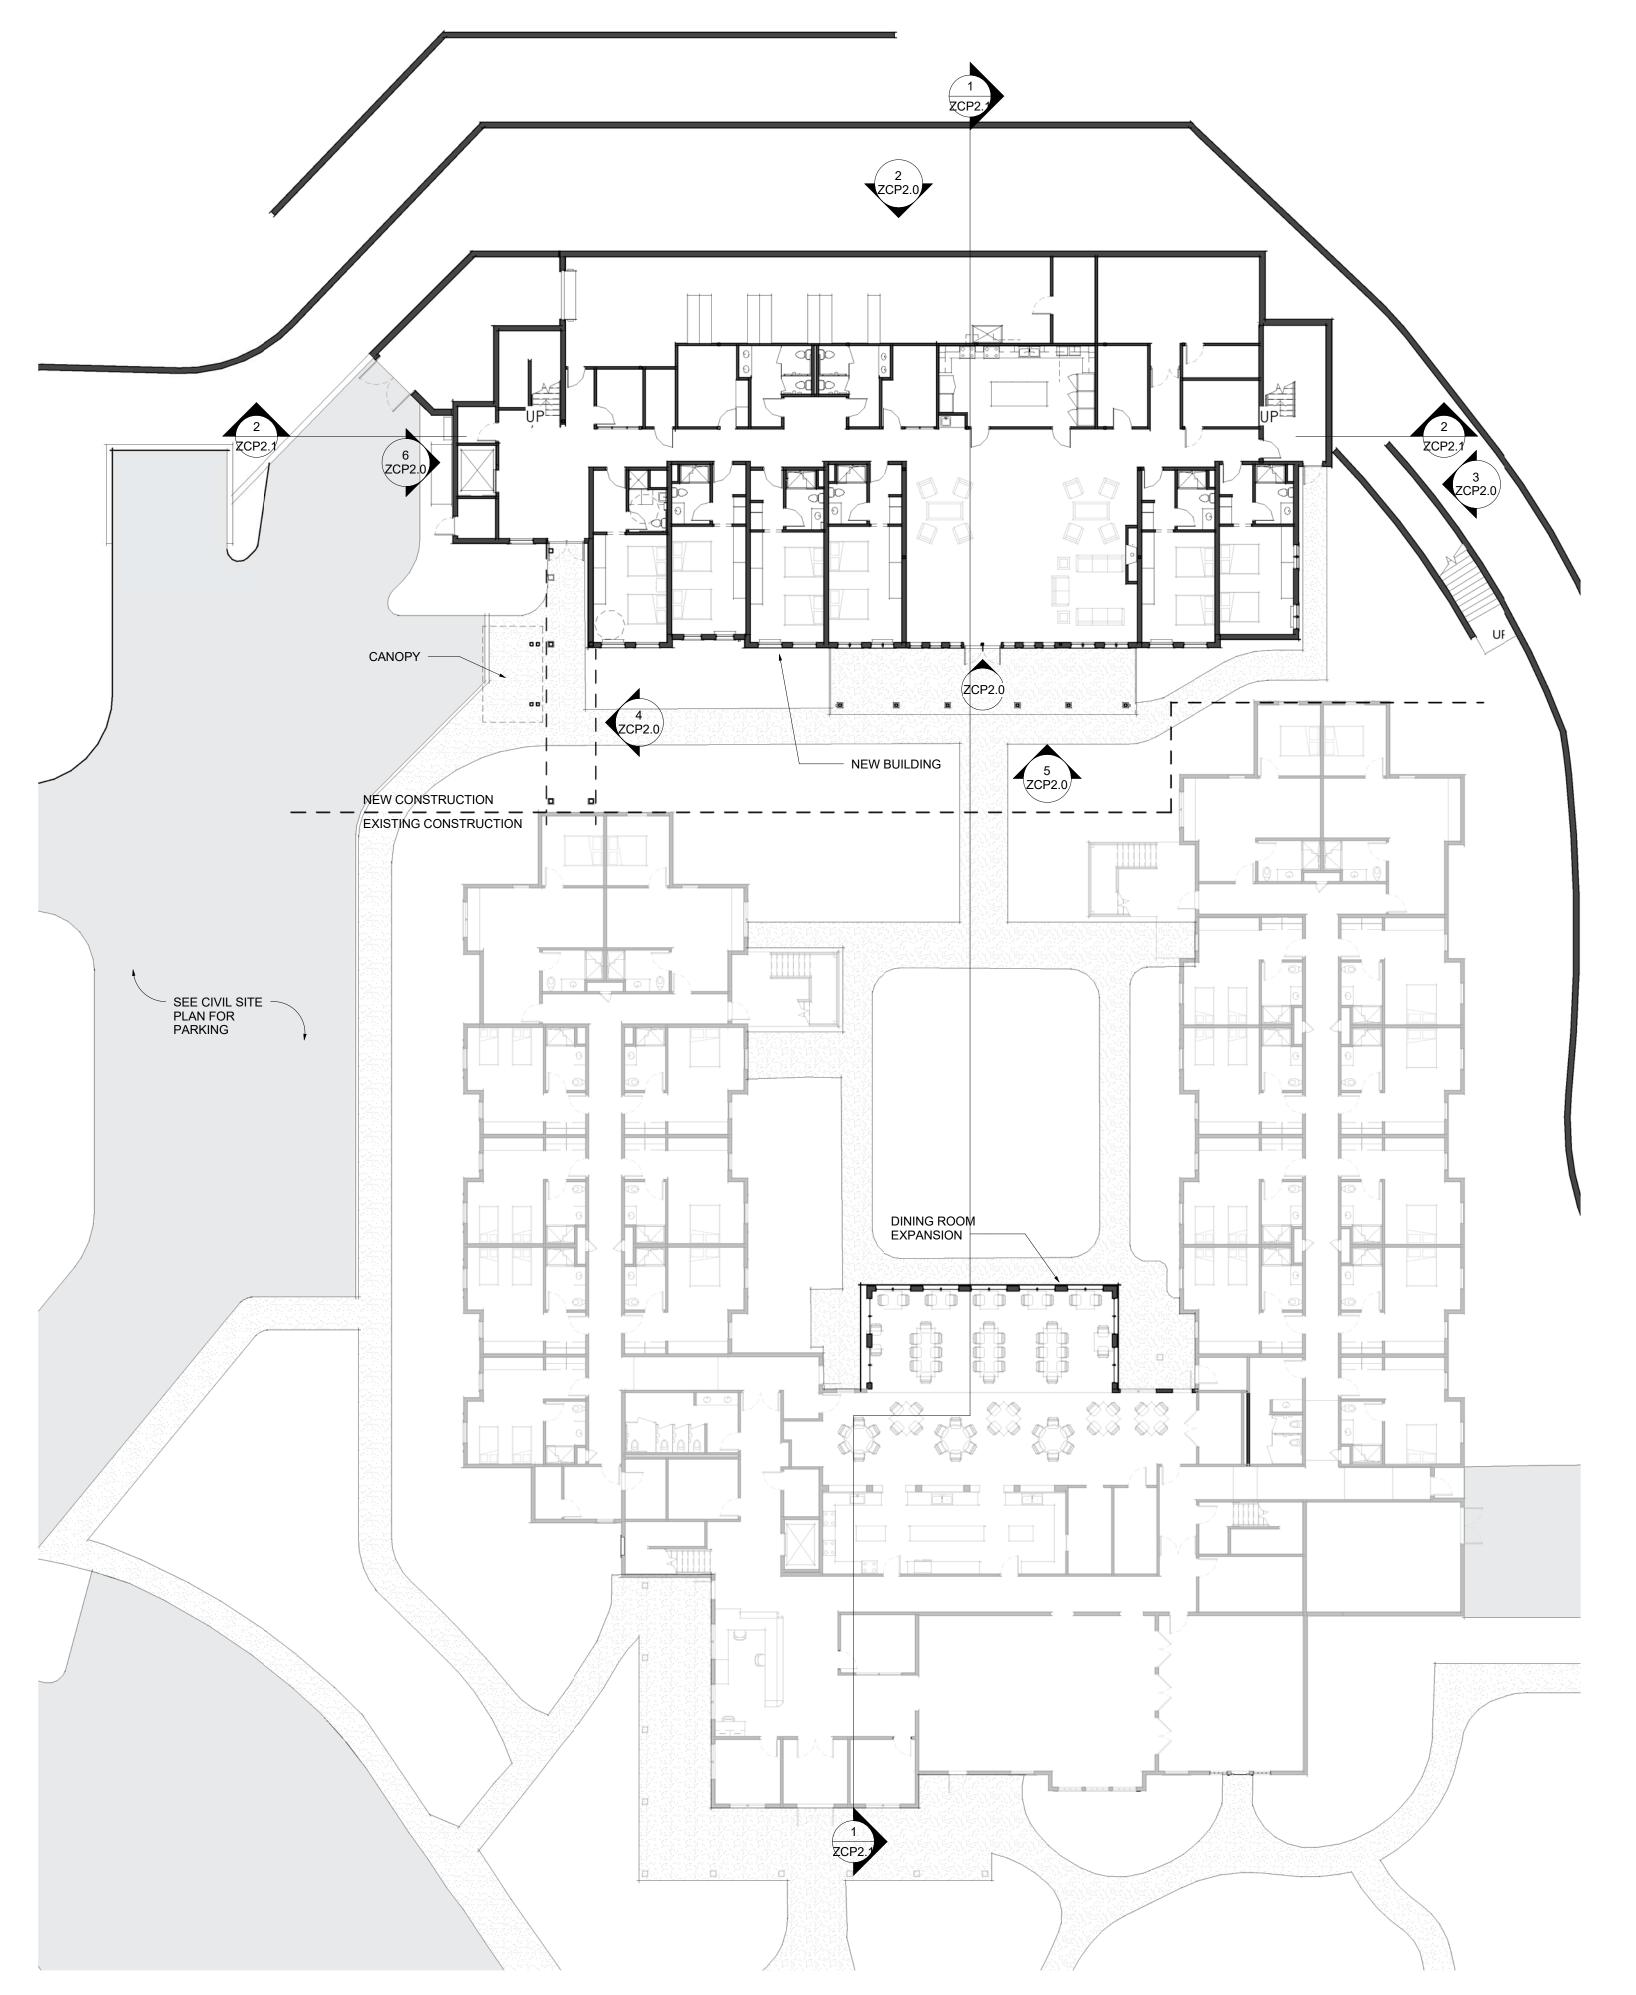

PLAN - LEVEL 1 - OVERALL

1/16" = 1'-0"

1