

## CONDITIONAL ZONING OF GATEWAY


PREPARED FOR:
NORTHVIEW PARTNERS


6131 FALLS OF THE NEUSE ROAD
SUITE 202
RALEIGH, NC 27609

J-30773.0001



PREPARED BY:

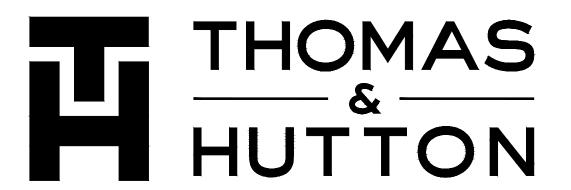

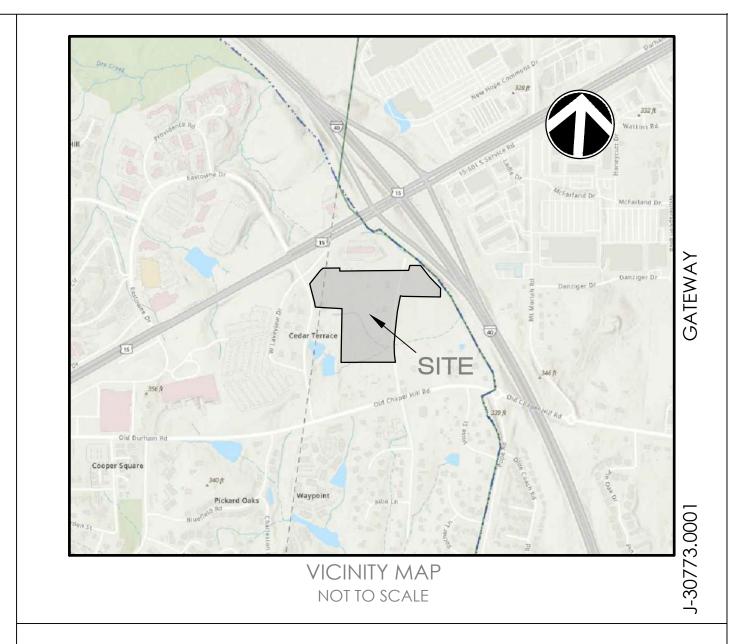





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PARCELS:

PARCEL A OWNER(S): PIN:		PARCEL B OWNER(S): PIN:	JTC IV LLC 9799994937 (Orange side)
DEED BOOK:	9890-90-52-6128.DO (Durham side) 6786 / 712	DEED BOOK:	9890-90-52-7784.DO (Durham side) 6786 / 712
PARCEL C OWNER(S): PIN: DEED BOOK:		PARCEL D OWNER(S): PIN: DEED BOOK:	REDWING JOCO LLC 9890-90-81-4582 9354 / 599
PARCEL E OWNER(S): PIN: DEED BOOK:	REDWING JOCO LLC 0800-00-12-5860 9354 / 599	PARCEL F OWNER(S): PIN: DEED BOOK:	REDWING JOCO LLC 0800-00-12-4064 9354 / 599
PARCEL G OWNER(S): PIN:	ENNIS RICHARD CALDWELL JR 0800-00-11-3370	PARCEL H OWNER(S): PIN: DEED BOOK:	REDWING JOCO LLC 0800-00-10-2025 9354 / 599
PARCEL I OWNER(S): PIN:	2729 / 460  REDWING JOCO LLC  9799-99-88-4004	PARCELJ OWNER(S): PIN: DEED BOOK:	DUVAL JUDITH POE 0709-09-18-0371 1061 / 781
• •	9354 / 556  APL CAPITAL LLC 0709-09-06-9881 9684 / 880	PARCEL L OWNER(S): PIN: DEED BOOK:	REDWING JOCO LLC 9799-99-85-3851 9646 / 729
PARCEL M OWNER(S): PIN:	ROBERT H SMITH REVOCABLE 0709-09-05-9350	PARCEL N OWNER(S): PIN: DEED BOOK:	APL CAPITAL LLC 9799-99-84-3831 9684 / 885

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## RESOURCE CONSERVATION NOTES

STREAM BUFFERS:
THERE IS A MAPPED STREAM AND ASSOCIATED STREAM
BUFFER LOCATED ON SITE. A DETERMINATION WAS
COMPLETED BY CHAPEL HILL PUBLIC WORKS TO VERIFY
THAT THE STREAM SHOWING UP ON THE ORANGE COUNTY
SOIL SURVEY EXISTS.

FLOODPLAIN PROTECTION:
THE SITE IS NOT AFFECTED BY A MAPPED FLOODPLAIN
ACCORDING TO FIRM MAPS 3710979900L, 3710989000M,
3720080000L, AND 3720070900K DATED 10/19/18.

STEEP SLOPE PROTECTION: THERE ARE STEEP SLOPES ON SITE.

THERE ARE MAPPED WETLANDS ONSITE.

WETLANDS:

TREE PROTECTION: REFER TO SHEET EX1.1 AND EX1.2.

## TOWN OF CHAPEL HILL NOTES

PARCEL O

OWNER(S): ROBERT H. SMITH

DEED BOOK: 3158 / 874

PIN: 0800-00-41-8958

REV. LIVING TRUST

- 1. A FIRE FLOW REPORT SHALL BE SUBMITTED TO THE TOWN FOR REVIEW AND APPROVAL PRIOR TO ISSUANCE OF A ZCP.
- 2. P.E. CERTIFICATION: PRIOR TO THE ISSUANCE OF A CERTIFICATE OF OCCUPANCY FOR ANY PHASE, THE APPLICANT SHALL PROVIDE A CERTIFICATION, SIGNED AND SEALED BY A NORTH CAROLINA-LICENSED PROFESSIONAL ENGINEER, THAT THE STORMWATER MANAGEMENT FACILITY IS CONSTRUCTED IN ACCORDANCE WITH THE APPROVED PLANS AND SPECIFICATIONS.
- 3. AS-BUILT PLANS: PRIOR TO THE ISSUANCE OF A CERTIFICATE OF OCCUPANCY, THE APPLICANT SHALL PROVIDE CERTIFIED AS-BUILT PLANS FOR BUILDING FOOTPRINTS, PARKING LOTS, STREET IMPROVEMENTS, STORM DRAINAGE SYSTEMS AND STORMWATER MANAGEMENT STRUCTURES, AND ALL OTHER IMPERVIOUS SURFACES, AND A TALLY OF THE CONSTRUCTED IMPERVIOUS AREA. THE AS-BUILT PLANS SHOULD BE IN DXF BINARY FORMAT USING STATE PLANE COORDINATES AND NAVD 88.
- 4. JORDAN SURETY: PRIOR TO ISSUANCE OF A CERTIFICATE OF OCCUPANCY, THE OWNER SHALL POST A MAINTENANCE BOND OR OTHER SURETY INSTRUMENT SATISFACTORY TO THE TOWN MANAGER, IN AN AMOUNT EQUAL TO ONE HUNDRED TWENTY-FIVE (125) PERCENT OF THE CONSTRUCTION COST OF EACH STORMWATER MANAGEMENT FACILITY TO ASSURE MAINTENANCE, REPAIR, OR RECONSTRUCTION NECESSARY FOR ADEQUATE PERFORMANCE OF THE STORMWATER MANAGEMENT FACILITY, OR ESTABLISH A STORMWATER MAINTENANCE (SINKING FUND) BUDGET AND ESCROW ACCOUNT IN ACCORDANCE WITH THE REQUIREMENTS OF SECTION 5.19 OF THE LAND USE MANAGEMENT ORDINANCE
- STORMWATER FACILITIES, EASEMENTS, AND OPERATIONS AND MAINTENANCE PLANS: ALL STORMWATER DETENTION, TREATMENT AND CONVEYANCE FACILITIES LOCATED ON AND BELOW THE GROUND SHALL BE WHOLLY CONTAINED WITHIN AN EASEMENT ENTITLED: "RESERVED STORMWATER FACILITY EASEMENT HEREBY DEDICATED" AND SHALL BE RESERVED FROM ANY DEVELOPMENT WHICH WOULD OBSTRUCT OR CONSTRICT THE EFFECTIVE MANAGEMENT, CONTROL, AND CONVEYANCE OF STORMWATER FROM OR ACROSS THE PROPERTY, OTHER THAN THE APPROVED DESIGN AND OPERATION FUNCTIONS. A COPY OF THE FINAL PLAT OR EASEMENT EXHIBIT, SIGNED AND SEALED BY A NORTH CAROLINA-REGISTERED LAND SURVEYOR AND RECORDED BY THE COUNTY REGISTER OF DEEDS, AND CONTAINING THE FOLLOWING NOTES SHALL BE SUBMITTED PRIOR TO ISSUANCE OF THE CERTIFICATE OF OCCUPANCY.
  - ALL ENGINEERED STORMWATER MANAGEMENT CONTROL, TREATMENT, AND CONVEYANCE STRUCTURES ON AND BELOW THE GROUND SHALL BE WHOLLY LOCATED
    WITHIN AN EASEMENT ENTITLED: "RESERVED STORMWATER FACILITY EASEMENT HEREBY DEDICATED" AND SHALL BE RESERVED FROM ANY DEVELOPMENT WHICH
    WOULD OBSTRUCT OR CONSTRICT THE EFFECTIVE MANAGEMENT, CONTROL, AND CONVEYANCE OF STORMWATER FROM OR ACROSS THE PROPERTY, OTHER THAN THE
    APPROVED DESIGN AND OPERATION FUNCTIONS. A SUITABLE MAINTENANCE ACCESS (MINIMUM 20' WIDE) TO ACCOMMODATE HEAVY EQUIPMENT FROM THE NEAREST
    PUBLIC RIGHT-OF-WAY TO THE RESERVED STORMWATER FACILITY EASEMENT MUST BE PROVIDED AND SHOWN ON THE PLANS.
  - THE "RESERVED STORMWATER FACILITY EASEMENT(S)" AND THE FACILITIES IT/THEY PROTECT ARE CONSIDERED TO BE PRIVATE, WITH THE SOLE RESPONSIBILITY OF THE OWNER TO PROVIDE FOR ALL REQUIRED MAINTENANCE AND OPERATIONS AS APPROVED BY THE TOWN MANAGER.
  - THE RESERVED STORMWATER FACILITY EASEMENT AND THE OPERATIONS AND MAINTENANCE PLAN ARE BINDING ON THE OWNER, HEIRS, SUCCESSORS, AND ASSIGNS.
- 6. JORDAN STORMWATER MANAGEMENT FOR NEW DEVELOPMENT: THAT PRIOR TO ISSUANCE OF A ZONING COMPLIANCE PERMIT, THE APPLICANT SHALL SUBMIT THE FINAL JORDAN ACCOUNTING TOOL SPREADSHEET, STORMWATER REPORT, AND PLANS FOR REVIEW AND APPROVAL BY THE TOWN MANAGER. THIS PROJECT MUST COMPLY WITH THE JORDAN STORMWATER MANAGEMENT REGULATIONS OF THE LAND USE MANAGEMENT ORDINANCE TO PROVIDE THE REQUIRED REDUCTIONS IN NITROGEN AND PHOSPHORUS LOADS FOR NEW DEVELOPMENT AND REDEVELOPMENT PROJECTS.
- 7. STORMWATER MANAGEMENT PLAN: THAT PRIOR TO THE ISSUANCE OF A ZONING COMPLIANCE PERMIT, THE APPLICANT SHALL SUBMIT A STORMWATER MANAGEMENT PLAN FOR REVIEW AND APPROVAL BY THE TOWN MANAGER. THIS PROJECT MUST COMPLY WITH THE STORMWATER MANAGEMENT REQUIREMENTS OF THE LAND USE MANAGEMENT ORDINANCE TO PROVIDE FOR 85 PERCENT TOTAL SUSPENDED SOLIDS REMOVAL FROM THE INCREASED IMPERVIOUS AREA, RETENTION FOR 2-5 DAYS OF THE INCREASED VOLUME OF STORMWATER RUNOFF FROM THE 2-YEAR, 24-HOUR STORM, AND CONTROL OF THE STORMWATER RUNOFF RATE FOR THE 1-YEAR, 2-YEAR, AND 25-YEAR STORMS.

## ORANGE COUNTY SOLID WASTE - CONSTRUCTION WASTE REQUIREMENTS:


- 1. ALL EXISTING STRUCTURES 500 SQUARE FEET AND LARGER SHALL BE ASSESSED PRIOR TO THE ISSUANCE OF A DEMOLITION PERMIT TO ENSURE COMPLIANCE WITH THE COUNTY'S REGULATED RECYCLABLE MATERIALS ORDINANCE (RRMO) AND TO ASSESS THE POTENTIAL FOR DECONSTRUCTION AND/OR THE REUSE OF SALVAGEABLE MATERIALS. CONTACT THE ORANGE COUNTY SW ENFORCEMENT OFFICER AT 919-968-2788 TO ARRANGE FOR THE ASSESSMENT.
- 2. PURSUANT TO THE COUNTY'S RRMO, CLEAN WOOD WASTE, SCRAP METAL, AND CORRUGATED CARDBOARD PRESENT IN CONSTRUCTION OR DEMOLITION WASTE MUST BE RECYCLED.
- 3. PURSUANT TO THE COUNTY'S RRMO, ALL HAULERS OF MIXED CONSTRUCTION AND DEMOLITION WASTE WHICH INCLUDES ANY REGULATED RECYCLABLE MATERIALS SHALL BE LICENSED BY ORANGE COUNTY.
- 4. PRIOR TO ANY DEMOLITION OR CONSTRUCTION ACTIVITY ON THE SITE, THE APPLICANT SHALL HOLD A PRE-DEMOLITION/PRE-CONSTRUCTION CONFERENCE WITH SOLID WASTE STAFF. THIS MAY BE THE SAME PRE-CONSTRUCTION MEETING HELD WITH OTHER DEVELOPMENT/ENFORCEMENT
- 5. THE PRESENCE IF ANY ASBESTOS CONTAINING MATERIALS ('ACM') AND/OR OTHER HAZARDOUS MATERIALS SHALL BE HANDLED IN ACCORDANCE WITH ANY AND ALL LOCAL, STATE, AND FEDERAL REGULATIONS AND GUIDELINES.


## TRANSPORTATION IMPROVEMENTS:

OFFICIALS.

- 1. A ROW RESERVATION HAS BEEN PROVIDED AT THE INTERSECTION OF LAKEVIEW AND NEW PUBLIC STREET A, FOR A POTENTIAL ROUND-A-BOUT IN THE
- 2. CONSTRUCT NEW TWO-LANE COLLECTOR STREET WITH SIDEWALK AS A CONNECTION FROM THE SITE TO LAKEVIEW DRIVE AND EXTEND TO INTERSECT WHITE OAK DRIVE, WITH FUTURE POTENTIAL EXTENSION TO THE EAST OF THE SITE.
- 3. UPGRADE THE EXISTING UNPAVED SECTION OF WHITE OAK DRIVE WITHIN THE LIMITS OF THE SITE PARCEL TO A LOCAL TWO-LANE STREET WITH MULTIOUSE PATH.
- 4. UPGRADE WHITE OAK DRIVE FROM THE SOUTHERN PROPERTY BOUNDARY TO OLD CHAPEL HILL ROAD TO PROVIDE TWO PAVED LANES WITHIN THE EXISTING RIGHT-OF WAY. THIS SECTION WILL BE FOR EMERGENCY ACCESS ONLY. THE DEVELOPER WILL POST SIGNAGE.
- 5. DEVELOPER WILL BUILD A VALLEY GUTTER AND ROLL CURB ACROSS WHITE OAK ROAD AT THE SITE BOUNDARY SO AS TO PERMIT FIRE TRUCKS, BUT DISSUADE GATEWAY RESIDENTS FROM USING IT.
- 6. THE DEVELOPER WILL FIX THE SUBGRADE AND PAVE AND STRIPE THE ROAD TO A MINIMUM OF 20 FT., INCLUDING STRIPING A 4 FT. WALKING PATH FOR THE PIECE OF N. WHITE OAK DRIVE SOUTH OF GATEWAY'S PROPERTY BOUNDARY AND UP TO OLD CHAPEL HILL ROAD. NO VERTICAL BOLLARDS ARE ALLOWED.
- 7. TO IMPROVE TRAFFIC OPERATIONS FOR THE EASTBOUND DIRECTION OF US 15-501 AT THE LAKEVIEW DRIVE / EASTOWNE DRIVE INTERSECTION, EXTEND THE EASTBOUND OUTER SHARED THROUGH/RIGHT-TURN LANE TO PROVIDE 450 FEET OF STORAGE TO HELP ACCOMMODATE A HIGH VOLUME OF TRAFFIC.

<u>ABBREVIATIONS</u>									
DBL	DOUBLE	FM	FORCE MAIN (SANITARY SEWER)		PC	POINT OF CURVE		TC	TOP OF CURB
BOT	воттом	FP	FINISH PAD		PH	POST HYDRANT		TH	THROAT ELEVATION
СВ	CATCH BASIN	FR	FRAME		PT	POINT OF TANGENT		TG	TOP OF GUTTER
CI	CURB INLET	Gl	GRATE INLET		PVC	POLYVINYL CHLORIDE		TP	TOP OF PAVEMENT
СО	CLEAN OUT	GV	GATE VALVE		RCP	REINFORCED CONCRETE PIPE		TW	TOP OF WALK
CPP	CORRUGATED PLASTIC PIPE	HDPE	HIGH DENSITY POLYETHYLENE		RC	ROLL CURB INLET		TYP	TYPICAL
DBL	DOUBLE	Н	HOODED INLET		RCP	REINFORCED CONCRETE PIPE		VI	VALLEY INLET
DI	DITCH INLET	INV	INVERT ELEVATION		RI	ROOF INLET		W	WATER
DIP	DUCTILE IRON PIPE	JB	JUNCTION BOX		RJP	restrained joint pipe		W/	WITH
EL	ELEVATION	LF	LINEAR FEET		R/W	RIGHT-OF-WAY		WV	WATER VALVE
ES	END SECTION	MAX	MAXIMUM		SD	STORM DRAINAGE		YI	YARD INLET
FES	FLARED END SECTION	MIN	MINIMUM		SDMH	STORM DRAINAGE MANHOLE		YI	YARD INLET
FG	FINISH GRADE	МН	MANHOLE		SF	SQUARE FEET			
FH	FIRE HYDRANT	ОС	ON CENTER		SS	SANITARY SEWER			

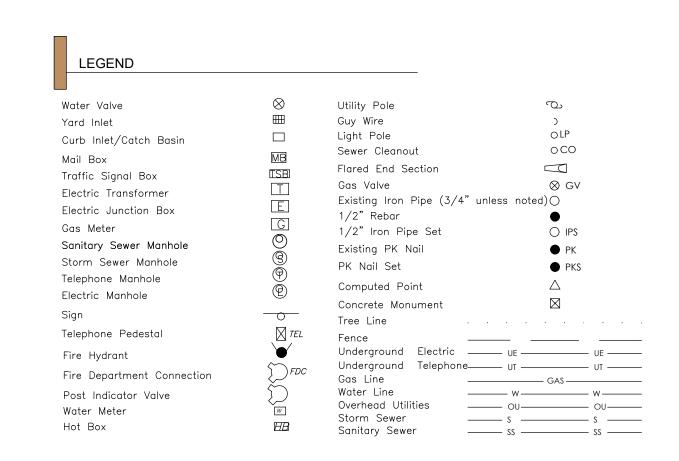

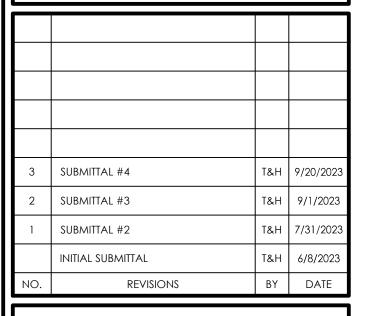





DURHAM, NC 27701

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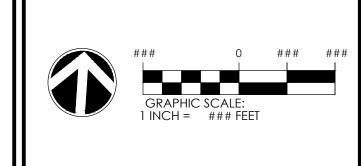
GENERAL NOTES & INDEX

GATEWAY

PROJECT LOCATION:
East Lakeview Drive


CLIENT/OWNER:
NorthView Partners


Chapel Hill, NC





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JOB NO:	30773.0001
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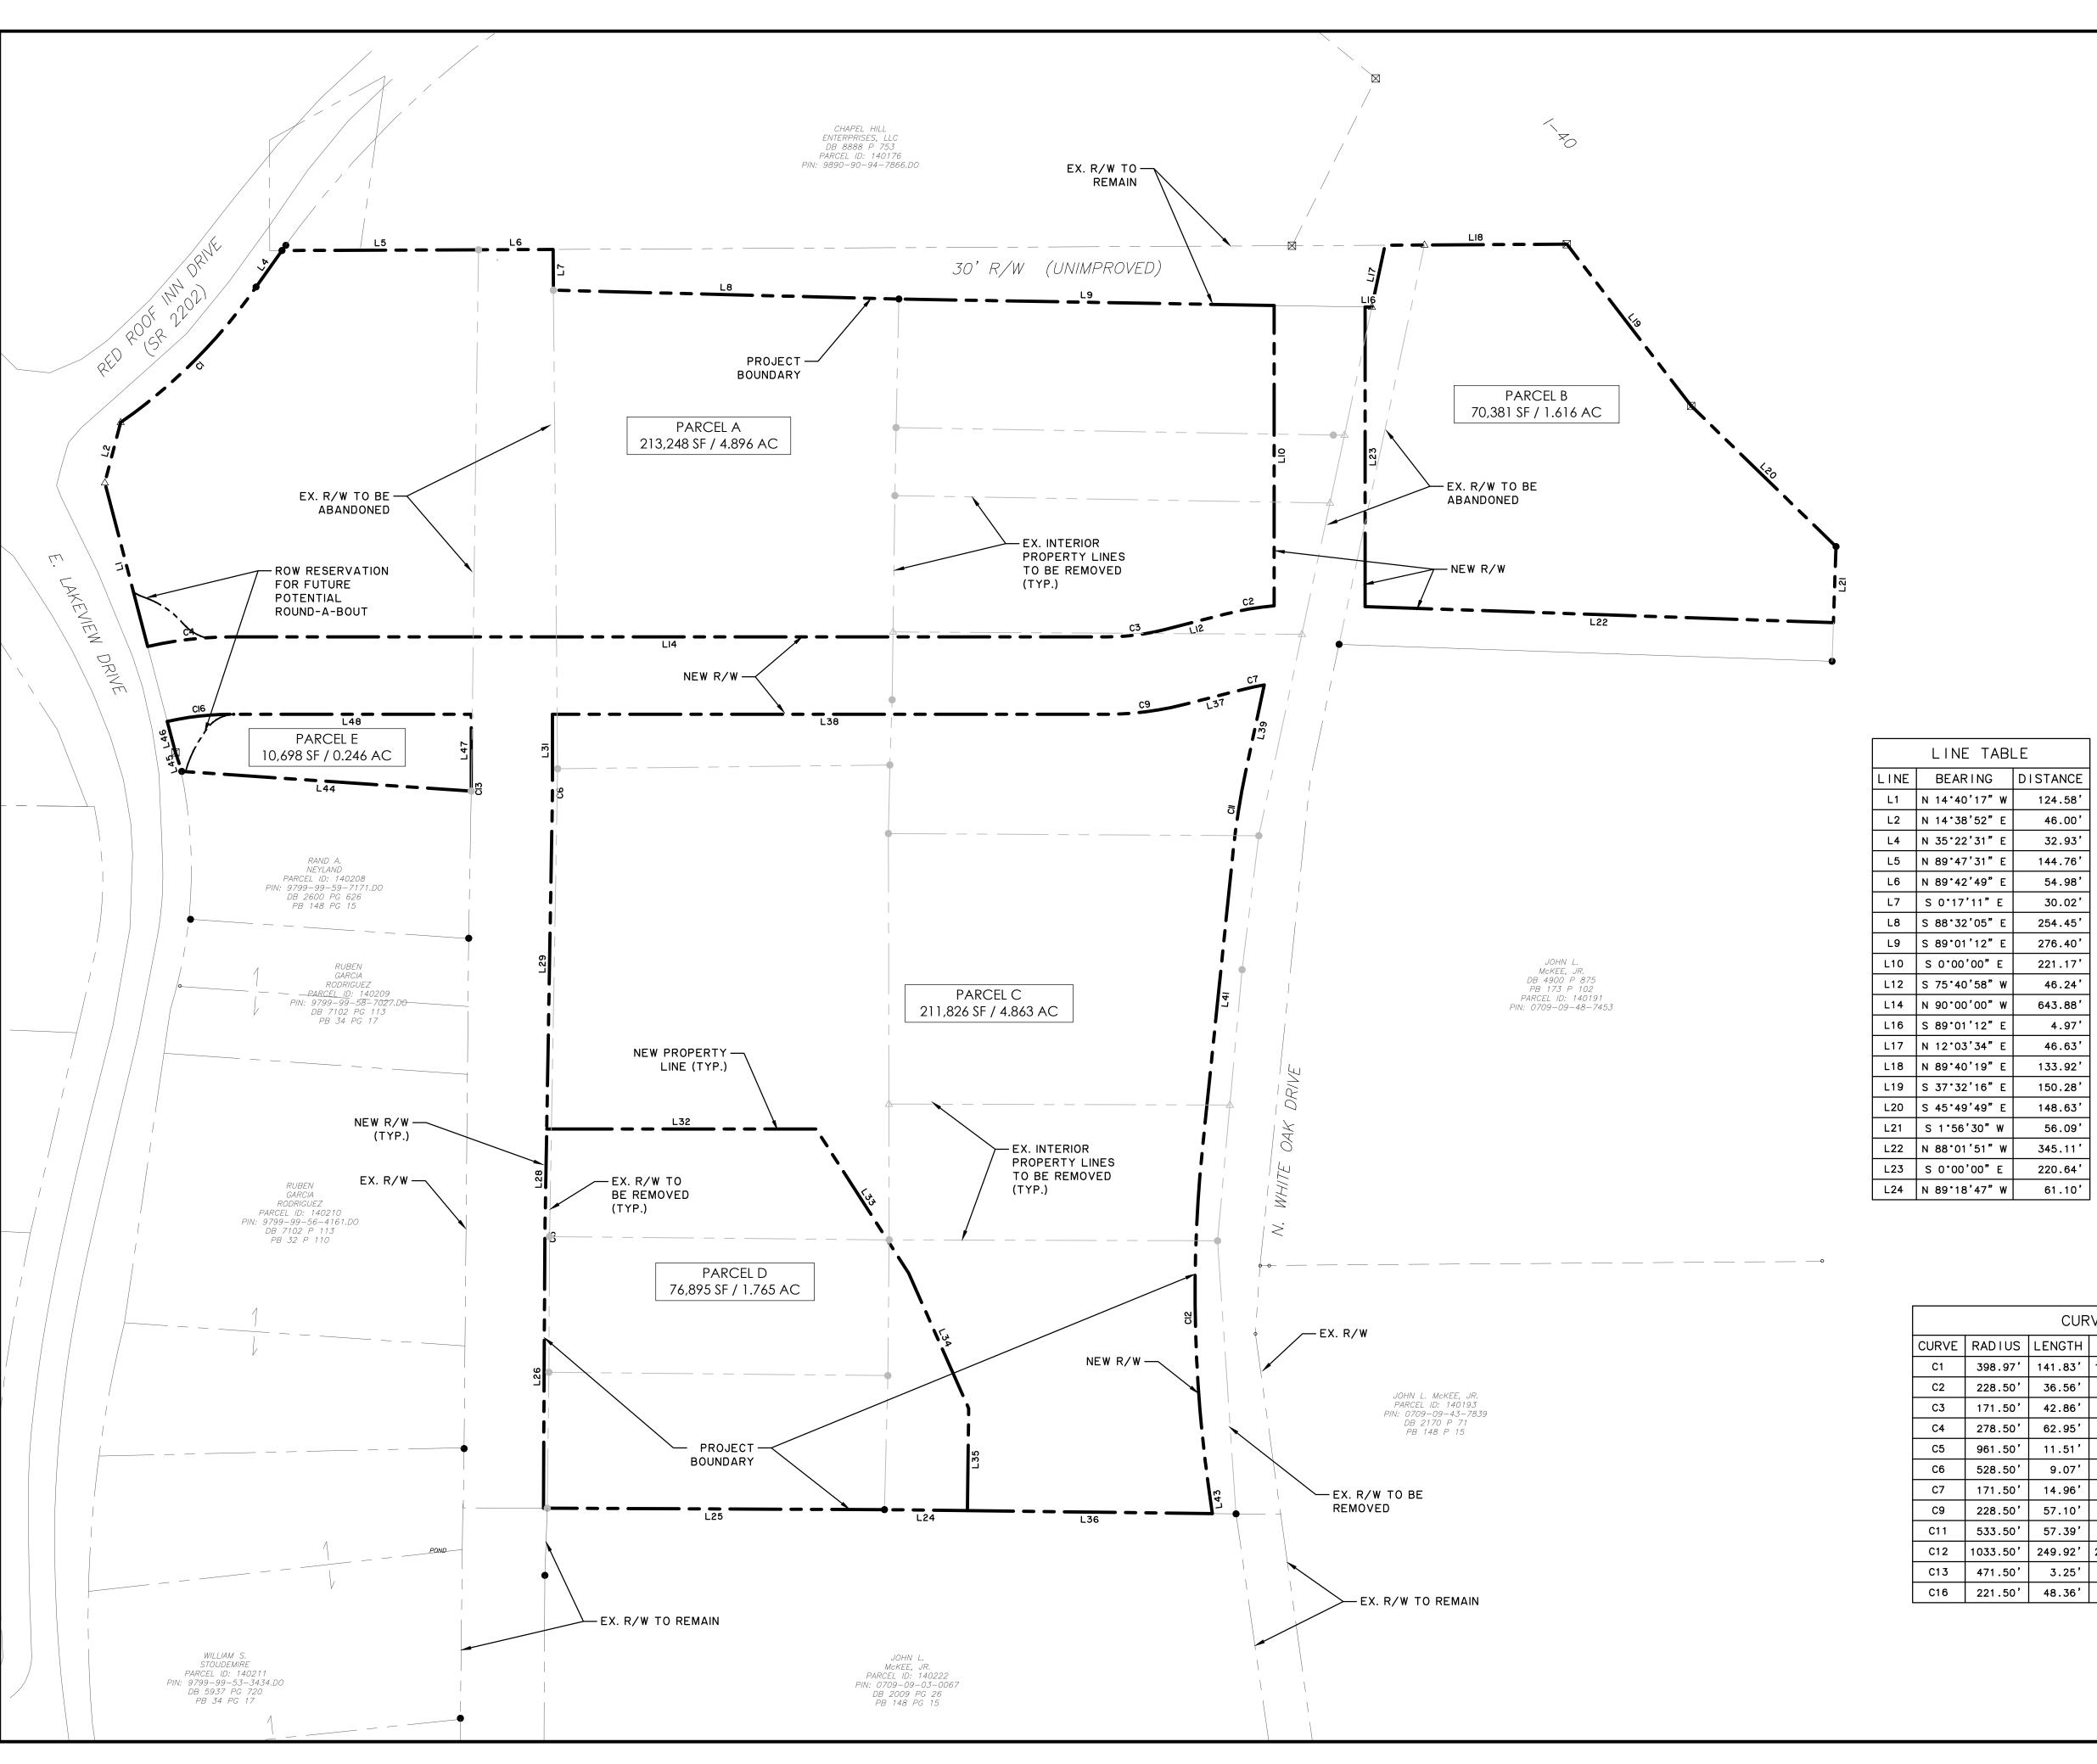
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	LINE TABI	_E
LINE	BEARING	DISTANCE
L1	N 14°40'17" W	124.58'
L2	N 14°38'52" E	46.00'
L4	N 35°22'31" E	32.93'
L5	N 89°47'31" E	144.76'
L6	N 89°42'49" E	54.98'
L7	S 0°17'11" E	30.02'
L8	S 88°32'05" E	254.45'
L9	S 89°01'12" E	276.40'
L10	S 0°00'00" E	221.17
L12	S 75°40'58" W	46.24'
L14	N 90°00'00" W	643.88
L16	S 89°01'12" E	4.97'
L17	N 12°03'34" E	46.63'
L18	N 89°40'19" E	133.92'
L19	S 37°32'16" E	150.28
L20	S 45°49'49" E	148.63'
L21	S 1°56'30" W	56.09
L22	N 88°01'51" W	345.11
L23	S 0°00'00" E	220.64
1.24	N 90*19'47" W	61 10'

LINE TABLE						
LINE	BEARING	DISTANCE				
L25	N 89°45'12" W	251.15'				
L26	N 0°17'51" E	193.95'				
L28	N 0°58'59" E	73.82'				
L29	N 0°58'59" E	243.09'				
L31	N 0°00'00" E	53.38'				
L32	N 90°00'00" E	198.41				
L33	S 32°42'20" E	126.26'				
L34	S 23°54'15" E	108.87				
L35	S 0°41'13" W	75.31'				
L36	N 89°18'47" W	180.35				
L37	S 75°40'58" W	46.24				
L38	N 90.00,00, M	408.20'				
L39	S 12°03'34" W	65.99'				
L41	S 5°53'44" W	221.30'				
L43	S 7°57'34" E	19.92'				
L44	N 86°06'47" W	213.66'				
L45	N 18°21'25" W	14.81'				
L46	N 14°40'17" W	23.55'				
L47	N 0°00'00" E	53.33'				
L48	N 90°00'00" W	175.84				

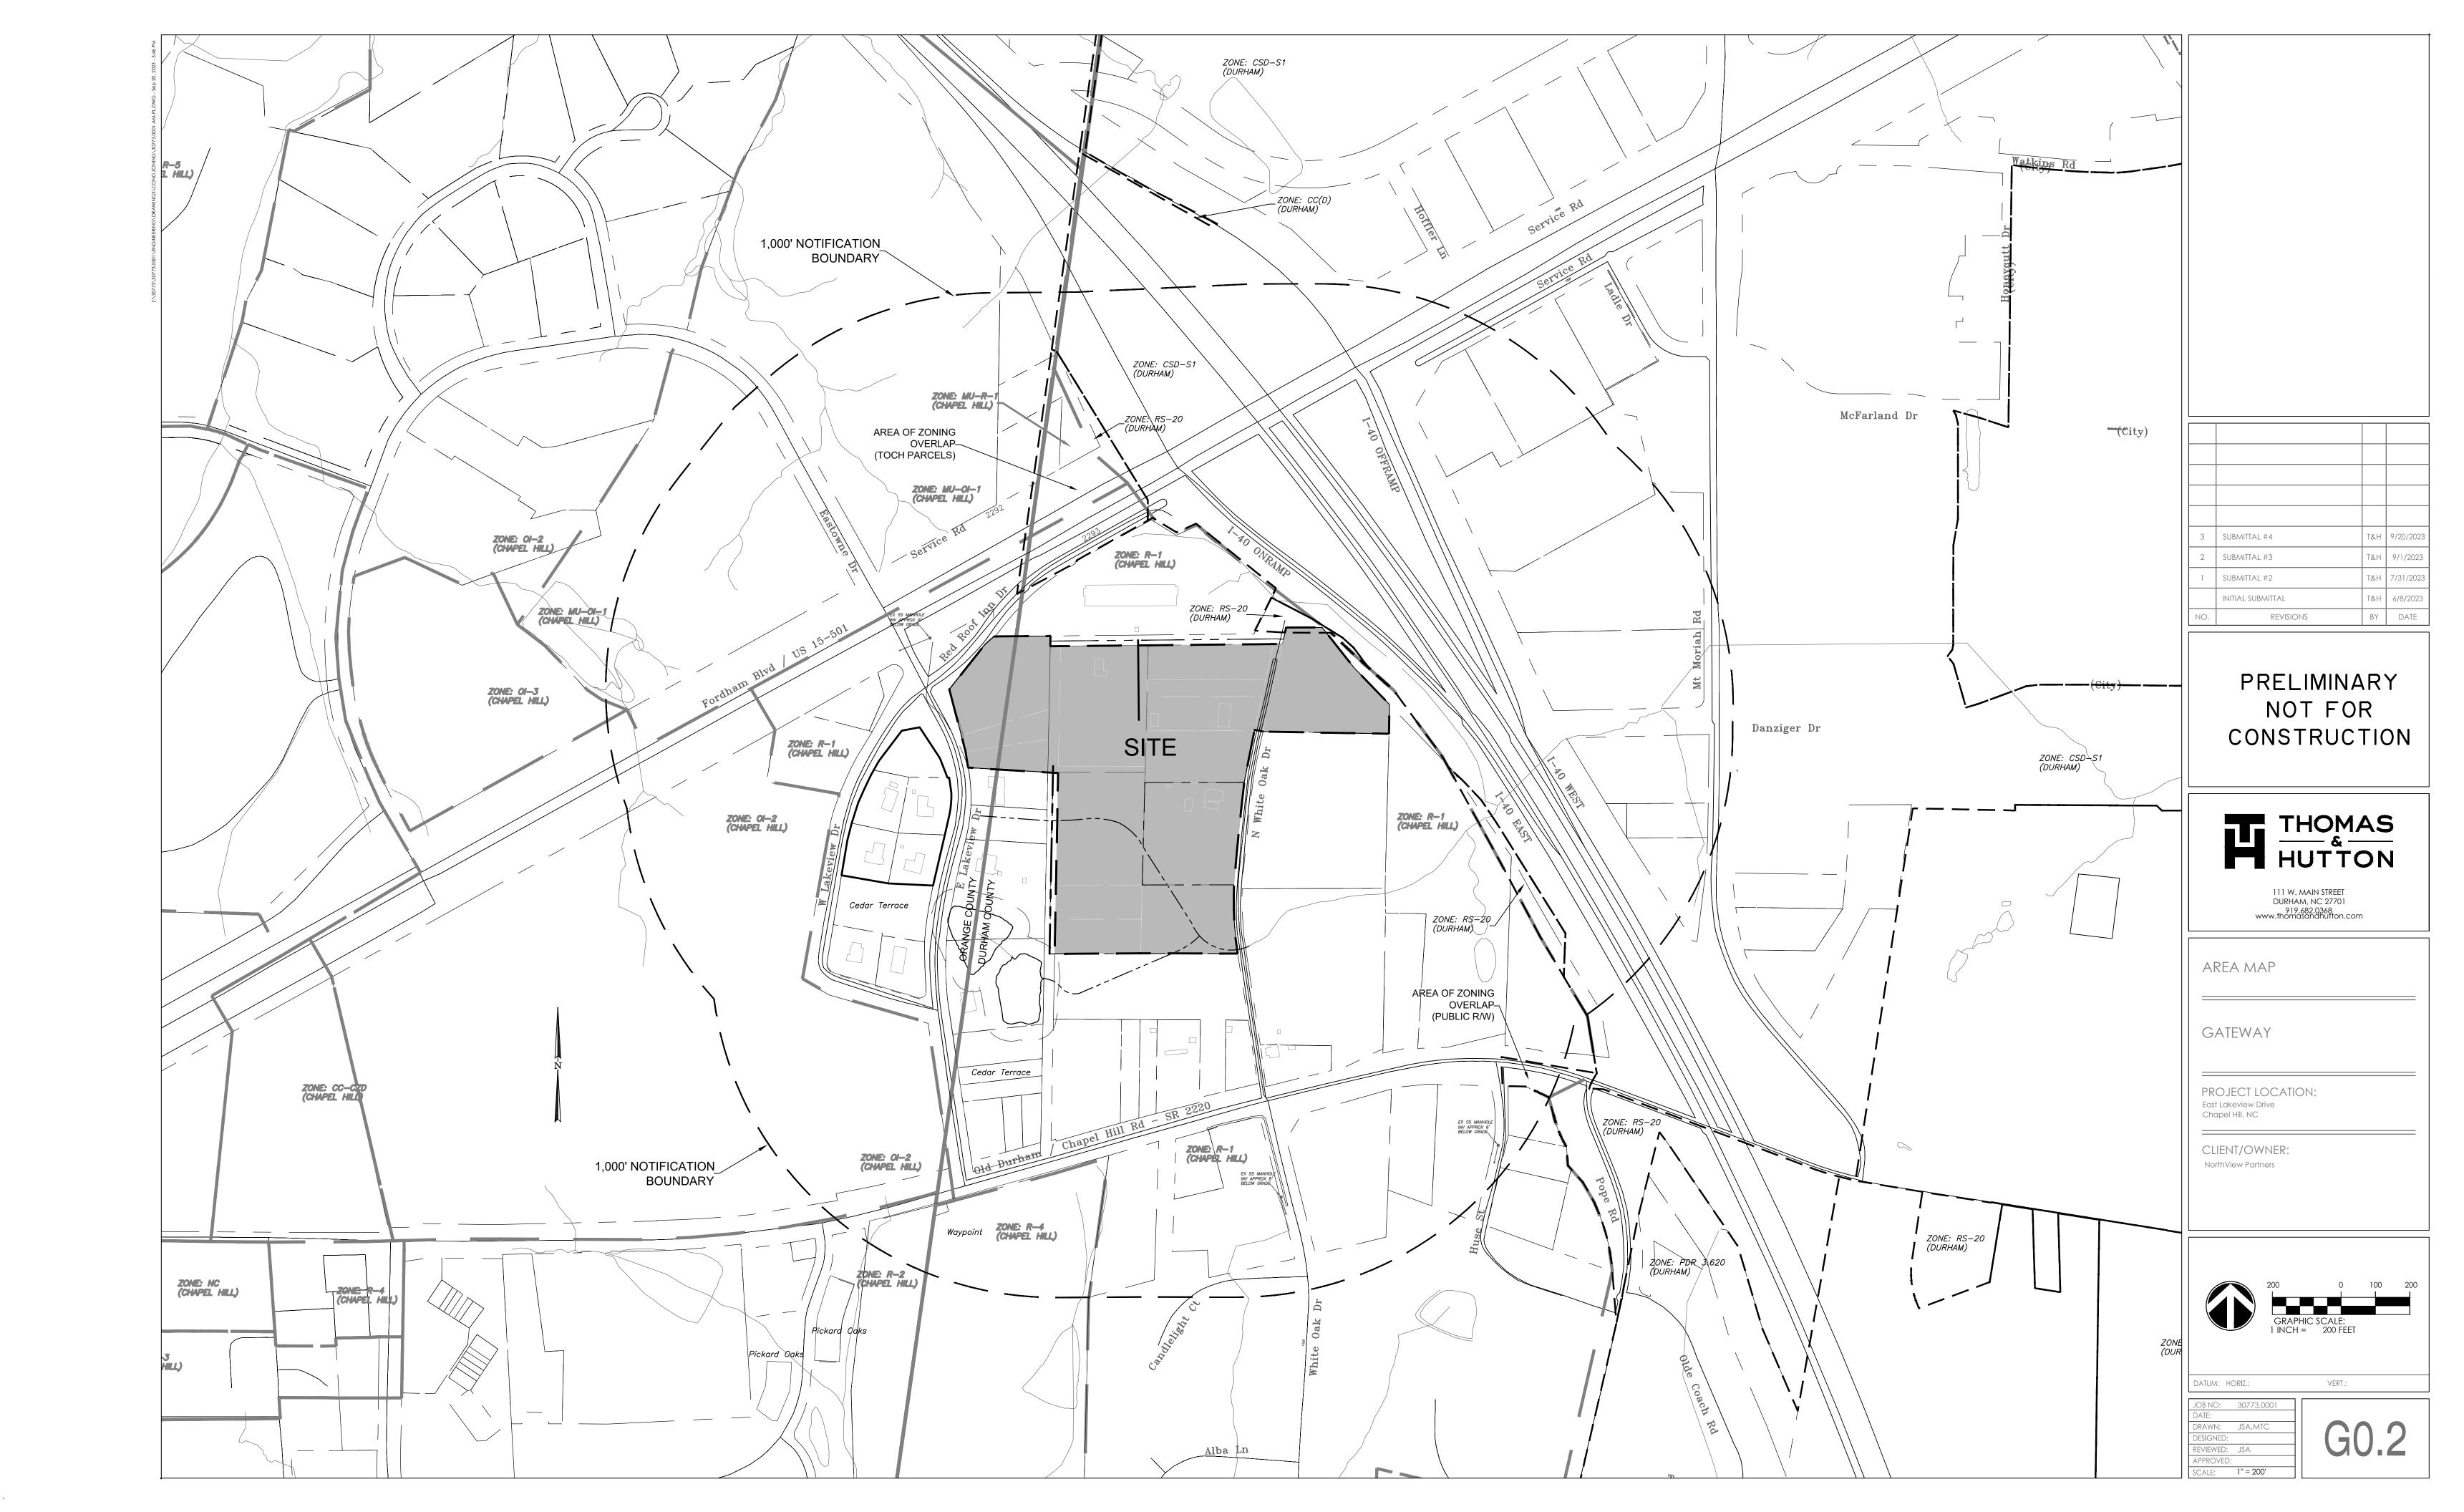CURVE TABLE						
CURVE	RADIUS	LENGTH	CHORD	CHD BEARING	DELTA	
C1	398.97	141.83	141.09'	N 44°59'17" E	20°22'08"	
C2	228.50'	36.56	36.52	S 80°15'57" W	910'00"	
С3	171.50'	42.86	42.74	S 82°50'29" W	14'19'02"	
C4	278.50'	62.95	62.82'	S 83°31'28" W	12.57,04"	
C5	961.50	11.51	11.51'	N 00°38'25" E	0°41'09"	
C6	528.50'	9.07	9.07	N 00°29'30" E	0.58.59"	
C7	171.50'	14.96	14.96	S 78°10'54" W	4*59'53"	
C9	228.50'	57.10	56.95	S 82°50'29" W	14'19'02"	
C11	533.50'	57.39	57.37	S 08°58'39" W	6'09'50"	
C12	1033.50	249.92'	249.31'	S 01°01'55" E	13*51'18"	
C13	471.50'	3.25'	3.25'	N 00°11'51" E	0°23'42"	
C16	221.50	48.36	48.26	S 83°44'45" W	12.30,30	

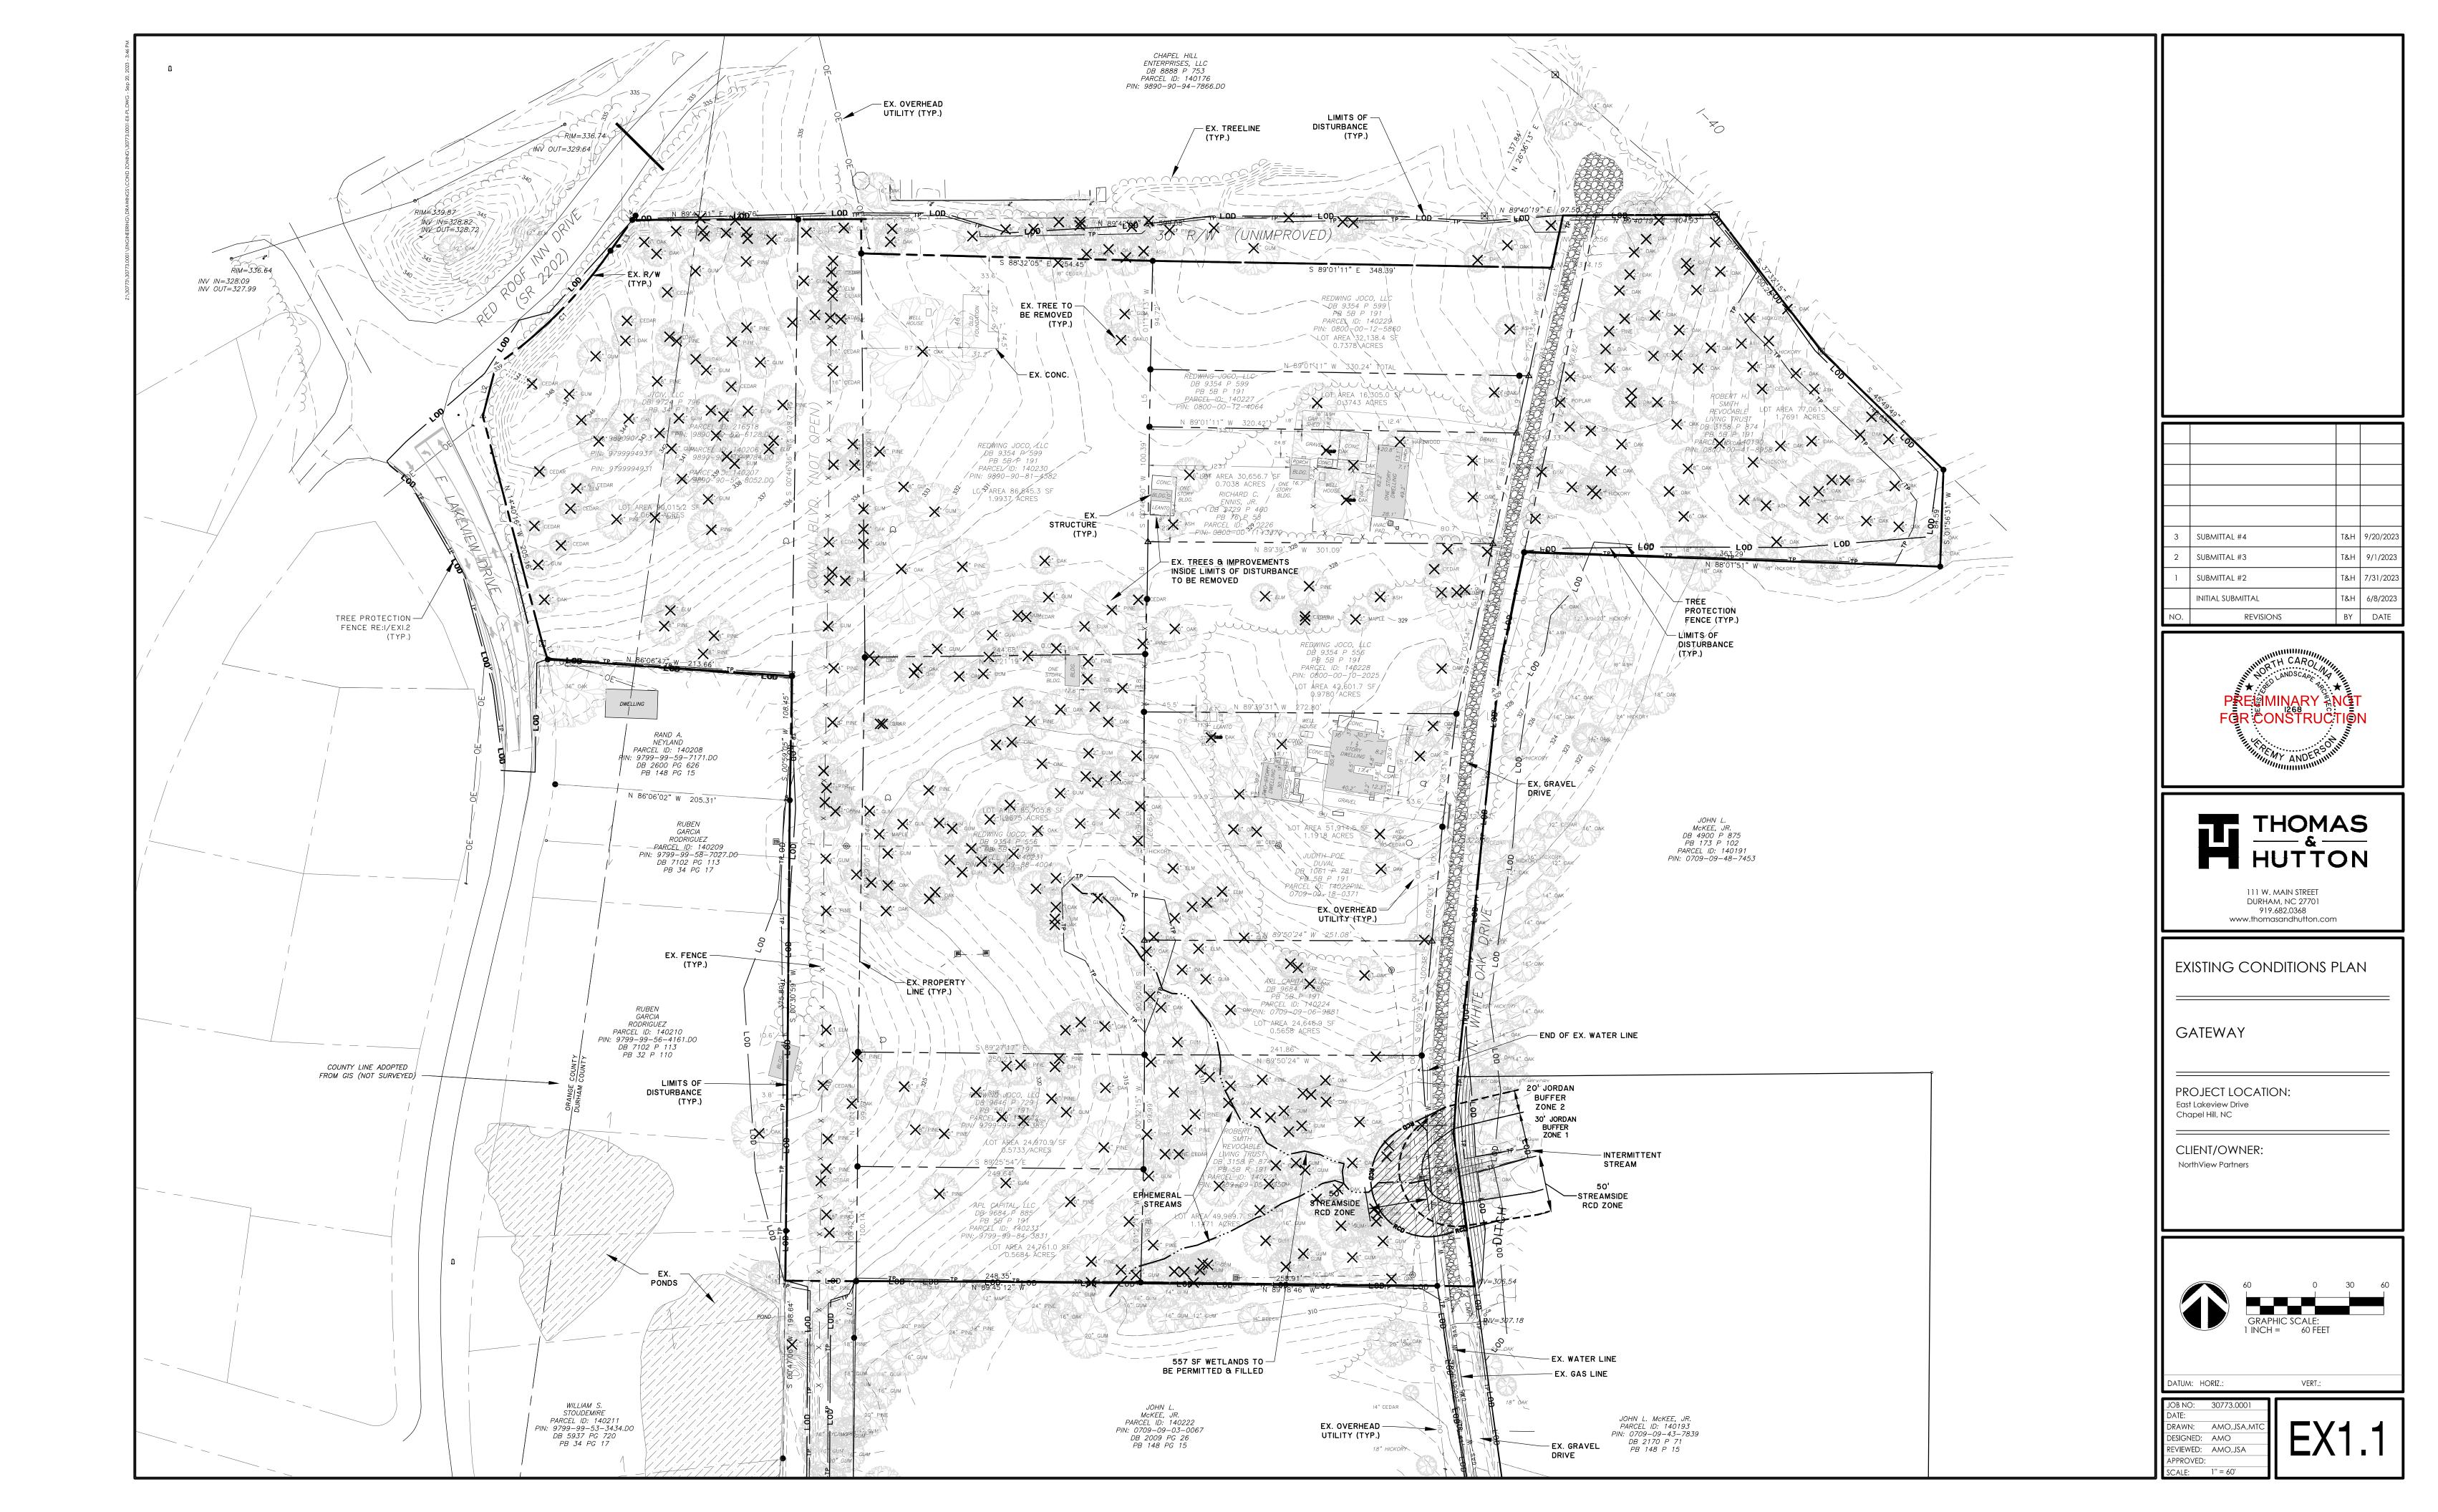3	SUBMITTAL #4	T&H	9/20/2023
2	SUBMITTAL #3	T&H	9/1/2023
1	SUBMITTAL #2	T&H	7/31/2023
	INITIAL SUBMITTAL	T&H	6/8/2023
NO	PEVISIONIS	RY	DATE

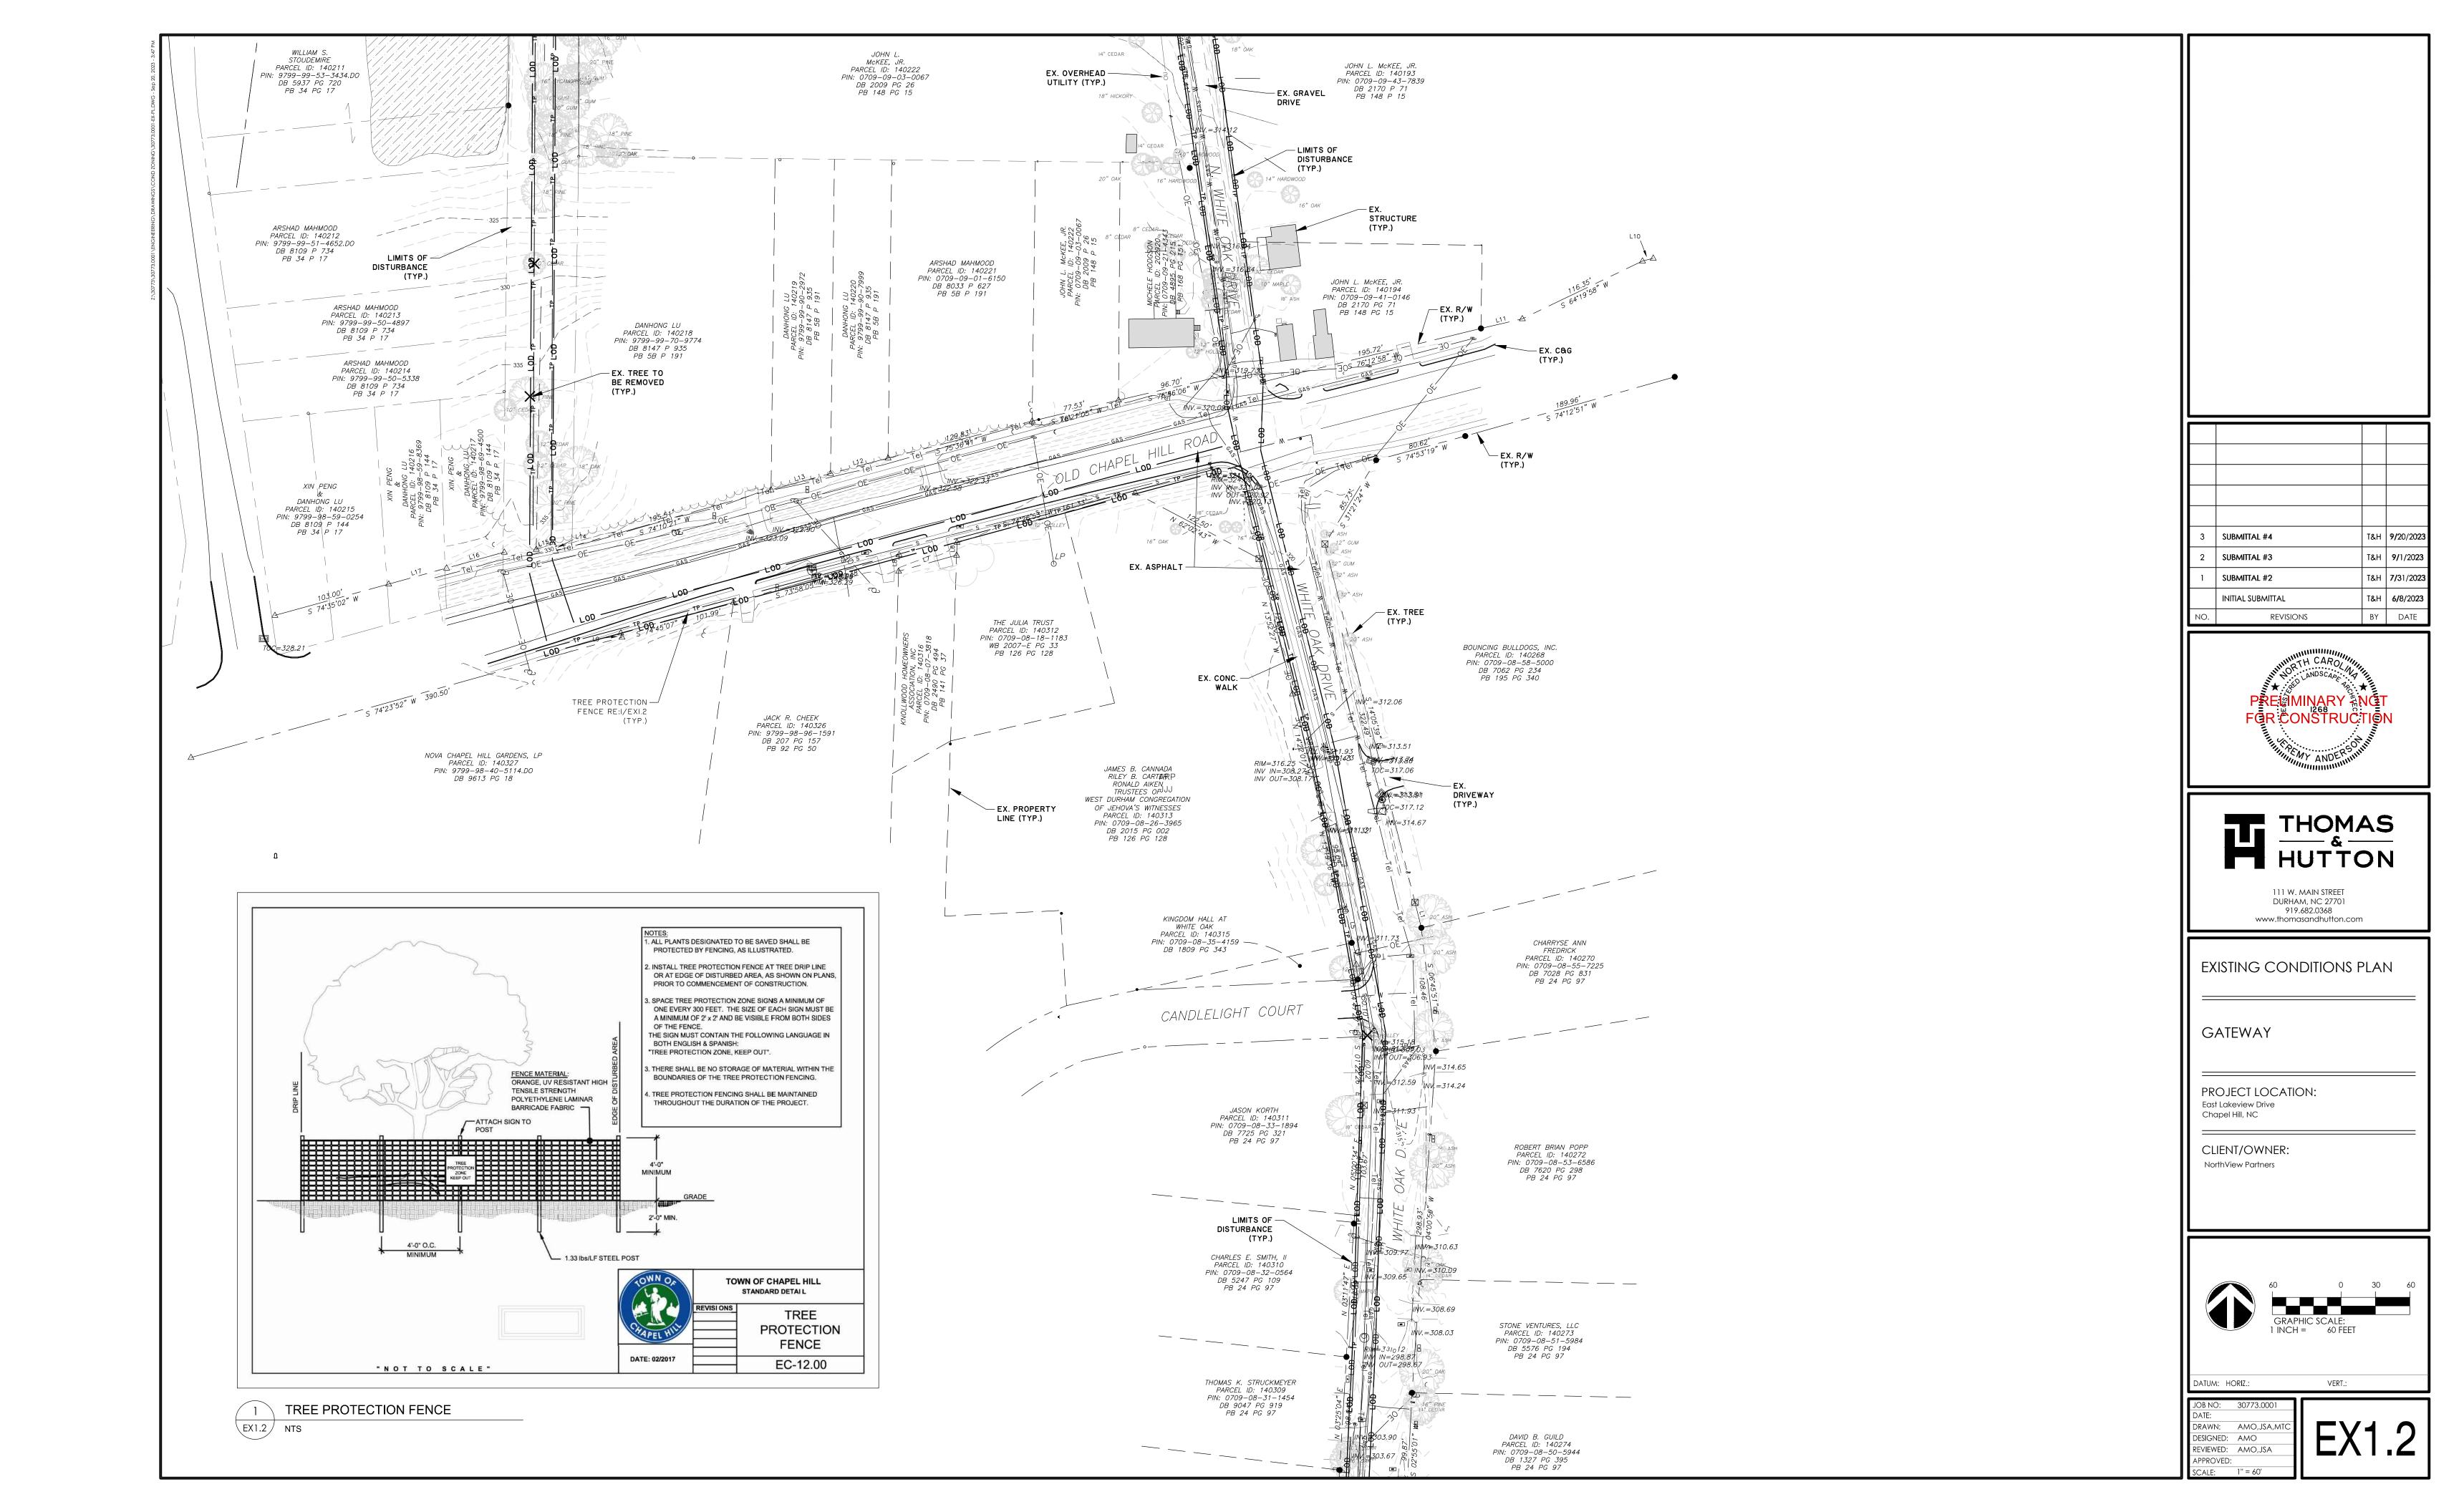PRELIMINARY NOT FOR CONSTRUCTION

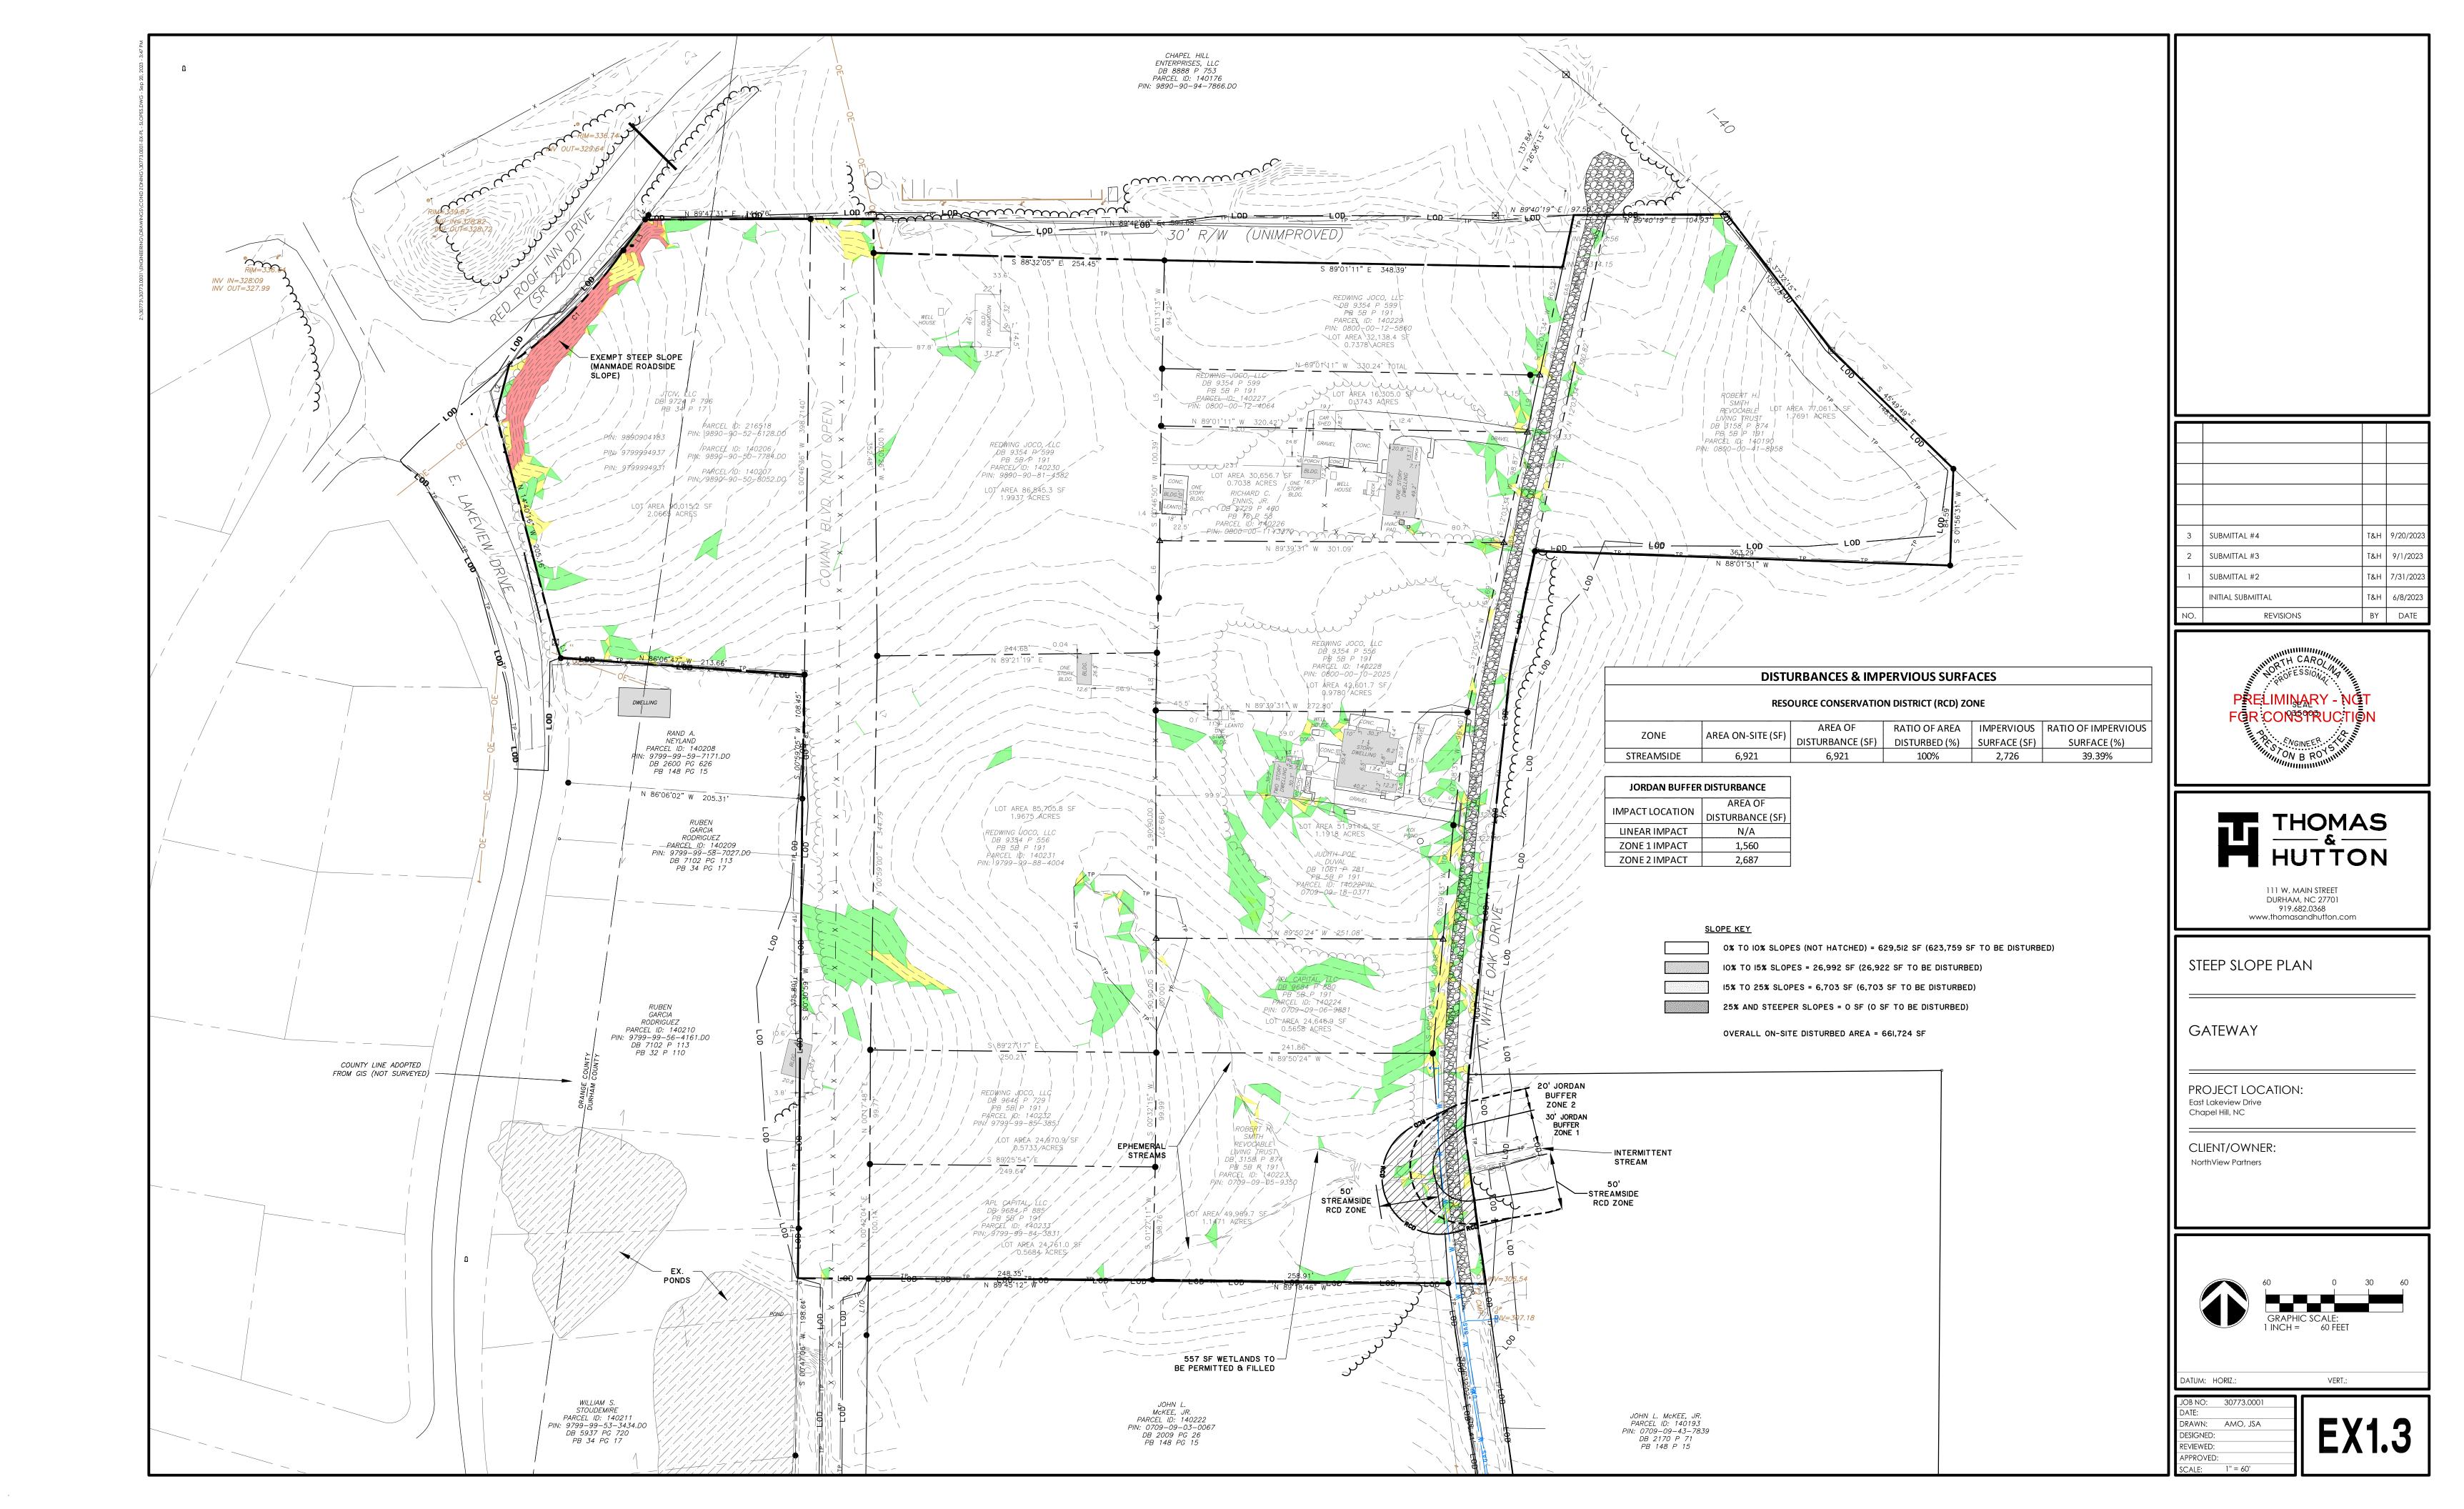

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PRELIMINARY PLAT


GATEWAY

Chapel Hill, NC

PROJECT LOCATION: East Lakeview Drive

CLIENT/OWNER:


NorthView Partners

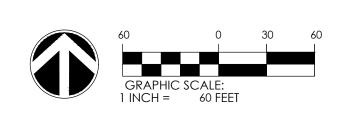

DATUM: HORIZ.:

DRAWN: AMO, JSA DESIGNED: REVIEWED: APPROVED:


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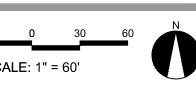
LANDSCAPE ARCHITECTURE CIVIL ENGINEERING TRANSPORTATION PLANNING

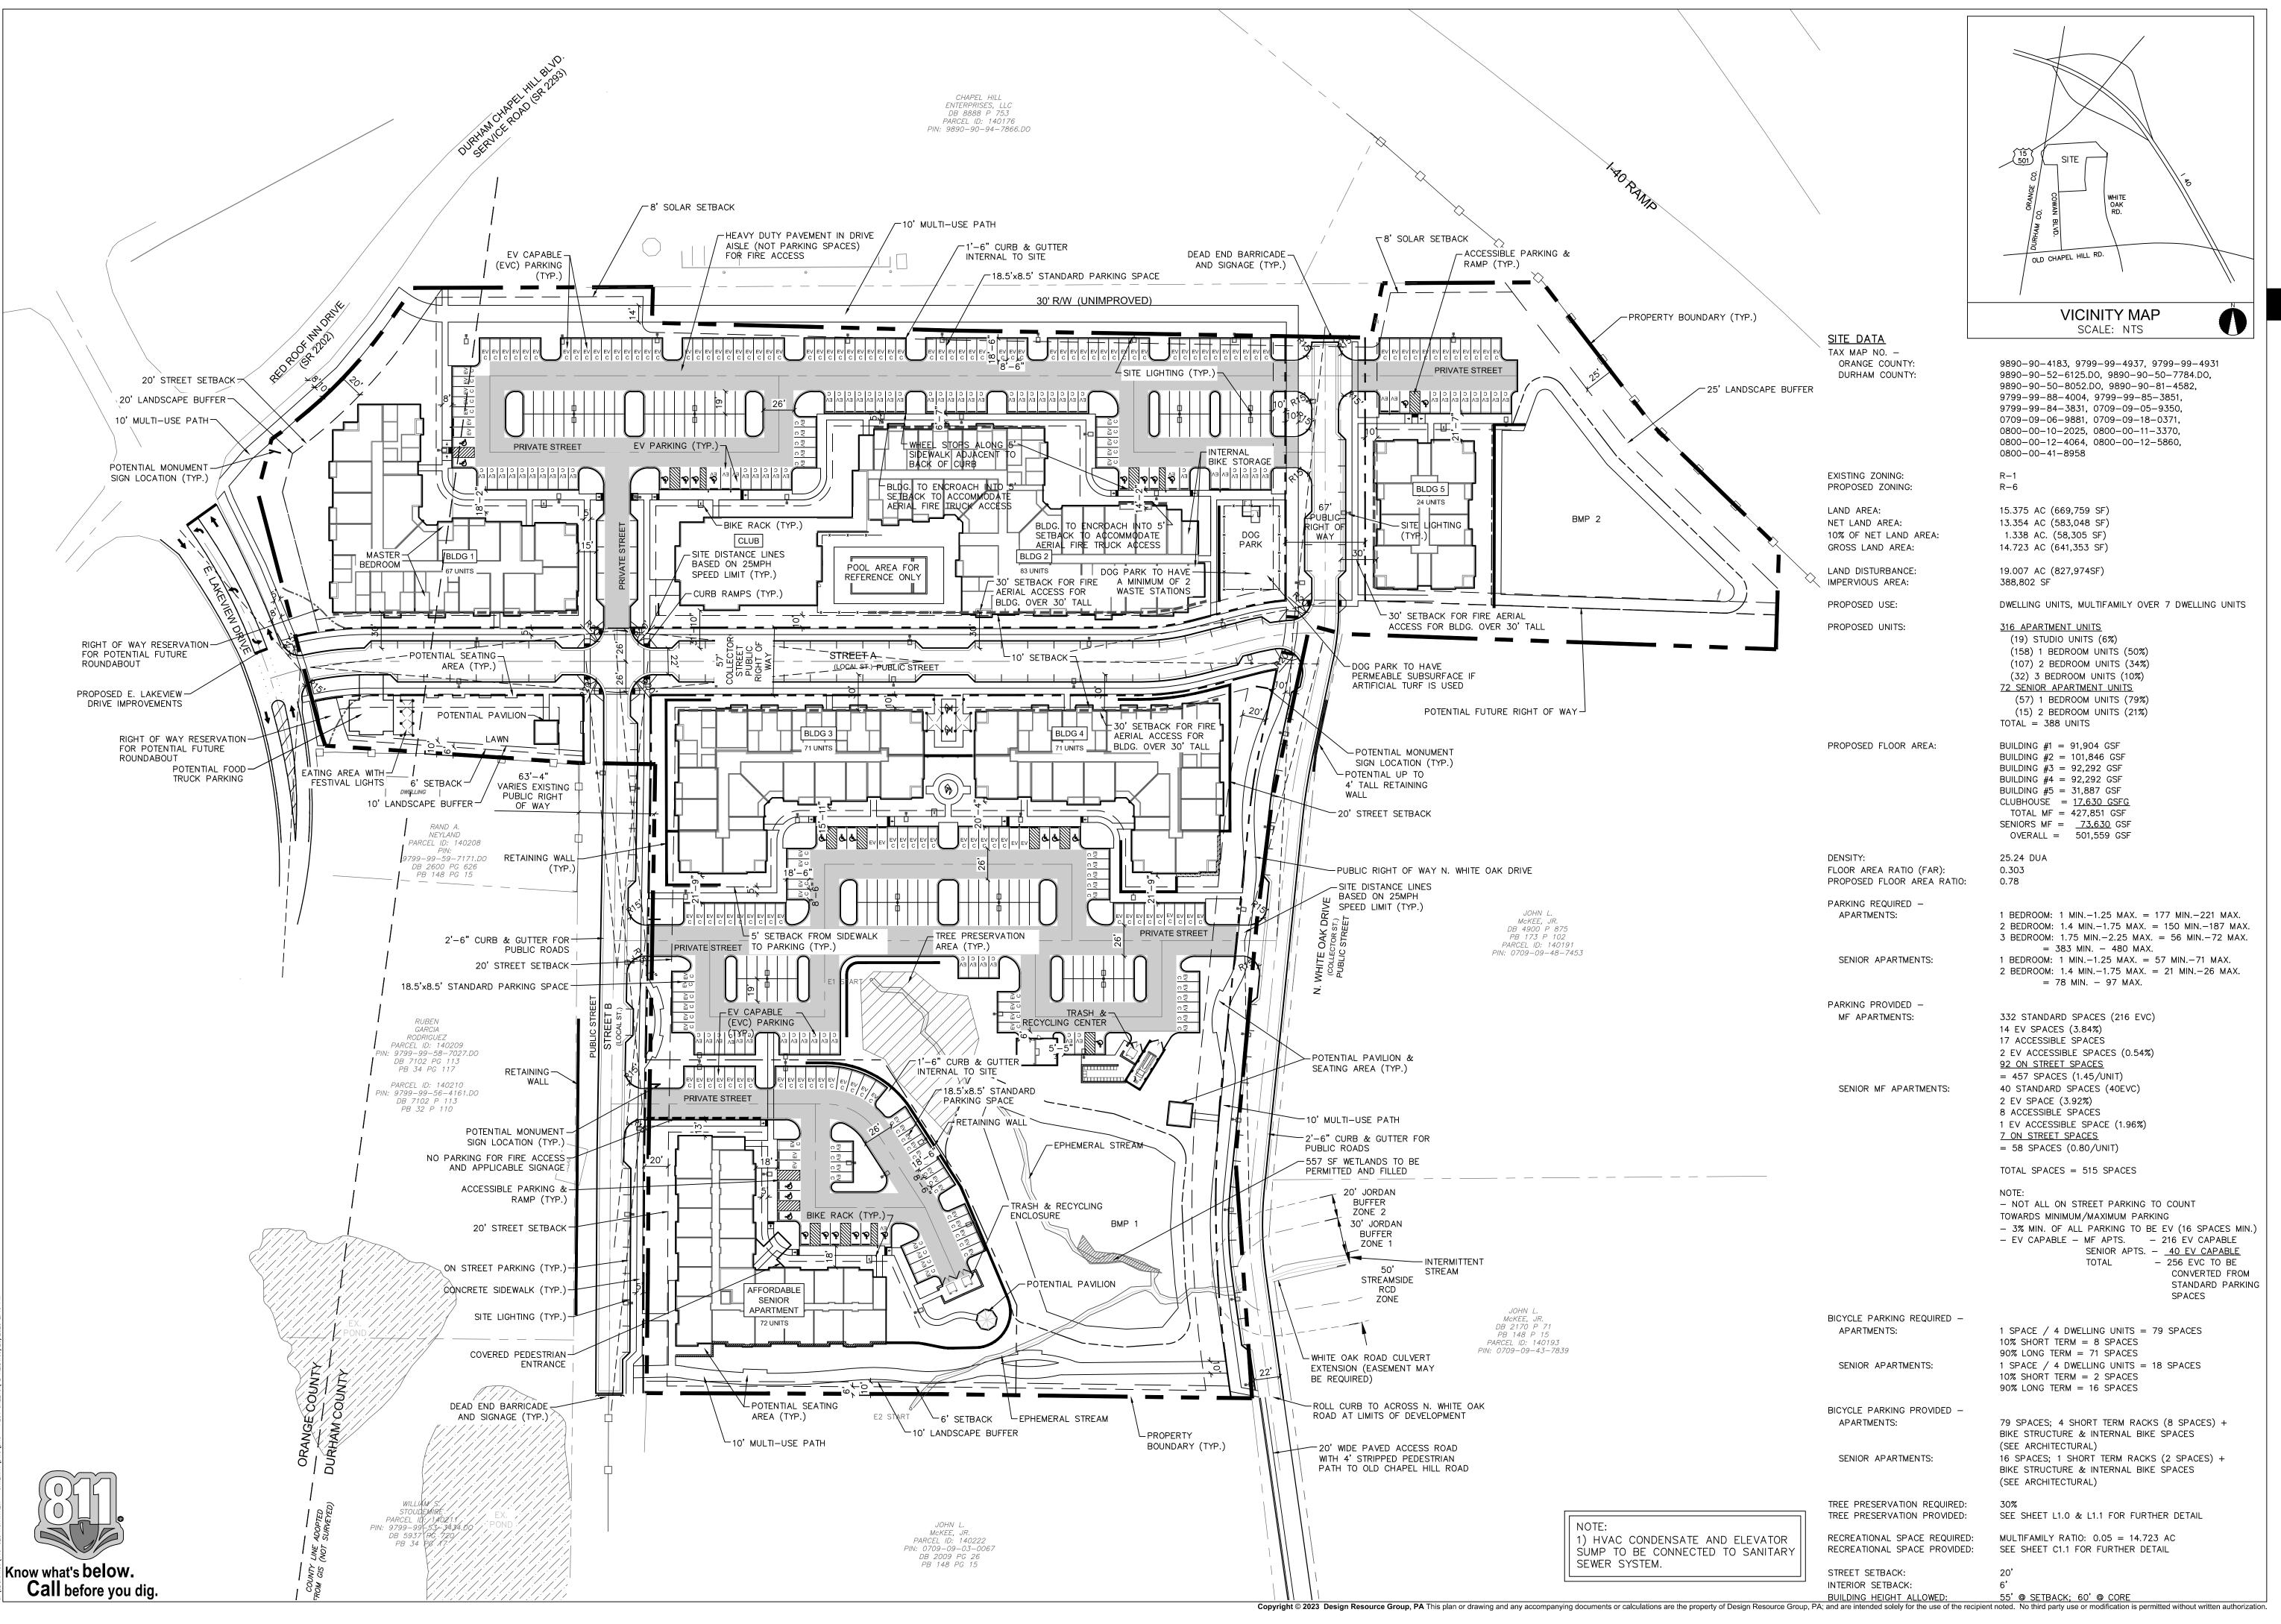2459 Wilkinson Blvd, Ste 200 Charlotte, NC 28208 704.343.0608 www.drgrp.com



REZONING

SITE PLAN

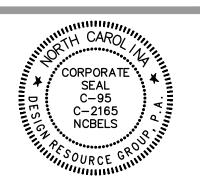



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JUNE 8, 2023

**REVISIONS:** 

C1.0




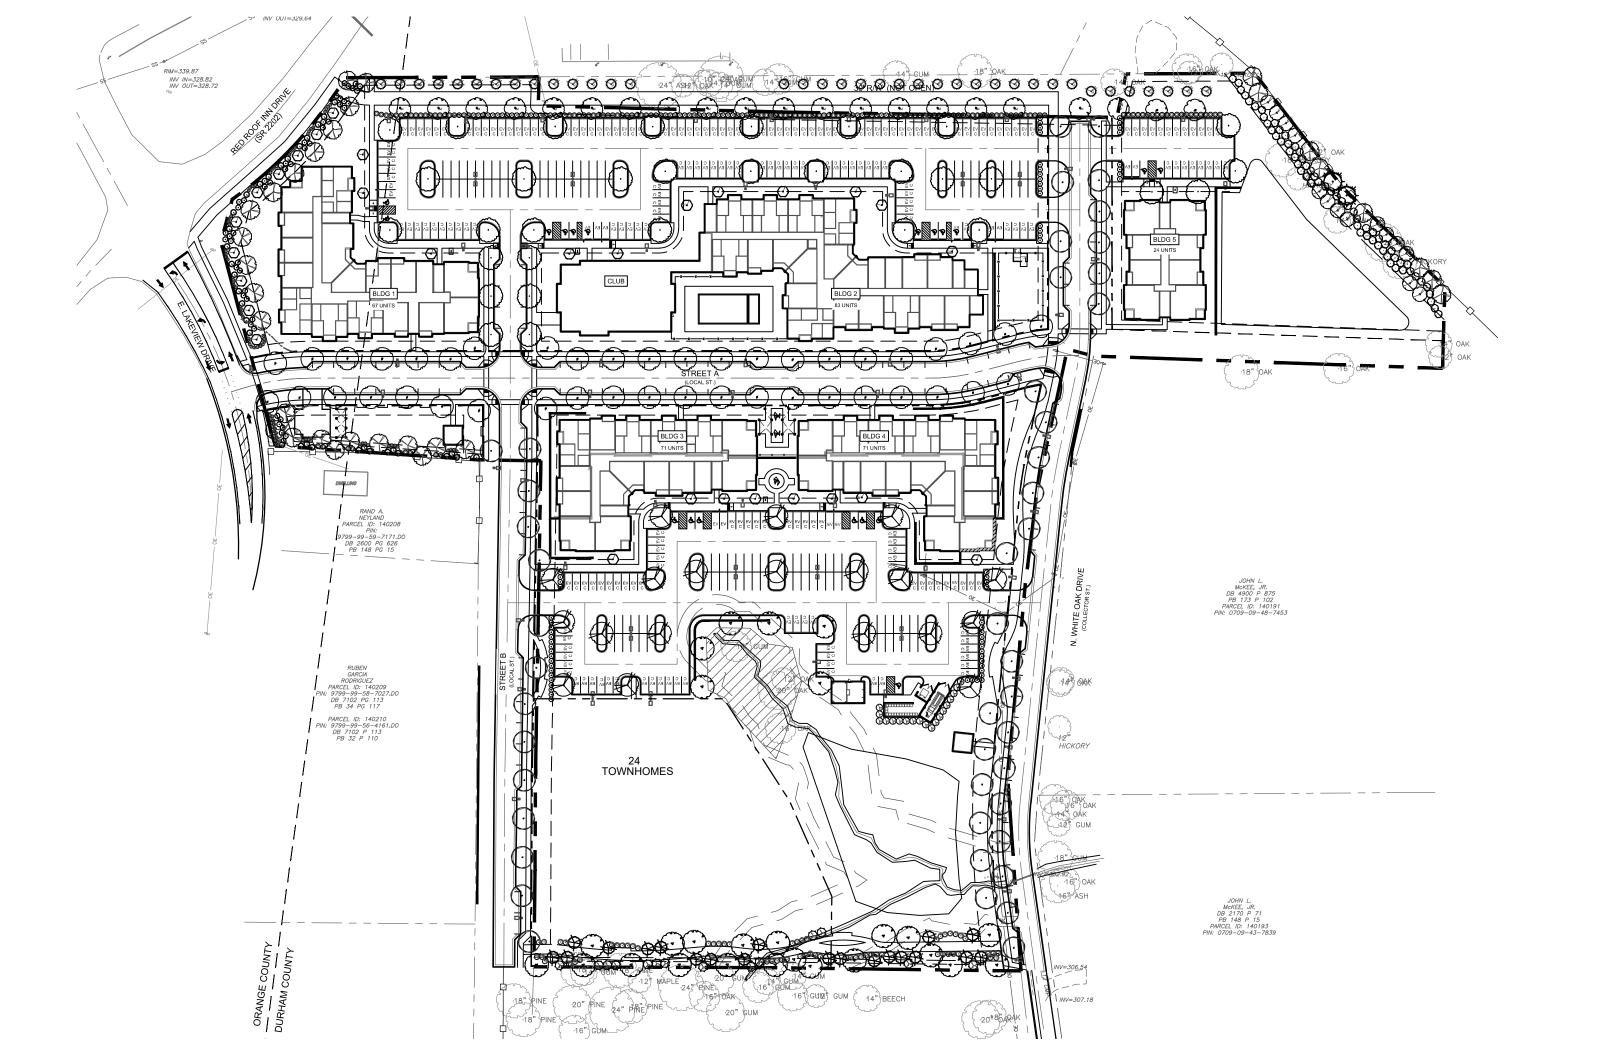

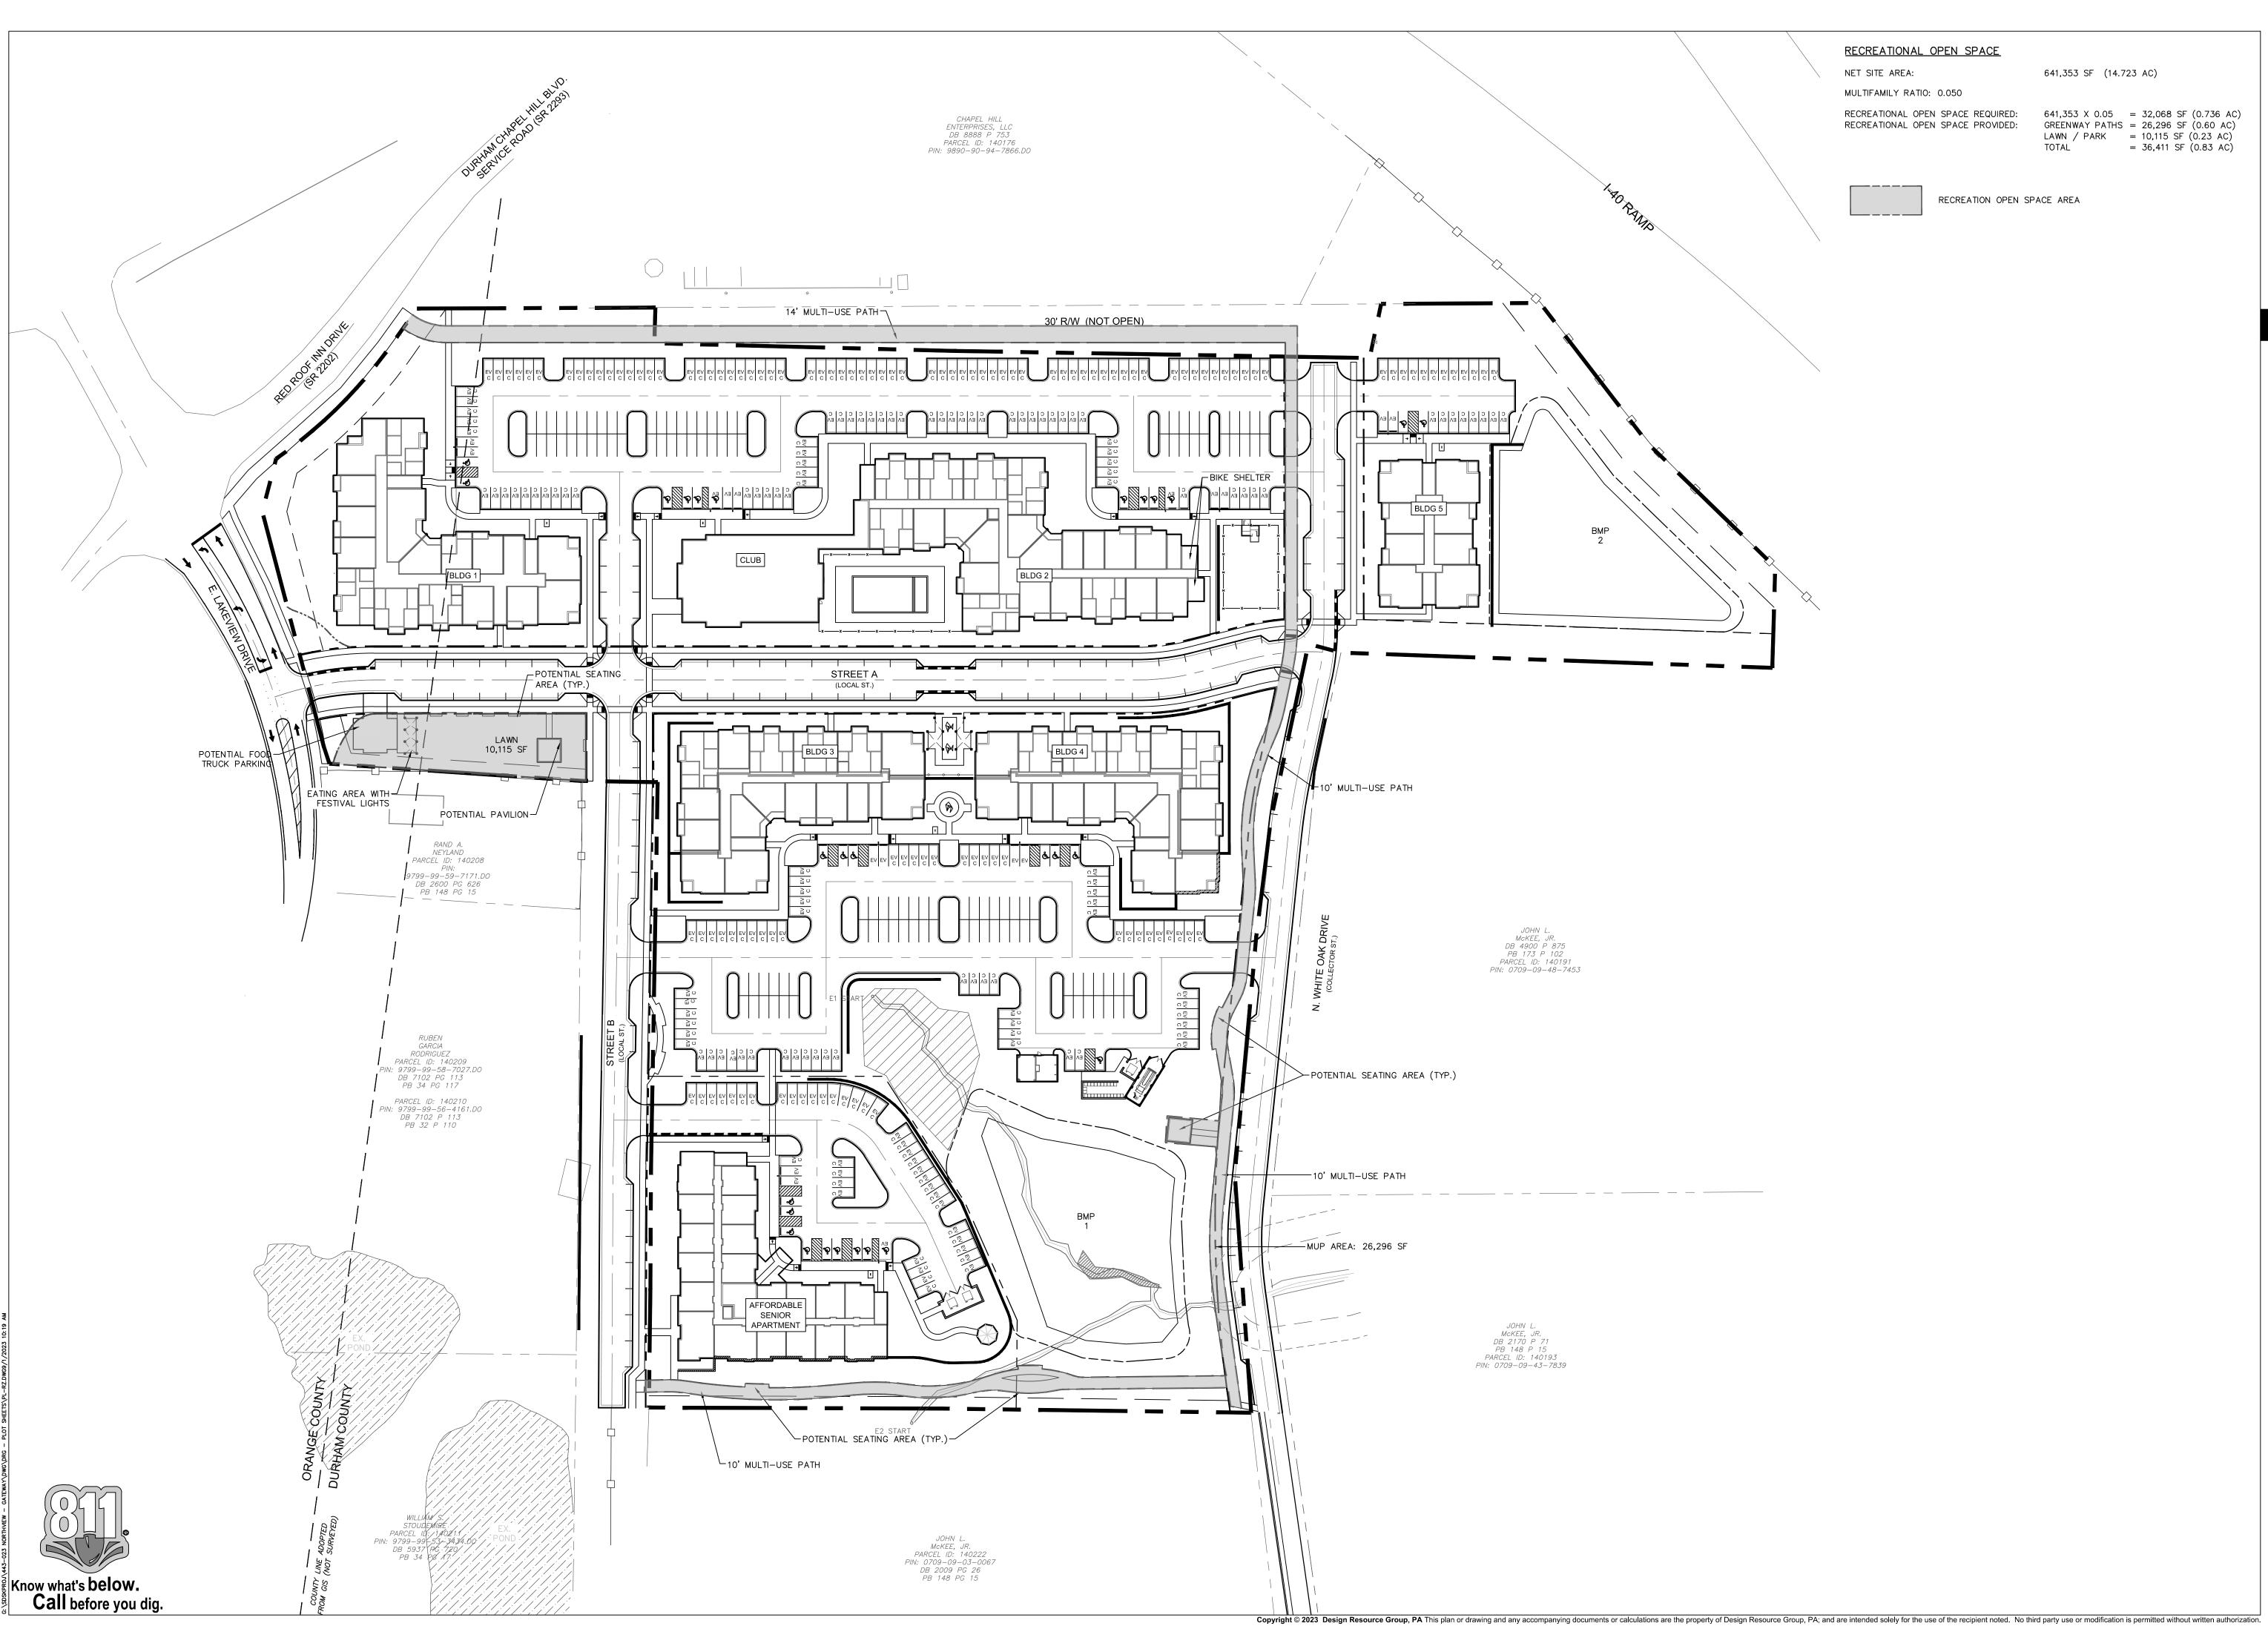

LANDSCAPE ARCHITECTURE CIVIL ENGINEERING TRANSPORTATION PLANNING


O 2459 Wilkinson Blvd, Ste 200 Charlotte, NC 28208 704.343.0608 www.drgrp.com

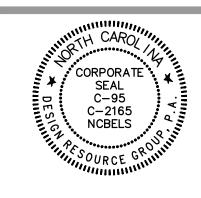

REZONING

# GAIEWAY PARTMENTS APEL HILL, NORTH CAROLINA

OPEN SPACE PLAN

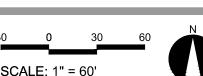


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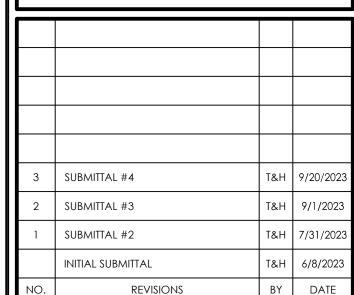
PROJECT #:
DRAWN BY:

DRAWN BY: CHECKED BY:

JUNE 8, 2023

REVISIONS:



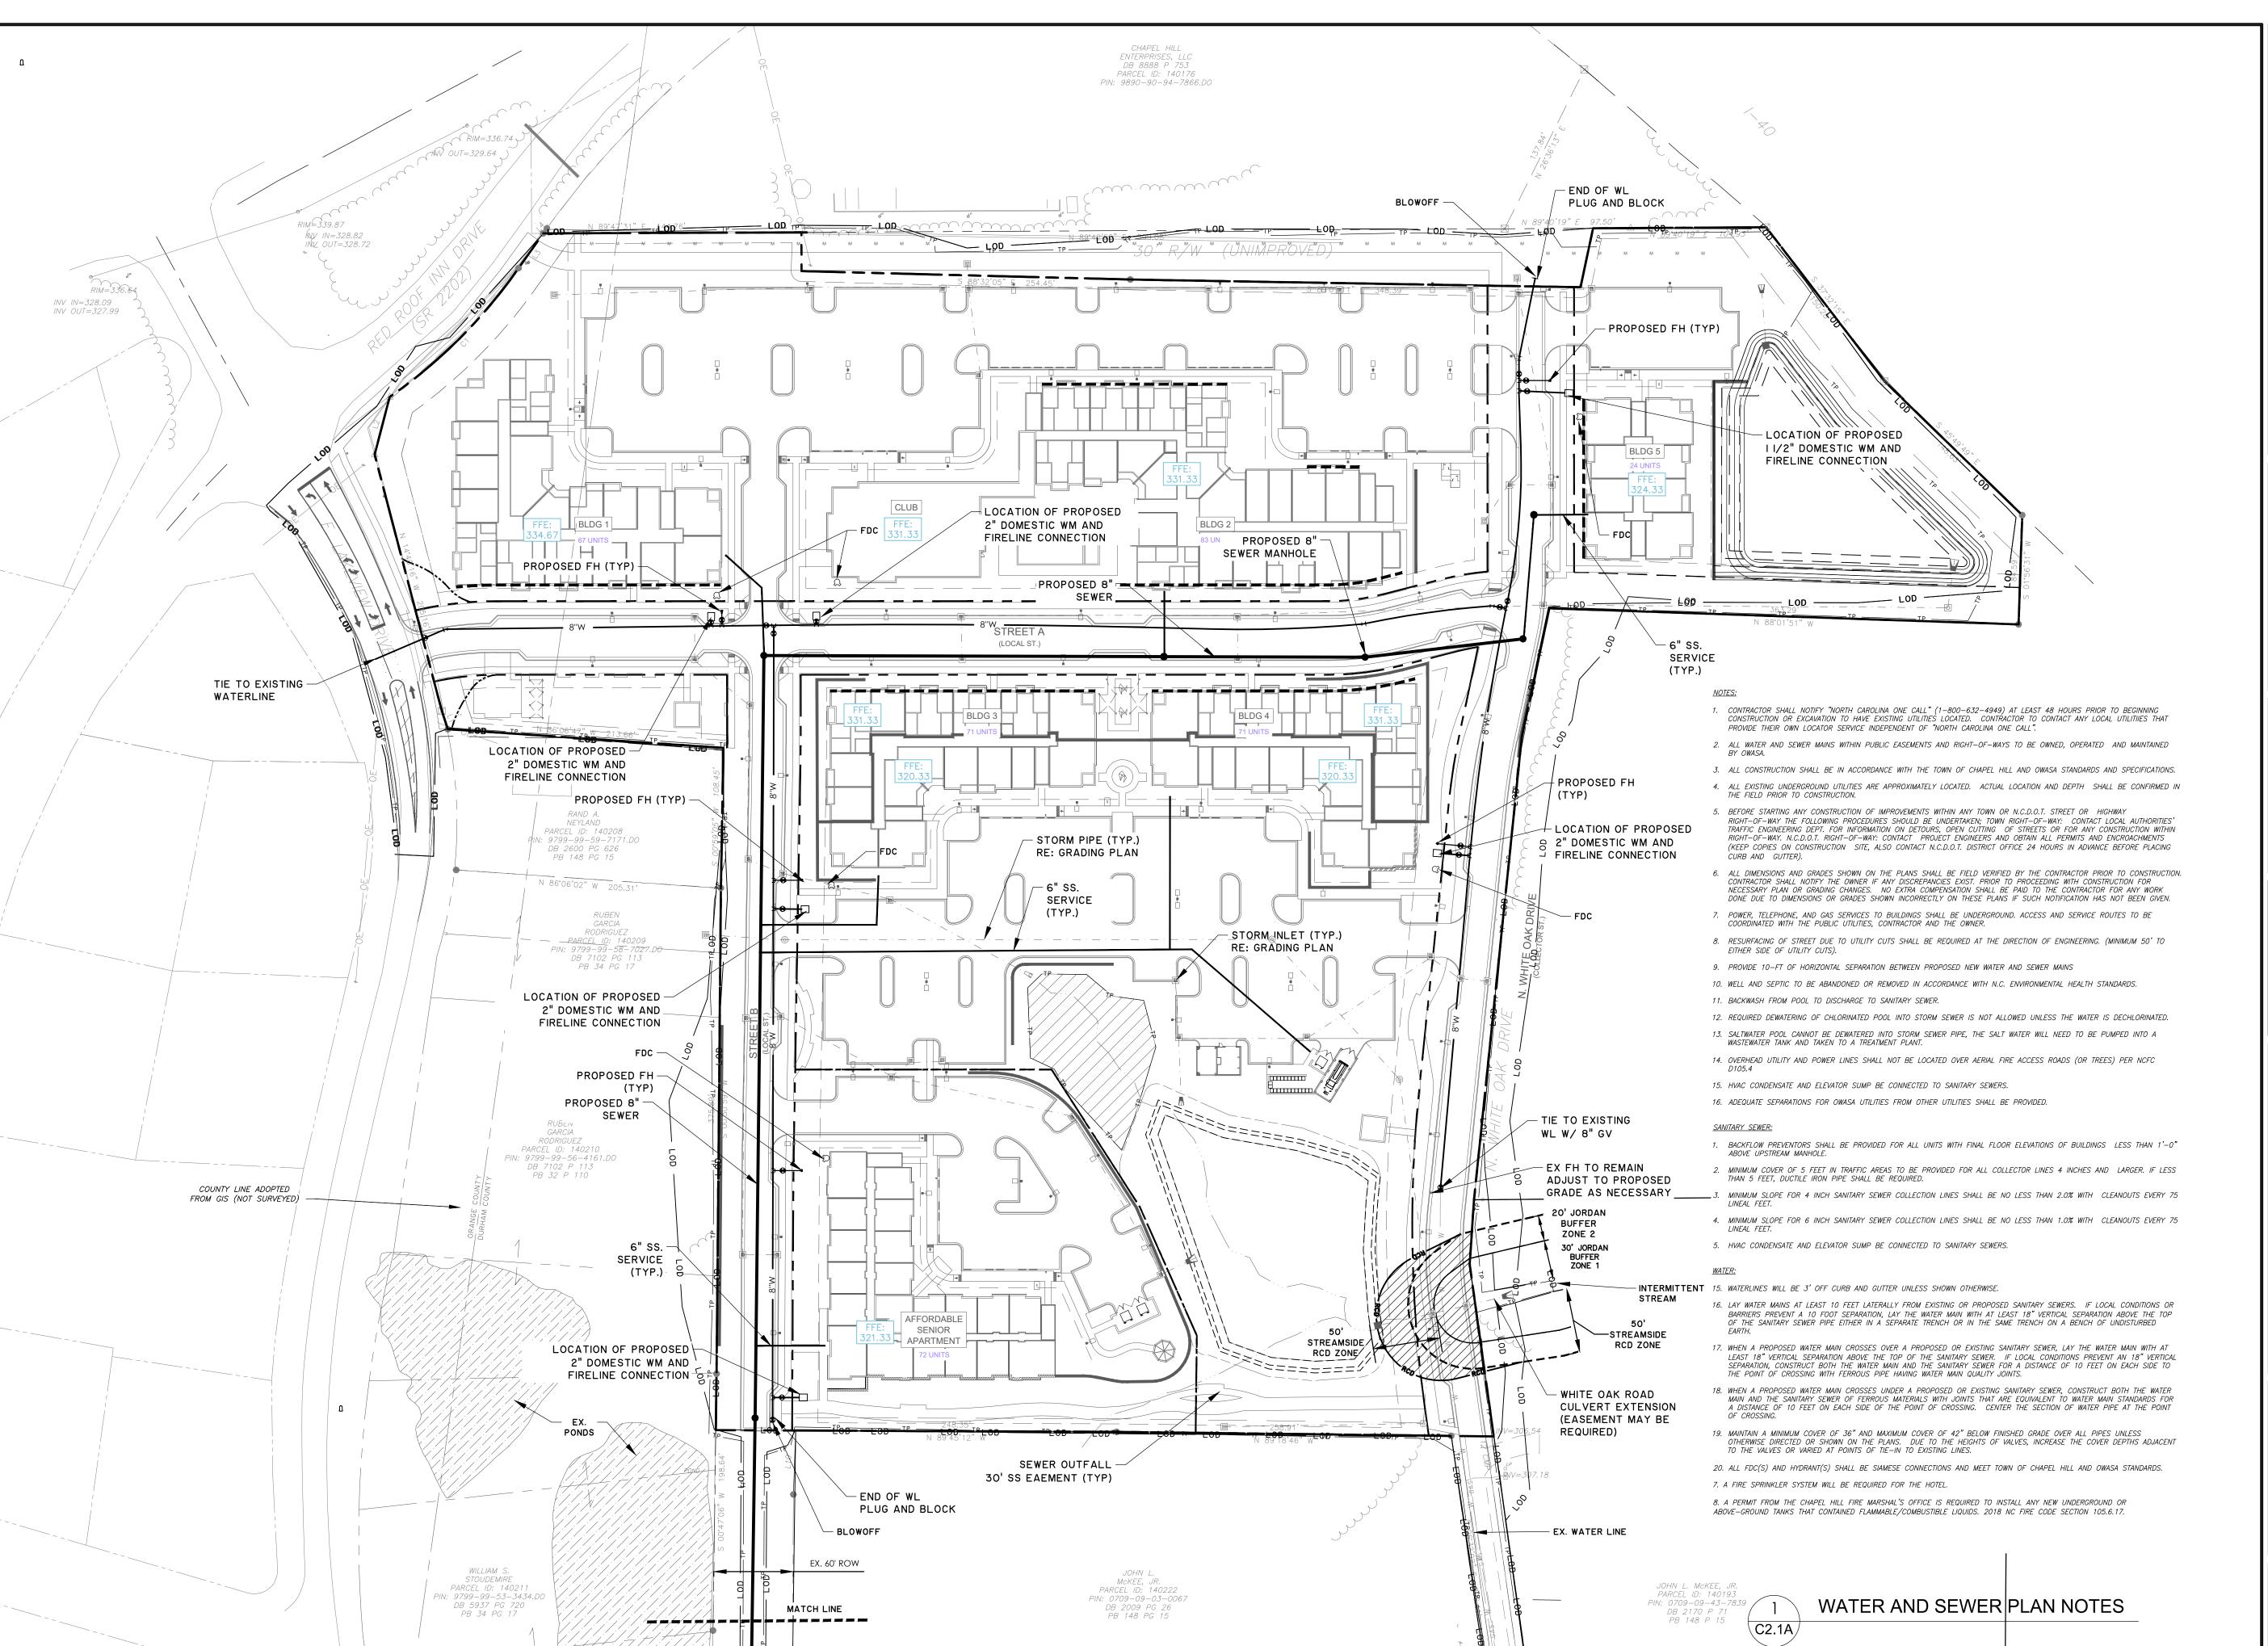




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UTILITY PLAN

GATEWAY

PROJECT LOCATION: East Lakeview Drive Chapel Hill, NC

CLIENT/OWNER:
NorthView Partners

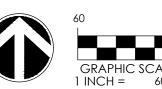

GRAPHIC SCALE:
1 INCH = 60 FEET


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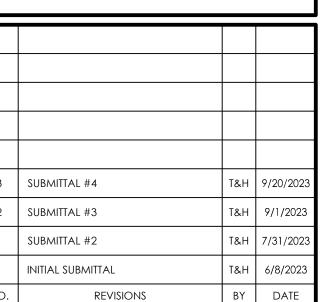
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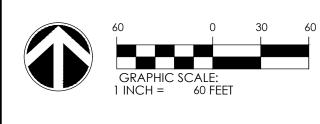
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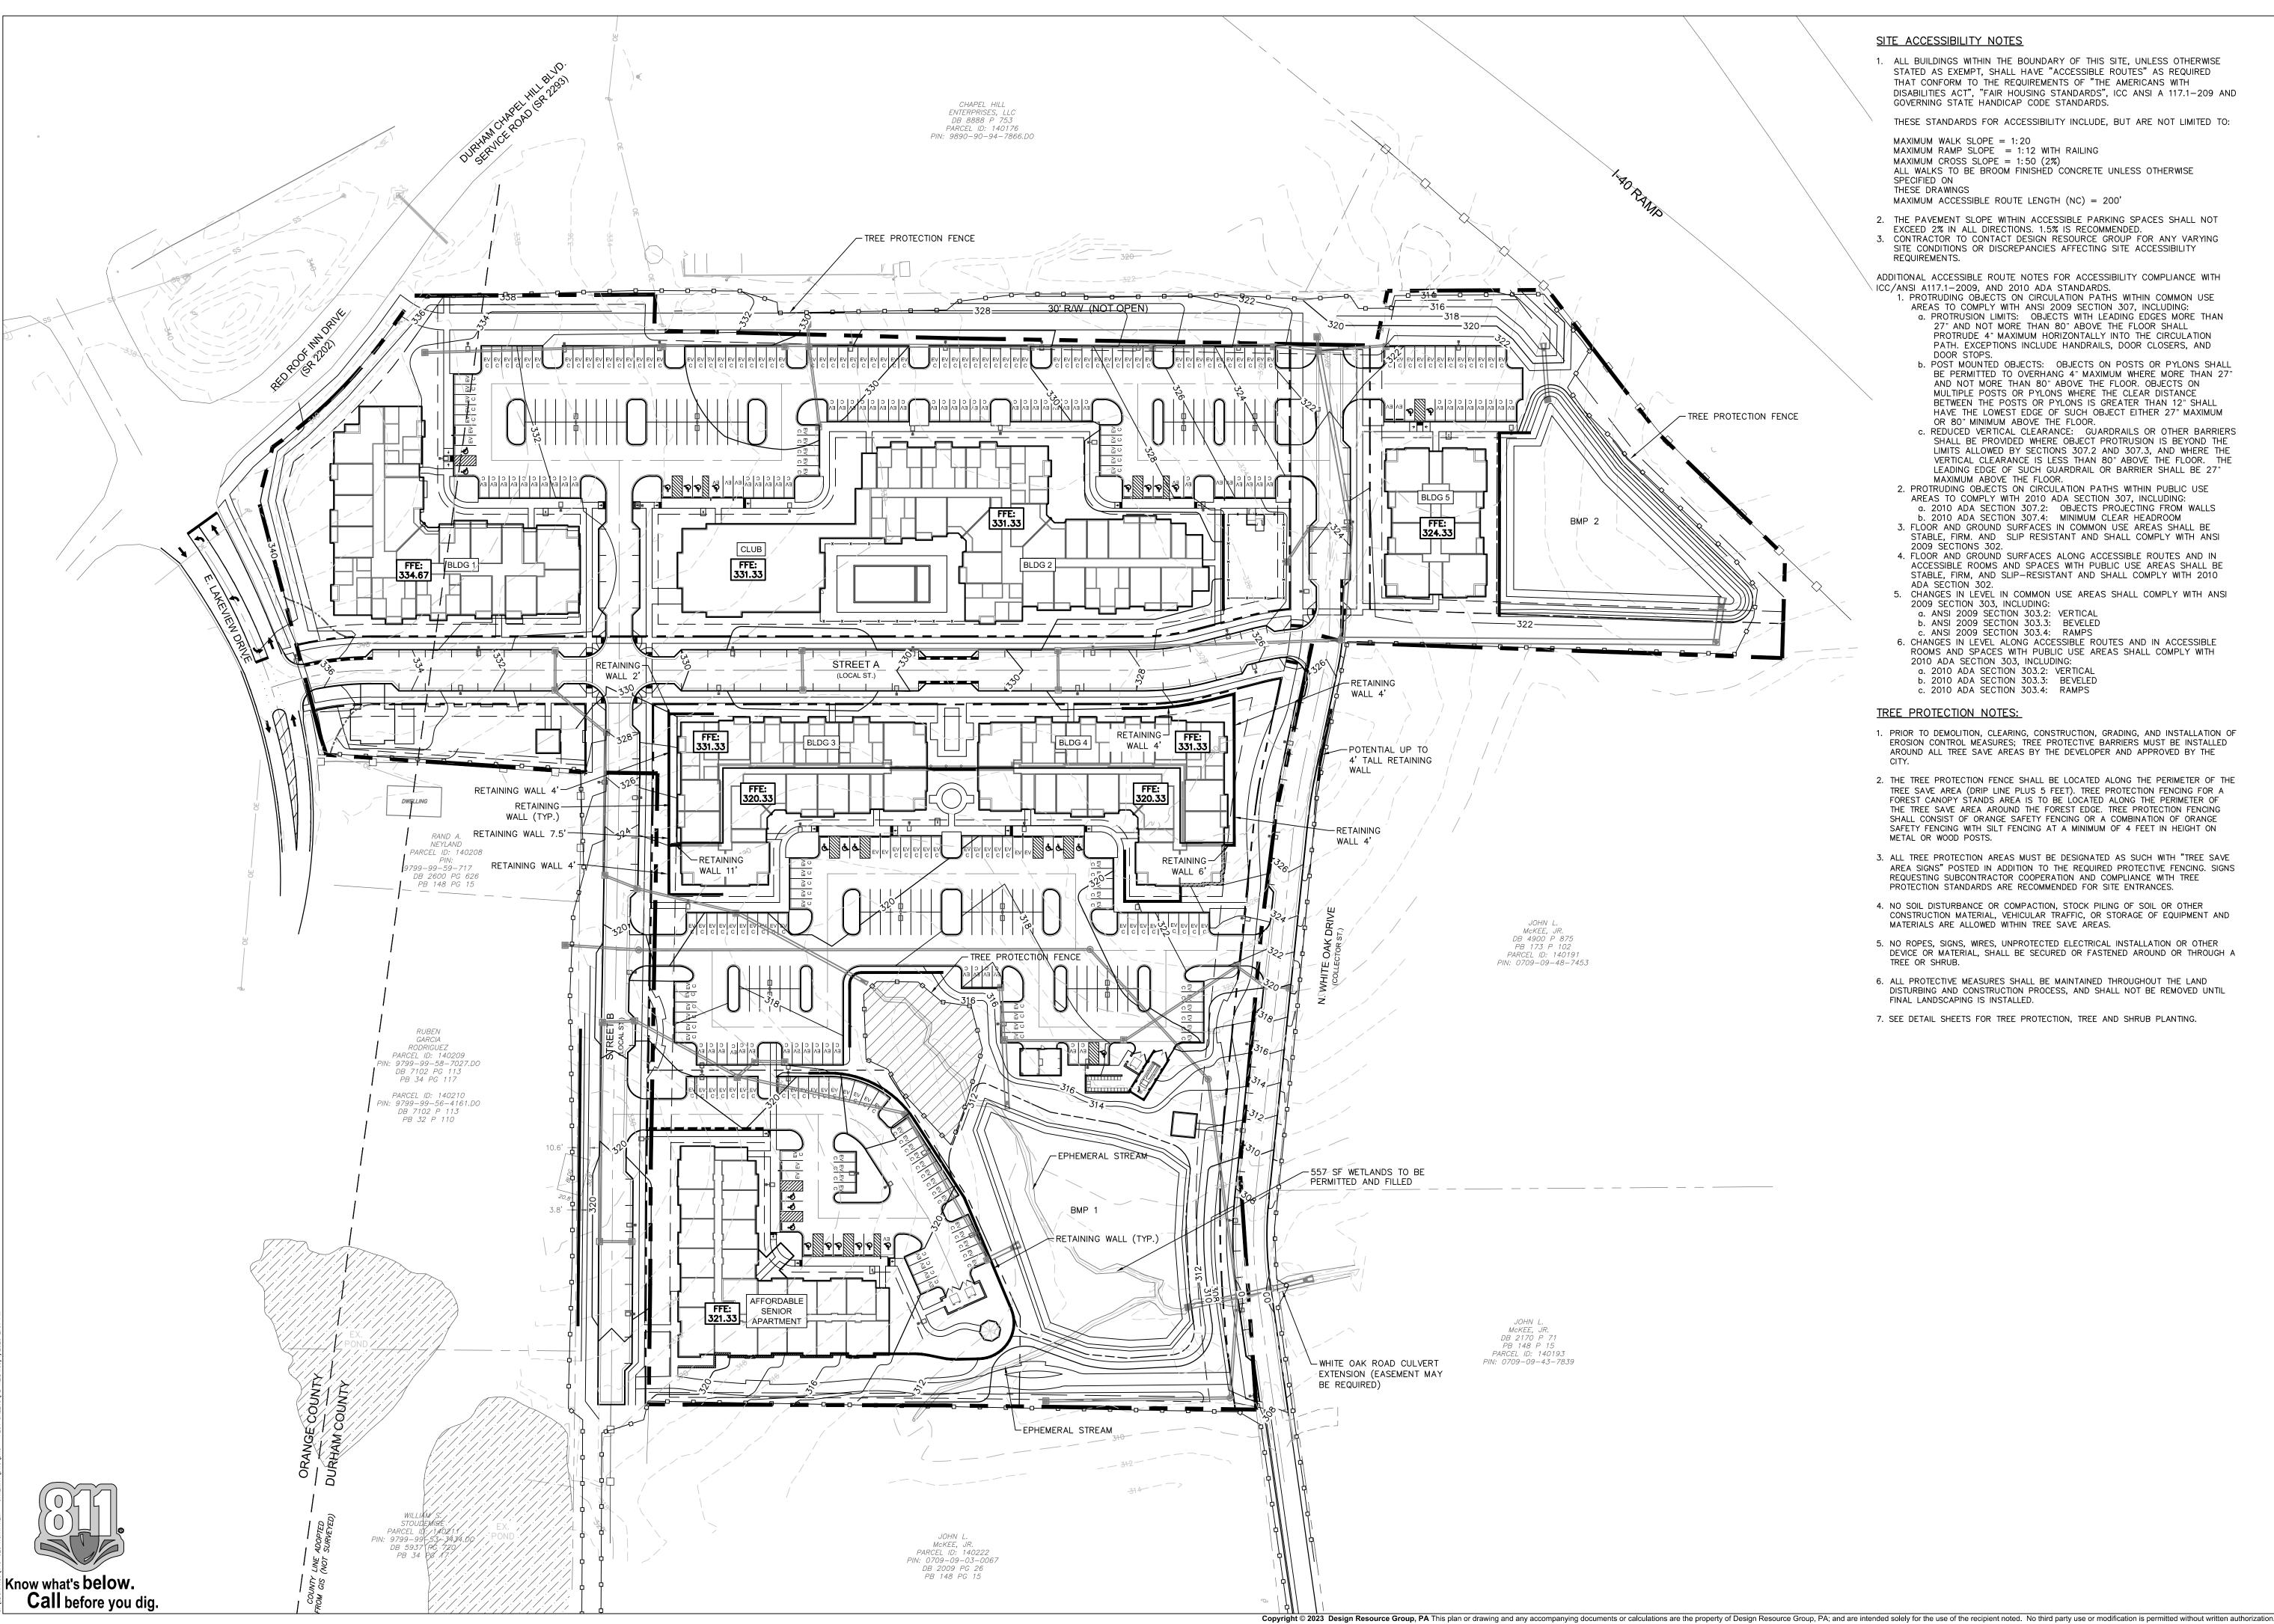
C2.1









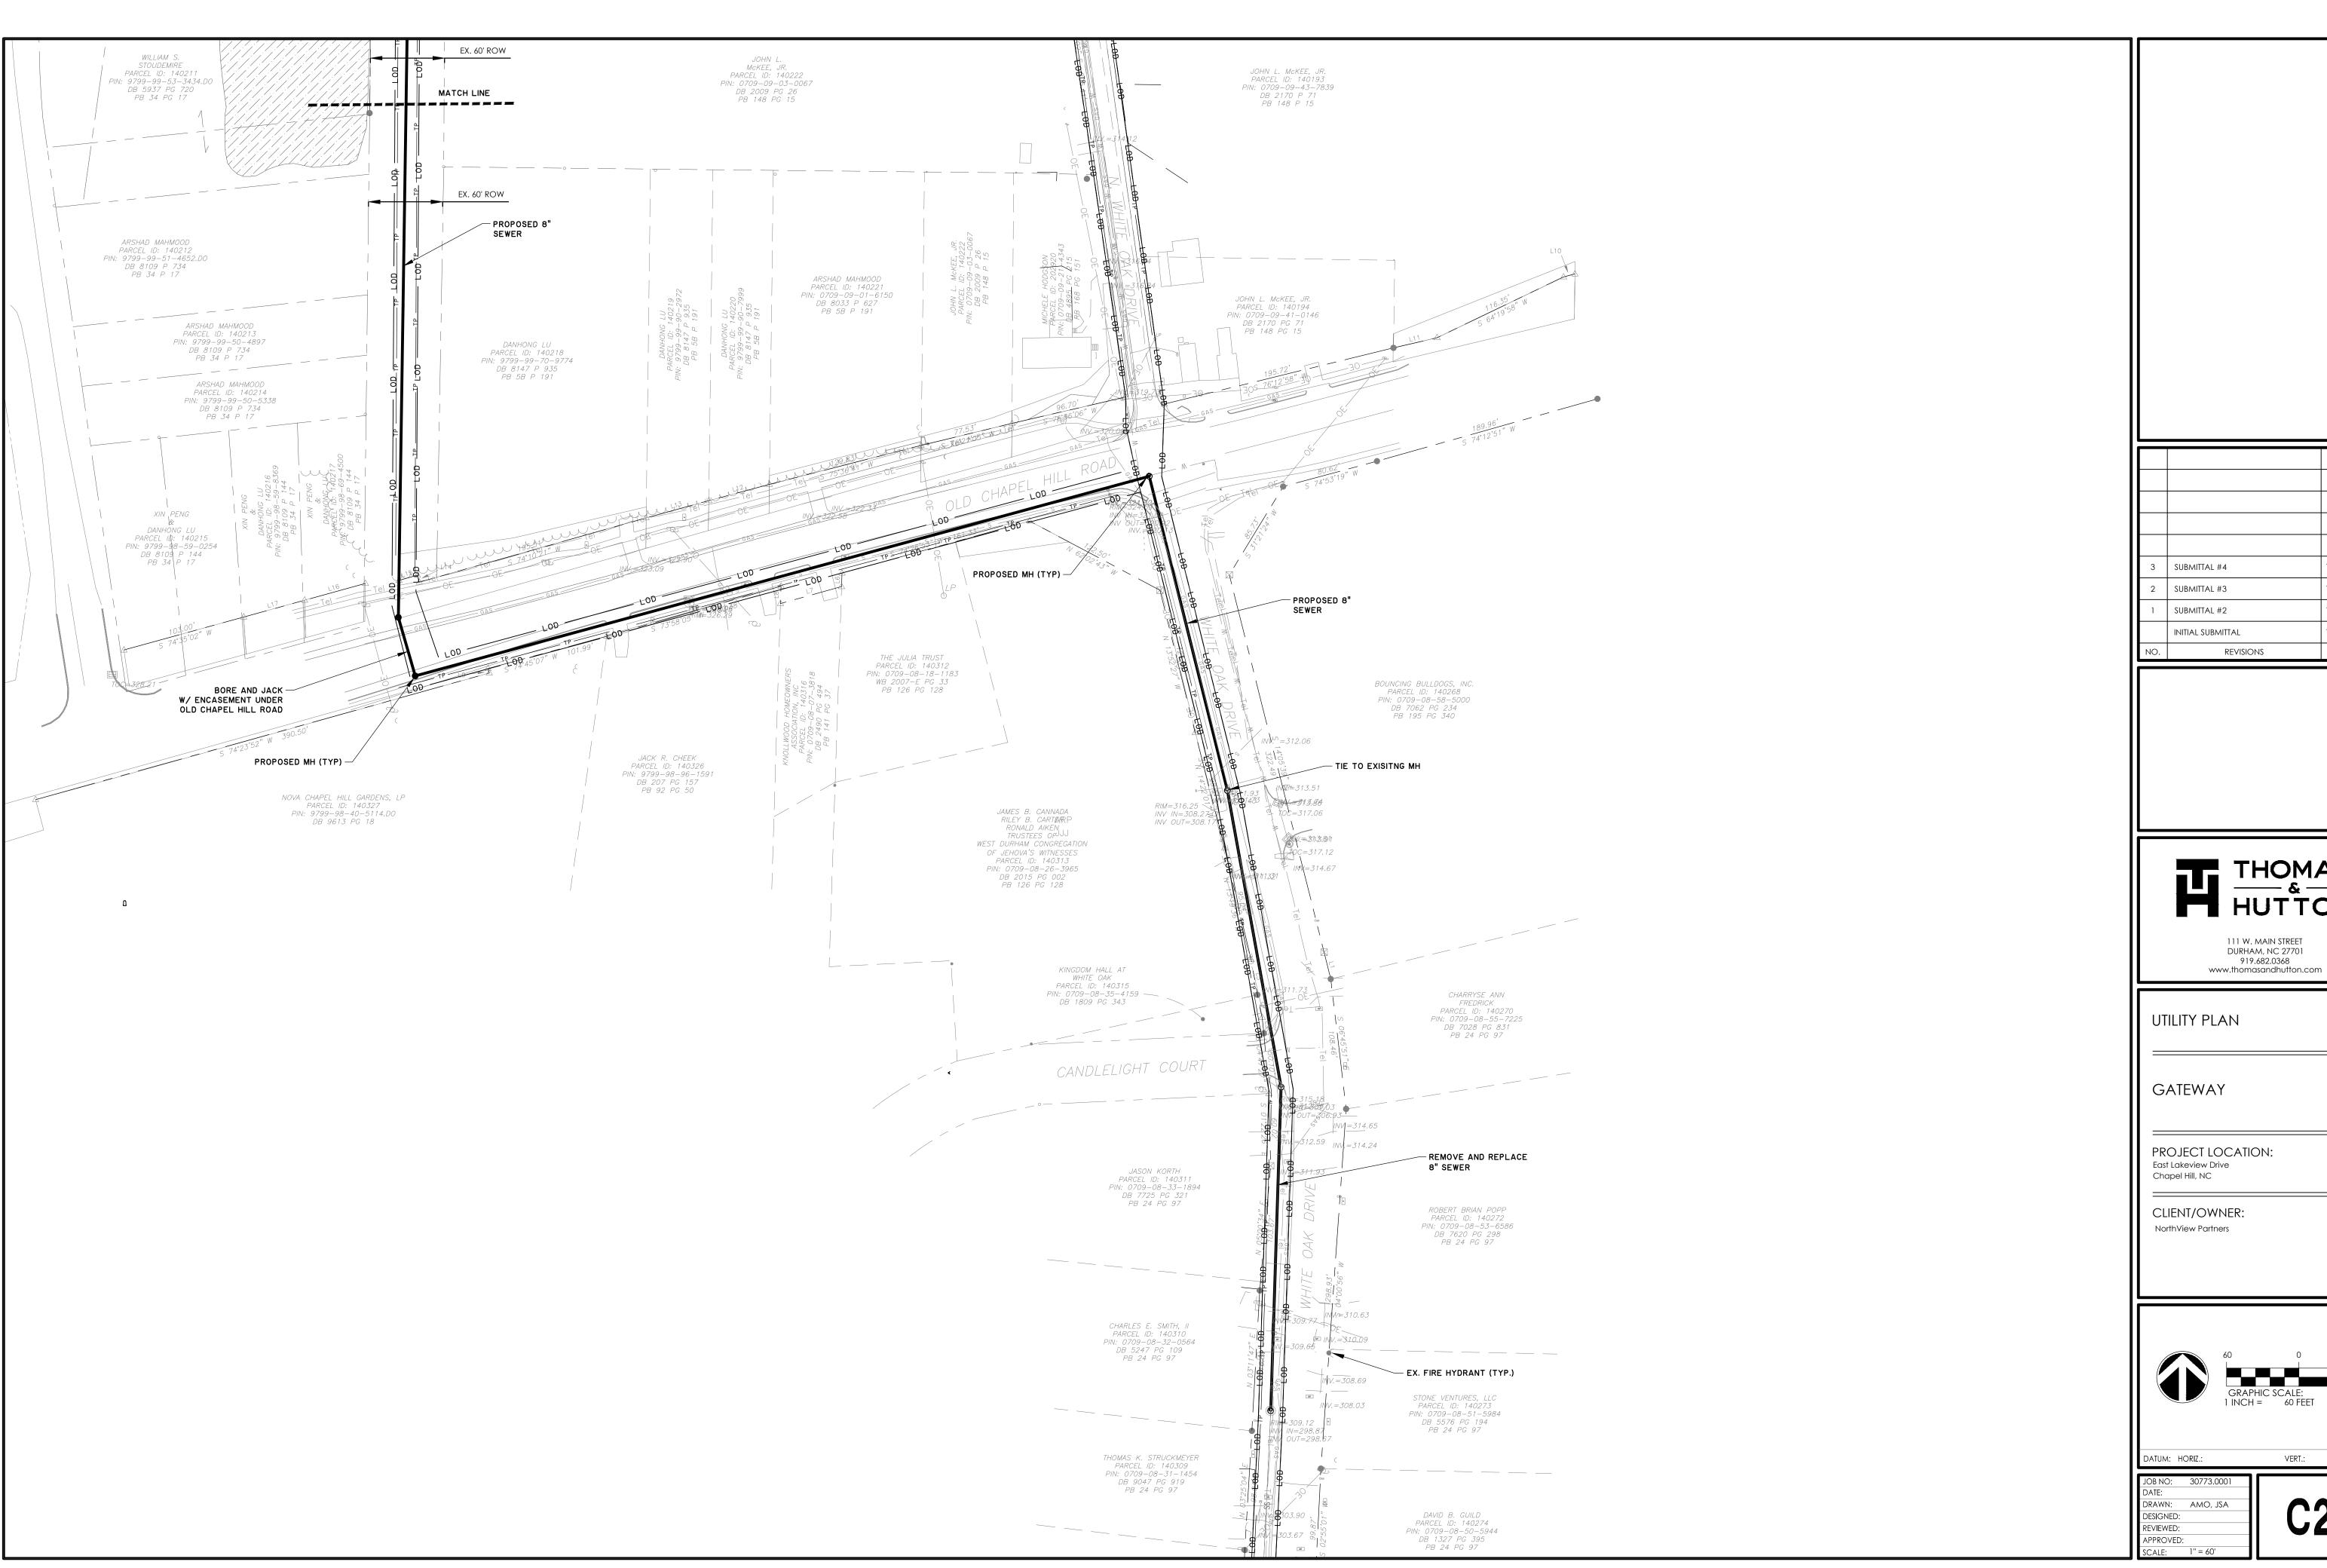

## SITE ACCESSIBILITY NOTES

- 1. ALL BUILDINGS WITHIN THE BOUNDARY OF THIS SITE, UNLESS OTHERWISE STATED AS EXEMPT, SHALL HAVE "ACCESSIBLE ROUTES" AS REQUIRED THAT CONFORM TO THE REQUIREMENTS OF "THE AMERICANS WITH DISABILITIES ACT", "FAIR HOUSING STANDARDS", ICC ANSI A 117.1-209 AND GOVERNING STATE HANDICAP CODE STANDARDS.
- THESE STANDARDS FOR ACCESSIBILITY INCLUDE, BUT ARE NOT LIMITED TO:

MAXIMUM WALK SLOPE = 1:20 MAXIMUM RAMP SLOPE = 1:12 WITH RAILING MAXIMUM CROSS SLOPE = 1:50 (2%) ALL WALKS TO BE BROOM FINISHED CONCRETE UNLESS OTHERWISE

THESE DRAWINGS MAXIMUM ACCESSIBLE ROUTE LENGTH (NC) = 200'

2. THE PAVEMENT SLOPE WITHIN ACCESSIBLE PARKING SPACES SHALL NOT EXCEED 2% IN ALL DIRECTIONS. 1.5% IS RECOMMENDED. 3. CONTRACTOR TO CONTACT DESIGN RESOURCE GROUP FOR ANY VARYING SITE CONDITIONS OR DISCREPANCIES AFFECTING SITE ACCESSIBILITY REQUIREMENTS.

ADDITIONAL ACCESSIBLE ROUTE NOTES FOR ACCESSIBILITY COMPLIANCE WITH \ICC/ANSI A117.1-2009, AND 2010 ADA STANDARDS. 1. PROTRUDING OBJECTS ON CIRCULATION PATHS WITHIN COMMON USE AREAS TO COMPLY WITH ANSI 2009 SECTION 307, INCLUDING: a. PROTRUSION LIMITS: OBJECTS WITH LEADING EDGES MORE THAN 27" AND NOT MORE THAN 80" ABOVE THE FLOOR SHALL PROTRUDE 4" MAXIMUM HORIZONTALLY INTO THE CIRCULATION

> DOOR STOPS. b. POST MOUNTED OBJECTS: OBJECTS ON POSTS OR PYLONS SHALL BE PERMITTED TO OVERHANG 4" MAXIMUM WHERE MORE THAN 27" AND NOT MORE THAN 80" ABOVE THE FLOOR. OBJECTS ON MULTIPLE POSTS OR PYLONS WHERE THE CLEAR DISTANCE BETWEEN THE POSTS OR PYLONS IS GREATER THAN 12" SHALL HAVE THE LOWEST EDGE OF SUCH OBJECT EITHER 27" MAXIMUM

PATH. EXCEPTIONS INCLUDE HANDRAILS, DOOR CLOSERS, AND

- OR 80" MINIMUM ABOVE THE FLOOR. c. REDUCED VERTICAL CLEARANCE: GUARDRAILS OR OTHER BARRIERS SHALL BE PROVIDED WHERE OBJECT PROTRUSION IS BEYOND THE LIMITS ALLOWED BY SECTIONS 307.2 AND 307.3, AND WHERE THE VERTICAL CLEARANCE IS LESS THAN 80" ABOVE THE FLOOR. THE LEADING EDGE OF SUCH GUARDRAIL OR BARRIER SHALL BE 27"
- MAXIMUM ABOVE THE FLOOR. 2. PROTRUDING OBJECTS ON CIRCULATION PATHS WITHIN PUBLIC USE AREAS TO COMPLY WITH 2010 ADA SECTION 307, INCLUDING: a. 2010 ADA SECTION 307.2: OBJECTS PROJECTING FROM WALLS b. 2010 ADA SECTION 307.4: MINIMUM CLEAR HEADROOM 3. FLOOR AND GROUND SURFACES IN COMMON USE AREAS SHALL BE STABLE, FIRM. AND SLIP RESISTANT AND SHALL COMPLY WITH ANSI 2009 SECTIONS 302. 4. FLOOR AND GROUND SURFACES ALONG ACCESSIBLE ROUTES AND IN ACCESSIBLE ROOMS AND SPACES WITH PUBLIC USE AREAS SHALL BE STABLE, FIRM, AND SLIP-RESISTANT AND SHALL COMPLY WITH 2010
- ADA SECTION 302. 5. CHANGES IN LEVEL IN COMMON USE AREAS SHALL COMPLY WITH ANSI 2009 SECTION 303, INCLUDING: a. ANSI 2009 SECTION 303.2: VERTICAL b. ANSI 2009 SECTION 303.3: BEVELED c. ANSI 2009 SECTION 303.4: RAMPS
- 6. CHANGES IN LEVEL ALONG ACCESSIBLE ROUTES AND IN ACCESSIBLE ROOMS AND SPACES WITH PUBLIC USE AREAS SHALL COMPLY WITH 2010 ADA SECTION 303, INCLUDING: a. 2010 ADA SECTION 303.2: VERTICAL b. 2010 ADA SECTION 303.3: BEVELED c. 2010 ADA SECTION 303.4: RAMPS


## TREE PROTECTION NOTES:

- 1. PRIOR TO DEMOLITION, CLEARING, CONSTRUCTION, GRADING, AND INSTALLATION OF EROSION CONTROL MEASURES; TREE PROTECTIVE BARRIERS MUST BE INSTALLED AROUND ALL TREE SAVE AREAS BY THE DEVELOPER AND APPROVED BY THE
- 2. THE TREE PROTECTION FENCE SHALL BE LOCATED ALONG THE PERIMETER OF THE TREE SAVE AREA (DRIP LINE PLUS 5 FEET). TREE PROTECTION FENCING FOR A FOREST CANOPY STANDS AREA IS TO BE LOCATED ALONG THE PERIMETER OF THE TREE SAVE AREA AROUND THE FOREST EDGE. TREE PROTECTION FENCING SHALL CONSIST OF ORANGE SAFETY FENCING OR A COMBINATION OF ORANGE SAFETY FENCING WITH SILT FENCING AT A MINIMUM OF 4 FEET IN HEIGHT ON METAL OR WOOD POSTS.
- 3. ALL TREE PROTECTION AREAS MUST BE DESIGNATED AS SUCH WITH "TREE SAVE AREA SIGNS" POSTED IN ADDITION TO THE REQUIRED PROTECTIVE FENCING. SIGNS REQUESTING SUBCONTRACTOR COOPERATION AND COMPLIANCE WITH TREE PROTECTION STANDARDS ARE RECOMMENDED FOR SITE ENTRANCES.
- 4. NO SOIL DISTURBANCE OR COMPACTION, STOCK PILING OF SOIL OR OTHER CONSTRUCTION MATERIAL, VEHICULAR TRAFFIC, OR STORAGE OF EQUIPMENT AND MATERIALS ARE ALLOWED WITHIN TREE SAVE AREAS.
- 5. NO ROPES, SIGNS, WIRES, UNPROTECTED ELECTRICAL INSTALLATION OR OTHER DEVICE OR MATERIAL, SHALL BE SECURED OR FASTENED AROUND OR THROUGH A TREE OR SHRUB.
- 6. ALL PROTECTIVE MEASURES SHALL BE MAINTAINED THROUGHOUT THE LAND DISTURBING AND CONSTRUCTION PROCESS, AND SHALL NOT BE REMOVED UNTIL FINAL LANDSCAPING IS INSTALLED.
- 7. SEE DETAIL SHEETS FOR TREE PROTECTION, TREE AND SHRUB PLANTING.



LANDSCAPE ARCHITECTURE CIVIL ENGINEERING TRANSPORTATION PLANNING

2459 Wilkinson Blvd, Ste 200 Charlotte, NC 28208 704.343.0608 www.drgrp.com

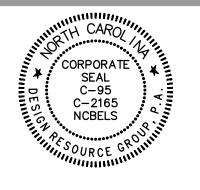


REZONING

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**GRADING &** DRAINAGE **PLAN** 

443-023

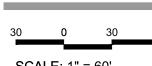


SCALE: 1" = 60'

DRAWN BY: CHECKED BY:

PROJECT #:

JUNE 8, 2023

**REVISIONS:** 

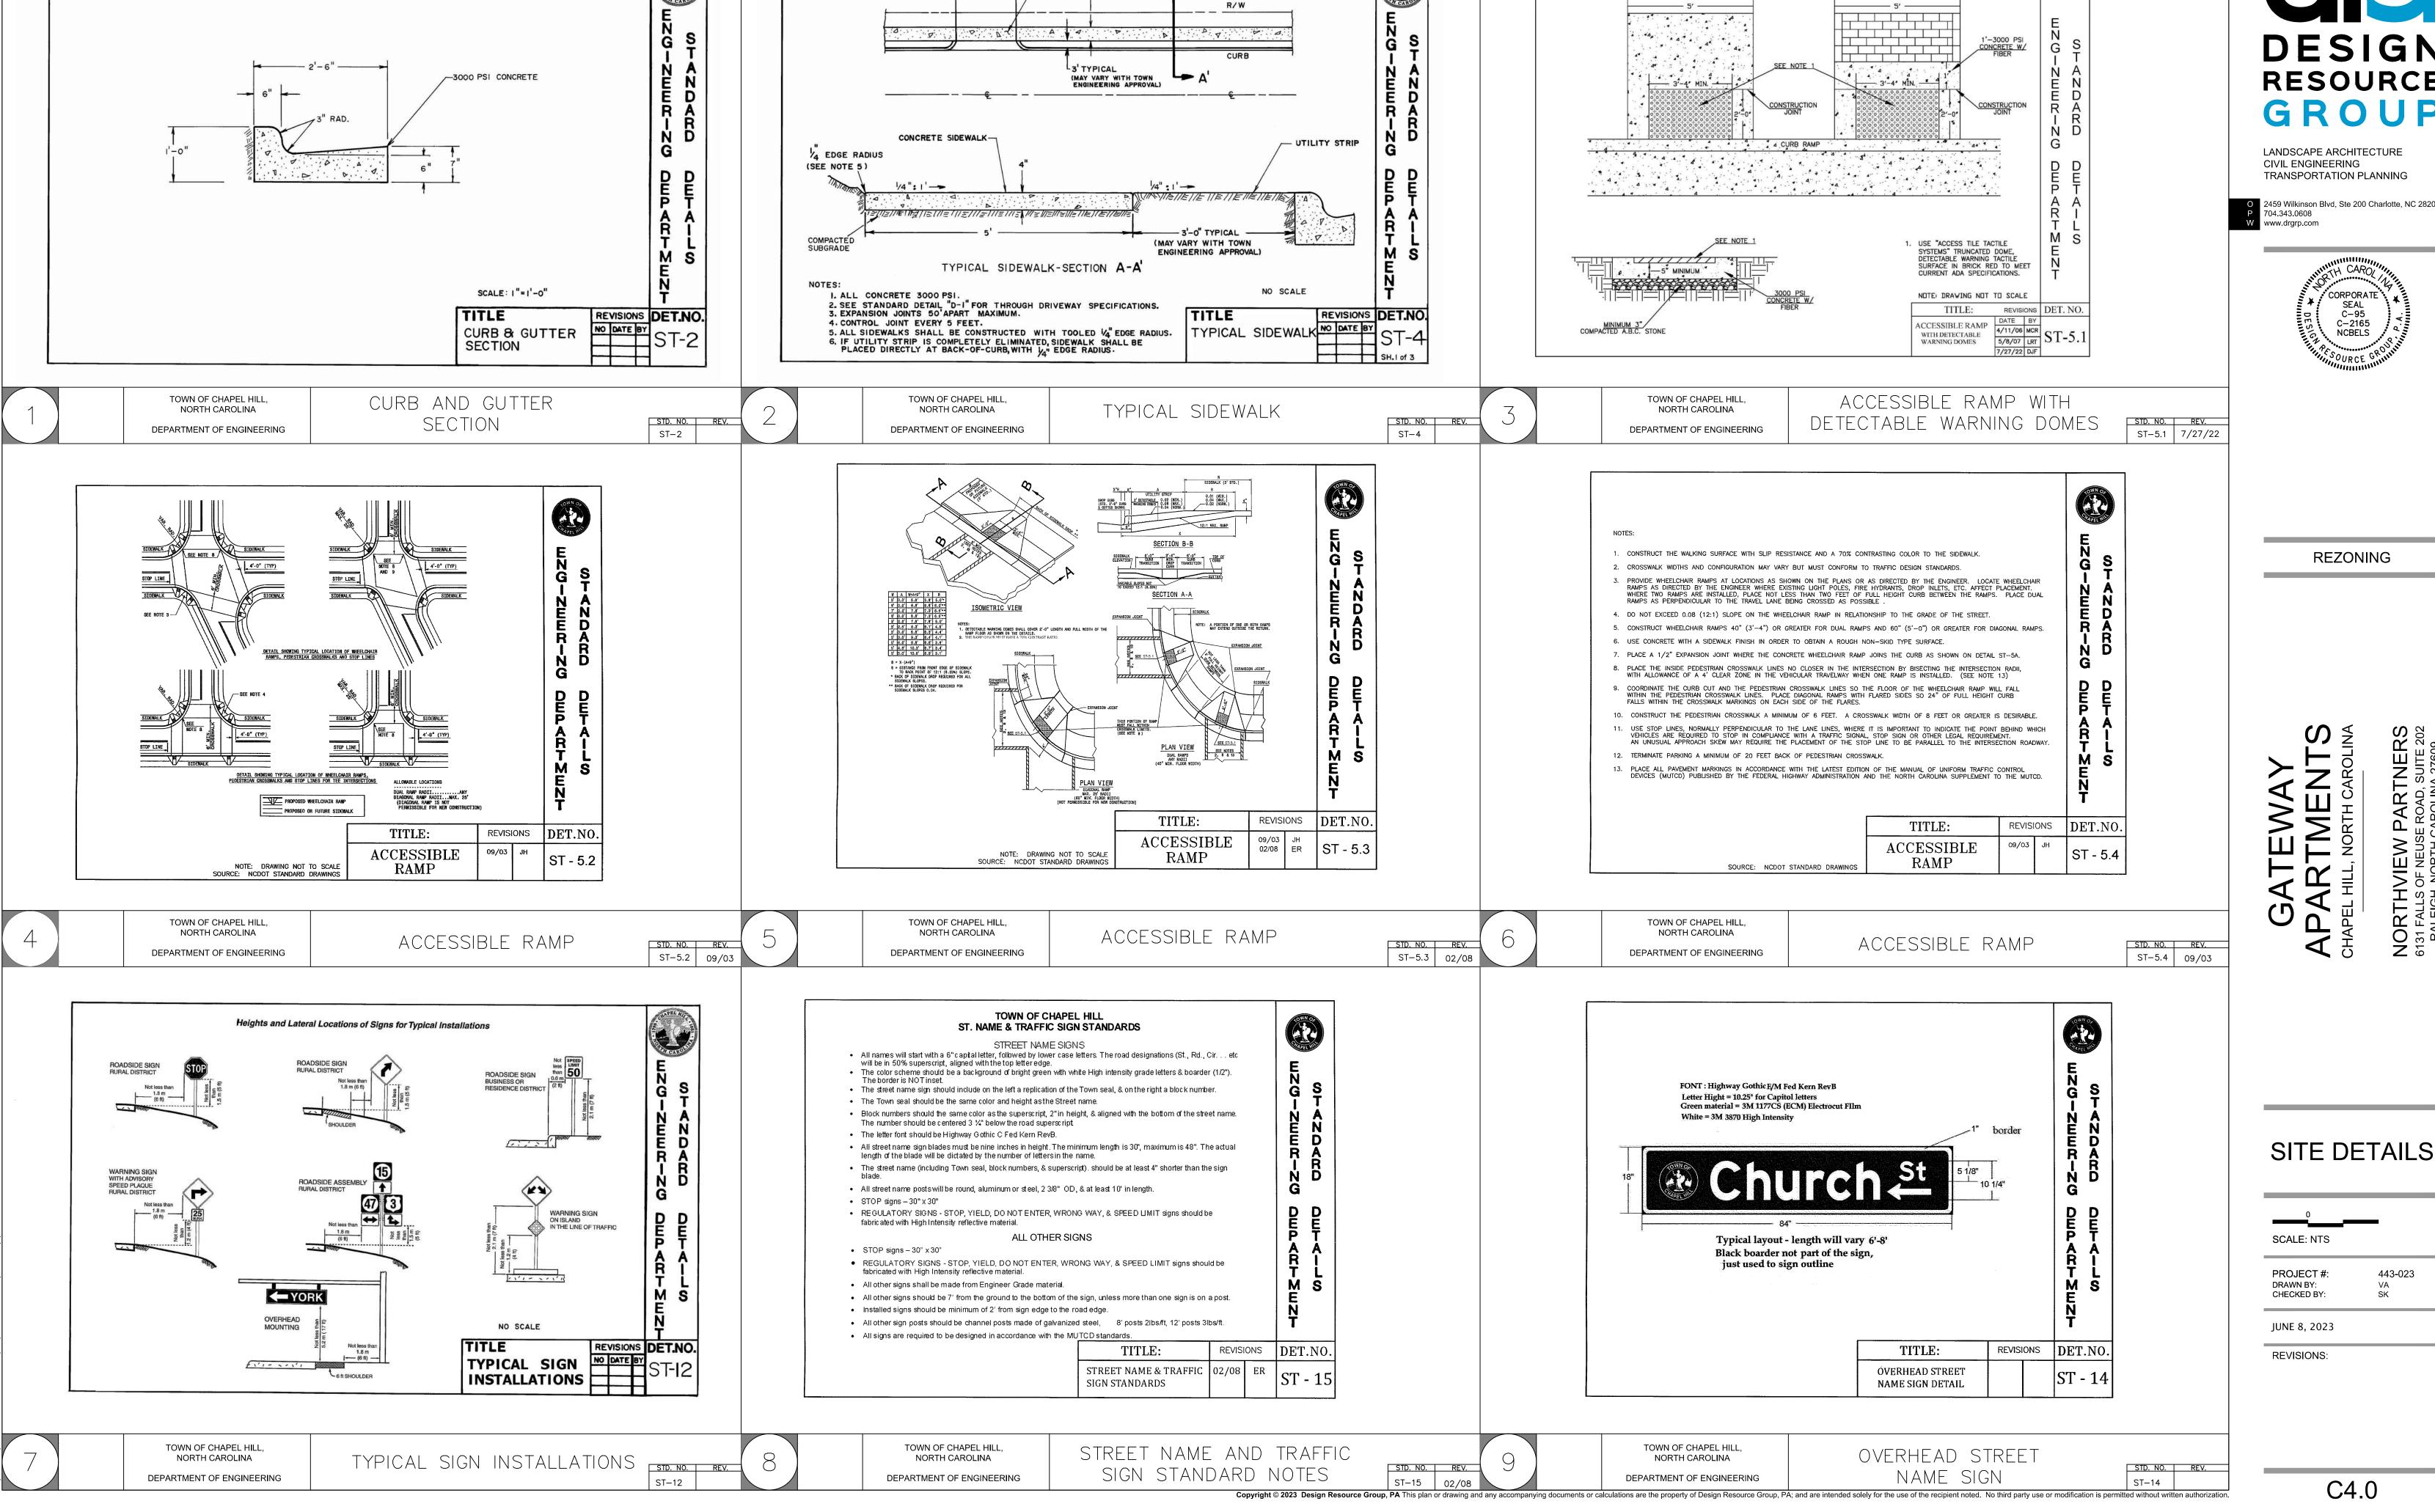

-SEE NOTE 2

5' CONCRETE SIDEWALK 3000 PSI W/FIBER

5' BRICK SIDEWALK WITH RUNNING COURSE


25'-0 MAX.

12'-0 STD.

DESIGN **RESOURCE** GROUP

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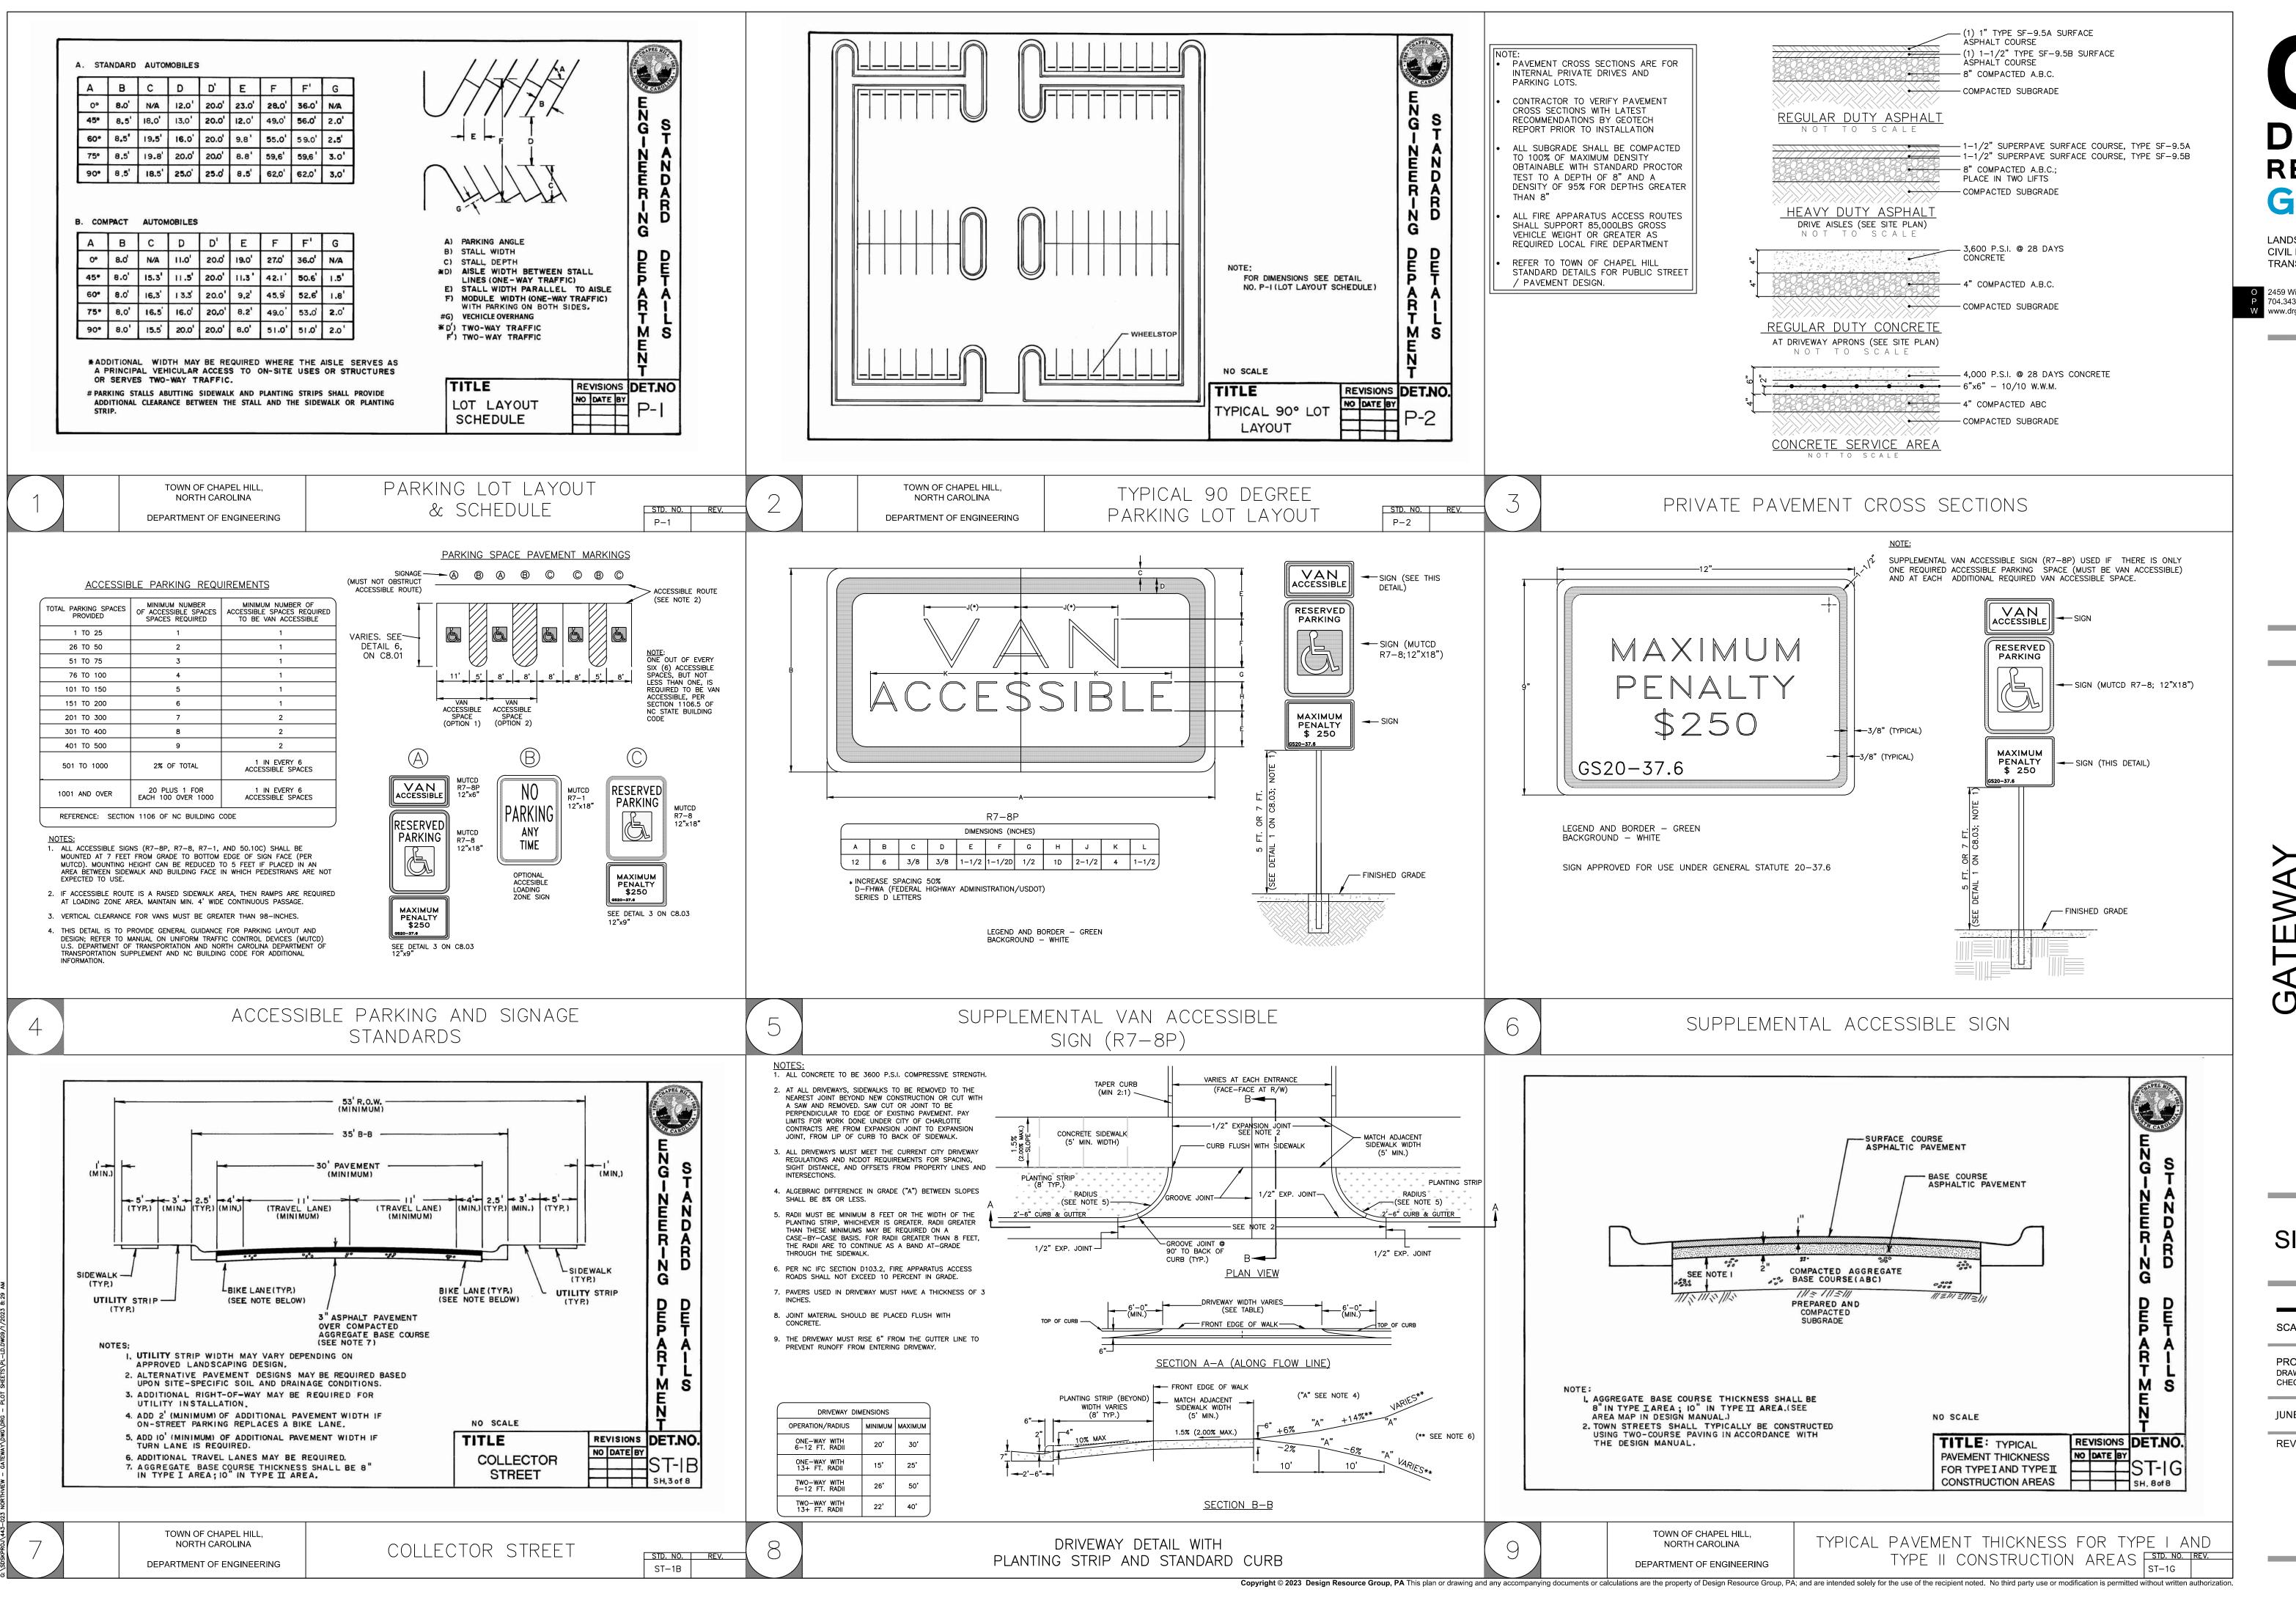
443-023

SCALE: NTS

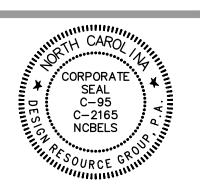PROJECT #: DRAWN BY: CHECKED BY:

**REVISIONS:** 


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REZONING

APARTMENTS
CHAPEL HILL, NORTH CAROLINA

NORTHVIEW PARTNERS
6131 FALLS OF NEUSE ROAD, SUITE 202
RALEIGH, NORTH CAROLINA 27609

SITE DETAILS


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PROJECT #: 443-023
DRAWN BY: VA
CHECKED BY: SK

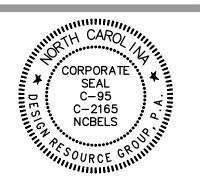JUNE 8, 2023

REVISIONS:


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LANDSCAPE ARCHITECTURE CIVIL ENGINEERING TRANSPORTATION PLANNING

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ARTMENTS
L HILL, NORTH CAROLINA

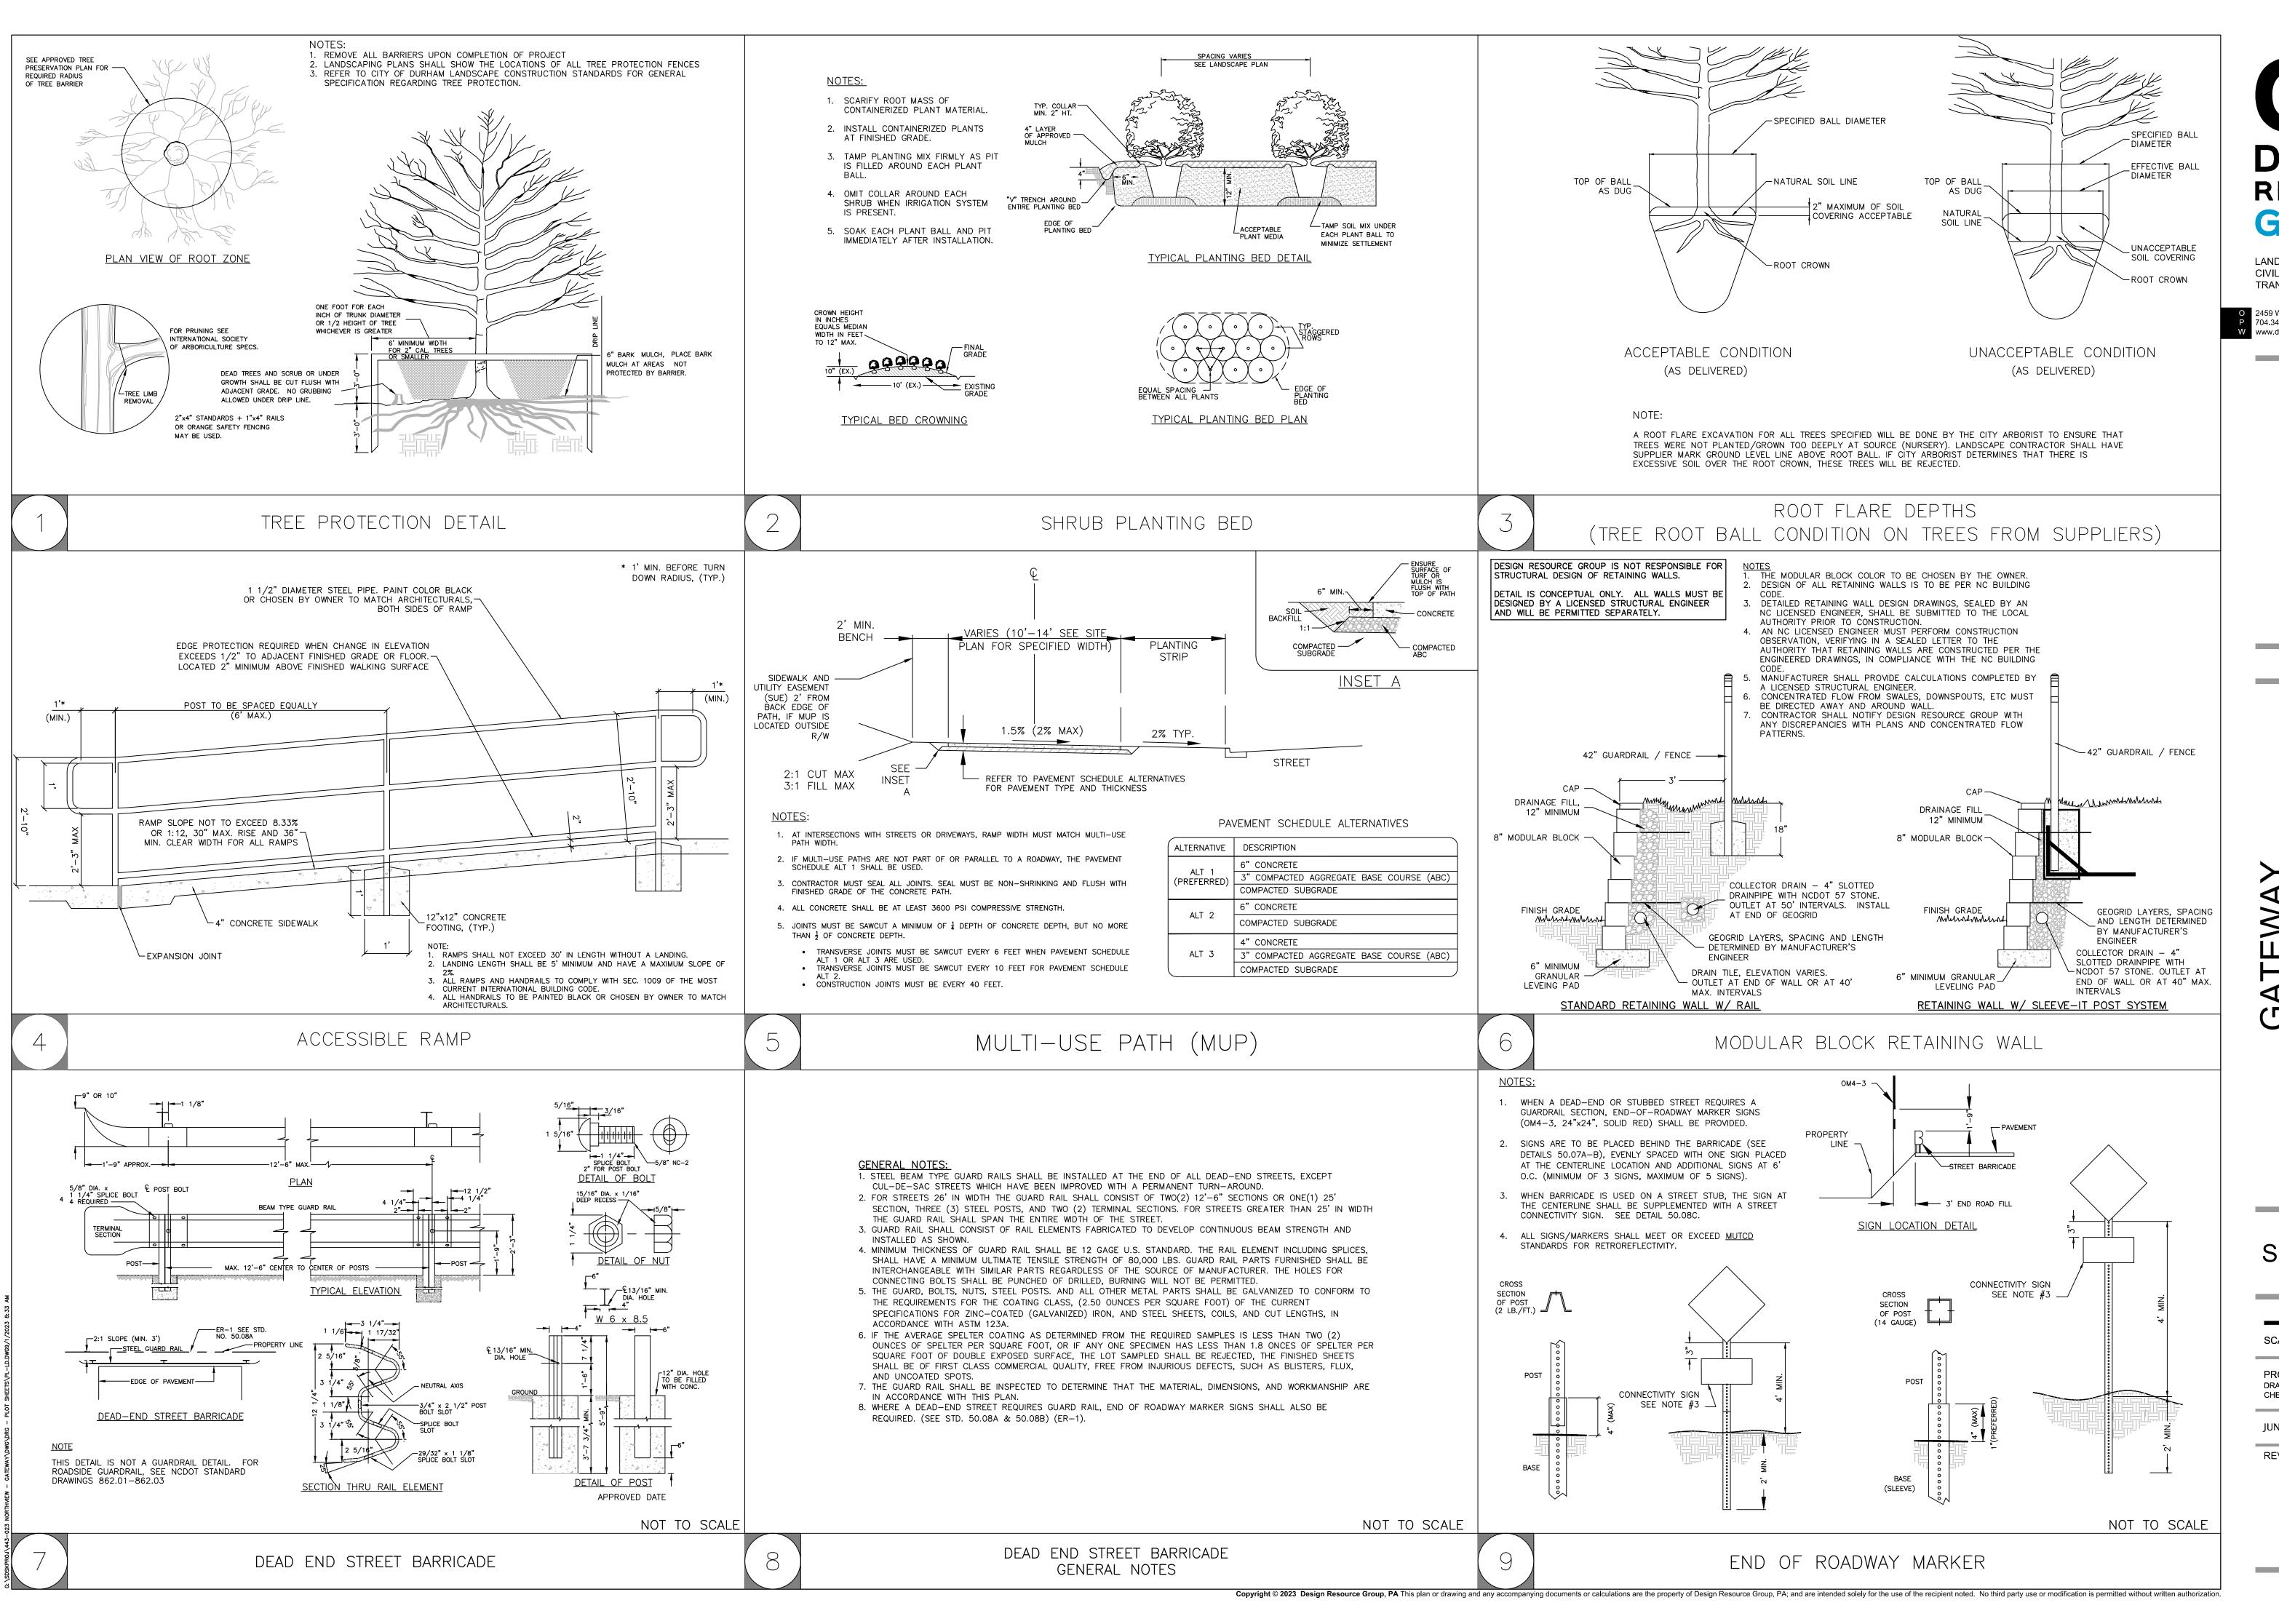SITE DETAILS


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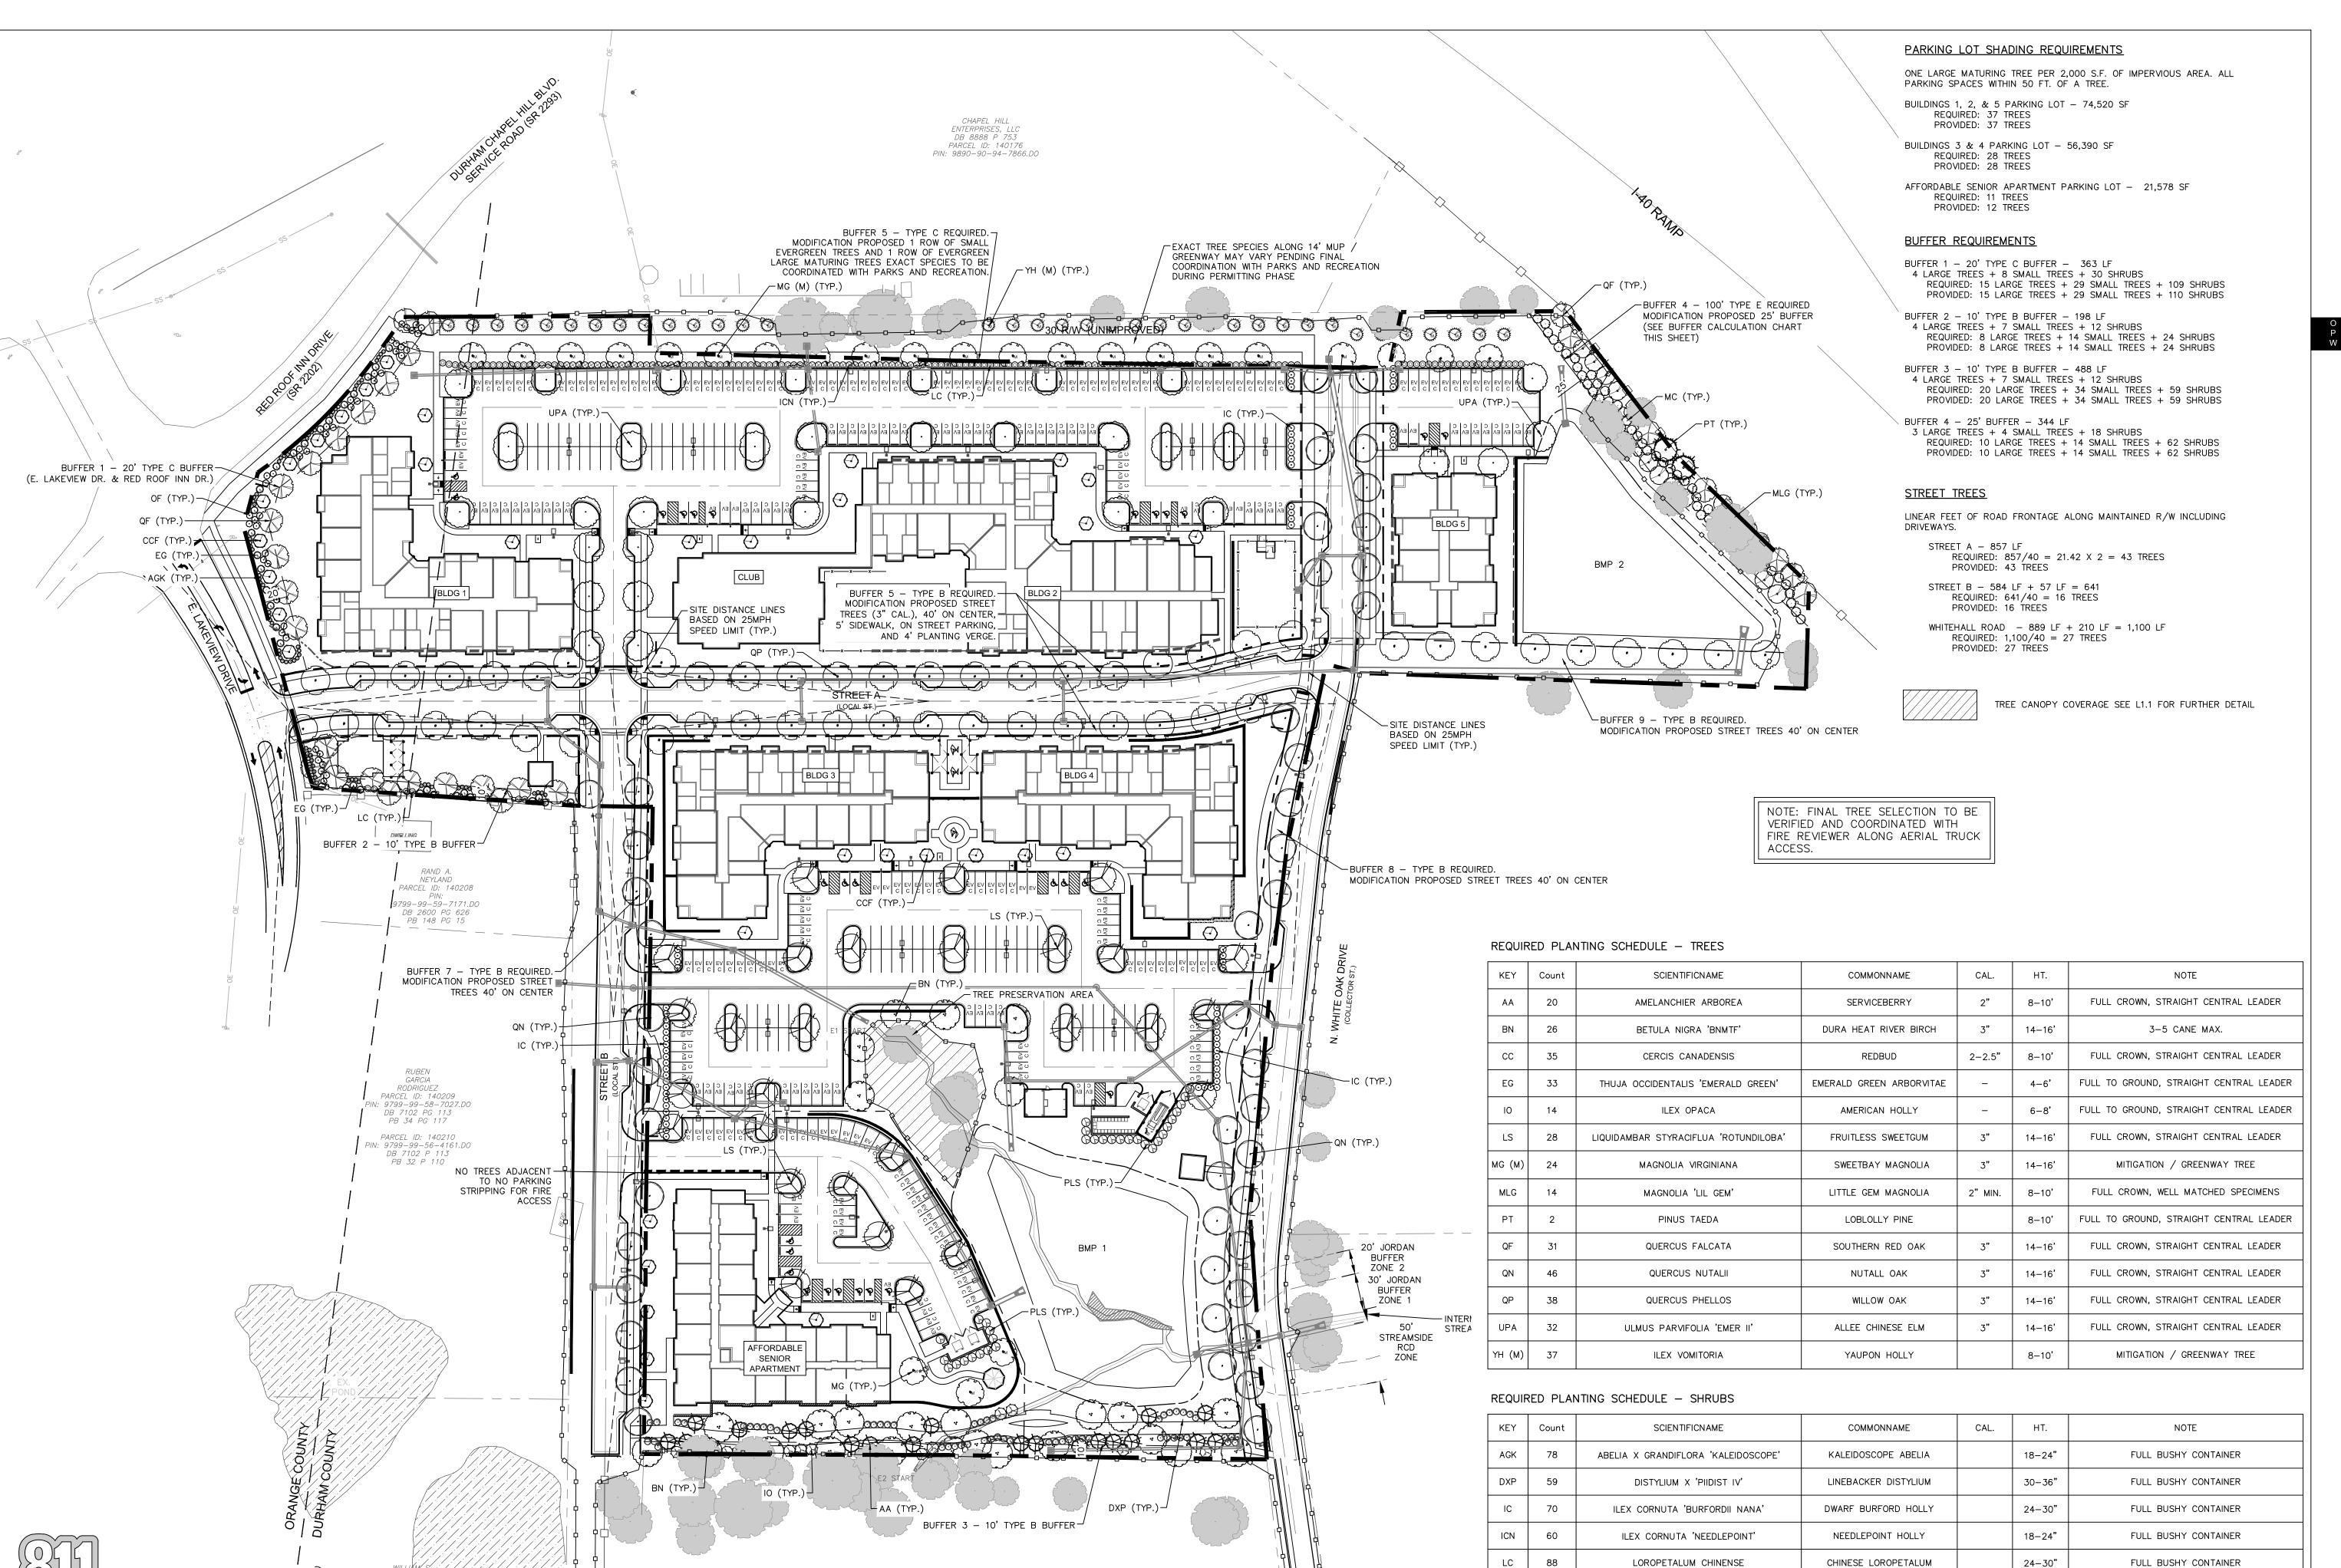
PROJECT #: 443-023
DRAWN BY: VA
CHECKED BY: SK

JUNE 8, 2023

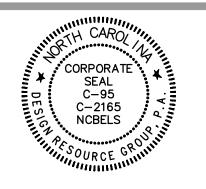REVISIONS:

C4.2



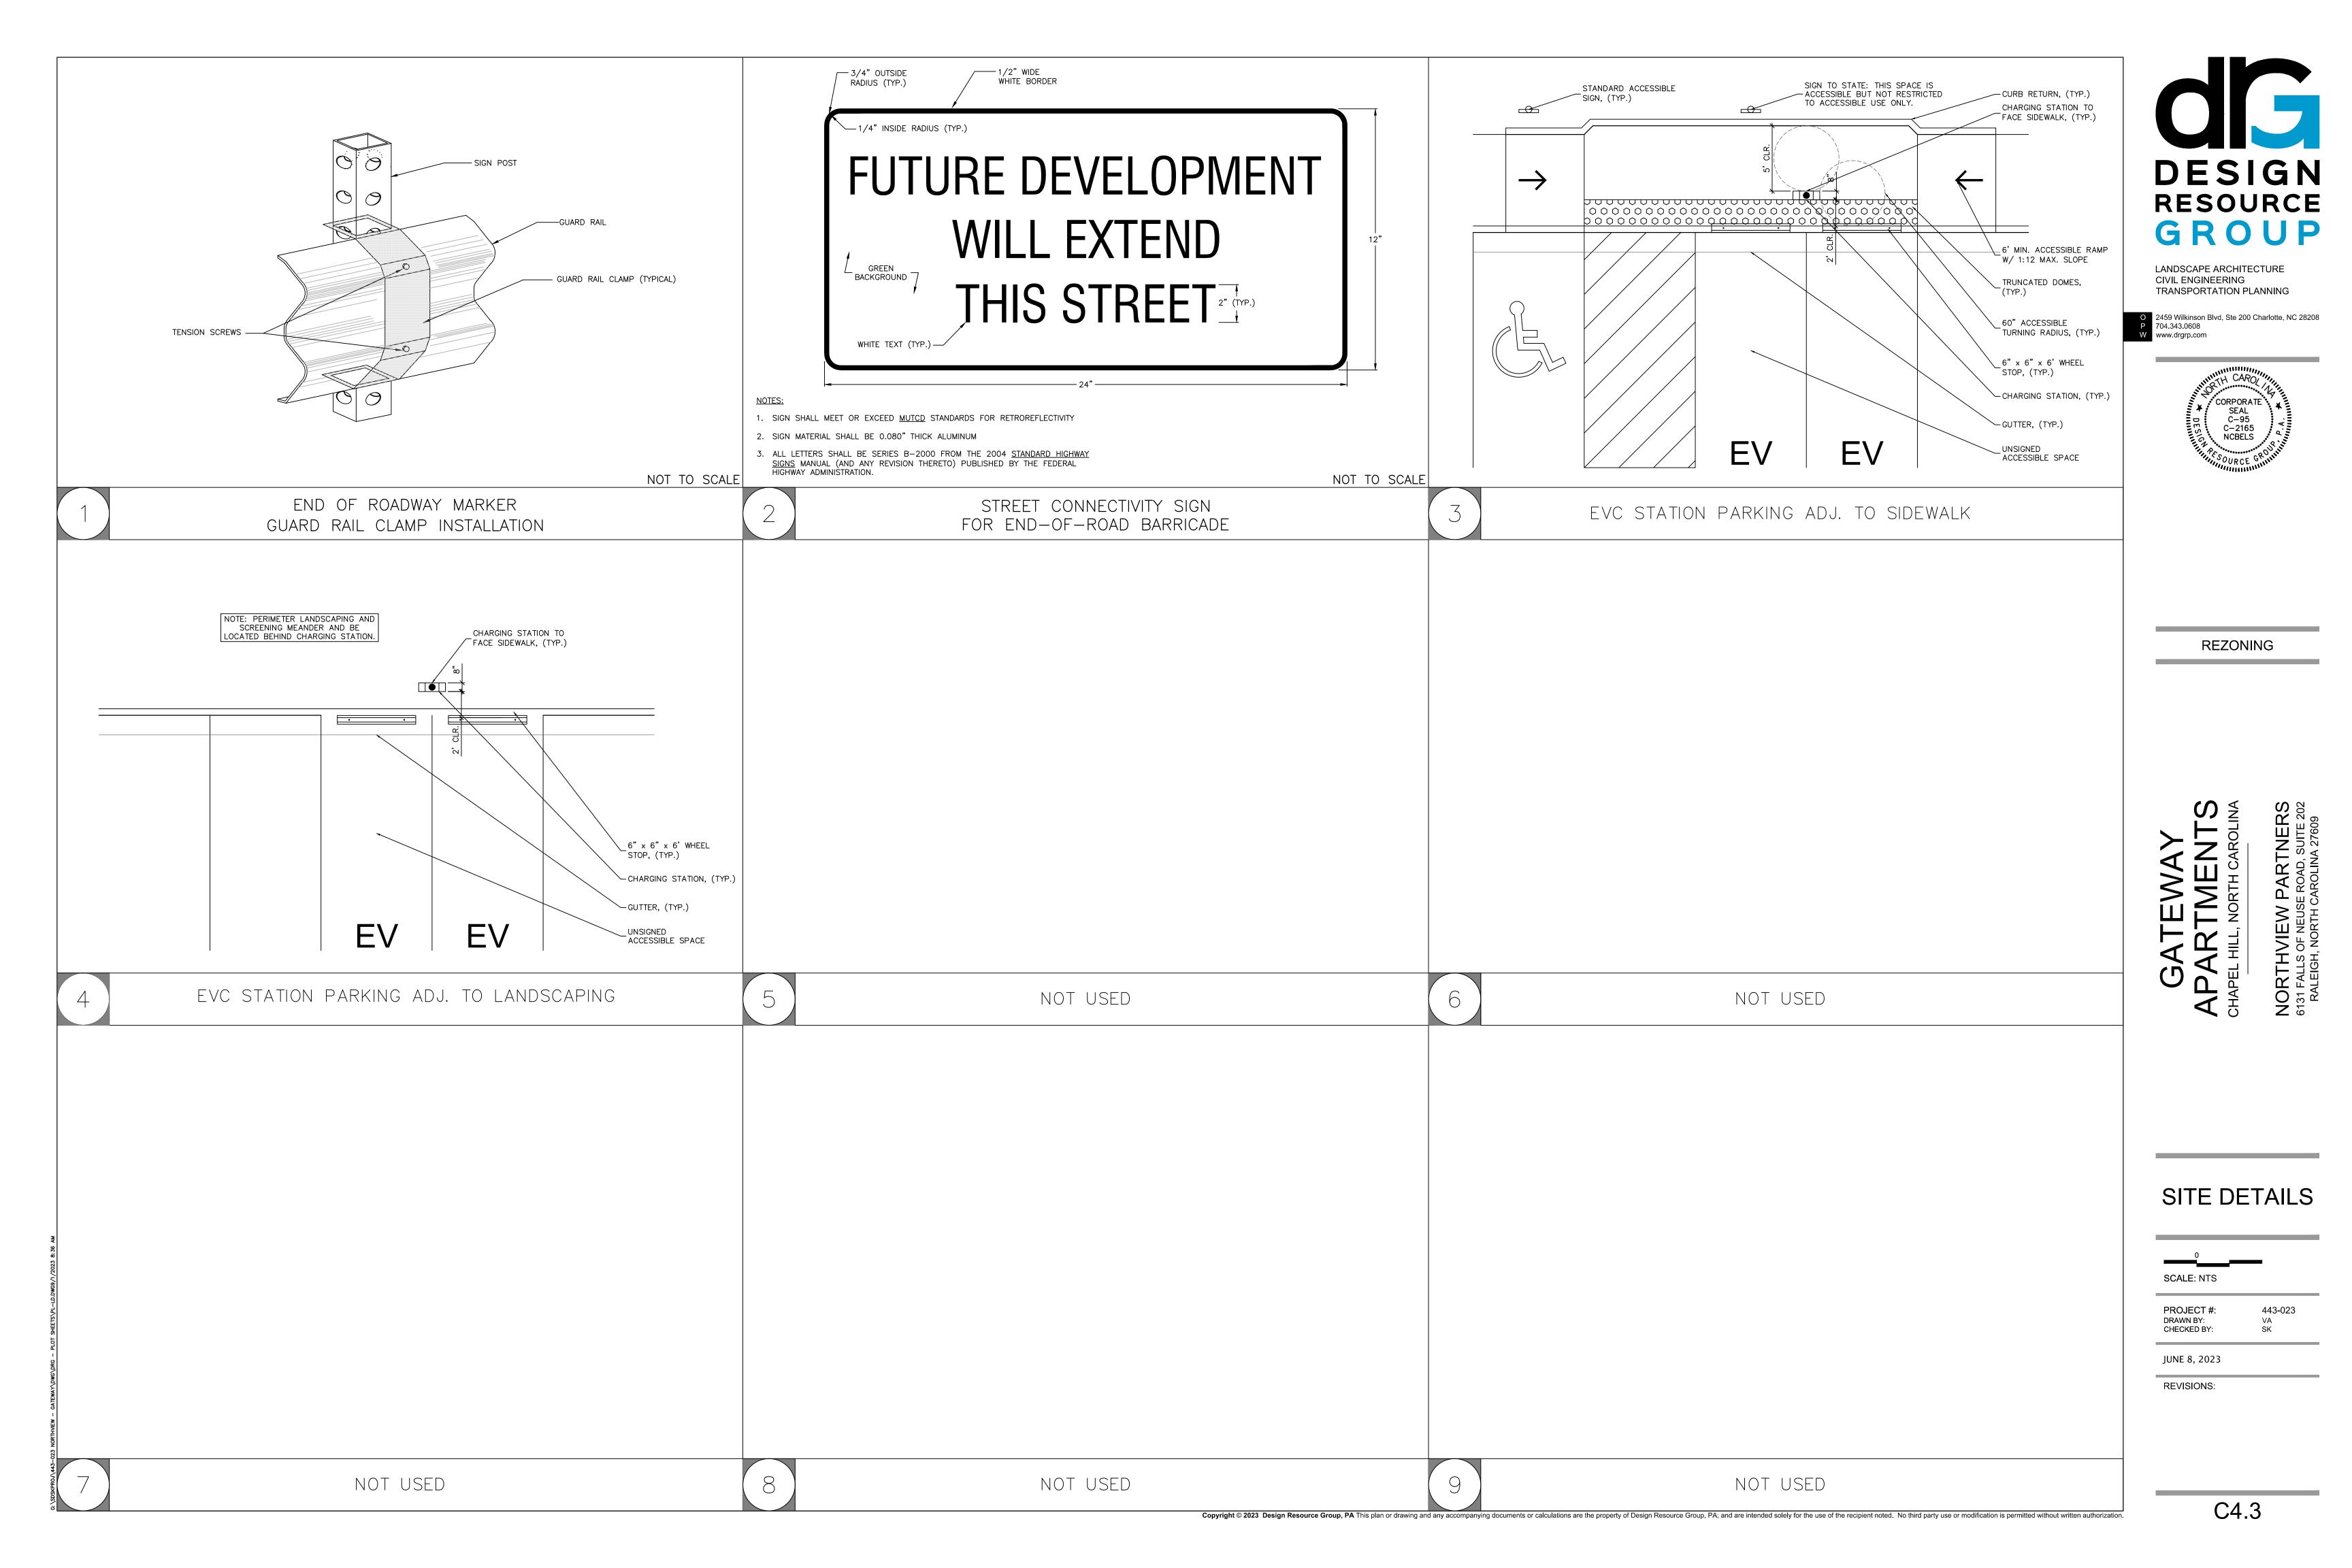

DB 2009 PG 26 PB 148 PG 15

Know what's below.

Call before you dig.

MC

PLS

62

MYRICA CERIFERA

OSMANTHUS FRAGRANS

PRUNUS LAUROCERASUS 'SCHIPKAENSIS'

WAX MYRTLE

FRAGRANT TEA OLIVE


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CITAL DESIGN RESOURCE GROUP

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REZONING

## GATEWAY PARTMENTS PEL HILL, NORTH CAROLINA

NORTHVIEW PARTNE 6131 FALLS OF NEUSE ROAD, SUITE RALEIGH, NORTH CAROLINA 2760

LANDSCAPE

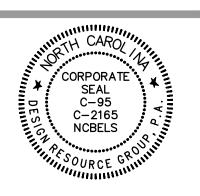30 0 30 60 SCALE: 1" = 60'

PROJECT #: 443-023
DRAWN BY: JO
CHECKED BY: SK

JUNE 8, 2023

REVISIONS:

FULL BUSHY CONTAINER


FULL BUSHY CONTAINER

FULL BUSHY CONTAINER

3-4'

30-36"

30-36"

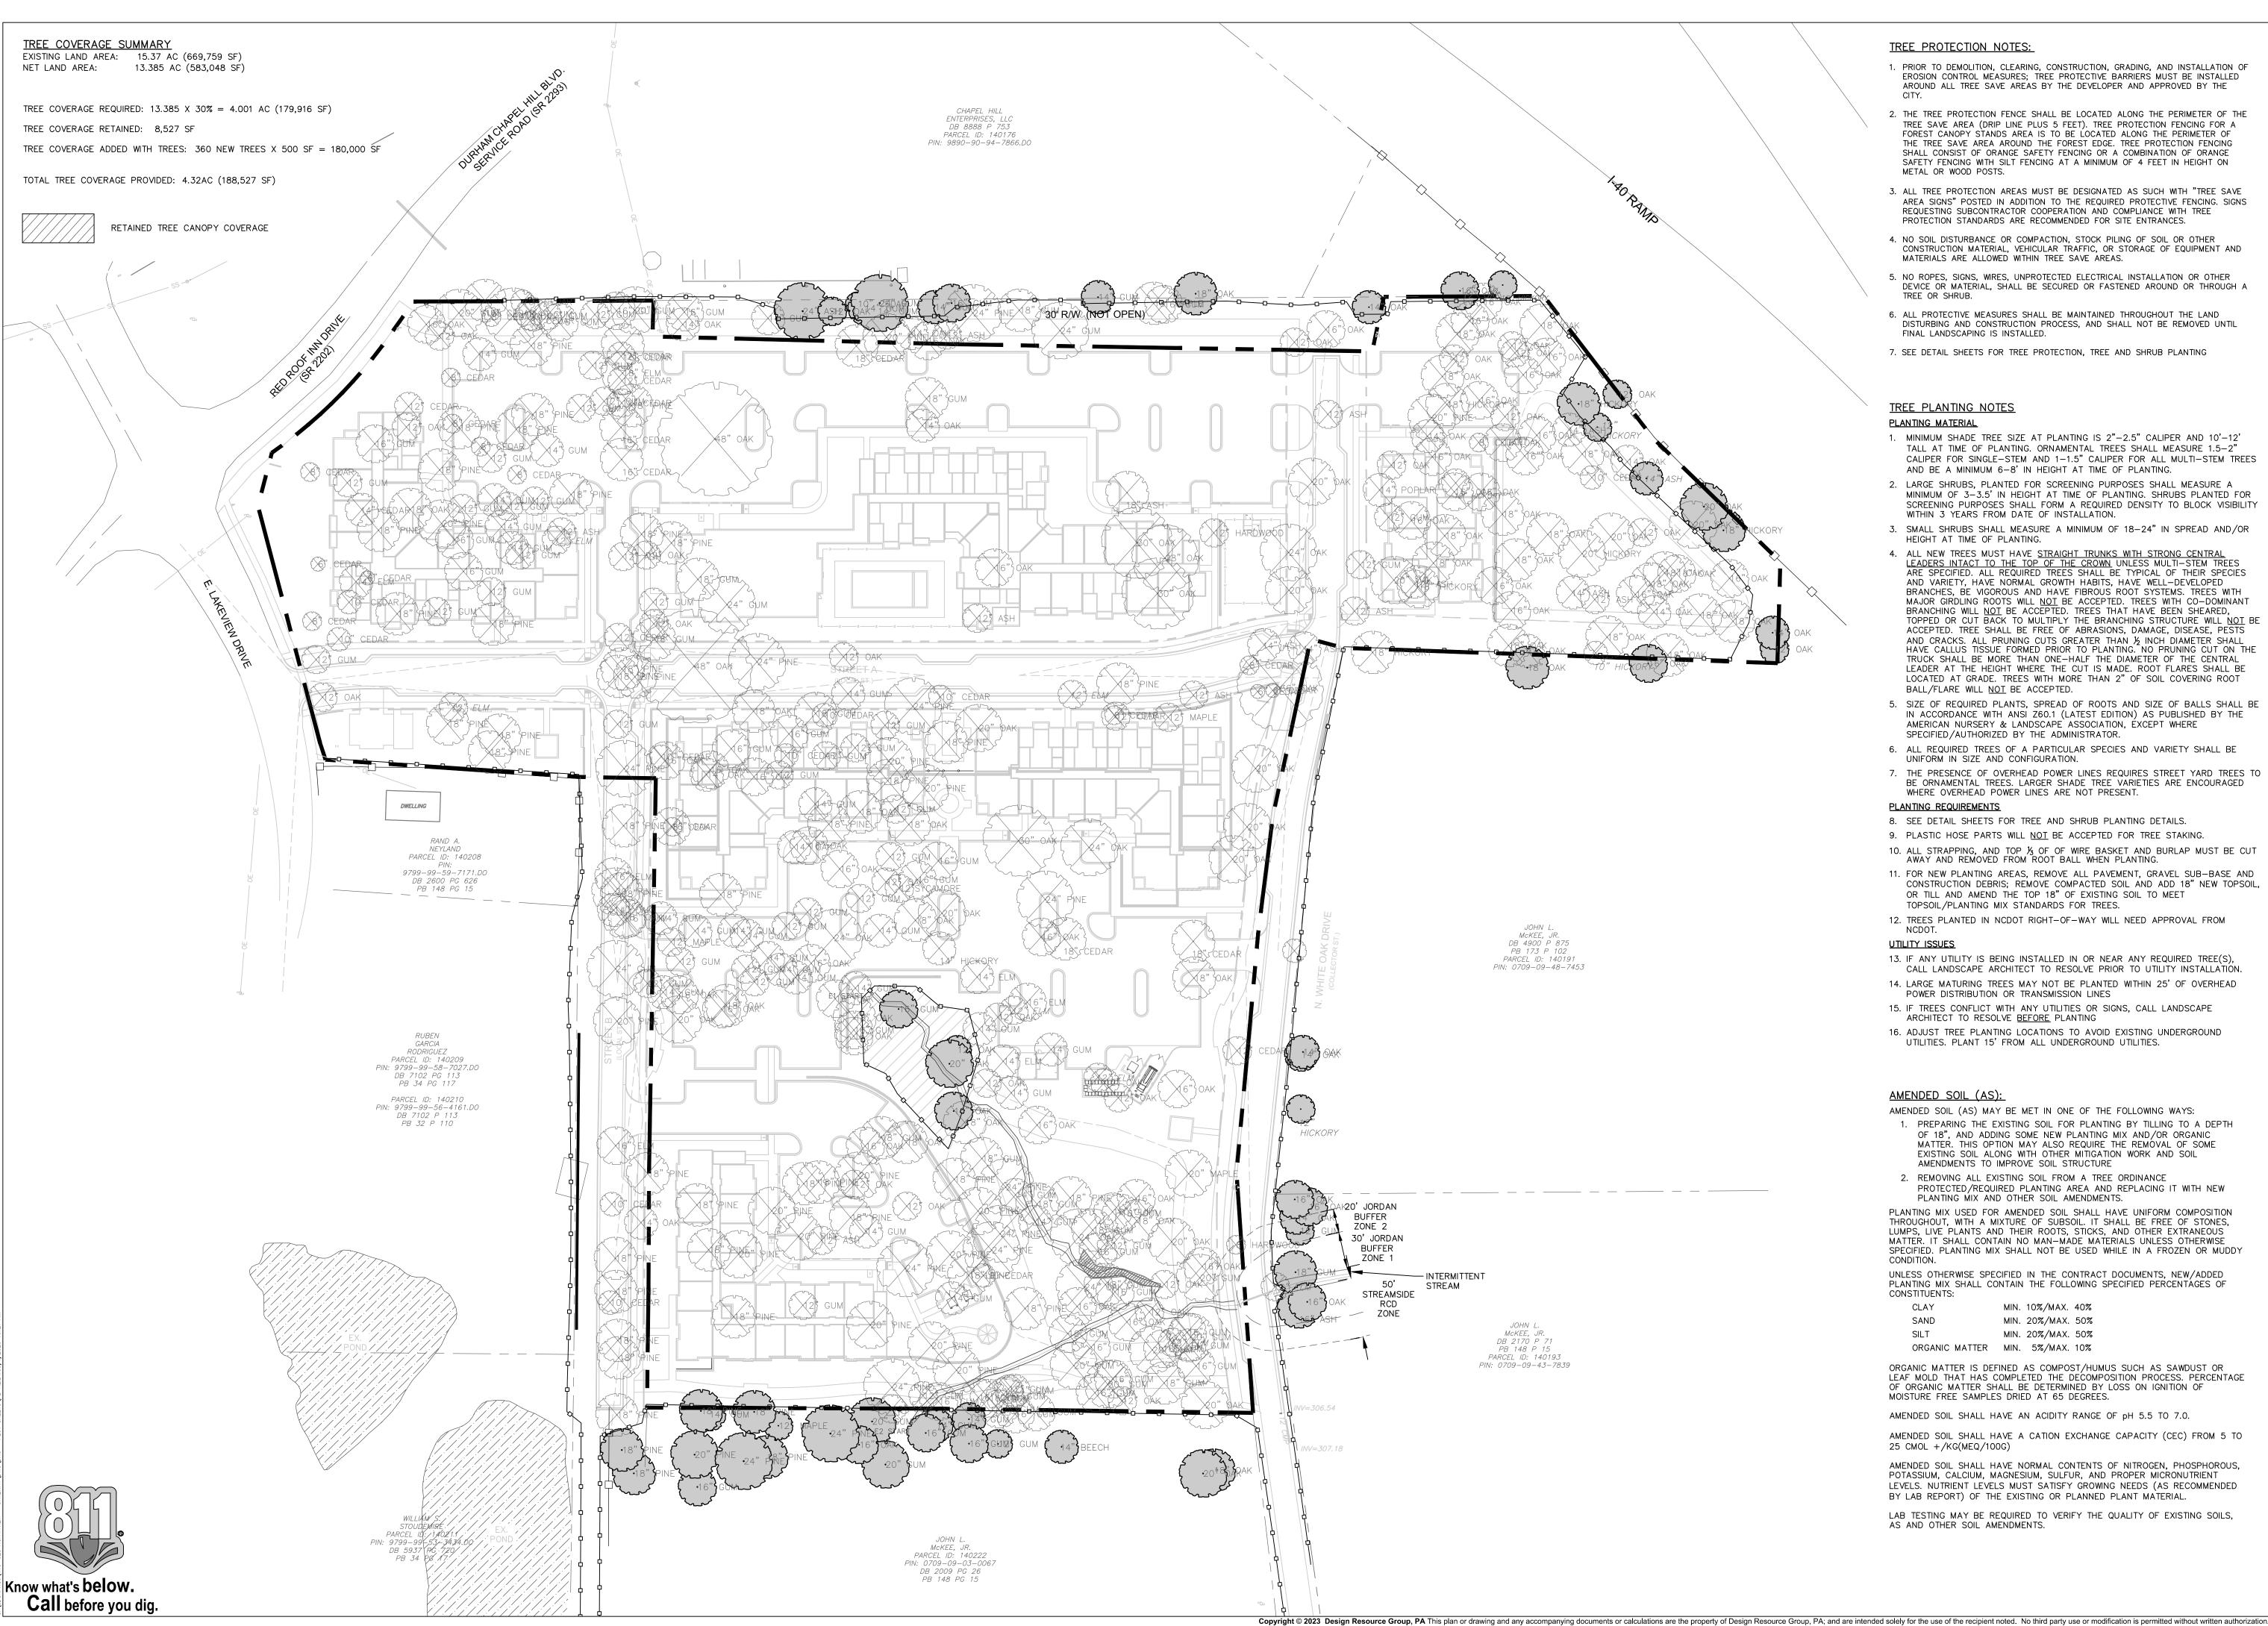

## TREE PROTECTION NOTES:

- 1. PRIOR TO DEMOLITION, CLEARING, CONSTRUCTION, GRADING, AND INSTALLATION OF EROSION CONTROL MEASURES; TREE PROTECTIVE BARRIERS MUST BE INSTALLED AROUND ALL TREE SAVE AREAS BY THE DEVELOPER AND APPROVED BY THE
- 2. THE TREE PROTECTION FENCE SHALL BE LOCATED ALONG THE PERIMETER OF THE TREE SAVE AREA (DRIP LINE PLUS 5 FEET). TREE PROTECTION FENCING FOR A FOREST CANOPY STANDS AREA IS TO BE LOCATED ALONG THE PERIMETER OF THE TREE SAVE AREA AROUND THE FOREST EDGE. TREE PROTECTION FENCING SHALL CONSIST OF ORANGE SAFETY FENCING OR A COMBINATION OF ORANGE SAFETY FENCING WITH SILT FENCING AT A MINIMUM OF 4 FEET IN HEIGHT ON
- 3. ALL TREE PROTECTION AREAS MUST BE DESIGNATED AS SUCH WITH "TREE SAVE AREA SIGNS" POSTED IN ADDITION TO THE REQUIRED PROTECTIVE FENCING. SIGNS REQUESTING SUBCONTRACTOR COOPERATION AND COMPLIANCE WITH TREE PROTECTION STANDARDS ARE RECOMMENDED FOR SITE ENTRANCES.
- 4. NO SOIL DISTURBANCE OR COMPACTION, STOCK PILING OF SOIL OR OTHER CONSTRUCTION MATERIAL, VEHICULAR TRAFFIC, OR STORAGE OF EQUIPMENT AND MATERIALS ARE ALLOWED WITHIN TREE SAVE AREAS.
- 5. NO ROPES, SIGNS, WIRES, UNPROTECTED ELECTRICAL INSTALLATION OR OTHER DEVICE OR MATERIAL, SHALL BE SECURED OR FASTENED AROUND OR THROUGH A TREE OR SHRUB.
- 6. ALL PROTECTIVE MEASURES SHALL BE MAINTAINED THROUGHOUT THE LAND DISTURBING AND CONSTRUCTION PROCESS, AND SHALL NOT BE REMOVED UNTIL
- 7. SEE DETAIL SHEETS FOR TREE PROTECTION, TREE AND SHRUB PLANTING

## TREE PLANTING NOTES

## 1. MINIMUM SHADE TREE SIZE AT PLANTING IS 2"-2.5" CALIPER AND 10'-12' TALL AT TIME OF PLANTING. ORNAMENTAL TREES SHALL MEASURE 1.5-2" CALIPER FOR SINGLE-STEM AND 1-1.5" CALIPER FOR ALL MULTI-STEM TREES

- AND BE A MINIMUM 6-8' IN HEIGHT AT TIME OF PLANTING. 2. LARGE SHRUBS, PLANTED FOR SCREENING PURPOSES SHALL MEASURE A MINIMUM OF 3-3.5' IN HEIGHT AT TIME OF PLANTING. SHRUBS PLANTED FOR SCREENING PURPOSES SHALL FORM A REQUIRED DENSITY TO BLOCK VISIBILITY
- WITHIN 3 YEARS FROM DATE OF INSTALLATION. 3. SMALL SHRUBS SHALL MEASURE A MINIMUM OF 18-24" IN SPREAD AND/OR HEIGHT AT TIME OF PLANTING.
- 4. ALL NEW TREES MUST HAVE <u>STRAIGHT TRUNKS WITH STRONG CENTRAL</u>
  <u>LEADERS INTACT TO THE TOP OF THE CROWN</u> UNLESS MULTI-STEM TREES
  ARE SPECIFIED. ALL REQUIRED TREES SHALL BE TYPICAL OF THEIR SPECIES AND VARIETY, HAVE NORMAL GROWTH HABITS, HAVE WELL-DEVELOPED BRANCHES, BE VIGOROUS AND HAVE FIBROUS ROOT SYSTEMS. TREES WITH MAJOR GIRDLING ROOTS WILL NOT BE ACCEPTED. TREES WITH CO-DOMINANT BRANCHING WILL NOT BE ACCEPTED. TREES THAT HAVE BEEN SHEARED, TOPPED OR CUT BACK TO MULTIPLY THE BRANCHING STRUCTURE WILL NO ACCEPTED. TREE SHALL BE FREE OF ABRASIONS, DAMAGE, DISEASE, PESTS AND CRACKS. ALL PRUNING CUTS GREATER THAN ½ INCH DIAMETER SHALL HAVE CALLUS TISSUE FORMED PRIOR TO PLANTING. NO PRUNING CUT ON THI TRUCK SHALL BE MORE THAN ONE—HALF THE DIAMETER OF THE CENTRAL LEADER AT THE HEIGHT WHERE THE CUT IS MADE. ROOT FLARES SHALL BE LOCATED AT GRADE. TREES WITH MORE THAN 2" OF SOIL COVERING ROOT BALL/FLARE WILL NOT BE ACCEPTED.
- 5. SIZE OF REQUIRED PLANTS, SPREAD OF ROOTS AND SIZE OF BALLS SHALL BE IN ACCORDANCE WITH ANSI Z60.1 (LATEST EDITION) AS PUBLISHED BY THE AMERICAN NURSERY & LANDSCAPE ASSOCIATION, EXCEPT WHERE SPECIFIED/AUTHORIZED BY THE ADMINISTRATOR.
- 6. ALL REQUIRED TREES OF A PARTICULAR SPECIES AND VARIETY SHALL BE UNIFORM IN SIZE AND CONFIGURATION.
- 7. THE PRESENCE OF OVERHEAD POWER LINES REQUIRES STREET YARD TREES TO BE ORNAMENTAL TREES. LARGER SHADE TREE VARIETIES ARE ENCOURAGED WHERE OVERHEAD POWER LINES ARE NOT PRESENT.

## PLANTING REQUIREMENTS

- 8. SEE DETAIL SHEETS FOR TREE AND SHRUB PLANTING DETAILS.
- 9. PLASTIC HOSE PARTS WILL NOT BE ACCEPTED FOR TREE STAKING.
- 10. ALL STRAPPING, AND TOP 1/3 OF OF WIRE BASKET AND BURLAP MUST BE CUT AWAY AND REMOVED FROM ROOT BALL WHEN PLANTING.
- 11. FOR NEW PLANTING AREAS. REMOVE ALL PAVEMENT. GRAVEL SUB-BASE AND CONSTRUCTION DEBRIS; REMOVE COMPACTED SOIL AND ADD 18" NEW TOPSOIL, OR TILL AND AMEND THE TOP 18" OF EXISTING SOIL TO MEET TOPSOIL/PLANTING MIX STANDARDS FOR TREES.
- 12. TREES PLANTED IN NCDOT RIGHT-OF-WAY WILL NEED APPROVAL FROM

## **UTILITY ISSUES**

- 13. IF ANY UTILITY IS BEING INSTALLED IN OR NEAR ANY REQUIRED TREE(S), CALL LANDSCAPE ARCHITECT TO RESOLVE PRIOR TO UTILITY INSTALLATION. 14. LARGE MATURING TREES MAY NOT BE PLANTED WITHIN 25' OF OVERHEAD
- POWER DISTRIBUTION OR TRANSMISSION LINES
- 15. IF TREES CONFLICT WITH ANY UTILITIES OR SIGNS, CALL LANDSCAPE ARCHITECT TO RESOLVE <u>BEFORE</u> PLANTING
- 16. ADJUST TREE PLANTING LOCATIONS TO AVOID EXISTING UNDERGROUND UTILITIES. PLANT 15' FROM ALL UNDERGROUND UTILITIES.

## AMENDED SOIL (AS):

- AMENDED SOIL (AS) MAY BE MET IN ONE OF THE FOLLOWING WAYS: 1. PREPARING THE EXISTING SOIL FOR PLANTING BY TILLING TO A DEPTH OF 18", AND ADDING SOME NEW PLANTING MIX AND/OR ORGANIC MATTER. THIS OPTION MAY ALSO REQUIRE THE REMOVAL OF SOME EXISTING SOIL ALONG WITH OTHER MITIGATION WORK AND SOIL AMENDMENTS TO IMPROVE SOIL STRUCTURE
- 2. REMOVING ALL EXISTING SOIL FROM A TREE ORDINANCE PROTECTED/REQUIRED PLANTING AREA AND REPLACING IT WITH NEW PLANTING MIX AND OTHER SOIL AMENDMENTS.
- PLANTING MIX USED FOR AMENDED SOIL SHALL HAVE UNIFORM COMPOSITION THROUGHOUT, WITH A MIXTURE OF SUBSOIL. IT SHALL BE FREE OF STONES, LUMPS, LIVE PLANTS AND THEIR ROOTS, STICKS, AND OTHER EXTRANEOUS MATTER. IT SHALL CONTAIN NO MAN-MADE MATERIALS UNLESS OTHERWISE SPECIFIED. PLANTING MIX SHALL NOT BE USED WHILE IN A FROZEN OR MUDDY CONDITION.
- UNLESS OTHERWISE SPECIFIED IN THE CONTRACT DOCUMENTS, NEW/ADDED PLANTING MIX SHALL CONTAIN THE FOLLOWING SPECIFIED PERCENTAGES OF CONSTITUENTS:

CLAY MIN. 10%/MAX. 40% SAND MIN. 20%/MAX. 50% MIN. 20%/MAX. 50%

ORGANIC MATTER IS DEFINED AS COMPOST/HUMUS SUCH AS SAWDUST OR LEAF MOLD THAT HAS COMPLETED THE DECOMPOSITION PROCESS. PERCENTAGE OF ORGANIC MATTER SHALL BE DETERMINED BY LOSS ON IGNITION OF MOISTURE FREE SAMPLES DRIED AT 65 DEGREES.

AMENDED SOIL SHALL HAVE AN ACIDITY RANGE OF pH 5.5 TO 7.0.

AMENDED SOIL SHALL HAVE A CATION EXCHANGE CAPACITY (CEC) FROM 5 TO 25 CMOL +/KG(MEQ/100G)


AMENDED SOIL SHALL HAVE NORMAL CONTENTS OF NITROGEN, PHOSPHOROUS, POTASSIUM, CALCIUM, MAGNESIUM, SULFUR, AND PROPER MICRONUTRIENT LEVELS. NUTRIENT LEVELS MUST SATISFY GROWING NEEDS (AS RECOMMENDED BY LAB REPORT) OF THE EXISTING OR PLANNED PLANT MATERIAL.

LAB TESTING MAY BE REQUIRED TO VERIFY THE QUALITY OF EXISTING SOILS, AS AND OTHER SOIL AMENDMENTS.

**DESIGN RESOURCE** GROUP

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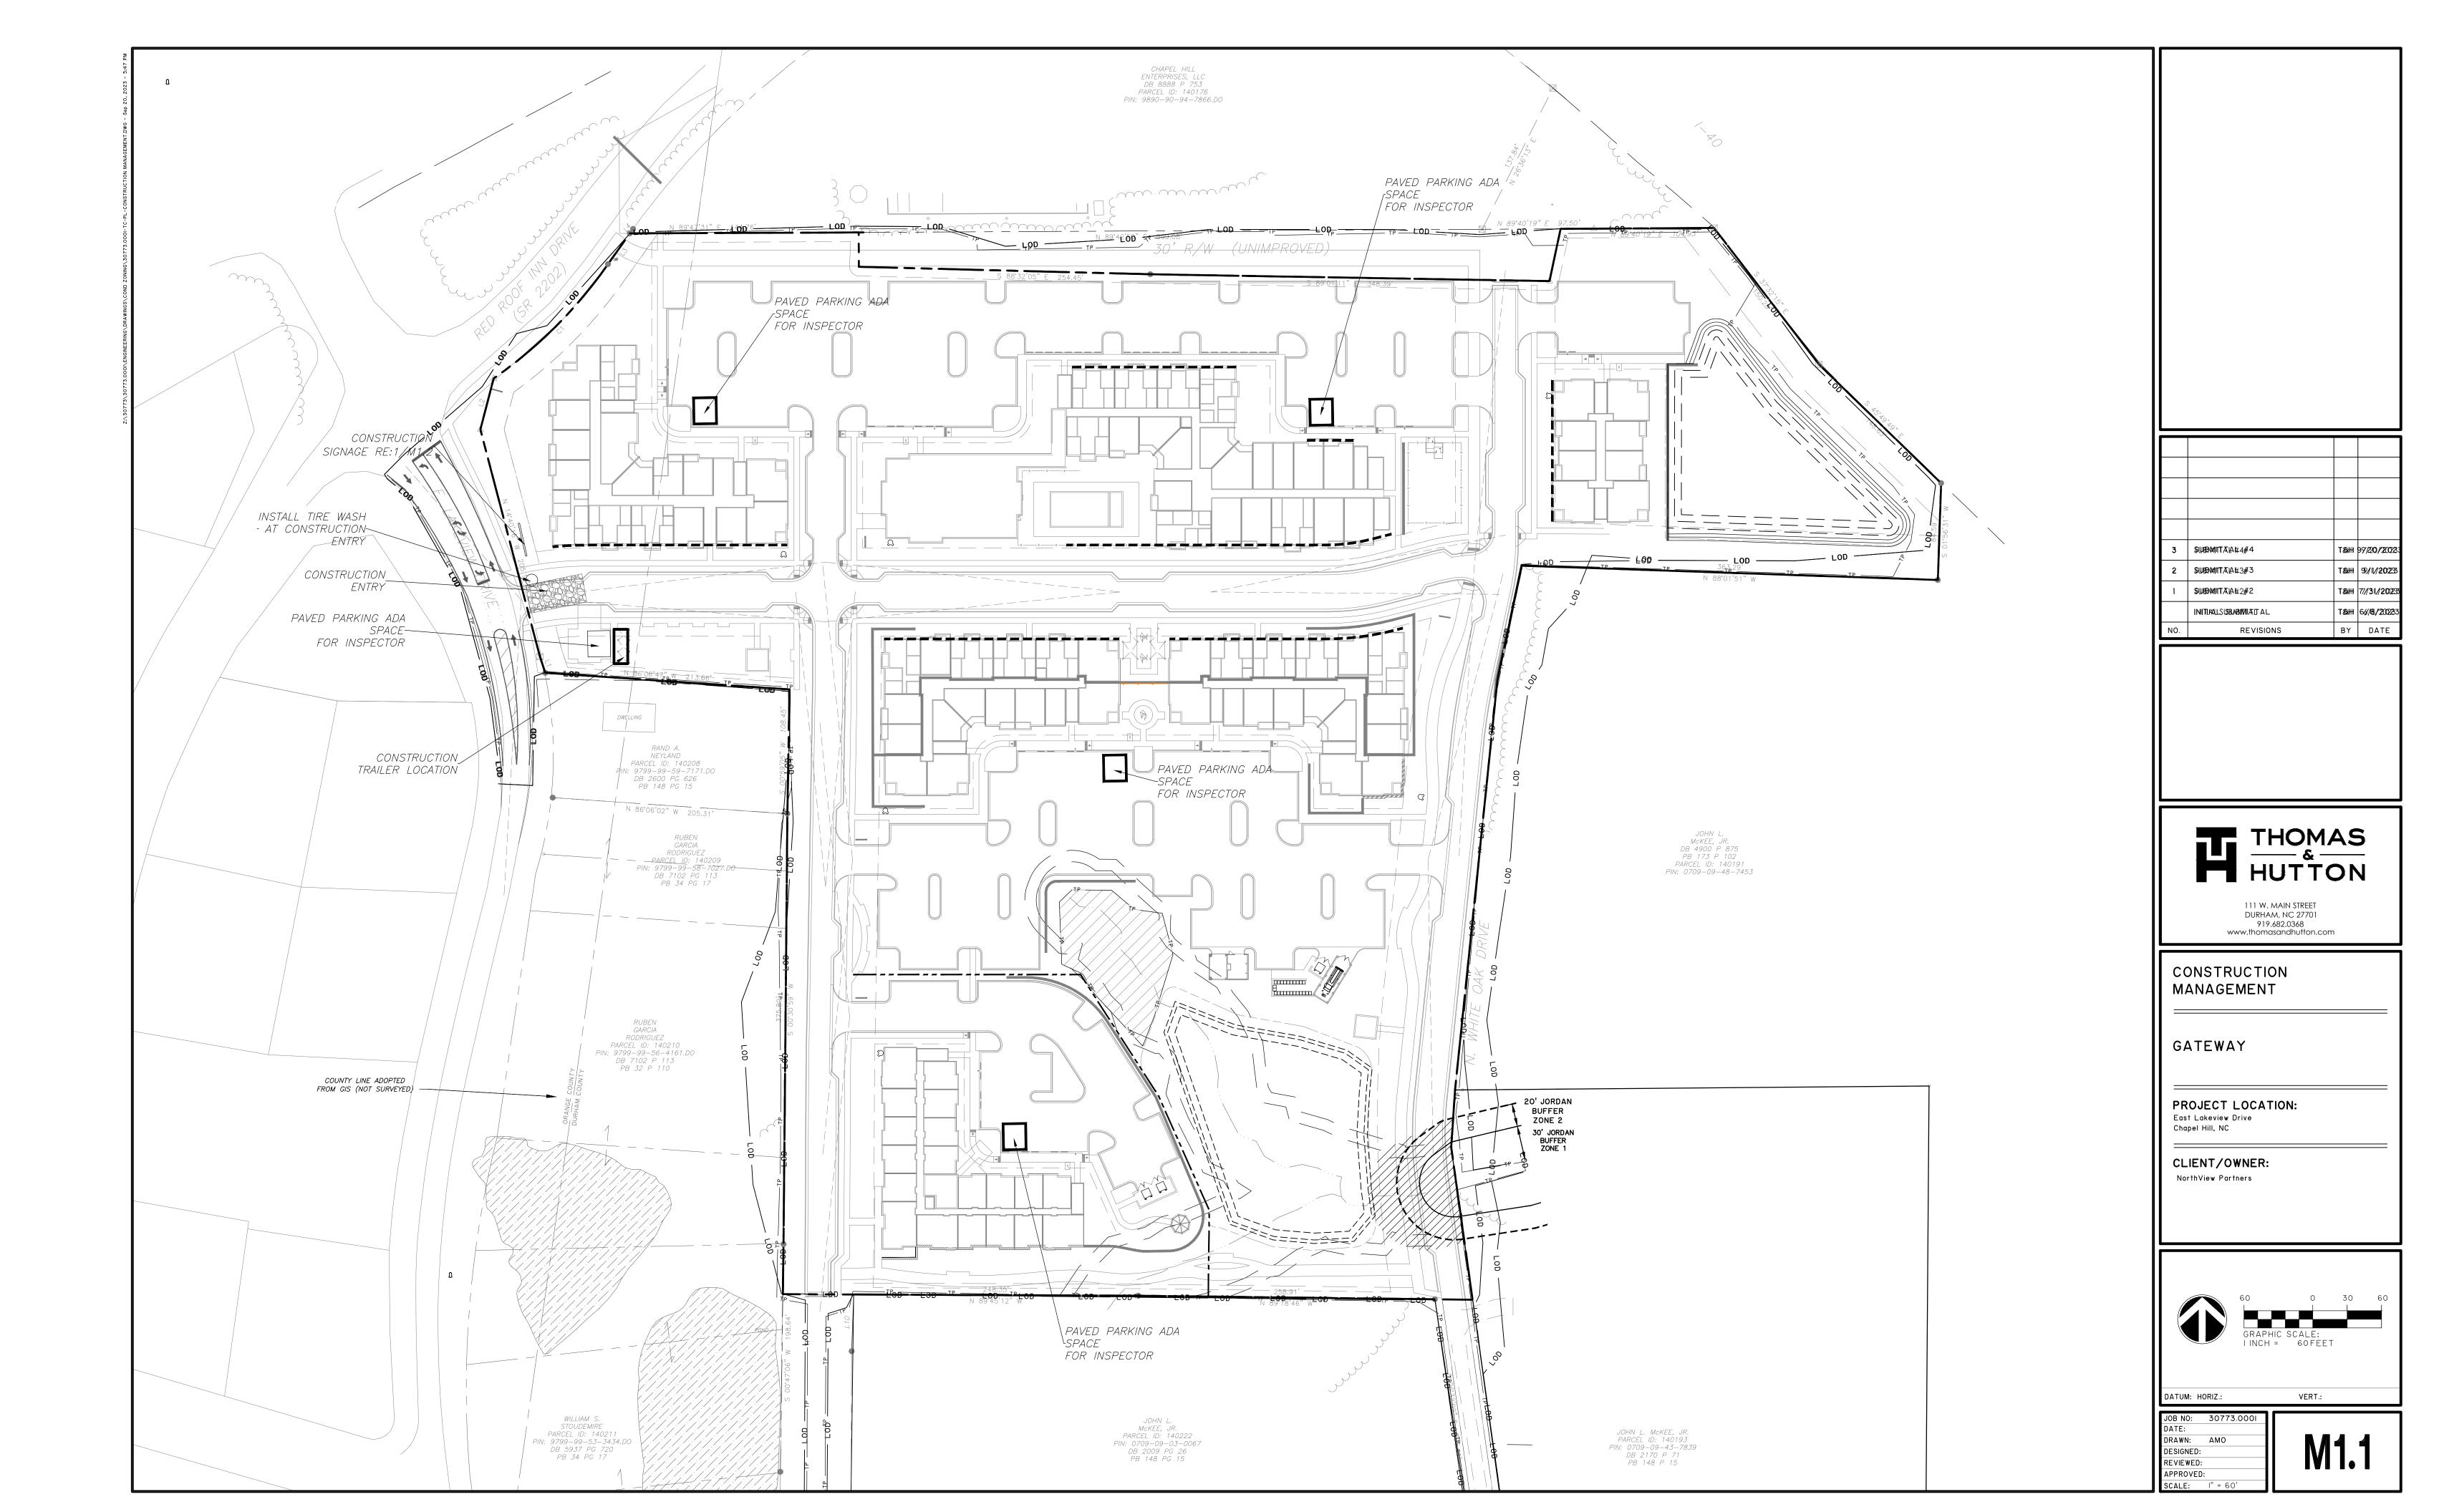
LANDSCAPE **PROTECTION** PLAN & NOTES


PROJECT #: 443-023 DRAWN BY: CHECKED BY:

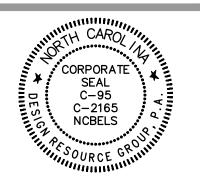JUNE 8, 2023

SCALE: 1" = 60'


**REVISIONS:** 



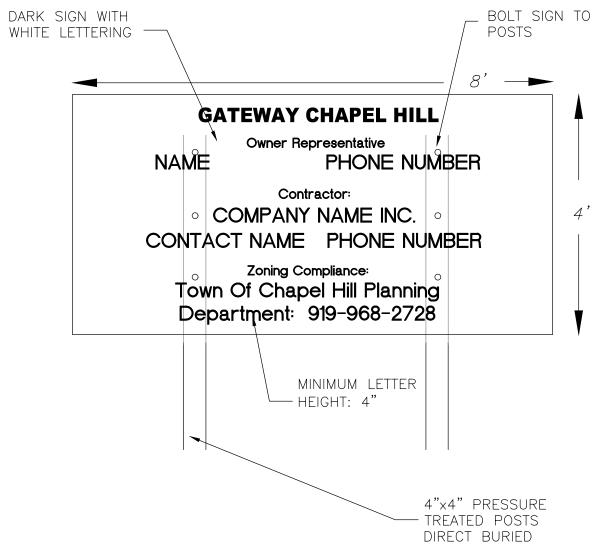

1. AT A MINIMUM, THE SIGN IS TO INCLUDE THE FOLLOWING INFORMATION: PROJECT NAME, OWNER CONTACT, CONTRACTOR CONTACT, ZONING COMPLIANCE CONTACT. SIGN IS TO BE A MAXIMUM OF 4' X 8' SIGN IS TO BE REMOVED AT PROJECT

- COMPLETION 4. THE SIGN WILL NEED A SEPARATE PERMIT THROUGH TOWN OF CHAPEL HILL PLANNING DEPARTMENT
- 1. ALL CONSTRUCTION TRAFFIC AND PARKING IS CONFINED TO THE
- 2. <u>NO CONSTRUCTION PARKING WILL BE ALLOWED ON ADJACENT</u> RESIDENTIAL STREETS.
- 3. HOURS OF CONSTRUCTION ARE MONDAY TO FRIDAY 7 AM TO 6 PM, AND SATURDAY AS NEEDED BETWEEN 8 AM AND 6 PM. THERE WILL BE NO CONSTRUCTION ON SUNDAYS. THE TOWN OF CHAPEL HILL NOISE ORDINANCE MUST BE COMPLIED WITH. THE TOWN ORDINANCE SPECIFIES CONSTRUCTION OPERATIONS ARE LIMITED TO 7 AM TO 9 PM WEEKDAYS, AND 8 AM TO 9 PM ANY ROCK REMOVAL WORK NEEDS TO BE COORDINATED WITH TOWN ADMINISTRATION, AND NEIGHBORS NOTIFIED IN ADVANCE.
- 4. PROVIDE PAVED ON-SITE PARKING FOR INSPECTORS AT EACH UNDER-CONSTRUCTION BUILDING FOR THE DURATION OF THE CONSTRUCTION PROJECT.
- 5. ALL MATERIAL STORAGE AND CONSTRUCTION PARKING IS TO OCCUR IN THE FOOTPRINTS OF PROPOSED PARKING AND BUILDING AREAS AND IS NOT TO EXTEND BEYOND SHOWN AND APPROVED LIMITS OF DISTURBANCE OR INTO ANY RIGHT OF WAY.

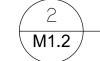

**CONSTRUCTION STAGING NOTES** 



**CONSTRUCTION SIGNAGE DETAIL** 

- 1. CONTRACTOR SHALL MAINTAIN A FIRE WATCH DURING THE CONSTRUCTION OR DEMOLITION OF "HOT WORK" THAT MAY SUBJECT MATERIALS TO SPONTANEOUS COMBUSTION. THE FIRE WATCH SHALL CONSIST OF AT LEAST ONE PERSON WITH A MEANS OF COMMUNICATING AN ALARM TO 911, SHALL HAVE A WRITTEN ADDRESS POSTED IN A CONSPICUOUS LOCATION, AND SHALL MAINTAIN CONSTANT PATROLS.
- 2. ALL CONSTRUCTION AND DEMOLITION SHALL COMPLY WITH THE CURRENT EDITION OF CHAPTER 14 OF THE NC FPC (FIRE CODE).
- 3. ANY TEMPORARY FENCING OF CONSTRUCTION AREAS MUST INCLUDE GATES SIZED FOR FIRE / EMERGENCY ACCESS. ANY PERMANENT OR TEMPORARY GATES ACROSS FIRE ACCESS DRIVES SHALL BE A MINIMUM WIDTH OF 20', EITHER SWINGING OR SLIDING TYPE, HAVE AN EMERGENCY MEANS OF OPERATION, AND SHALL BE OPERABLE BY EITHER FORCIBLE ENTRY OR KEYED, CAPABLE OF BEING OPERATED BY ONE PERSON, AND SHALL BE INSTALLED AND MAINTAINED ACCORDING TO UL 325 AND ASTM F 2200 NC FPC 2012.
- 1. SIGNS SHOWN ON THIS PLAN ARE REQUIRED DURING THE CONSTRUCTION OF THIS PROJECT.
- 2. CONSTRUCTION REQUIRING TEMPORARY LANE CLOSURES ON PUBLIC STREETS NEEDS TOWN APPROVAL. TEMPORARY LANE CLOSURES ARE ONLY ALLOWED DURING DAYLIGHT HOURS.
- 3. CONTRACTOR MUST CONTACT CHAPEL HILL TRANSIT AT LEAST 5 BUSINESS DAYS PRIOR TO ANY CONSTRUCTION REQUIRING ANY LANE CLOSURES WHICH MIGHT AFFECT BUS ROUTES.
- 4. ALL WORK ZONE SIGNAGE SHALL COMPLY WITH APPLICABLE M.U.T.C.D. STANDARDS AND DETAILS.
- 5. PRIOR TO ANY TRAFFIC LANE CLOSURES, IT WILL BE NECESSARY TO CONTACT TOWN OF CHAPEL HILL ENGINEERING DIVISION AT 919-968-2833, AT LEAST 5 WORKING DAYS BEFORE THE PROPOSED WORK TO APPLY FOR A LANE CLOSURE PERMIT.
- 6. SIGNS AND TEMPORARY BARRICADES AS NEEDED WILL BE PLACED TO DIRECT PEDESTRIANS WHEN SIDEWALKS ARE IN THE CONSTRUCTION AREAS.



FIRE PROTECTION NOTES



TRAFFIC / PEDESTRIAN CONTROL NOTES

SUBMITALA#3#3 T&H 99/1/2023 SUBMITALA#2#2 |T&HH|77//31//2002233 INITI AALS USBABINTATU AL T&HH 66/88/200223 REVISIONS BY DATE



111 W. MAIN STREET DURHAM, NC 27701 919.682.0368 www.thomasandhutton.com

CONSTRUCTION **MANAGEMENT** 

GATEWAY

PROJECT LOCATION: East Lakeview Drive Chapel Hill, NC

CLIENT/OWNER: NorthView Partners




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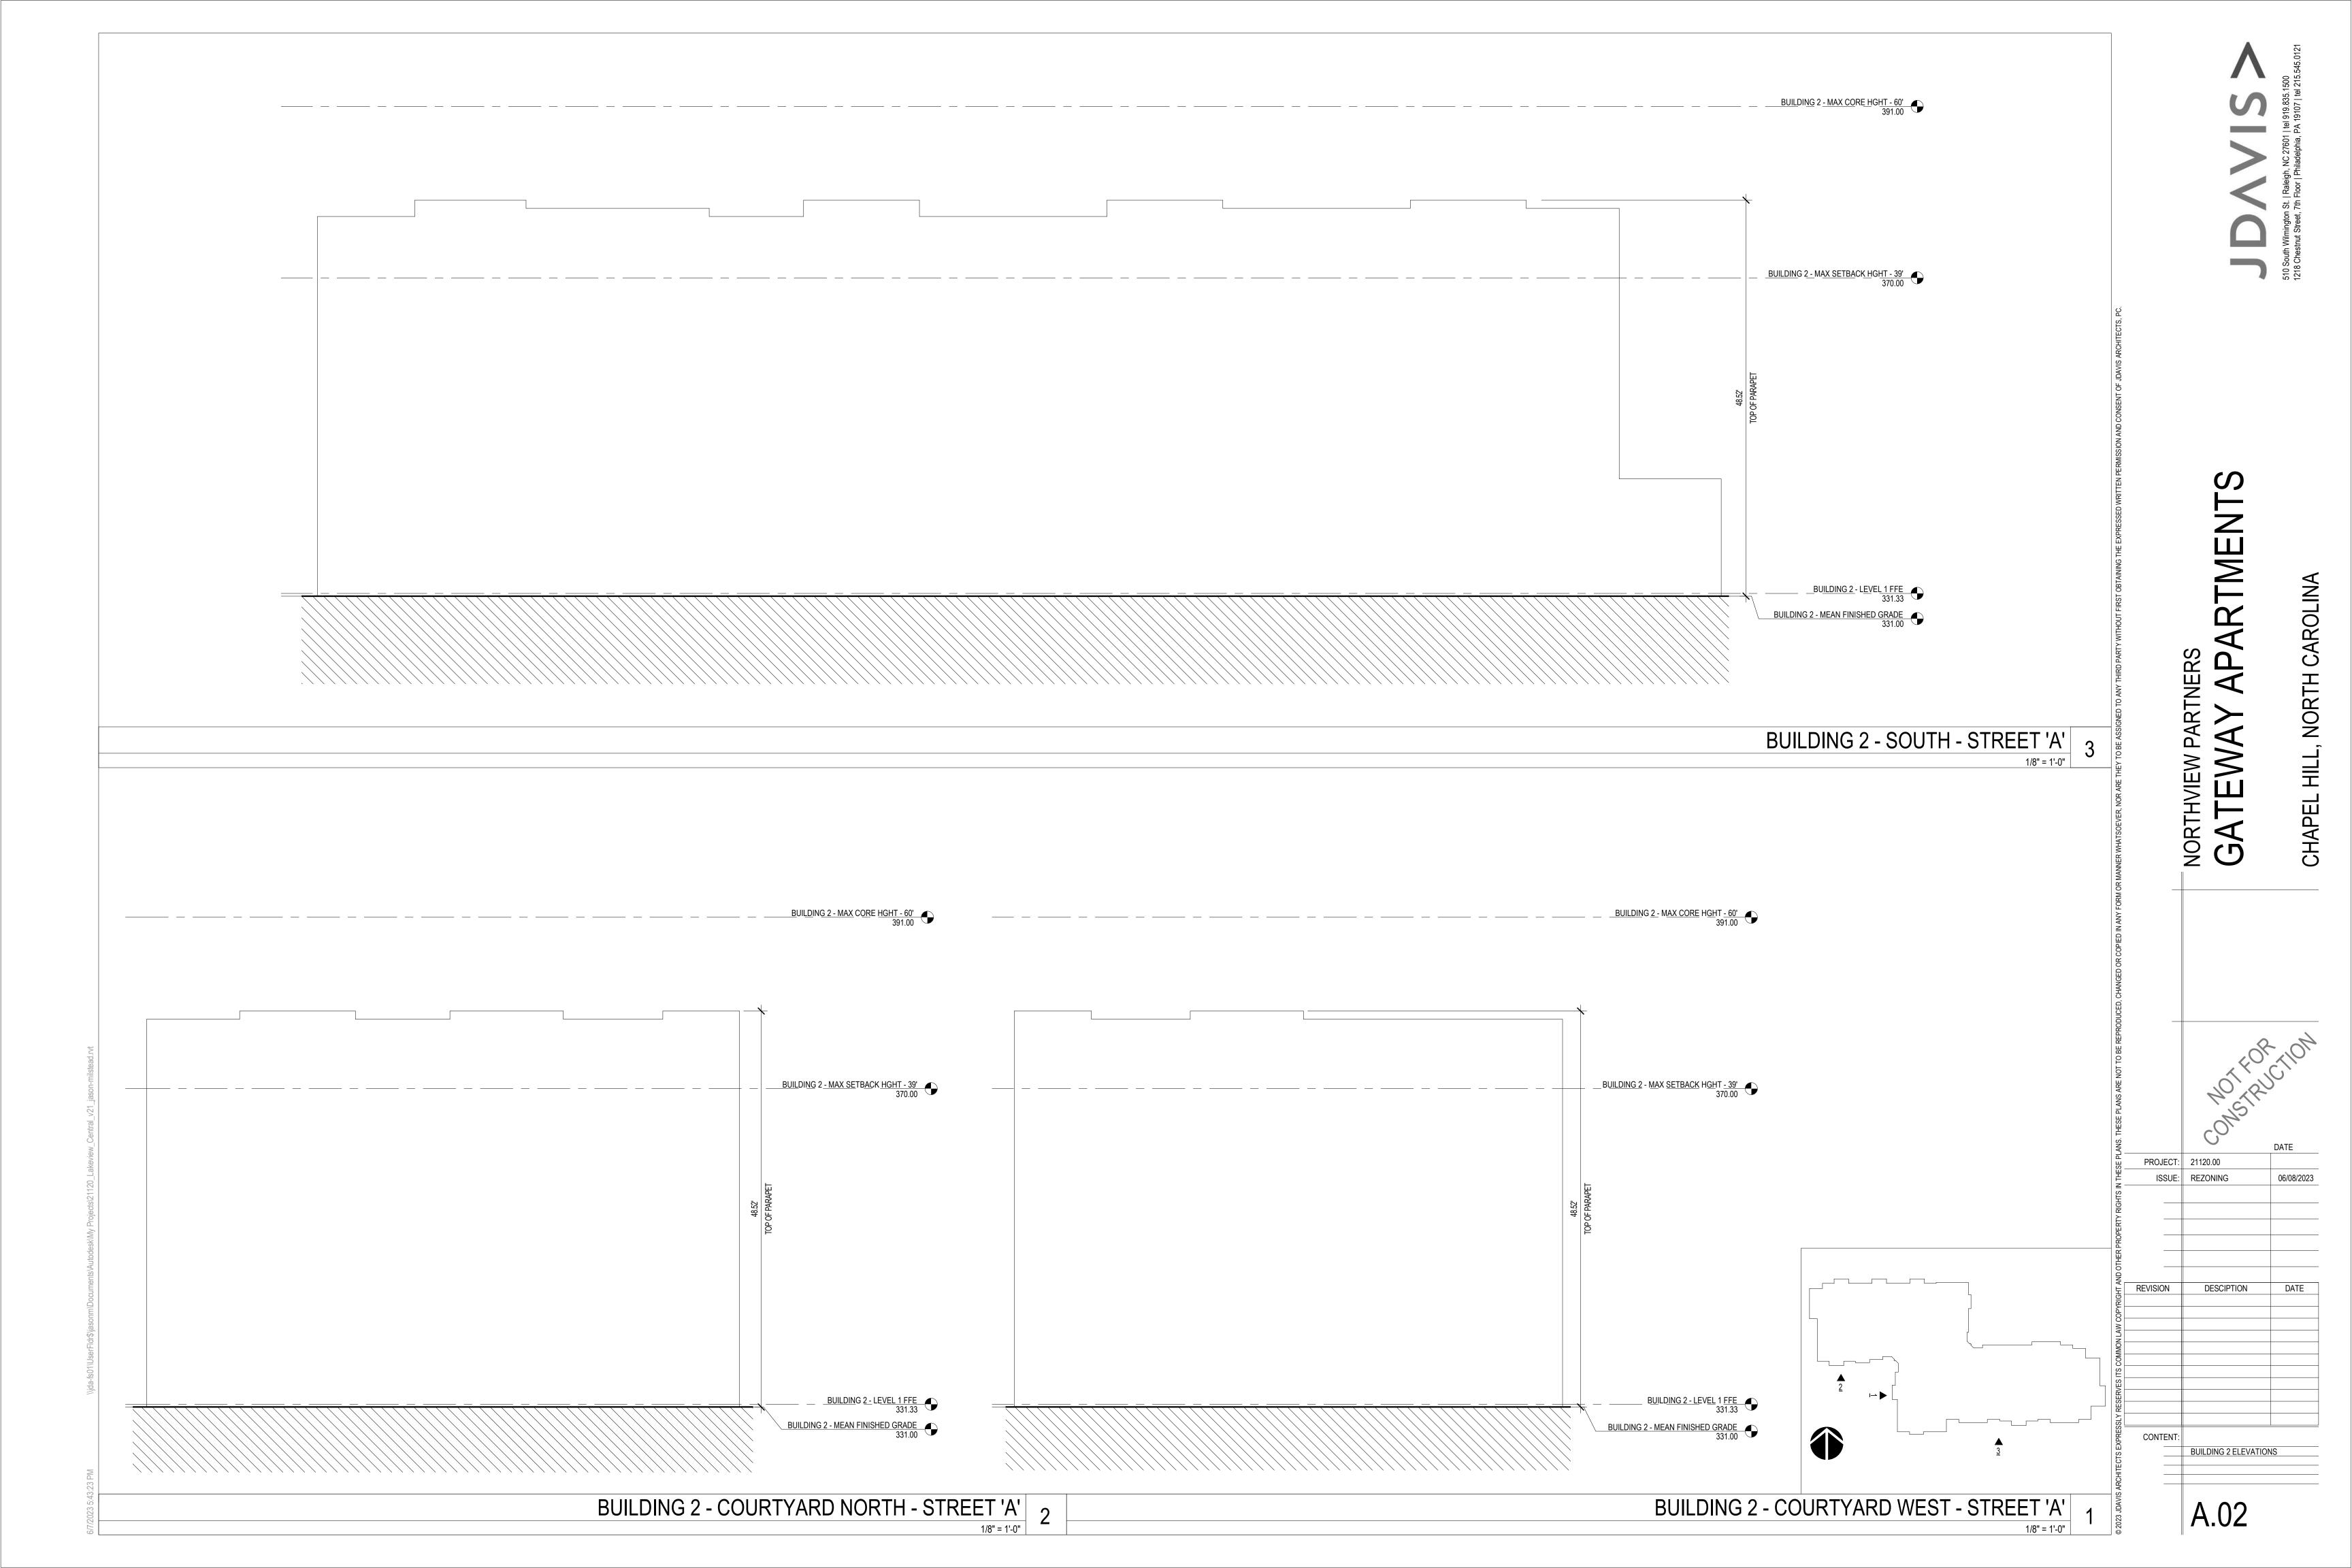
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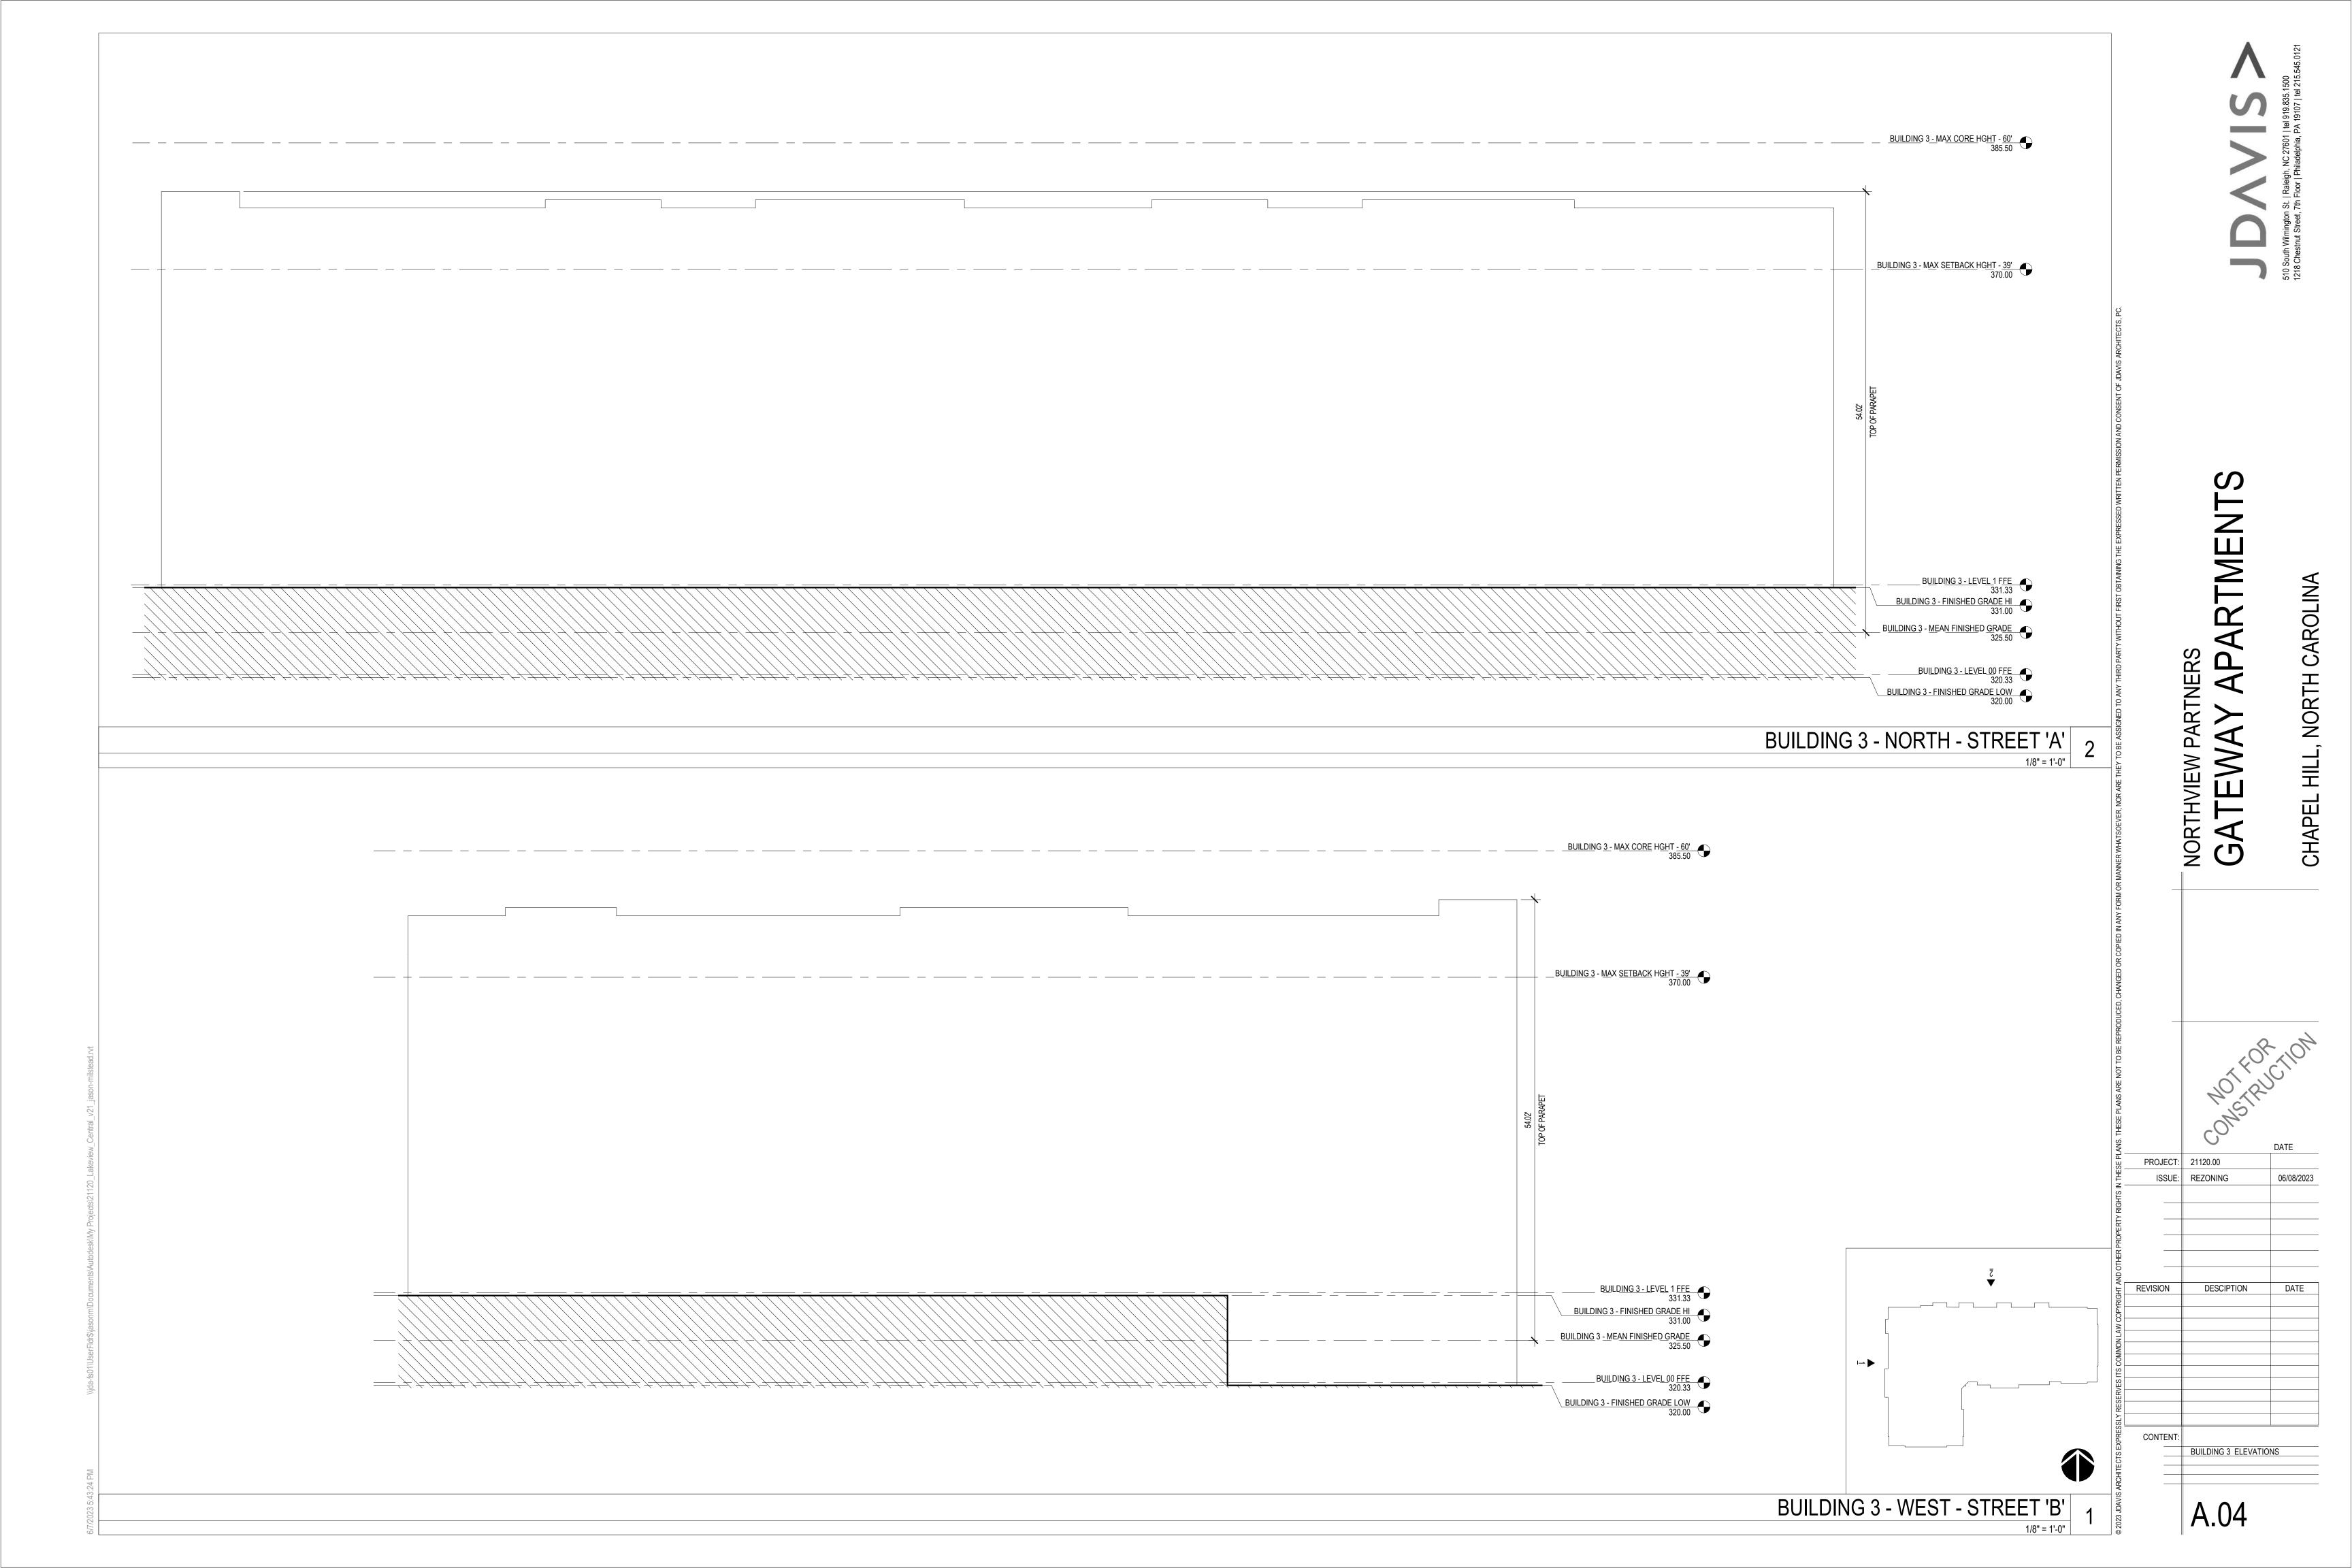
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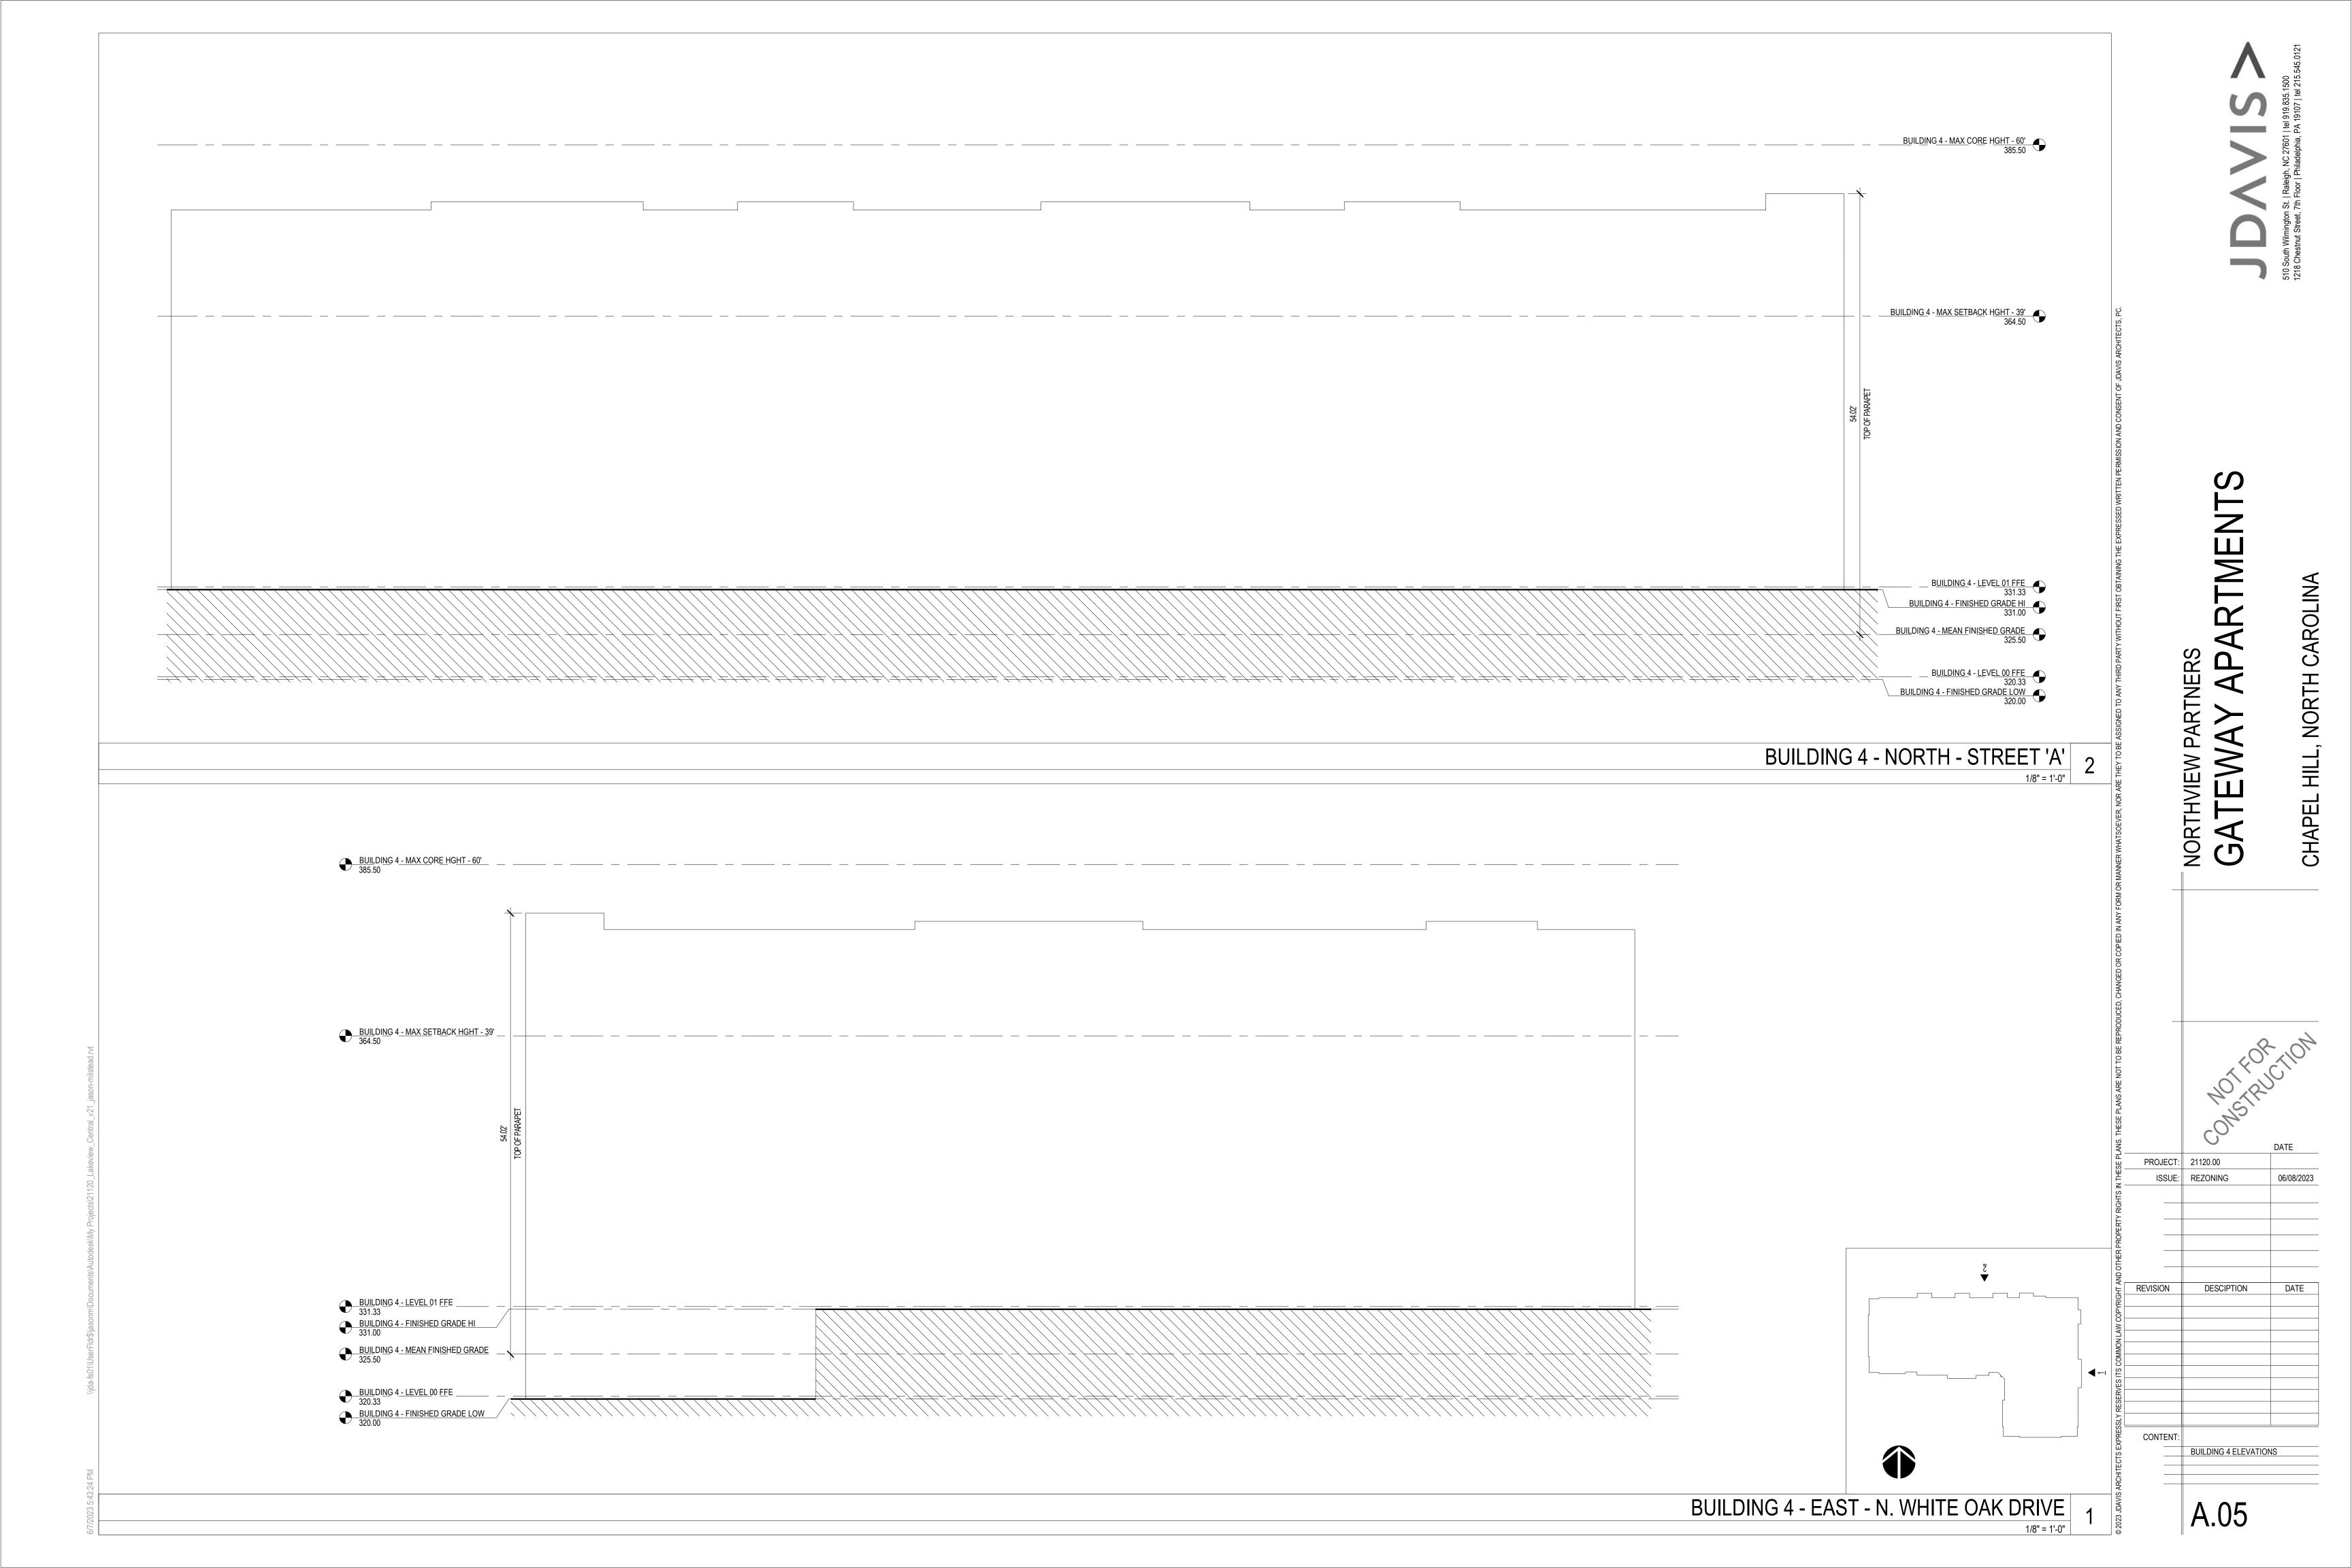
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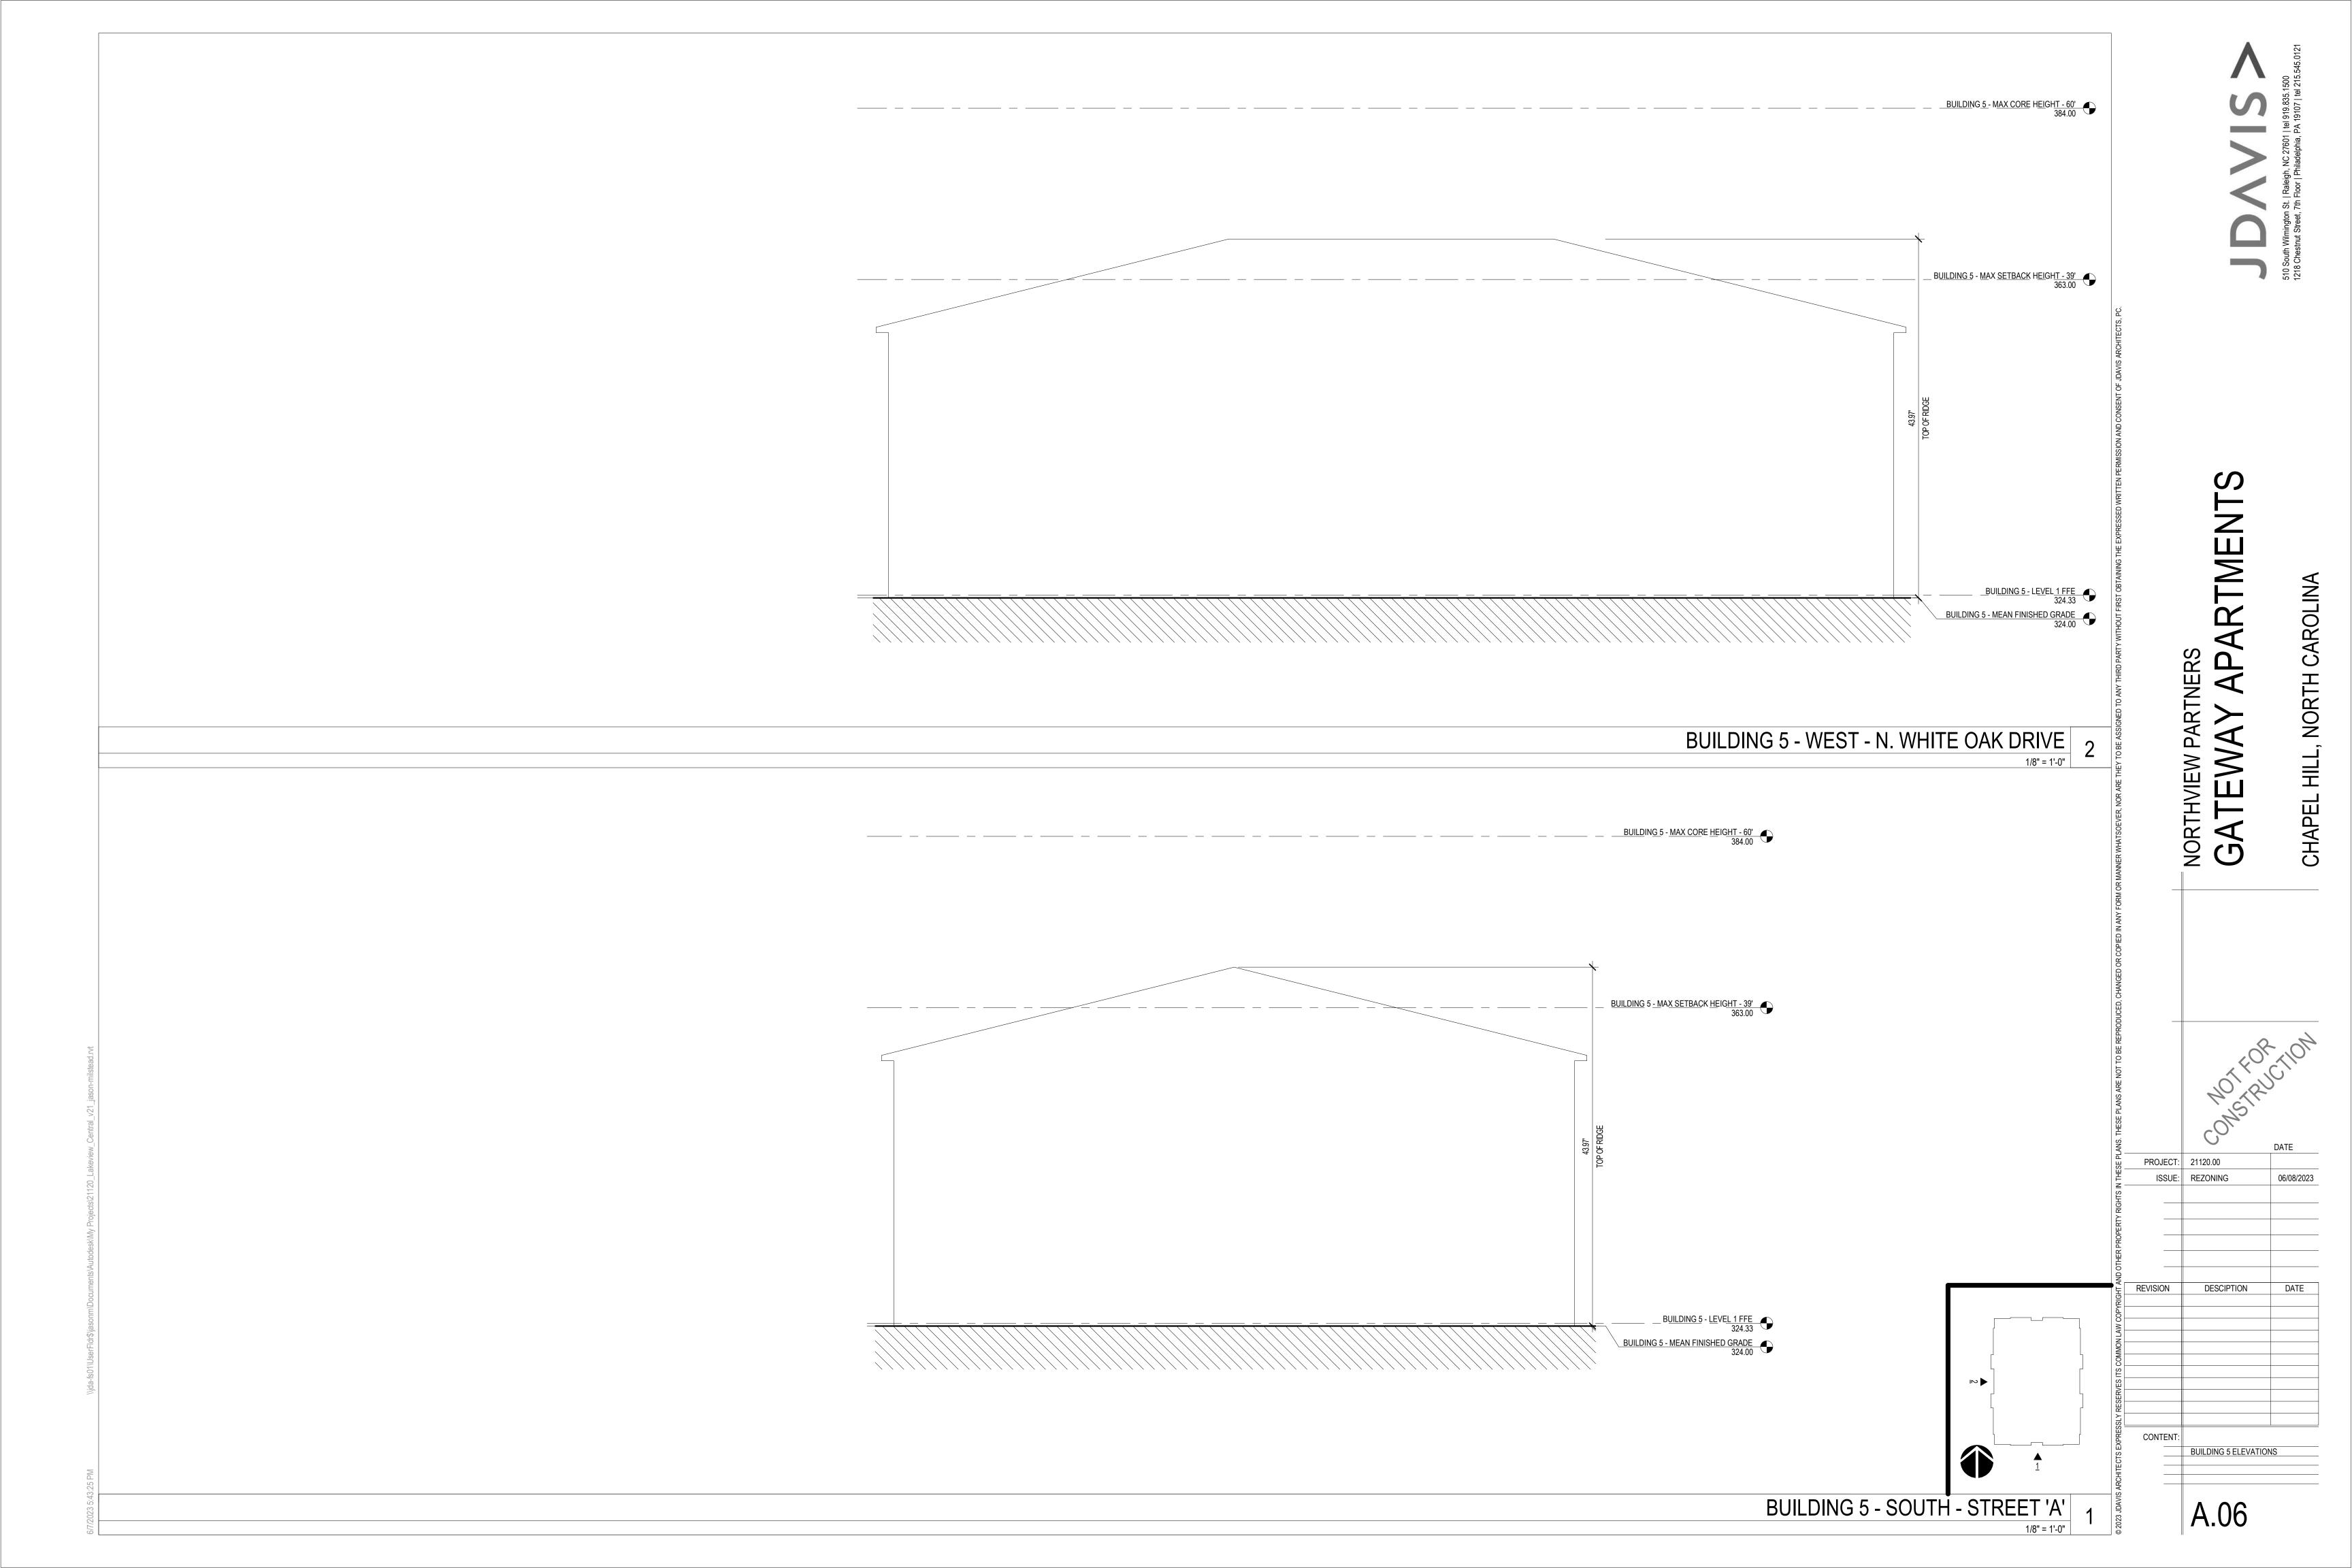










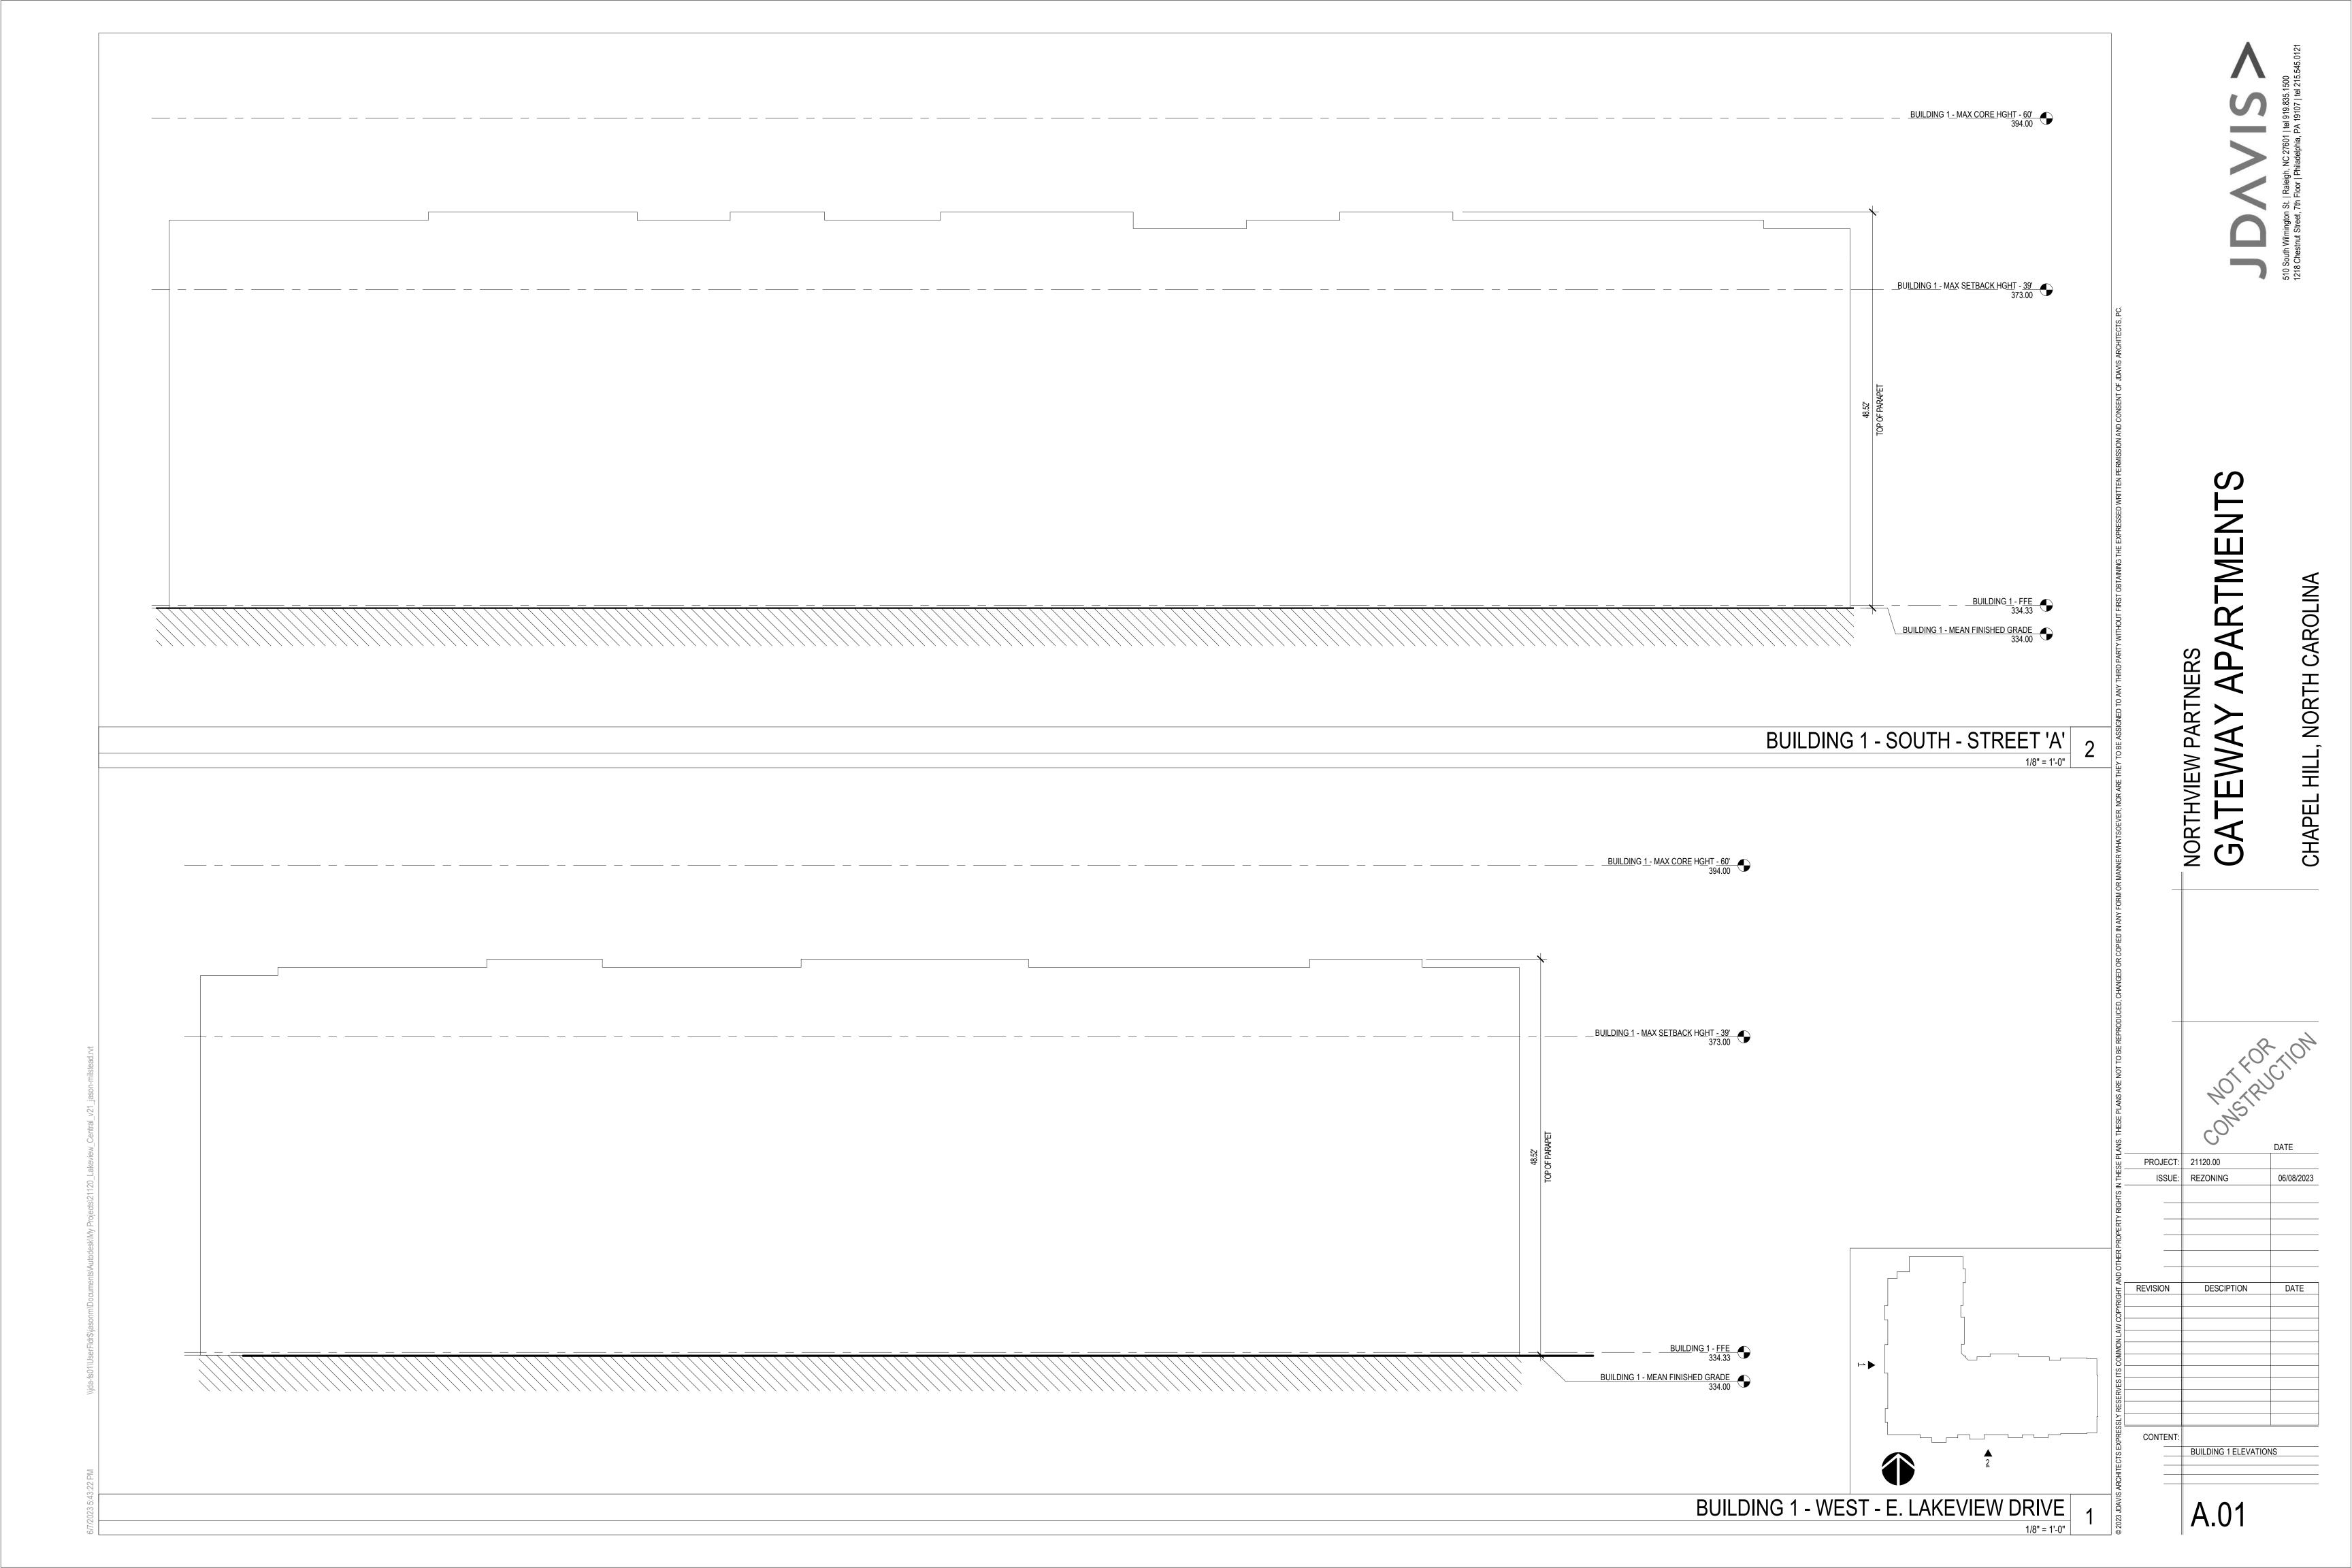

NORTHVIEW PARTNERS

GATEWAY APARTMENTS

CHAPEL HILL, NORTH CAROLINA

PROJECT: 21120.00
ISSUE: REZONING 06/08/2023

REVISION DESCIPTION DATE

A.C

SENIOR LIVING ELEVATIONS