# CONDITIONAL ZONING APPLICATION



# TOWN OF CHAPEL HILL Planning Department

405 Martin Luther King Jr. Blvd. (919) 968-2728 fax (919) 969-2014 www.townofchapelhill.org

12 Nov 2021 Parcel Identifier Number (PIN): 9788379851, 9788472803 Date: Section A: Project Information 150 E Rosemary Street Lab & Office Building Project Name: Property Address: 150 E Rosemary St Zip Code: 27514 Use Groups (A, B, and/or C): **Existing Zoning District:** TC-2 Demolition of existing Wallace Parking Deck and construction of a 7-story lab and office building Project Description: Section B: Applicant, Owner, and/or Contract Purchaser Information **Applicant Information** (to whom correspondence will be mailed): Ballentine Associates, attn: George Retschle Name: Address: 221 Providence Road City: Chapel Hill State: NC Zip Code: 27514 Phone: (919) 929-0481 Email: georger@bapa.eng.pro The undersigned applicant hereby certifies that, to the best of their knowledge and belief, all information supplied with this application and accurate. Signature: Date: 12 Nov 2021 **Owner/Contract Purchaser Information: Owner Contract Purchaser** Franklin Office Chapel Hill, LLC Name: 117 Edinburgh South Drive Suite 110 Address: State: NC Zip Code: 27511 City: Cary Phone: (919) 388-5774 Email: JDye@grubbproperties.com The undersigned applicant hereby certifies that, to the best of their knowledge and belief, all information supplied with this application and accurate. 12 Nov 2021 Signature: Date: Click here for application submittal instructions.

# CONDITIONAL ZONING APPLICATION



# TOWN OF CHAPEL HILL Planning Department

405 Martin Luther King Jr. Blvd. (919) 968-2728 fax (919) 969-2014 www.townofchapelhill.org

Parcel Ider	ntifier Number (PIN	): _97883798	51, 97884728	303			Date:	12 Nov 2021
Section A	: Project Inform	ation				and the		
Project Na	me:	150 E Rosema	ry Street Lab	& Office	Building			
Property A	ddress:	150 E Rosema	ary St			Zip Code:	27	514
Use Group	s (A, B, and/or C):	С				Existing Zoning District	: TC	-2
Project De	scription:	Demolition of	existing Wal	lace Park	ing Deck ar	d construction of a 7-st	ory lab	and office building
110,000.00	Son paroni							
Section B:	Applicant, Ow	ner, and/or (	Contract Pu	ırchase	r Informa	tion		
	cant Information							
Name:	Ballentine Associ			ic will be	maneay.			
Address:	221 Providence R	load						
City:	Chapel Hill			State:	NC	Zip C	ode:	27514
Phone:	(919) 929-0481			Email:	georger@	bapa.eng.pro	•	
						1 1 1 1 1 1	c	
	ndersigned applic ied with this appl			to the b	est of thei	r knowledge and belie	et, all II	nformation
Signature:	ADA	)	our a cor			Date: 12	2 Nov 2	2021
	1911					12		
Owne	er/Contract Purch	aser Informa	tion:					
⊠o	wner			☐ Con	tract Purc	haser		
					tract rare			
Name:	Town of Chapel F	fill						
Address:	405 Martin Luther	King Jr Blvd						
City:	Chapel Hill			State:	NC	Zip C	ode:	27514
Phone:	(919) 968-2743			Email:	manager@	townofchapelhill.org		
The	ndersigned applic	ant hereby co	rtifies that	to the h	est of their	r knowledge and belie	of all in	nformation
	ied with this appli			to the b	est of thei	r knowledge and belle	:i, aii i	mormation
Signature:		Laurens	Constal			Date:	11 -	-12-21
			7					
		Cli	ck here for a	pplicatio	n submittal	instructions.		

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06.08.2020

# **CONDITIONAL ZONING**



TOWN OF CHAPEL HILL Planning Department

Conditional Rezoning applications are reviewed by staff, Planning Commission, and Town Council. The application is part of an open public process that enables Town Council to discuss and decide on the key issues of a rezoning proposal. If a rezoning is approved, the applicant may then submit a detailed final plan application to staff for compliance review with the technical development standards and with the Council rezoning approval.

The establishment of a Conditional Zoning District shall be consistent with the Land Use Plan in the Comprehensive Plan. A proposed Conditional Zoning District is deemed consistent if the proposed District will be located in conformance with an adopted small area plan and/or in one of the following Land Use Categories:

- Medium Residential
- High Residential
- Commercial
- Mixed Use, Office/Commercial Emphasis
- Mixed Use, Office Emphasis
- Town/Village Center
- Institutional
- Office
- University
- Development Opportunity Area
- Light Industrial Opportunity Area

If the proposed conditional zoning districts is located in a Low Residential or a Rural Residential Land Use Category, the Town Council must approve a Land Use Plan amendment prior to proceeding.

SIGNED CONDITIONS: All conditions shall be in writing, prepared by the owner of the property or an attorney and must be signed by all property owners and contract purchasers, if applicable. The Town Attorney may require additional signatures if necessary and will determine whether or not the conditions statement is legally sufficient. Within thirty (30) days after receipt of the conditions the Planning Division Manager will notify the applicant of any deficiencies in the conditions statement or if any additional information is needed. The applicant may make changes to the written conditions statement provided it is submitted at least thirty (30) prior to Planning Commission meeting or thirty (30) days prior to Town Council public hearing.

RECORDATION OF CONDITIONS: After a rezoning has been approved by the Town Council, the conditions statement shall be recorded with the Register of Deeds Office. After a rezoning has been approved by Town Council and recorded by the Register of Deeds Office, the conditions may not be amended except through a new rezoning application.



# PROJECT FACT SHEET TOWN OF CHAPEL HILL

**Planning Department** 

Section A: Project Information						
Use Type: (check/list all that apply)						
☐ Residential ☐ Residential	Mixed-Use	☑ Other:				
Overlay District: (check all that apply)						
☐ Neighborhoo	od Conservation Distric	ct Airport Hazaı	rd Zone			
Section B: Land Area						
Net Land Area (NLA): Area within zoning lot boo	undaries			NLA=	64,690	sq. ft.
Choose one, or both, of the following (a or b), not	Area (total adjacent fr	rontage) x ½ width of p	ublic right-	CSA=	6,469	sq. ft.
to exceed 10% of NLA  b) Credited Perma dedicated open sp		al adjacent frontage) x	½ public or	COS=		sq. ft.
TOTAL: NLA + CSA and/or COS = Gross Land Are	a (not to exceed NLA	+ 10%)		GLA=	71,159	sq. ft.
Special Protection Areas, Lan  Special Protection Areas: (check all those to Bource Consertion)  Jordan Buffer Resource Consertion	hat apply)	100 Year Floodplain	☐ Water	shed Pro	tection Dist	rict
Land Disturbance					Total (sq. ft.)	
Area of Land Disturbance (Includes: Footprint of proposed activity plus work all grading, including off-site clearing)	area envelope, staging a	rea for materials, access/	equipment pat	ths, and	75,000	
Area of Land Disturbance within RCD						
Area of Land Disturbance within Jordan Buffer					0	
Impervious Areas Existing (sq. ft.) Demolition (sq. ft.) Proposed (sq. ft.)					Total (s	q. ft.)
Impervious Surface Area (ISA) 58,014 58,014 59,14			59,145		59,145	
Impervious Surface Ratio: Percent Impervious Surface Area of Gross Land Area (ISA/GLA)%  81.527  83.117				83.117		
If located in Watershed Protection District, % of impervious surface on 7/1/1993						



# PROJECT FACT SHEET TOWN OF CHAPEL HILL

**Planning Department** 

# **Section D: Dimensions**

Dimensional Unit (sq. ft.)	Existing (sq. ft.)	Demolition (sq. ft.)	Proposed (sq. ft.)	Total (sq. ft.)
Number of Buildings	1 +/- 1,500 enclosed	all	237,000	237,000
Number of Floors	3	3	7	7
Recreational Space				

Residential Space						
Dimensional Unit (sq. ft.)	Existing (sq. ft.)	Demolition (sq. ft.)	Proposed (sq. ft.)	Total (sq. ft.)		
Floor Area (all floors – heated and unheated)						
Total Square Footage of All Units						
Total Square Footage of Affordable Units						
Total Residential Density						
Number of Dwelling Units						
Number of Affordable Dwelling Units						
Number of Single Bedroom Units						
Number of Two Bedroom Units						
Number of Three Bedroom Units						

Non-Residential Space (Gross Floor Area in Square Feet)						
Use Type	Existing	Proposed	Uses	Existing	Proposed	
Commercial	750	3,000				
Restaurant			# of Seats			
Government						
Institutional						
Medical						
Office	1,500	234,000				
Hotel			# of Rooms			
Industrial						
Place of Worship			# of Seats			
Other						

Dimensional Requirements		Required by Ordinance	Existing	Proposed
Catharala	Street	0	10	12
Setbacks (minimum)	Interior (neighboring property lines)			
(minimum)	Solar (northern property line)	0	10	12
Height	Primary	44	34	50
(maximum)	Secondary	120	40	132
Stuasts	Frontages	12	45	361
Streets	Widths	15	45	361



# PROJECT FACT SHEET TOWN OF CHAPEL HILL Planning Department

# **Section F: Adjoining or Connecting Streets and Sidewalks**

Note: For approval of proposed street names, contact the Engineering Department.

Street Name	Right-of-Way Width	Pavement Width	Number of Lanes	Existing Sidewalk*	Existing Curb/Gutter
E Rosemary St	45	39	3		⊠ Yes
Henderson St	40	30	2		

List Proposed	Points of	Access (Fx:	Number	Street	Name)	١.
LIST LIOPOSER	FUILLS OF	MCCESS (LA.	muniber,	Jucei	ivaiiic <i>i</i>	1.

\*If existing sidewalks do not exist and the applicant is adding sidewalks, please provide the following information:

Sidewalk Information							
Street Names	Dimensions	Surface	Handicapped Ramps				
			Yes No N/A				
			Yes No N/A				

# **Section G: Parking Information**

Parking Spaces	Minimum	Maximum	Proposed
Regular Spaces	n/a	608	152
Handicap Spaces	6	n/a	6
Total Spaces	n/a	608	158
Loading Spaces	1	n/a	1
Bicycle Spaces	168	n/a	181
Surface Type	concrete parking podium		

# **Section H: Landscape Buffers**

Location (North, South, Street, Etc.)	Minimum Width	Proposed Width	Alternate Buffer	Modify Buffer
buffers n/a	n/a		Yes	☐ Yes
			Yes	☐ Yes
			Yes	☐ Yes
			Yes	Yes

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# PROJECT FACT SHEET TOWN OF CHAPEL HILL Planning Department

Section 1: Land Use int	lensity		

Existing Zoning District: Proposed Zoning Change (if any):

Zoning – Area – Ratio			Imperv	ious Surface Thre	Minimum and Maximum Limitations		
Zoning District(s)	Space Ra		Low Density Residential (0.24)	High Density Residential (0.50)	Non- Residential (0.70)	Maximum Floor Area (MFA) = FAR x GLA	Minimum Recreation Space (MSR) = RSR x GLA
TC-3-CZC	4	n/a			n/a	284,636	
TOTAL							
RCD Streamside		0.01					
RCD Managed		0.019					
RCD Upland							

# **Section J: Utility Service**

Спеск ан that apply:				
Water		☐ Individual Well	Community Well	Other
Sewer		☐ Individual Septic Tank	Community Package Plant	Other
Electrical	□ Underground	Above Ground		
Telephone	□ Underground	Above Ground		
Solid Waste	Town	☐ Private		

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TOWN OF CHAPEL HILL Planning Department

The following must accompany your application. Failure to do so will result in your application being considered incomplete. For assistance with this application, please contact the Chapel Hill Planning Department (Planning) at (919) 968-2728 or at <a href="mailto:planning@townofchapelhill.org">planning@townofchapelhill.org</a>.

х	Application fee (including Engineering Review fee) (refer to fee schedule)  Amount Paid \$ paid
х	Pre-application meeting –with appropriate staff
х	Digital Files – provide digital files of all plans and documents
х	Recorded Plat or Deed of Property
х	Project Fact Sheet
х	Traffic Impact Statement – completed by Town's consultant (or exemption)
n/a	Description of Public Art Proposal, if applicable
Х	Statement of Justification
Х	Response to Community Design Commission and Town Council Concept Plan comments, if applicable
n/a	Affordable Housing Proposal, if applicable
Х	Statement of Consistency with Comprehensive Plan or request to amend Comprehensive Plan
Х	Mailing list of owners of property within 1,000 feet perimeter of subject property (see GIS notification tool)
х	Mailing fee for above mailing list (mailing fee is double due to 2 mailings)  Amount Paid \$ paid
Х	Written Narrative describing the proposal, including proposed land uses and proposed conditions
n/a	Resource Conservation District, Floodplain, & Jordan Buffers Determination – necessary for all submittals
n/a	Jurisdictional Wetland Determination – if applicable
n/a	Resource Conservation District Encroachment Exemption or Variance (determined by Planning)
n/a	Jordan Buffer Authorization Certificate or Mitigation Plan Approval (determined by Planning)
Χ	Reduced Site Plan Set (reduced to 8.5" x 11")

# **Stormwater Impact Statement** (1 copy to be submitted)

- a) Written narrative describing existing & proposed conditions, anticipated stormwater impacts and management structures and strategies to mitigate impacts
- b) Description of land uses and area (in square footage)
- c) Existing and proposed impervious surface area in square feet for all subareas and project area
- d) Ground cover and uses information
- e) Soil information (classification, infiltration rates, depth to groundwater and bedrock)
- f) Time of concentration calculations and assumptions
- g) Topography (2-foot contours)
- h) Pertinent on-site and off-site drainage conditions
- i) Upstream and/or downstream volumes
- j) Discharges and velocities
- k) Backwater elevations and effects on existing drainage conveyance facilities
- I) Location of jurisdictional wetlands and regulatory FEMA Special Flood Hazard Areas
- m) Water quality volume calculations
- n) Drainage areas and sub-areas delineated
- o) Peak discharge calculations and rates (1, 2, and 25-year storms)
- p) Hydrographs for pre- & post-development without mitigation, post-development with mitigation
- q) Volume calculations and documentation of retention for 2-year storm

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**TOWN OF CHAPEL HILL** 

**Planning and Development Services** 

- r) 85% TSS removal for post-development stormwater runoff
- s) Nutrient loading calculations
- t) BMP sizing calculations
- u) Pipe sizing calculations and schedule (include HGL & EGL calculations and profiles)

# Plan Sets (10 copies to be submitted no larger than 24" x 36")

Plans should be legible and clearly drawn. All plan set sheets should include the following:

- Project Name
- Legend
- Labels
- North Arrow (North oriented toward top of page)
- Property boundaries with bearing and distances
- Scale (Engineering), denoted graphically and numerically
- Setbacks
- Streams, RCD Boundary, Jordan Riparian Buffer Boundary, Floodplain, and Wetlands Boundary, where applicable
- Revision dates and professional seals and signatures, as applicable

#### **Cover Sheet**

a) Include Project Name, Project fact information, PIN, and Design Team

### Area Map

- a) Project name, applicant, contact information, location, PIN, & legend
- b) Dedicated open space, parks, greenways
- c) Overlay Districts, if applicable
- d) Property lines, zoning district boundaries, land uses, project names of site and surrounding properties, significant buildings, corporate limit lines
- e) Existing roads (public & private), rights-of-way, sidewalks, driveways, vehicular parking areas, bicycle parking, handicapped parking, street names
- f) 1,000' notification boundary

# **Existing Conditions Plan**

- a) Slopes, soils, environmental constraints, existing vegetation, and any existing land features
- b) Location of all existing structures and uses
- c) Existing property line and right-of-way lines
- d) Existing utilities & easements including location & sizes of water, sewer, electrical, & drainage lines
- e) Nearest fire hydrants
- f) Nearest bus shelters and transit facilities
- g) Existing topography at minimum 2-foot intervals and finished grade
- h) Natural drainage features & water bodies, floodways, floodplain, RCD, Jordan Buffers & Watershed boundaries

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**TOWN OF CHAPEL HILL** 

**Planning and Development Services** 

### **Detailed Site Plan**

- a) Existing and proposed building locations
- b) Description & analysis of adjacent land uses, roads, topography, soils, drainage patterns, environmental constraints, features, existing vegetation, vistas (on and off-site)
- c) Location, arrangement, & dimension of vehicular parking, width of aisles and bays, angle of parking, number of spaces, handicapped parking, bicycle parking. Typical pavement sections & surface type.
- d) Location of existing and proposed fire hydrants
- e) Location and dimension of all vehicle entrances, exits, and drives
- f) Dimensioned street cross-sections and rights-of-way widths
- g) Pavement and curb & gutter construction details
- h) Dimensioned sidewalk and tree lawn cross sections
- i) Proposed transit improvements including bus pull-off and/or bus shelter
- j) Required landscape buffers (or proposed alternate/modified buffers)
- k) Required recreation area/space (including written statement of recreation plans)
- I) Refuse collection facilities (existing and proposed) or shared dumpster agreement
- m) Construction parking, staging, storage area, and construction trailer location
- n) Sight distance triangles at intersections
- o) Proposed location of street lights and underground utility lines and/or conduit lines to be installed
- p) Easements
- q) Clearing and construction limits
- r) Traffic Calming Plan detailed construction designs of devices proposed & associated sign & marking plan

### **Stormwater Management Plan**

- a) Topography (2-foot contours)
- b) Existing drainage conditions
- c) RCD and Jordan Riparian Buffer delineation and boundary (perennial & intermittent streams; note ephemeral streams on site)
- d) Proposed drainage and stormwater conditions
- e) Drainage conveyance system (piping)
- f) Roof drains
- g) Easements
- h) BMP plans, dimensions, details, and cross-sections
- i) Planting and stabilization plans and specifications

# Landscape Protection Plan

- a) Rare, specimen, and significant tree survey within 50 feet of construction area
- b) Rare and specimen tree critical root zones
- c) Rare and specimen trees proposed to be removed
- d) Certified arborist tree evaluation, if applicable
- e) Significant tree stand survey
- f) Clearing limit line
- g) Proposed tree protection/silt fence location
- h) Pre-construction/demolition conference note
- i) Landscape protection supervisor note
- j) Existing and proposed tree canopy calculations, if applicable

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**TOWN OF CHAPEL HILL** 

**Planning and Development Services** 

### **Planting Plan**

- a) Dimensioned and labeled perimeter buffers
- b) Off-site buffer easement, if applicable
- c) Landscape buffer and parking lot planting plan (including planting strip between parking and building, entryway planting, and 35% shading requirement

# **Steep Slope Plan**

- a) Classify and quantify slopes 0-10%, 10-15%, 15-25%, and 25% and greater
- b) Show and quantify areas of disturbance in each slope category
- c) Provide/show specialized site design and construction techniques

# **Grading and Erosion Control Plan**

- a) Topography (2-foot contours)
- b) Limits of Disturbance
- c) Pertinent off-site drainage features
- d) Existing and proposed impervious surface tallies

# Streetscape Plan, if applicable

- a) Public right-of-way existing conditions plan
- b) Streetscape demolition plan
- c) Streetscape proposed improvement plan
- d) Streetscape proposed utility plan and details
- e) Streetscape proposed pavement/sidewalk details
- f) Streetscape proposed furnishing details
- g) Streetscape proposed lighting detail

#### **Solid Waste Plan**

- a) Preliminary Solid Waste Management Plan
- b) Existing and proposed dumpster pads
- c) Proposed dumpster pad layout design
- d) Proposed heavy duty pavement locations and pavement construction detail
- e) Preliminary shared dumpster agreement, if applicable



**TOWN OF CHAPEL HILL** 

**Planning and Development Services** 

### **Construction Management Plan**

- a) Construction trailer location
- b) Location of construction personnel parking and construction equipment parking
- c) Location and size of staging and materials storage area
- d) Description of emergency vehicle access to and around project site during construction
- e) Delivery truck routes shown or noted on plan sheets

### **Energy Management Plan**

- a) Description of how project will be 20% more energy efficient than ASHRAE standards
- b) Description of utilization of sustainable forms of energy (Solar, Wind, Hydroelectric, and Biofuels)
- c) Participation in NC GreenPower program
- d) Description of how project will ensure indoor air quality, adequate access to natural lighting, and allow for proposed utilization of sustainable energy
- e) Description of how project will maintain commitment to energy efficiency and reduced carbon footprint over time
- f) Description of how the project's Transportation Management Plan will support efforts to reduce energy consumption as it affects the community

### **Exterior Elevations**

a) An outline of each elevation of the building, including the finished grade line along the foundation (height of building measured from mean natural grade)

#### 150 E Rosemary Street - Conditional Zoning

#### **Project Narrative**

The 150 E Rosemary Street office and lab building will create much needed commercial office and lab space for new and emerging businesses in downtown Chapel Hill and will be an integral component of the revitalization of East Rosemary Street. This redevelopment strategy for East Rosemary Street will create space for hundreds of new office, professional, technology and researcher workers in the heart of downtown. This new building project will also create a new Town Green public space on the southwest corner of E Rosemary and Henderson Streets as well as improved streetscape treatments on the southern frontage of E Rosemary and the western frontage of Henderson Street.

Currently, the 1.49 acre site is occupied by the Wallace Parking Deck and is owned by the Town of Chapel Hill. Under the Economic Development Agreement (EDA) between the Town and Grubb Properties, this property will be exchanged with Grubb Properties for two parcels on the north side of E Rosemary Street, where the new 125 E Rosemary Street Parking Deck will be constructed, providing approximately 1,100 parking spaces in a centralized parking facility.

The new building will also include approximately 150-170 parking spaces beneath the building to augment some of the parking need for the new office and lab building.

#### Statement of Justification - Conditional Zoning

This is a statement of justification to support the request for Conditional Zoning for 150 East Rosemary Street. This parcel is currently within the TC-2 zoning district which does not accommodate the target program for the building as contemplated by the EDA. To accommodate this program a Conditional Zoning for TC-3 is being requested. The Conditional Zoning is being requested to facilitate an open dialogue with the public and negotiations between the applicant and the Town of Chapel Hill.

In order to establish and maintain a sound, stable, and desirable development within the planning jurisdiction of the Town, it is intended that the Land Use Management Ordinance (as stated in Section 4.4) shall not be amended except:

- 1) To correct a manifest error in the chapter; or
- 2) Because of changed or changing conditions in a particular area or in the jurisdiction generally; or
- **3)** To achieve the purposes of the Comprehensive Plan.

Below is the applicant's evaluation of this application based on these three findings.

1) Finding #1: The proposed zoning amendment is necessary to correct a manifest error.

Response: We do not believe there is error in the Town's Zoning Atlas Amendment related to the project site. NOTE: since the Town just adopted the FLUM, which calls for this block to be 6-8 stories I believe, should we cite that here?

2) Finding #2: The proposed zoning amendment is necessary because of changed or changing conditions in a particular area or in the jurisdiction generally.

Response: Changing conditions center around the revitalization of the 100 block of E Rosemary street beginning with the adjacent 136 E Rosemary Street building and connected 137 E Franklin Street building, together with the EDA which contemplates the Town's investment in a centralized parking structure and requirement to seek the highest and best use of 150 E Rosemary Street for up to 250,000 square feet of office and lab space. This revitalization effort will provide much needed commercial office and lab space where new and emerging businesses can locate and grow in support of the economic vitality of downtown and greater Chapel Hill. The Future Land Use Map (FLUM) adopted on December 9, 2020 reflects the Town's goal of revitalizing this area. This project site is located within Sub-Area E of the FLUM's Downtown Focus Area and the FLUM recommends significantly greater density than currently exist within the area, with core heights of up to 8 stories.

3) Finding #3: The proposed zoning amendment is necessary to achieve the purposes of the comprehensive plan.

Response: The proposed rezoning would contribute to the following elements of the Comprehensive Plan:

### Theme 1: A Place for Everyone

- Family-friendly, accessible exterior and interior places throughout the town for a variety of active uses (PFE.1).
- A welcoming and friendly community that provides people with access to opportunities (PFE.4).

#### Theme 2: Community Prosperity and Engagement

- Balance and sustain finances by increasing revenues and decreasing expenses (CPE.1).
- Foster success of local businesses (CPE.2).

#### Theme 3: Getting Around

 A connected community that links neighborhoods, businesses and schools through the provision of greenways, sidewalks, bike facilities and public transportation (GA.2).

#### Theme 4: Good Places, New Spaces

- A vibrant, diverse, pedestrian-friendly, and accessible downtown with opportunities for growing office, retail, residential and cultural development and activity (GPNS.2).
- A joint Town/University development strategy that aligns initiatives for transportation, housing, environmental protection, and entrepreneurial programs (GPNS.4).
- A community that welcomes and supports change and creativity (GPNS.6).
- Open and accessible common spaces for community gathering, cultural uses, and community development (GPNS.7).

#### Theme 6: Town and Gown Collaboration

 Take full advantage of ideas and resources to create a thriving economy and incorporate and utilize the intellectual capital that the University and Town create (TGC.1).

### **Modifications of Regulations:**

**Building Height, Setback** - LUMO Table 3.8-1 Dimensional Matrix limits the Maximum Setback Height line in the TC-3 zoning district to 44 feet and limits the Maximum Core Height in the district to 120 feet. The proposed building will comply with the Maximum Core Height of 120 feet, but a modification of regulations is requested from the Town Council to increase the Maximum Setback Height to 112 feet in order to accommodate the targeted program for the project.

### 150 E Rosemary Street Lab & Office Building

# **Conditional Zoning**

### Responses to Concept Plan input from HDC, Community Design Commissions and Town Council

The applicant met with the Historic District Commission, the Community Design Commission and Town Council in January and February to present the initial design concepts. The following is a summary of the comments from the three bodies and the applicant's responses:

**Height:** Options for six, seven and eight story designs were shown. Most comments were favorable for six stories, while very few were supportive of eight. There was a general comfort level with a seven story option, while much of that would depend on the specific architectural articulation of the exterior, especially as seen from Franklin Street. Related to the height was a concern with potential rooftop equipment or penthouses and the visibility of those from the street.

Response: The applicant will continue to refine and study the massing and architectural articulation of the building to present at the next step of the review process. The applicant will also show the impact of the height variations to the amount of program the building can accommodate.

Character: Precedents of modern buildings in historic contexts were shared, showing how scale, articulation, materials and detailing can make modern buildings compatible with historic settings. There was general support for this approach. There was particular concern that the eastern façade of the building facing the Historic District make a meaningful relationship to the historic character of downtown, without replicating the historic structures. There was a concern about the length of the façade facing E Rosemary Street and the need for more vertical articulation, particularly at the main entrance.

Response: The applicant will continue to develop this approach with more specific design refinements, including how to incorporate more vertical articulation.

**Town Green:** The applicant presented an initial concept for the Town Green on the corner of E Rosemary Street and Henderson Street with Post Office alley continuing to Rosemary Street and with a connection to the street corner to make it accessible from the street. This approach would require regrading the existing open space which would most likely require the removal of the large Magnolia tree. While some reviewers had reservations about removing the tree there was a general consensus that the Town Green must be a successful urban space and that if that meant that the tree must be removed then it would be acceptable. There was interest in having seating, gathering spaces, and possibly a pavilion in the space.

Response: The applicant will continue to study the design of the Green and seek the input of an arborist to determine if it is feasible for the tree to remain.

**Materials:** Examples of exterior materials that will be considered were shown, including brick, terra cotta, and glass and metal panels. There was general agreement with this initial selection, pending

further study. It was expressed that the new building should have some relationship with the material selections on the new 125 E Rosemary parking deck, which include terra cotta and precast concrete.

Response: The applicant will continue to study and refine the materials selection for further review at the next step of the process.

**Pedestrian Experience:** Several reviewers emphasized that the new building must create an appealing pedestrian experience on E Rosemary and Henderson Street. They wanted to know how the sidewalk level of the building would activate the street and sidewalk and what type of uses will fact the street. The applicant was asked to eliminate or minimize the number of curb cuts on Rosemary Street.

Response: The building design will have active uses facing Rosemary Street and the Town Green with transparency so that passersby can see the interior activities. The sidewalks will be widened on E Rosemary with new streetscape and street tree planting. The sidewalk on Henderson could also be widened if the Town agrees to remove the parallel parking on the western side of the street.

**NCNB Alley:** Some reviewers were interested to know how NCNB alley could be improved to make it a more attractive pedestrian space.

Response: While it is not on the applicant's property it may be possible repave the alley and add sidewalks, but this will require much further study.

**Parking:** Reviewers wanted to understand how the parking under the building would be configured and how visible it would be from the street.


Response: There will likely be three separate levels of parking, one entirely underground, and two levels above ground but only exposed to the side facing NCNB alley. There will be no parking exposed to E Rosemary Street.

# CONDITIONAL ZONING DRAWINGS

FOR

# 150 E. ROSEMARY STREET LAB AND OFFICE BUILDING

CHAPEL HILL, ORANGE COUNTY, NORTH CAROLINA

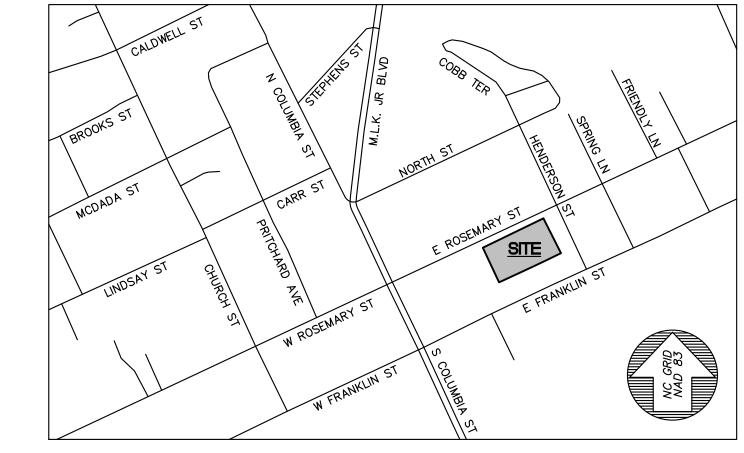


VICINITY MAP

SCALE: 1"=500"


# **DRAWING LIST**

9	<u>SHEET</u>	DRAWING TITLE	LATEST ISSUE DATE
(	G0001	COVER SHEET	23 JUL 21
(	C0001	AREA MAP	23 JUL 21
(	C0101	EXISTING CONDITIONS & DEMOLITION PLAN	23 JUL 21
(	C1000	BLOCK OVERVIEW	23 JUL 21
(	C1001	SITE PLAN	23 JUL 21
(	C1002	SOLID WASTE MANAGEMENT PLAN	23 JUL 21
(	C1101	UTILITY PLAN	23 JUL 21
(	C1201	GRADING & DRAINAGE PLAN	23 JUL 21
(	C4201	SCM ENLARGEMENT	23 JUL 21
(	C5001	SITE DETAILS	23 JUL 21
(	C5101	UTILITY DETAILS	23 JUL 21
(	C5102	UTILITY DETAILS	23 JUL 21
(	C5201	STORM DRAINAGE DETAILS	23 JUL 21
(	C5202	STORM DRAINAGE DETAILS	23 JUL 21
	L200	HARDSCAPE PLAN	15 JUL 21
	L201	PLANTING PLAN	15 JUL 21
	A-101	FLOOR PLANS	01 JUN 21
	A-102	FLOOR PLANS	01 JUN 21
	A-314	DETAILS	01 JUN 21
;	Z-110	ZONING ENVELOPE ELEVATIONS	01 JUN 21

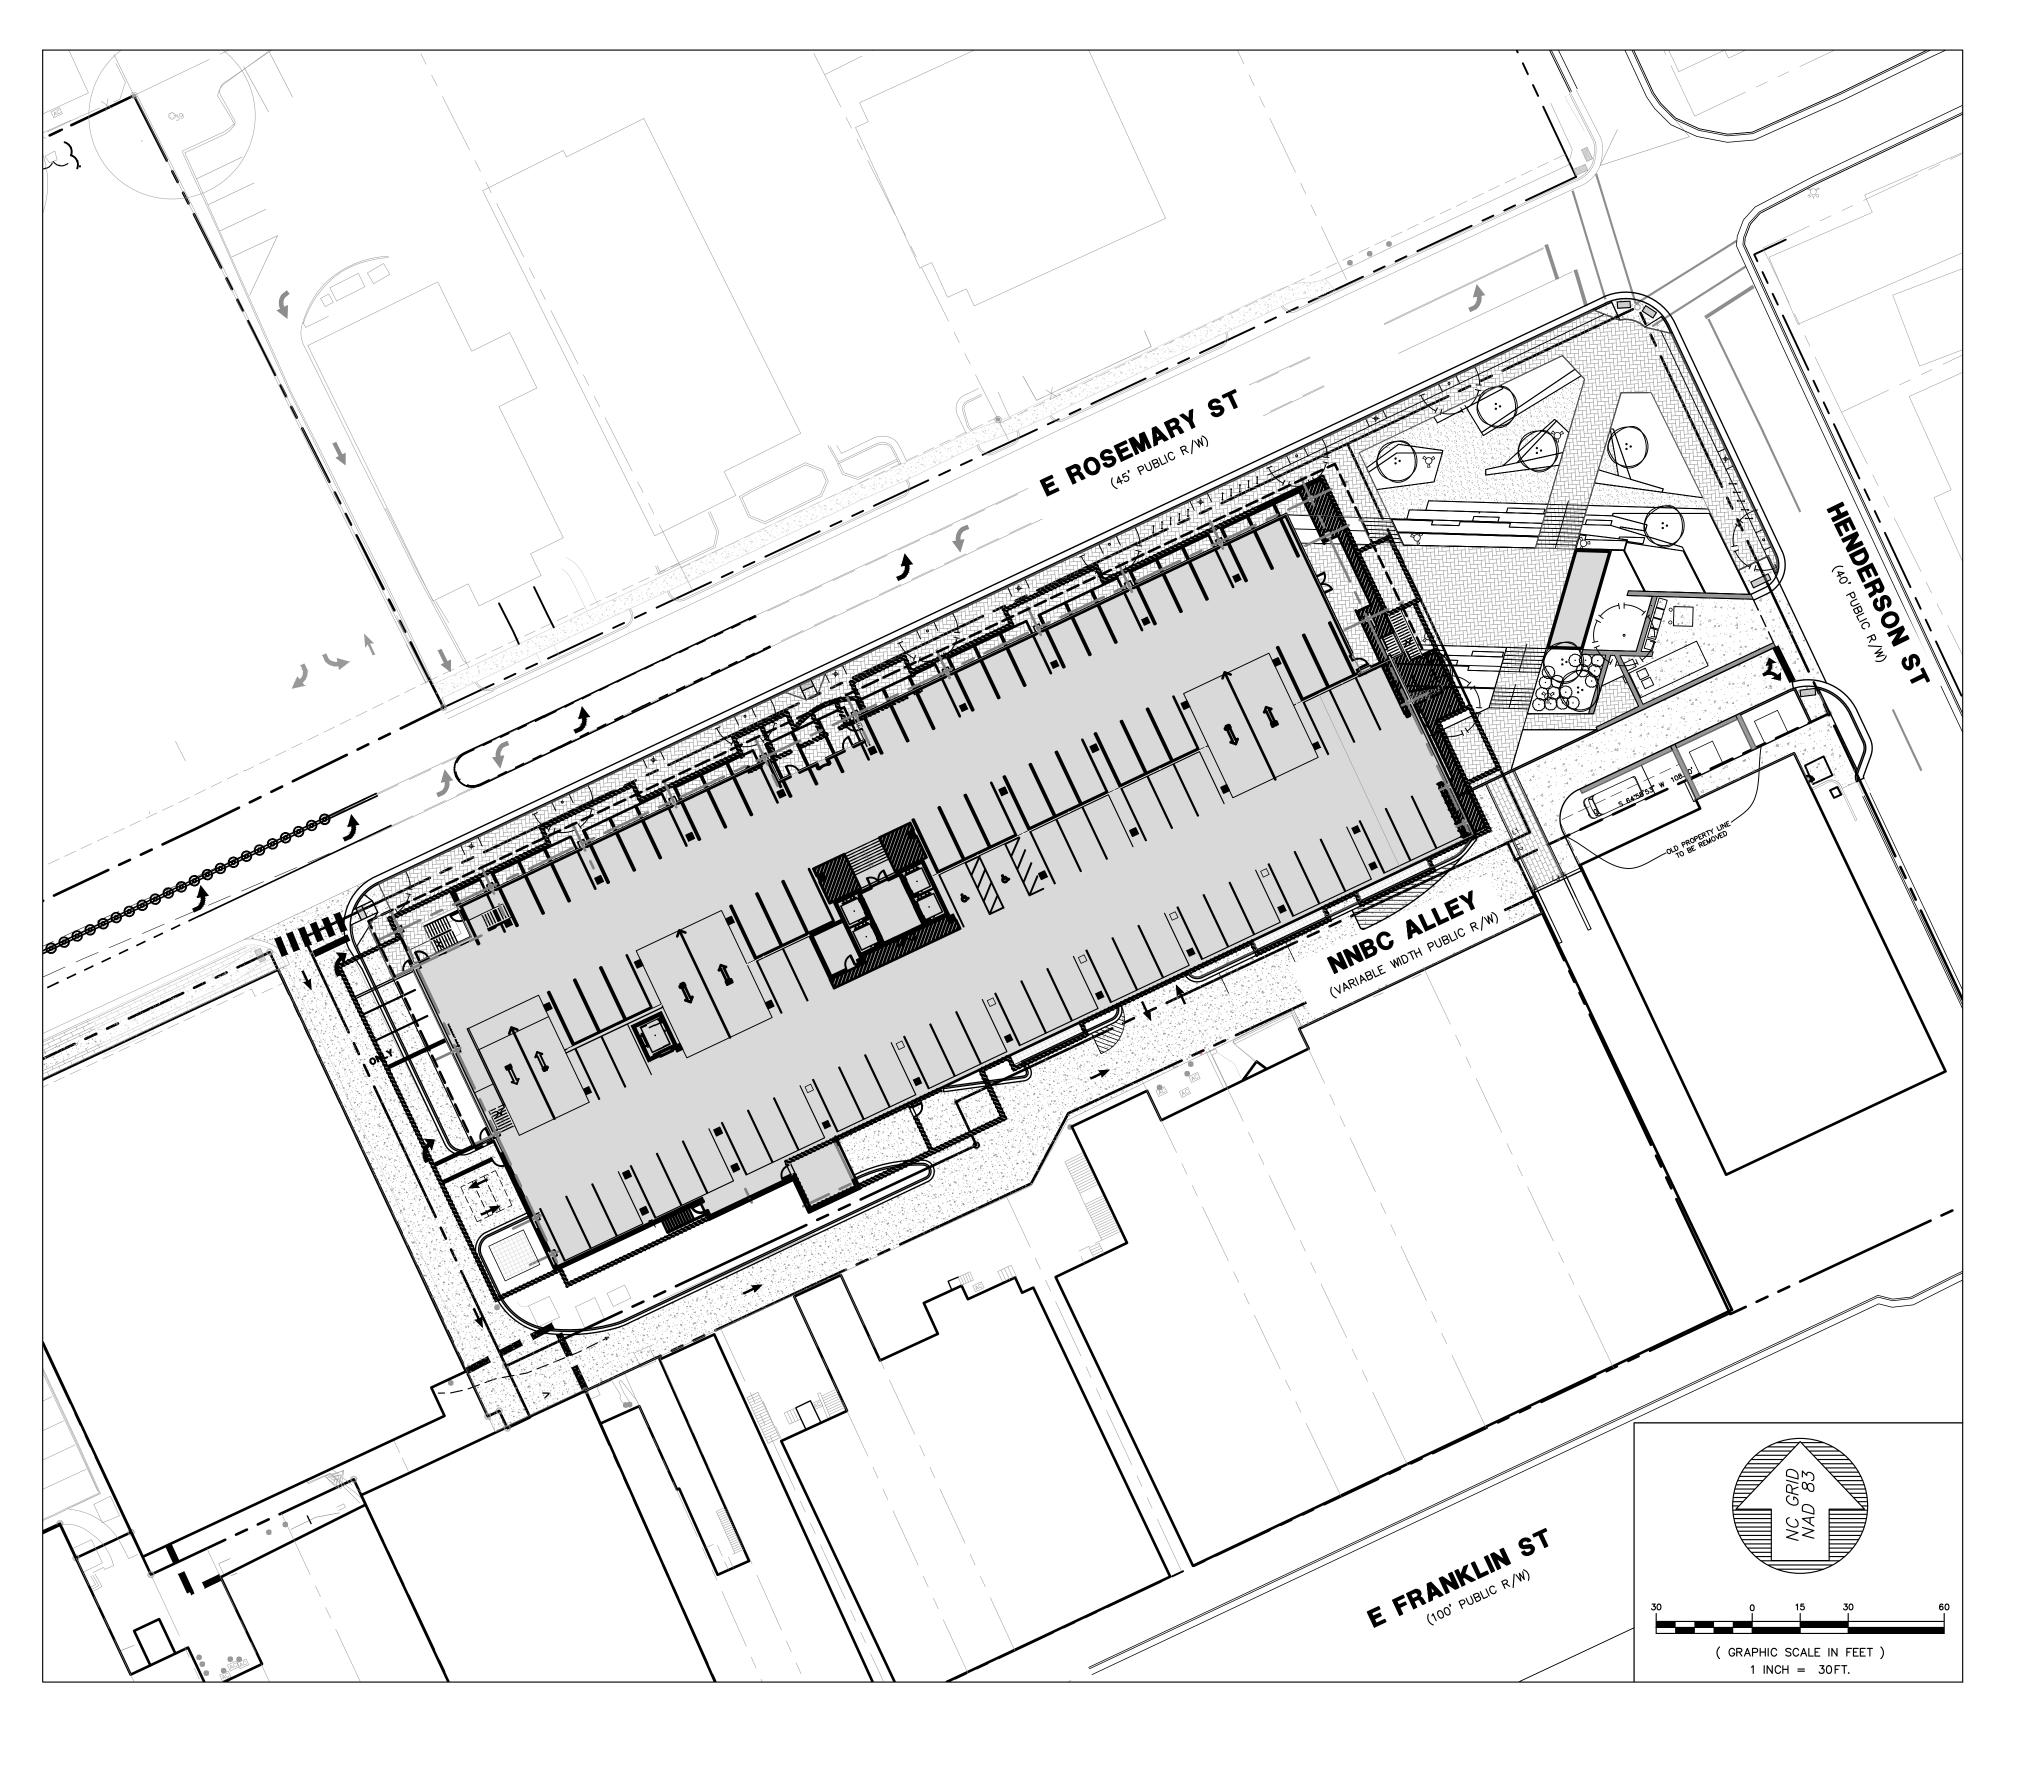

PERKINS—
EASTMAN

555 FAYETTEVILLE STREET
RALEIGH, NC 27601
(704) 927-0484

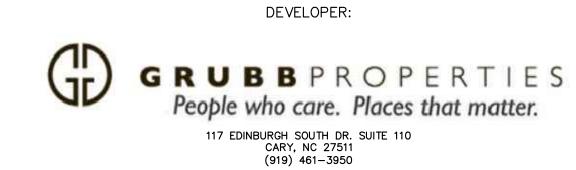

SITE PLANNING / CIVIL ENGINEERING:

BALLENTINE

ASSOCIATES, P.A.

221 PROVIDENCE ROAD, CHAPEL HILL, N.C. 27514
(919) 929 - 0481 (919) 489 - 4789

CONDITIONAL ZON
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CONDITIONAL ZON

150 E. ROSEMAF LAB & OFFICE CHAPEL HILL, NORTH

JOB #: 118038.03

DATE: 10 FEB 21


SCALE: AS NOTED

DRAWN BY: A.A.A./S.R.H.

REVIEWED BY: G.J.R.

SHEET

G0001

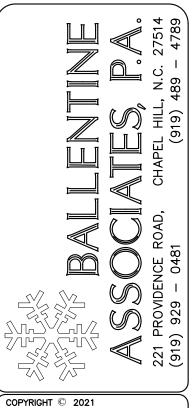


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OWNER INFORMATION GRUBB PROPERTIES, INC

4500 CAMERON VALLEY PKWY.
SUITE 350
CHARLOTTE, NC 28211
OWNERS REPRESENTATIVE:
JOE DYE
(919) 388-5774
FAX (919) 461-3939
EMAIL jdye@grubbproperties.com

10 23 23 28 28

PROJECT SITE

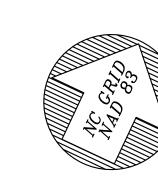

**AREA MAP** 

( GRAPHIC SCALE IN FEET ) 1 inch = 200 ft. REVIEW DRAWING NOT FOR CONSTRUCTION

REVIEWED BY: G.J.R. SHEET


C0001

150 LA

JOB #: 118038.03

DATE: 10 FEB 21 SCALE: AS NOTED

DRAWN BY: A.A.A./S.R.H.

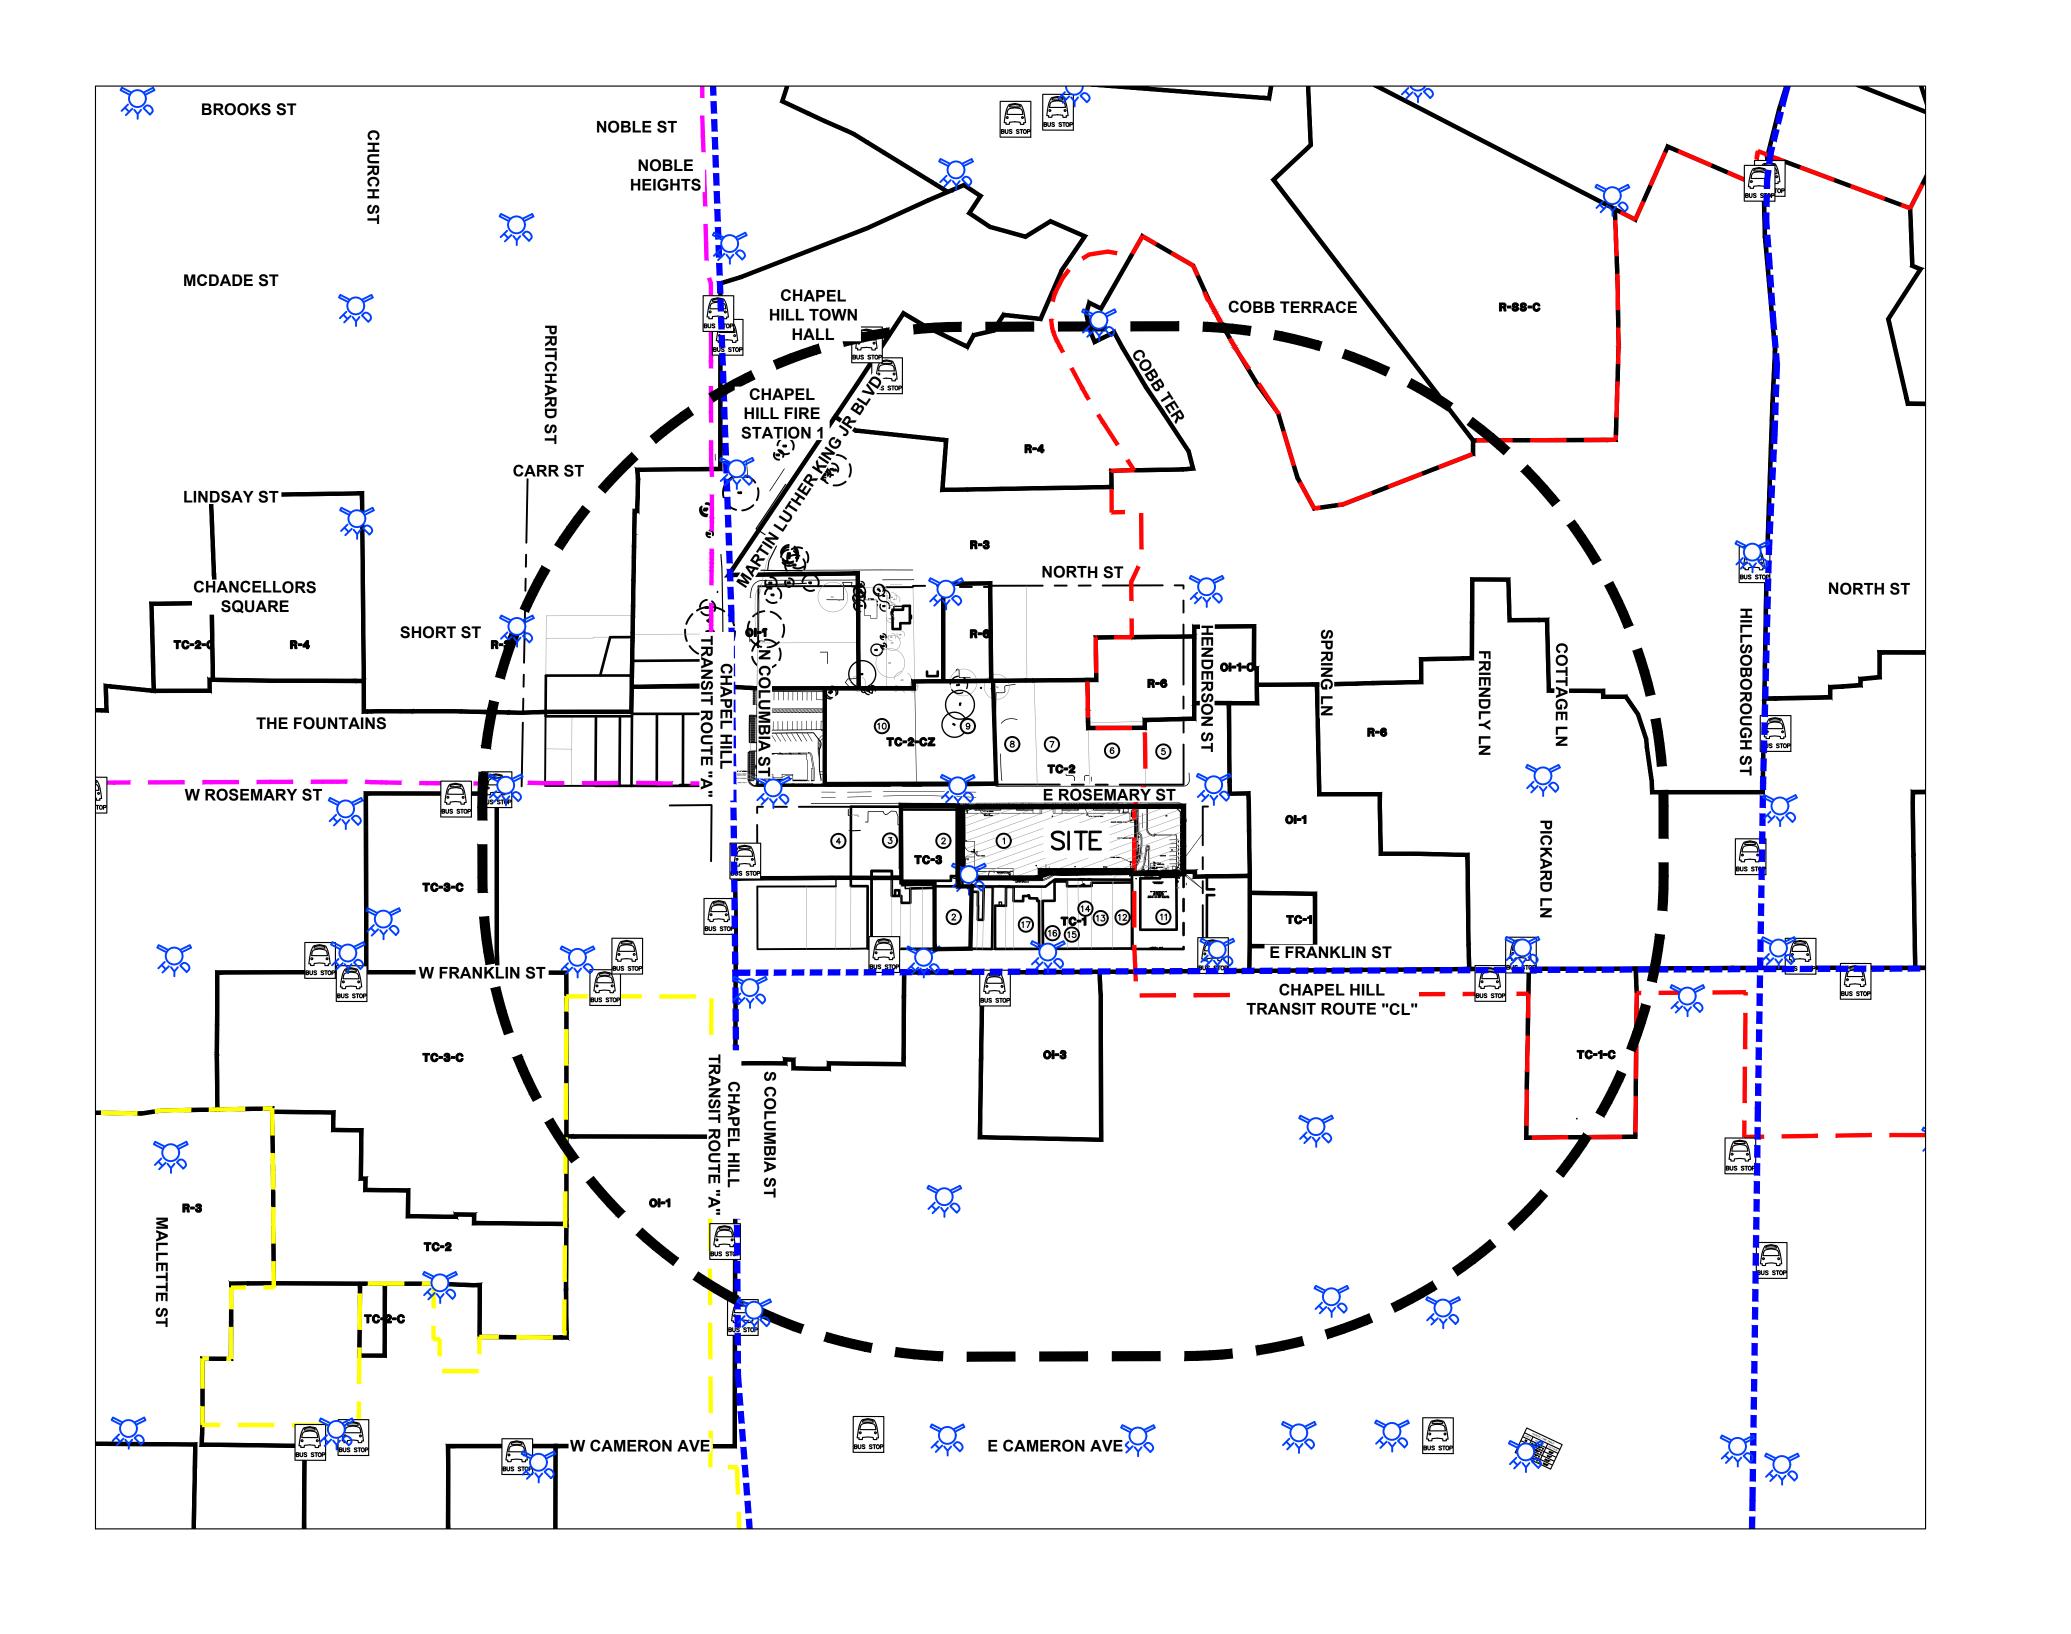

# SITE PARCEL DATA


1 TOWN OF CHAPEL HILL 9788-37-9717 TC-2 1269/442 1.49 PARKING DECK	LABEL #	OWNER	PIN #	ZONING	DB./PG.	PARCEL ACREAGE	CURRENT LAND USE
	1	TOWN OF CHAPEL HILL	9788-37-9717	TC-2	1269/442	1.49	PARKING DECK

# **ADJOINER PARCEL DATA**

LABEL #	OWNER(S)	PIN #	ZONING	CURRENT LAND USE
2	FRANKLIN OFFICE CHAPEL HILL LLC	9788-37-7517	TC-3	OFFICE
3	TOWN OF CHAPEL HILL	9788-37-5557	TC-2	PARKING LOT
4	TOWN OF CHAPEL HILL	9788-37-4469	TC-2	PARKING LOT
5	CELESTE H. SLOOP	9788-48-0001	TC-2	PARKING LOT
6	PALIOURAS ENTERPRISES LLC	9788-37-9926	TC-2	RESTAURANT
7	SPIKE III LLC	9788-38-8082	TC-2	OFFICE
8	BRANCH BANKING AND TRUST CO	9788-37-7911	TC-2	BANK
9	INVESTORS TITLE COMPANY	9788-37-6817	TC-2-CZ	PARKING LOT
10	FRANKLIN OFFICE CHAPEL HILL LLC	9788-37-4748	TC-2-CZ	PARKING DECK
11	TOWN OF CHAPEL HILL	9788-47-1649	TC-1	POST OFFICE
12	CHRIS LINDA K. TRUSTEE	9788-47-0687	TC-1	RESTAURANT
13	LILLY PROPERTIES LLC	9788-47-0645	TC-1	RESTAURANT
14	CAROLYN R COBB ETAL	9788-47-0614	TC-1	RETAIL
15	LILLY NANCY COBB/ LILLY PROPERTIES LLC	9788-37-9693	TC-1	RESTAURANT
16	144 PROPERTIES LLC	9788-37-9660	TC-1	NIGHTCLUB
17	MUNCH FAMILY PROPERTIES LLC	9788-37-9517	TC-1	RETAIL

# DRAWING LEGEND


# DESCRIPTION 1000' NOTIFICATION LINE ZONING BOUNDARY FRANKLIN-ROSEMARY HISTORIC DISTRICT CAMERON-MCCAULEY HISTORIC DISTRICT NORTHSIDE NEIGHBORHOOD CONSERVATION DISTRICT CHAPEL HILL TRANSIT ROUTE ZONING CLASSIFICATION EXISTING FIRE HYDRANT EXISTING BUS STOP

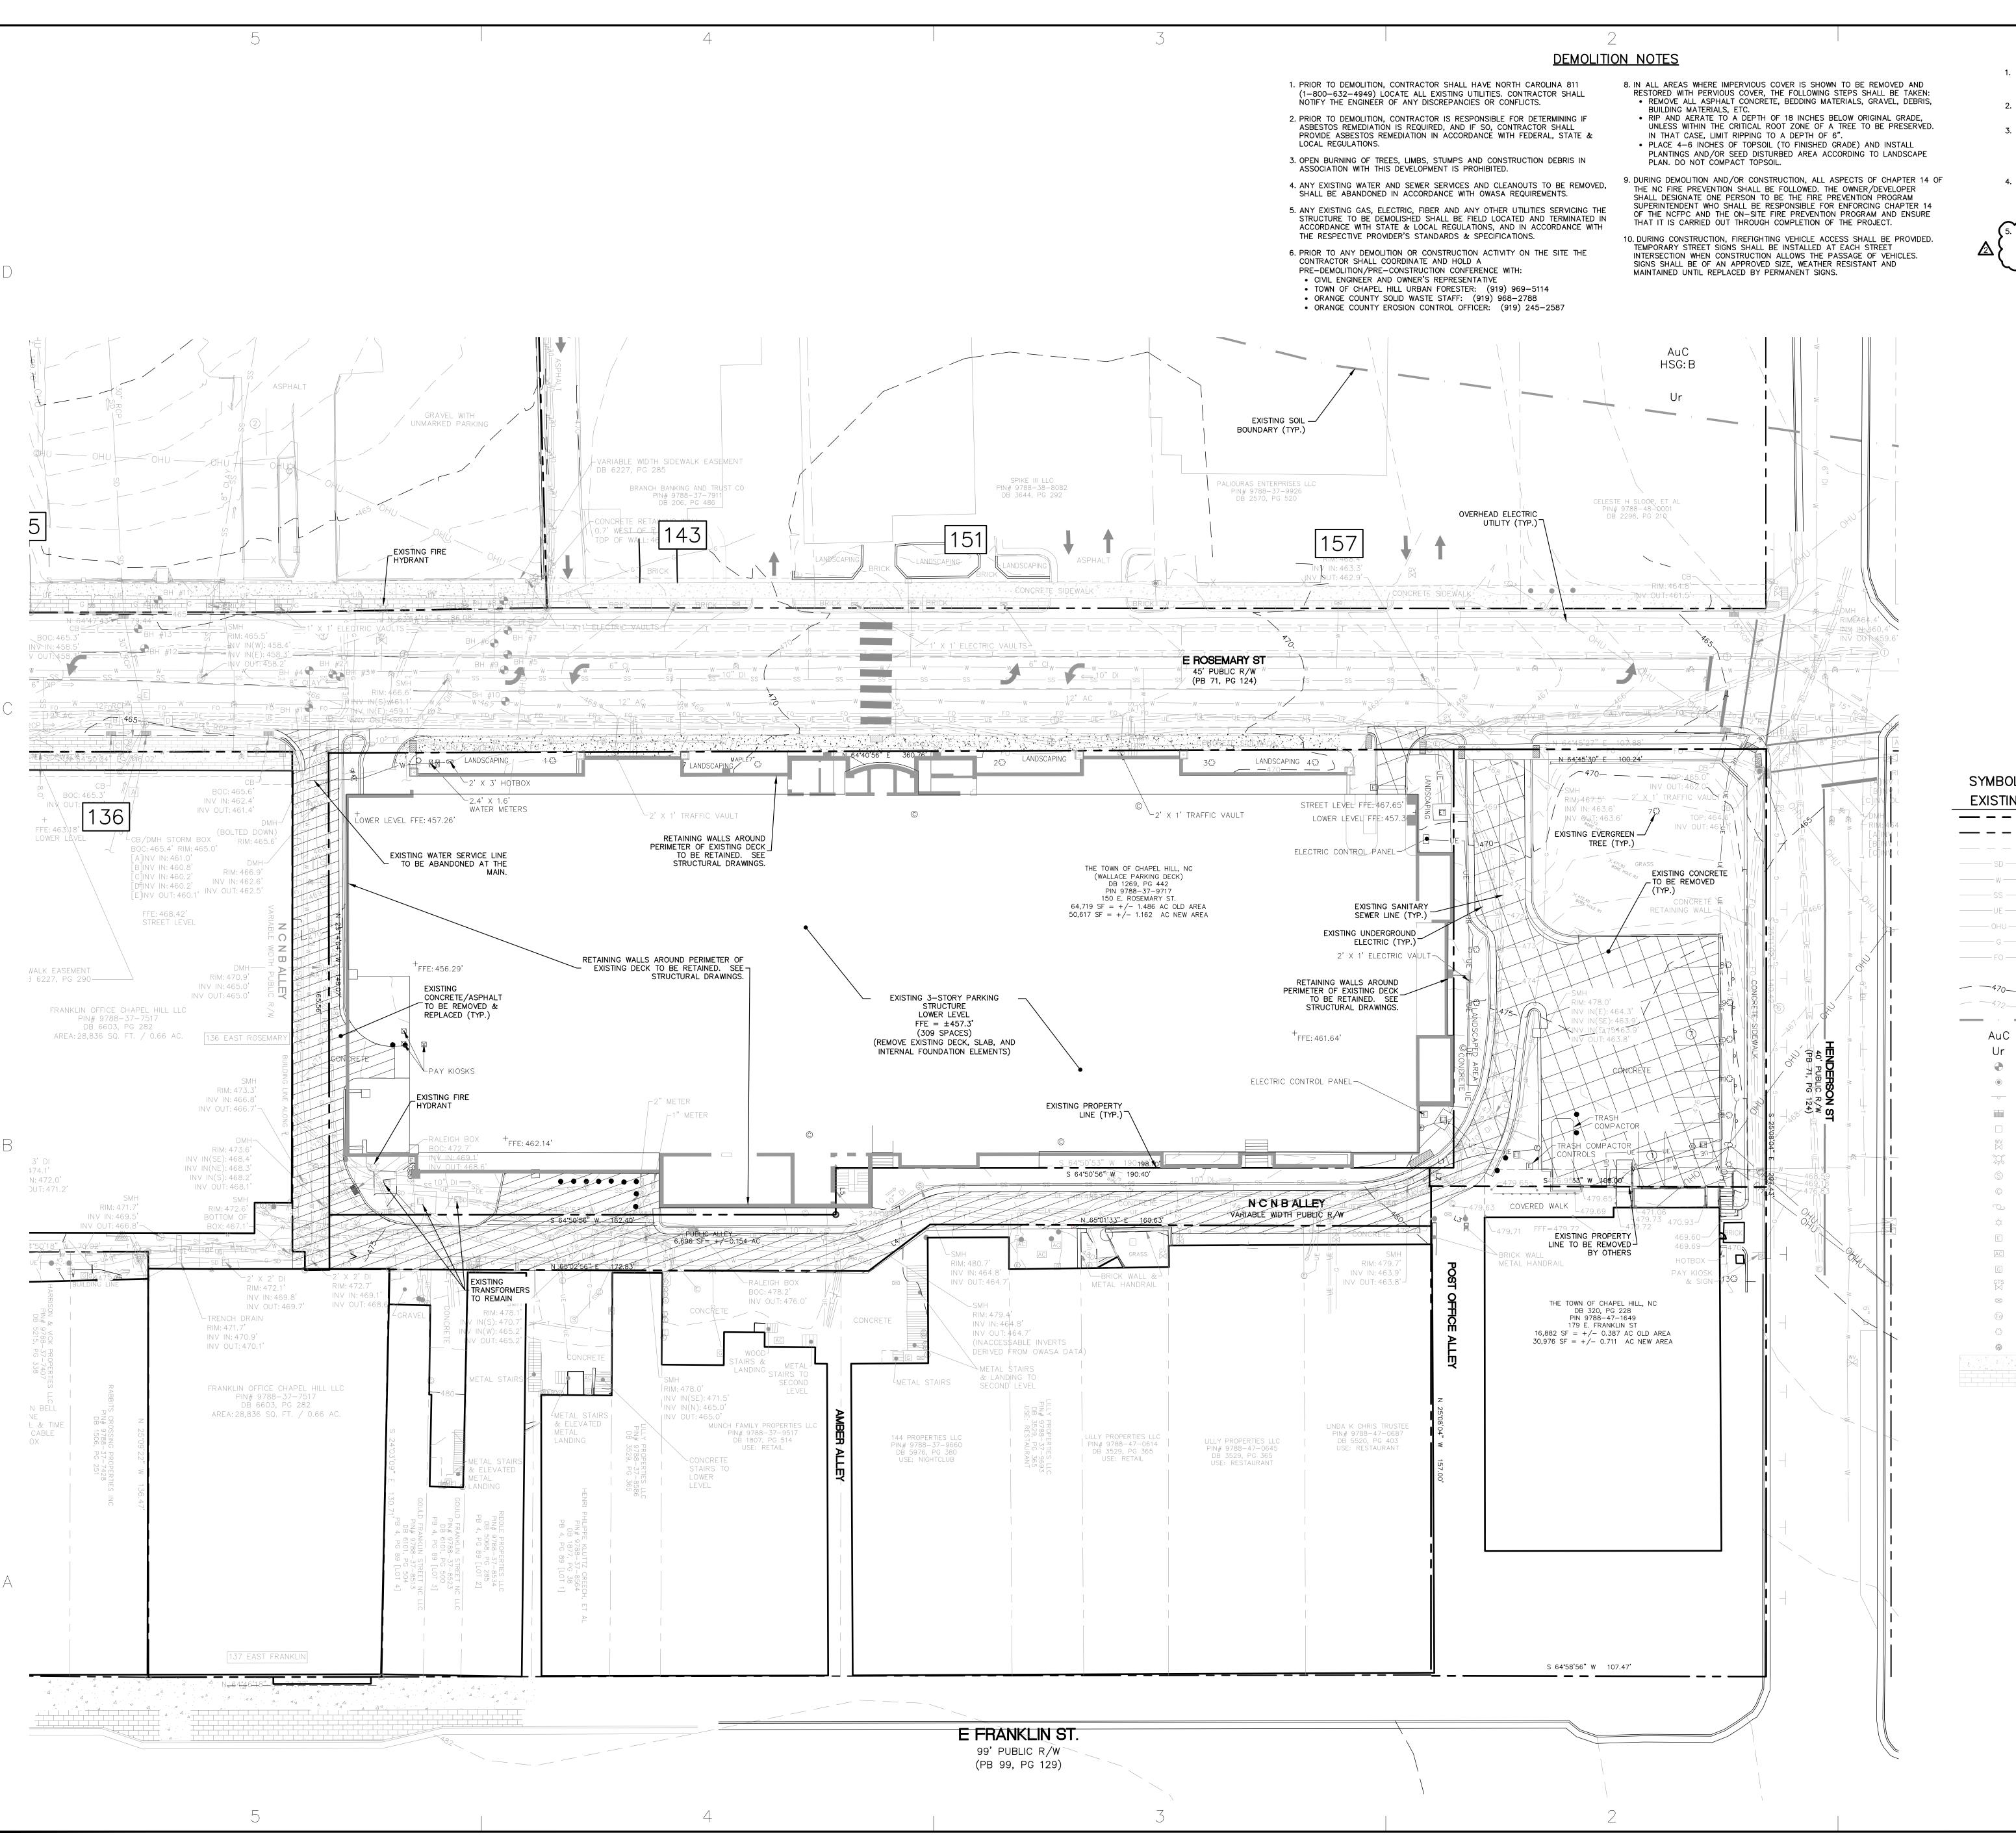

OR CONFLICTS PRIOR TO BEGINNING CONSTRUCTION.


- 1. EXISTING CONDITIONS SHOWN ARE BASED UPON SITE SURVEYS PERFORMED BY BALLENTINE ASSOCIATES, KCI ASSOCAITES AND ORANGE COUNTY GIS
- 2. THE PROPERTY DOES NOT LIE WITHIN A SPECIAL FLOOD HAZARD AREA AS
- SHOWN ON FLOOD INSURANCE RATE MAP 3710978800K. 3. CONTRACTOR SHALL HAVE NORTH CAROLINA ONE CALL (1-800-632-4949). LOCATE ALL EXISTING UTILITIES PRIOR TO BEGINNING CONSTRUCTION. CONTRACTOR SHALL VERIFY THE DEPTH AND LOCATION OF ALL EXISTING UTILITIES AND NOTIFY THE ENGINEER OF ANY DISCREPANCIES
- 4. THIS PLAN IS DIAGRAMMATIC AND REPRESENTS THE APPROXIMATE LOCATION OF UTILITIES UNLESS SPECIFICALLY DIMENSIONED. NOT ALL EXISTING UTILITIES ARE SHOWN. THE CONTRACTOR SHALL COORDINATE MINIMUM SIZE, SLOPE, AND CODE REQUIREMENTS.

THE ACTUAL LOCATION OF UTILITIES TO AVOID CONFLICTS AND MEET ONCE BUILDING DEMOLITION IS COMPLETE, ADDITIONAL SOIL EXPLORATION TO BE CONDUCTED AND THE FULL REPORT TO BE SENT TO THE TOWN ( CHAPEL HILL ENGINEERING DIVISION. 

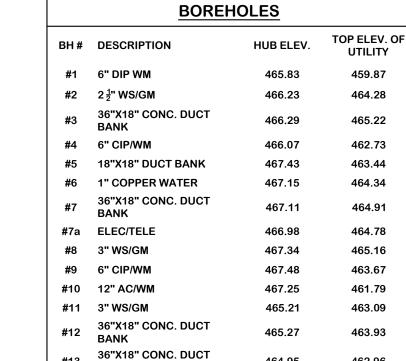

# **DRAWING LEGEND**

EXISTING	DEMO	DESCRIPTION
		- PROPERTY LINE
		RIGHT-OF-WAY LINE
		ADJOINER PROPERTY LINE
SD		- STORM DRAIN LINE
	W	— WATER LINE
SS	SS	<ul> <li>SANITARY SEWER LINE</li> </ul>
———UE ———	———UE ———	UNDERGROUND ELECTRIC LINE
——— OHU ———	OHU	OVERHEAD ELECTRIC LINE
G	G	— GAS LINE
FO	——— FO ———	- FIBER OPTIC LINE
		LIMITS OF DISTURBANCE
- <del>- 470</del>		MAJOR CONTOUR
472-		MINOR CONTOUR
		SOIL BOUNDARY
AuC		APPLING-URBAN LAND COMPLE
Ur		URBAN LAND
•		BOREHOLE
•	•	EXISTING IRON PIPE
	<del>-</del> o-	SIGN
		CATCH BASIN
		DROP INLET
₩V	₩V	WATER VALVE
Ş.	Ş	FIRE HYDRANT
S	S	SANITARY SEWER MANHOLE
©	©	SANITARY SEWER CLEANOUT
	C	POWER POLE
<b>\$</b>	<b>\$</b>	LIGHT POLE
E	E	ELECTRIC BOX
AC	AC	HVAC UNIT
G	G	GAS METER
GTS ⋈	GTS ⋈	GAS VALVE
$\boxtimes$	$\boxtimes$	TELEPHONE VAULT

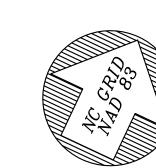

**EXISTING CONDITIONS & DEMOLITION PLAN** 

DECIDUOUS TREE

CONIFEROUS TREE

BRICK SIDEWALK

CONCRETE SIDEWALK

( GRAPHIC SCALE IN FEET 1 inch = 20 ft.

**REVIEW DRAWING** NOT FOR CONSTRUCTION C0101

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(919) 388-5774 FAX (919) 461-3939


EMAIL jdye@grubbproperties.com

#2 #3


150 LA

JOB #: 118038.03 DATE: 10 FEB 21 SCALE: AS NOTED DRAWN BY: A.A.A./S.R.H.

REVIEWED BY: G.J.R. SHEET

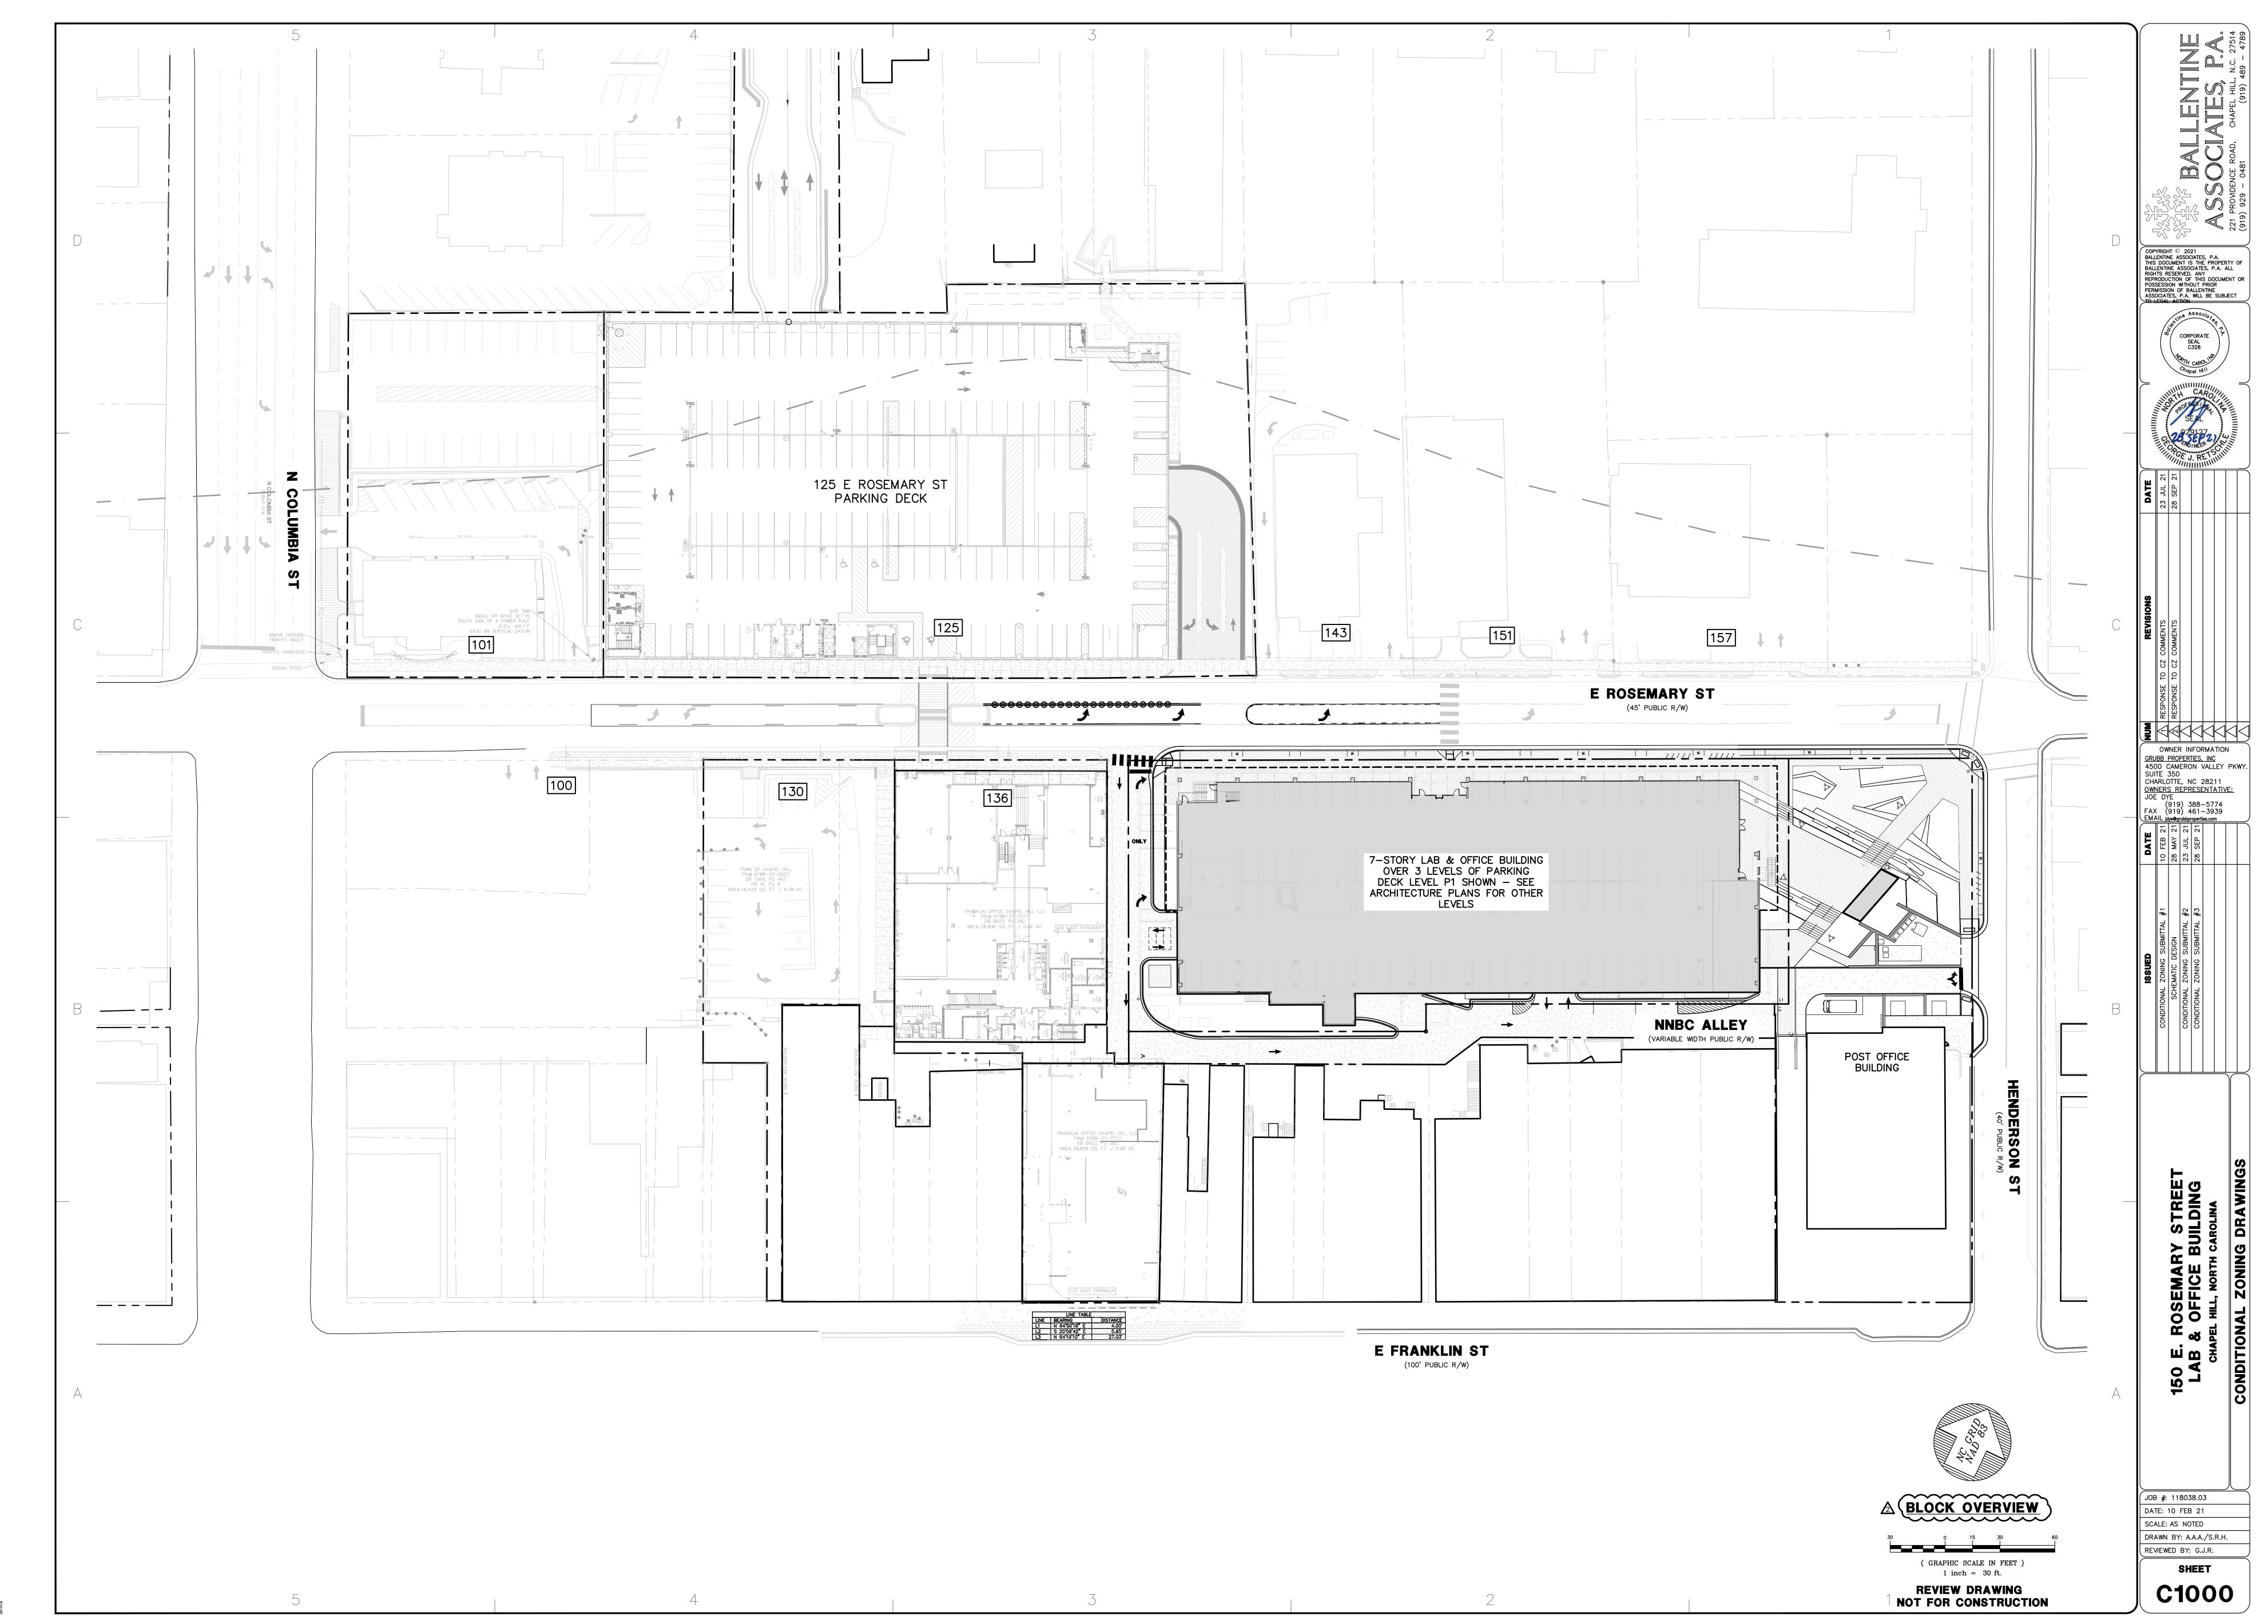

ojects\119016.00 Rosemary St Properties\119016.03 150 E Rosemary\1\_\_Dwg\BA-Model Files\C1000-Site-150 E Rosemary.dwg, C10

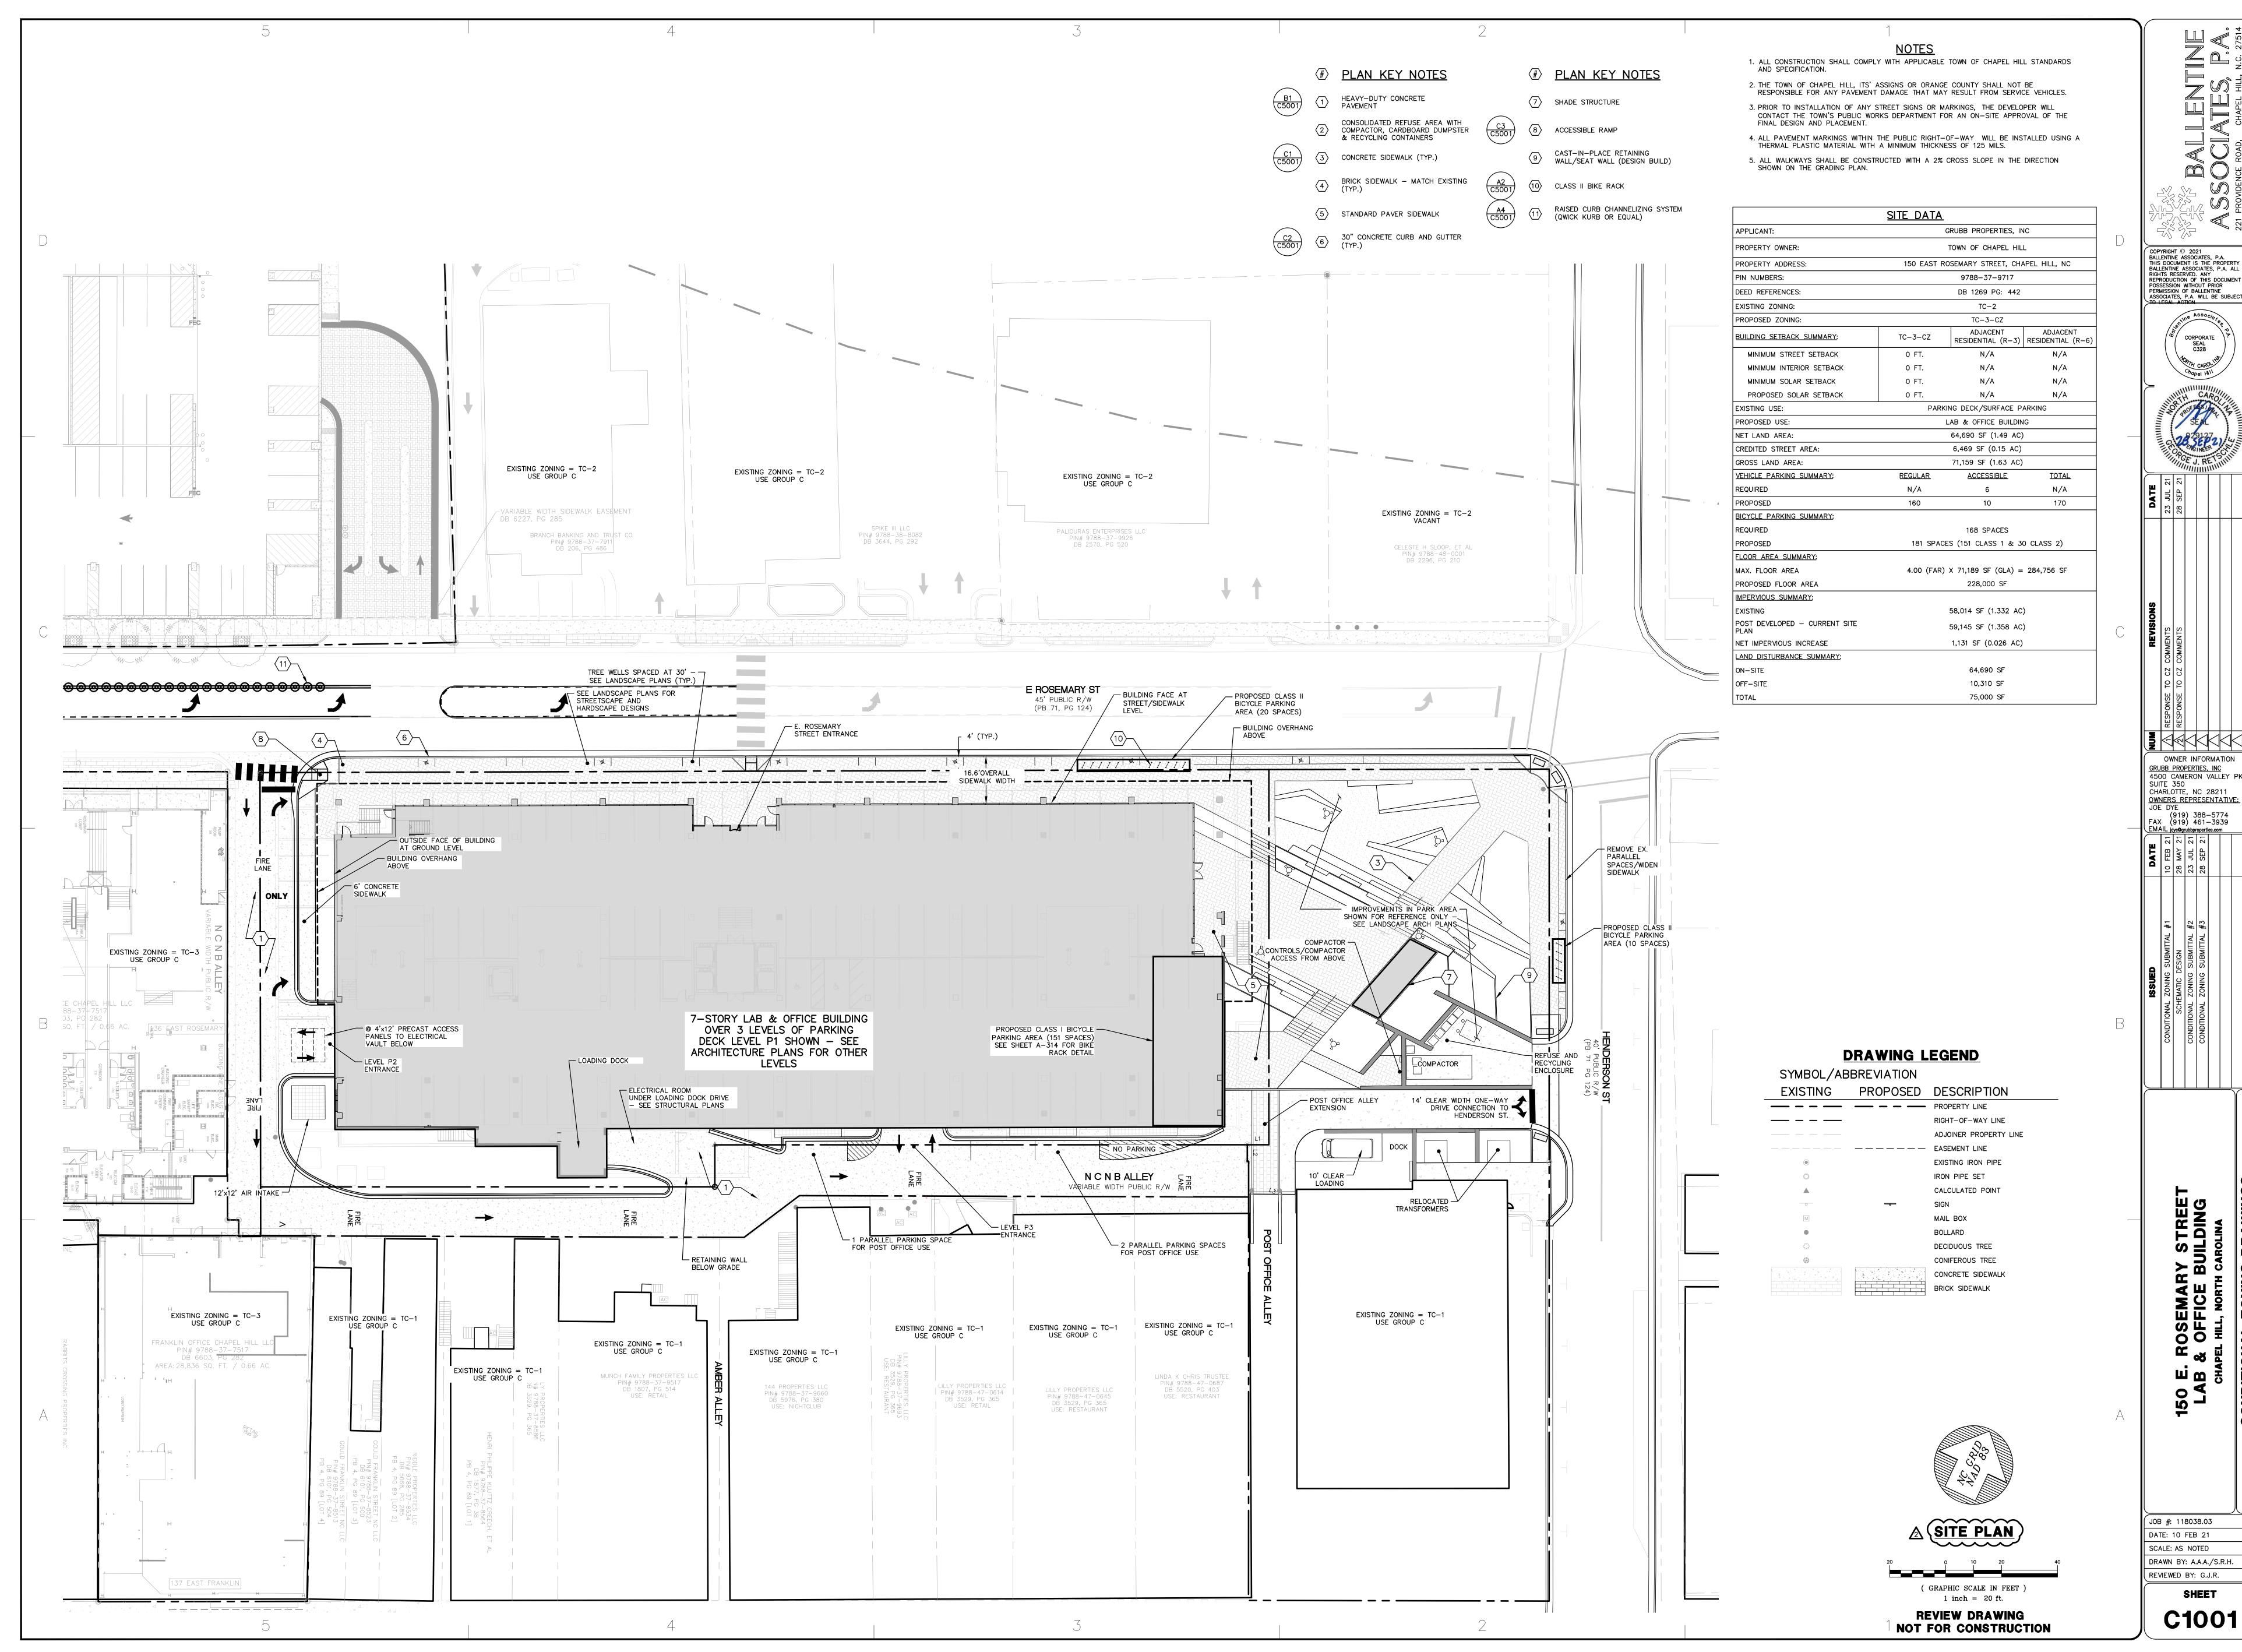

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CORPORATE Chapel Hill

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10 28 23 28

#2 #3

150 LA

JOB #: 118038.03

DATE: 10 FEB 21 SCALE: AS NOTED DRAWN BY: A.A.A./S.R.H. REVIEWED BY: G.J.R.

SHEET

# SOLID WASTE MANAGEMENT PLAN

PROJECT NARRATIVE

THE FOLLOWING IS A NARRATIVE OF HOW SOLID WASTE, MIXED RECYCLABLES, AND CORRUGATED CARDBOARD WILL BE HANDLED FOR THE FUTURE DEVELOPMENT LOCATED AT 150 E ROSEMARY ST. IN CHAPEL HILL. IT IS THE INTENT OF THE PROJECT DEVELOPER/APPLICANT TO UTILIZE THE SERVICES OF A PRIVATE COMPANY FOR THE COLLECTION OF THE STORED SOLID WASTE, MIXED RECYCLABLES, AND CORRUGATED CARDBOARD PURSUANT TO THIS OUTLINE. IN DOING SO, THE PROJECT DEVELOPER/APPLICANT UNDERSTANDS AND AGREES THAT THEY ARE WAIVING THEIR RIGHTS O HAVE ORANGE COUNTY COMMUNITY RECYCLING COLLECT MIXED RECYCLABLES AND THAT THE PROJECT WILL NOT RECEIVE PUBLIC RECYCLING COLLECTION AT ANY TIME NOW OR IN 3. COUNTY FEES FOR RECYCLING AND WASTE MANAGEMENT ASSOCIATED WITH THIS THE FUTURE UNLESS A RECYCLING CENTER IS CONSTRUCTED TO ORANGE COUNTY SPECIFICATIONS OR CONTINGENCY FOR SUCH A CENTER IS INCLUDED ON THE DEVELOPMENT PLANS. FURTHER, THE PROJECT DEVELOPER/APPLICANT UNDERSTANDS THAT THE FEES FOR 4. APPLICANT AGREES TO ENTER INTO A SERVICE AGREEMENT WITH A PRIVATE SOLID PUBLIC RECYCLING AND WASTE MANAGEMENT WILL NOT BE WAIVED. IN ADDITION, PRIOR TO PLAN APPROVAL, THE PROJECT DEVELOPER/APPLICANT SHALL PROVIDE A COPY OF A LETTER FROM THE INTENDED PRIVATE GARBAGE, MIXED RECYCLABLE AND CORRUGATED CARDBOARD COLLECTOR ACKNOWLEDGING THAT THEY HAVE REVIEWED THE PROJECT PLANS

MATERIALS AS STATED HEREIN. REFUSE SUMMARY

A. THE PROJECT IS DESIGNED WITH A GARBAGE DUMPSTER & COMPACTOR. GARBAGE RECEPTACLES WILL BE LOCATED THROUGHOUT THE BUILDING AND SITE, AND WILL BE RECEPTACLES WILL BE LOCATED AS MEDDED BY MANAGEMENT PERSONNEL. OFFICE AND MONITORED AND COLLECTED AS NEEDED BY MANAGEMENT PERSONNEL. OFFICE AND LAB WORKERS ARE RESPONSIBLE FOR DEPOSITING THEIR TRASH INTO THE DUMPSTER. CORRUGATED CARDBOARD AND MIXED RECYCLABLES SHALL NOT BE PLACED IN THE

AND AGREE TO THE PRESCRIBED METHODS FOR STORAGE AND COLLECTION OF THESE

GARBAGE DUMPSTER. GARBAGE AND RECYCLING RECEPTACLES WILL BE MARKED WITH APPROPRIATE SYMBOLS. B. THE DUMPSTERS WILL BE LOCATED IN THE ENCLOSURE LOCATED AT THE SOUTHEASTERN CORNER OF THE SITE. MANAGEMENT PERSONNEL SHALL BE RESPONSIBLE FOR MANAGING THE DUMPSTER ENCLOSURE AS NEEDED. C. ON TRASH COLLECTION DAY, MANAGEMENT PERSONNEL SHALL ENSURE THAT THE DUMPSTERS ARE ACCESSIBLE TO THE PRIVATE COLLECTION VENDOR. "NO PARKING" SIGNS SHALL BE PLACED ON THE OUTSIDE OF THE DUMPSTER ENCLOSURE GATE. D. INITIALLY WE ANTICIPATE TRASH PICK-UP TO OCCUR AT LEAST TWICE PER WEEK.

MANAGEMENT PERSONNEL WILL MONITOR TRASH VOLUMES AND ADJUST PICK-UP SCHEDULE(S) AS NEEDED. E. GARBAGE COLLECTION AND HAUL OFF WILL BE PERFORMED BY A PRIVATE VENDOR, HIRED BY MANAGEMENT.

RECYCLING SUMMARY

A. THE PROJECT IS DESIGNED WITH AN OVER-SIZED DUMPSTER ENCLOSURE TO ACCOMMODATE ROLL CARTS & A CARDBOARD RECYCLING DUMPSTER. THE ROLL CARTS WILL BE USED TO STORE ALL COMMINGLED RECYCLING. OFFICE AND LAB WORKERS ARE RESPONSIBLE FOR DEPOSITING THEIR RECYCLABLES IN THE ROLL CARTS. B. TRASH SHALL NOT BE PLACED IN THE RECYCLING ROLL CARTS AND SIGNS STATING THIS WILL BE PLACED ON THE CARTS. C. INITIALLY WE ANTICIPATE COMMINGLED RECYCLING PICK-UP TO OCCUR AT LEAST TWICE PER WEEK. MANAGEMENT PERSONNEL WILL MONITOR COMMINGLED RECYCLING VOLUMES AND ADJUST PICK-UP SCHEDULE(S) AS NEEDED. D. RECYCLING COLLECTION AND HAUL OFF WILL BE PERFORMED BY A PRIVATE VENDOR, HIRED BY MANAGEMENT.

CARDBOARD

A. CORRUGATED CARDBOARD WILL BE PLACED EXCLUSIVELY INTO THE CARDBOARD B. OFFICE AND LAB WORKERS WILL BE RESPONSIBLE FOR DELIVERING BROKEN DOWN CORRUGATED CARDBOARD BOXES AND OTHER CARDBOARD TO THE CARDBOARD C. INITIALLY WE ANTICIPATE CARDBOARD PICK-UP TO OCCUR AT LEAST TWICE PER WEEK. MANAGEMENT PERSONNEL WILL MONITOR CARDBOARD VOLUMES AND ADJUST PICK-UP SCHEDULE(S) AS NEEDED.

# PUBLIC RECYCLING WAIVER

1. APPLICANT ELECTS TO PROVIDE RECYCLING SERVICES TO RESIDENTS/TENANTS OF THIS PROPERTY IN LIEU OF BUILDING A RECYCLING STATION CONSTRUCTED TO ORANGE COUNTY SPECIFICATIONS. THE SITE WILL NOT RECEIVE PUBLIC RECYCLING COLLECTION NOW OR IN THE FUTURE UNLESS SUCH A RECYCLING STATION IS CONSTRUCTED OR CONTINGENCY FOR SUCH A STATION IS INCLUDED ON THE

DEVELOPMENT PLANS. 2. APPLICANT MUST REQUIRE AT THE LEAST THE SAME LEVEL OF SERVICE (CURRENT

OR FUTURE) TO ITS OFFICE AND LAB WORKERS AS THAT PROVIDED BY ORANGE PROJECT/PROPERTY WILL NOT BE WAIVED.

WASTE/RECYCLING COLLECTION CONTRACTOR THAT IS ACCEPTABLE TO ORANGE COUNTY. FURTHER, THE AGREEMENT SHALL PROVIDE FOR THE COLLECTION AND RECYCLING OF CORRUGATED CARDBOARD IN ADDITION TO THE OTHER CO-MINGLED RECYCLABLES AND AN EXECUTED COPY OF THE AGREEMENT SHALL BE PROVIDED TO AND APPROVED BY ORANGE COUNTY PRIOR TO APPROVAL OF FINAL

# **CONSTRUCTION WASTE NOTES**

CONSTRUCTION PLANS FOR THE PROPERTY/PROJECT.

SHALL BE LICENSED BY ORANGE COUNTY.

ALL EXISTING STRUCTURES 500 SQUARE FEET AND LARGER SHALL BE ASSESSED PRIOR TO THE ISSUANCE OF A DEMOLITION PERMIT TO ENSURE COMPLIANCE WITH THE COUNTY'S REGULATED RECYCLABLE MATERIALS ORDINANCE (RRMO) AND TO ASSESS THE POTENTIAL FOR DECONSTRUCTION AND/OR THE REUSE OF SALVAGEABLE MATERIALS.

PURSUANT TO THE COUNTY'S RRMO, CLEAN WOOD WASTE, SCRAP METAL, AND CORRUGATED CARDBOARD PRESENT IN CONSTRUCTION OR DEMOLITION WASTE MUST COPYRIGHT © 2021
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CHARLOTTE, NC 28211 OWNERS REPRESENTATIVE:

(919) 388-5774 FAX (919) 461-3939

#1

SUITE 350

4500 CAMERON VALLEY PKWY.

PURSUANT TO THE COUNTY'S RRMO, ALL HAULERS OF MIXED CONSTRUCTION AND DEMOLITION WASTE (WHICH INCLUDES ANY REGULATED RECYCLABLE MATERIALS)

4. PRIOR TO ANY DEMOLITION OR CONSTRUCTION ACTIVITY ON THE SITE, THE APPLICANT SHALL HOLD A PRE-DEMOLITION/PRE-CONSTRUCTION CONFERENCE WITH SOLID WASTE STAFF. THIS MAY BE THE SAME PRE-CONSTRUCTION MEETING HELD WITH OTHER DEVELOPMENT/ENFORCEMENT OFFICIALS.

5. THE PRESENCE OF ANY ASBESTOS CONTAINING MATERIALS ('ACM') AND/OR OTHER HAZARDOUS MATERIALS SHALL BE HANDLED IN ACCORDANCE WITH ANY AND ALL LOCAL, STATE, AND FEDERAL REGULATIONS AND GUIDELINES.

# REFUSE/RECYCLING NOTES

1. ANY GATE DESIGN WILL INCLUDE GATE RETAINERS.

SERVICE UNTIL THE NEXT SCHEDULED COLLECTION DAY.


2. THE USER WILL BE RESPONSIBLE FOR OPENING GATES TO THE DUMPSTER AREA ON COLLECTION DAYS OF ANY MATERIAL(S) TO BE COLLECTED FROM

. BY ORANGE COUNTY ORDINANCE, CLEAN WOOD WASTE, SCRAP METAL AND CORRUGATED CARDBOARD, ALL PRESENT IN CONSTRUCTION WASTE, MUST

4. BY ORANGE COUNTY ORDINANCE, ALL HAULERS OF CONSTRUCTION WASTE MUST BE PROPERLY LICENSED. 5. IF ANY VEHICLES ARE PARKED IN THE REFUSE OR RECYCLABLES COLLECTION VEHICLE ACCESS AREA, THE CONTAINERS WILL NOT RECEIVE

6. PRIOR TO ANY DEMOLITION OR CONSTRUCTION ACTIVITY ON THE SITE, THE APPLICANT WILL HOLD DECONSTRUCTION ASSESSMENT CONFERENCE SPECIFICALLY CONCERNING THE BUILDINGS TO BE REMOVED FROM THE SITE AND A GENERAL PRE-DEMOLITION / PRE-CONSTRUCTION CONFERENCE WITH THE COUNTY'S SOLID WASTE STAFF. THIS MAY BE THE SAME MEETING HELD WITH OTHER DEVELOPMENT OFFICIALS.



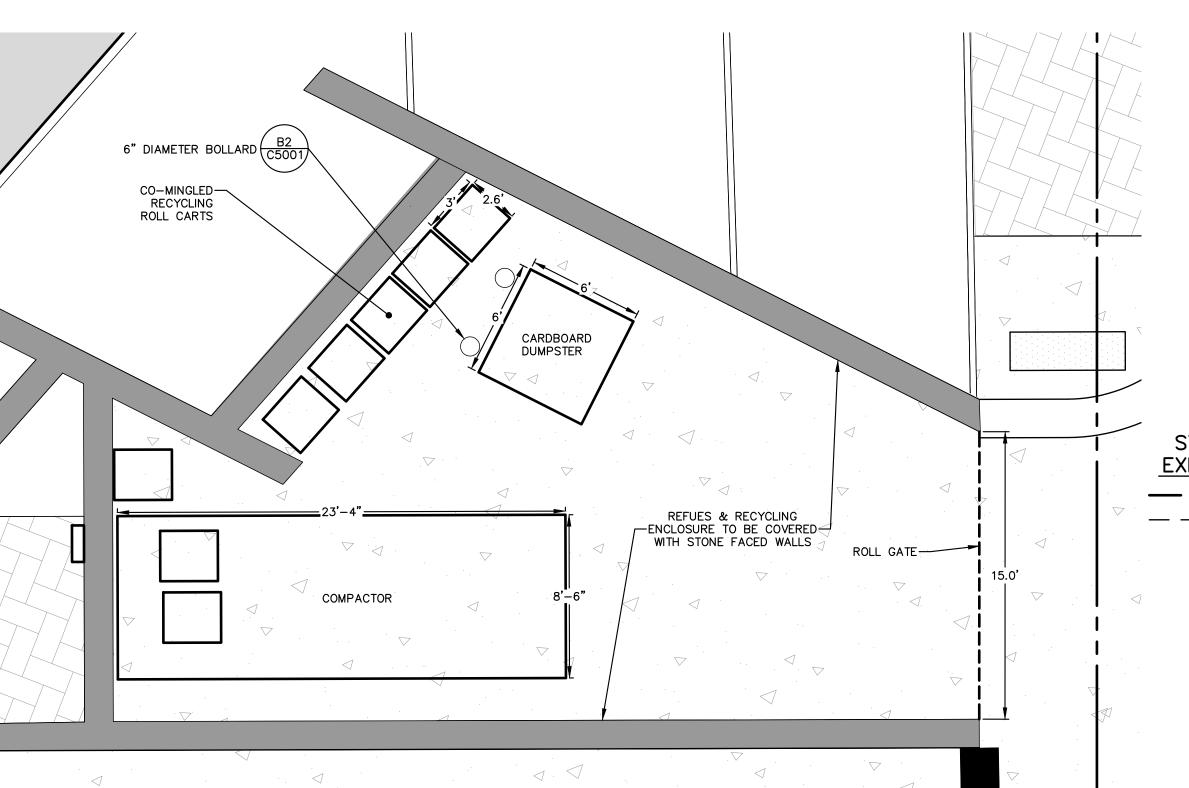

REFUSE & RECYCLING ENCLOSURE ENLARGEMENT

C1002 SCALE: 1" = 5'

SYMBOL/ABBREVIATION



**SOLID WASTE** 

( GRAPHIC SCALE IN FEET )
1 inch = 10 ft.

**REVIEW DRAWING** 

SHEET C1002

150 LA

JOB #: 118038.03

DATE: 10 FEB 21

SCALE: AS NOTED

DRAWN BY: A.A.A./S.R.H. REVIEWED BY: G.J.R.


**DRAWING LEGEND** 

DESCRIPTION



**MANAGEMENT PLAN** 

NOT FOR CONSTRUCTION

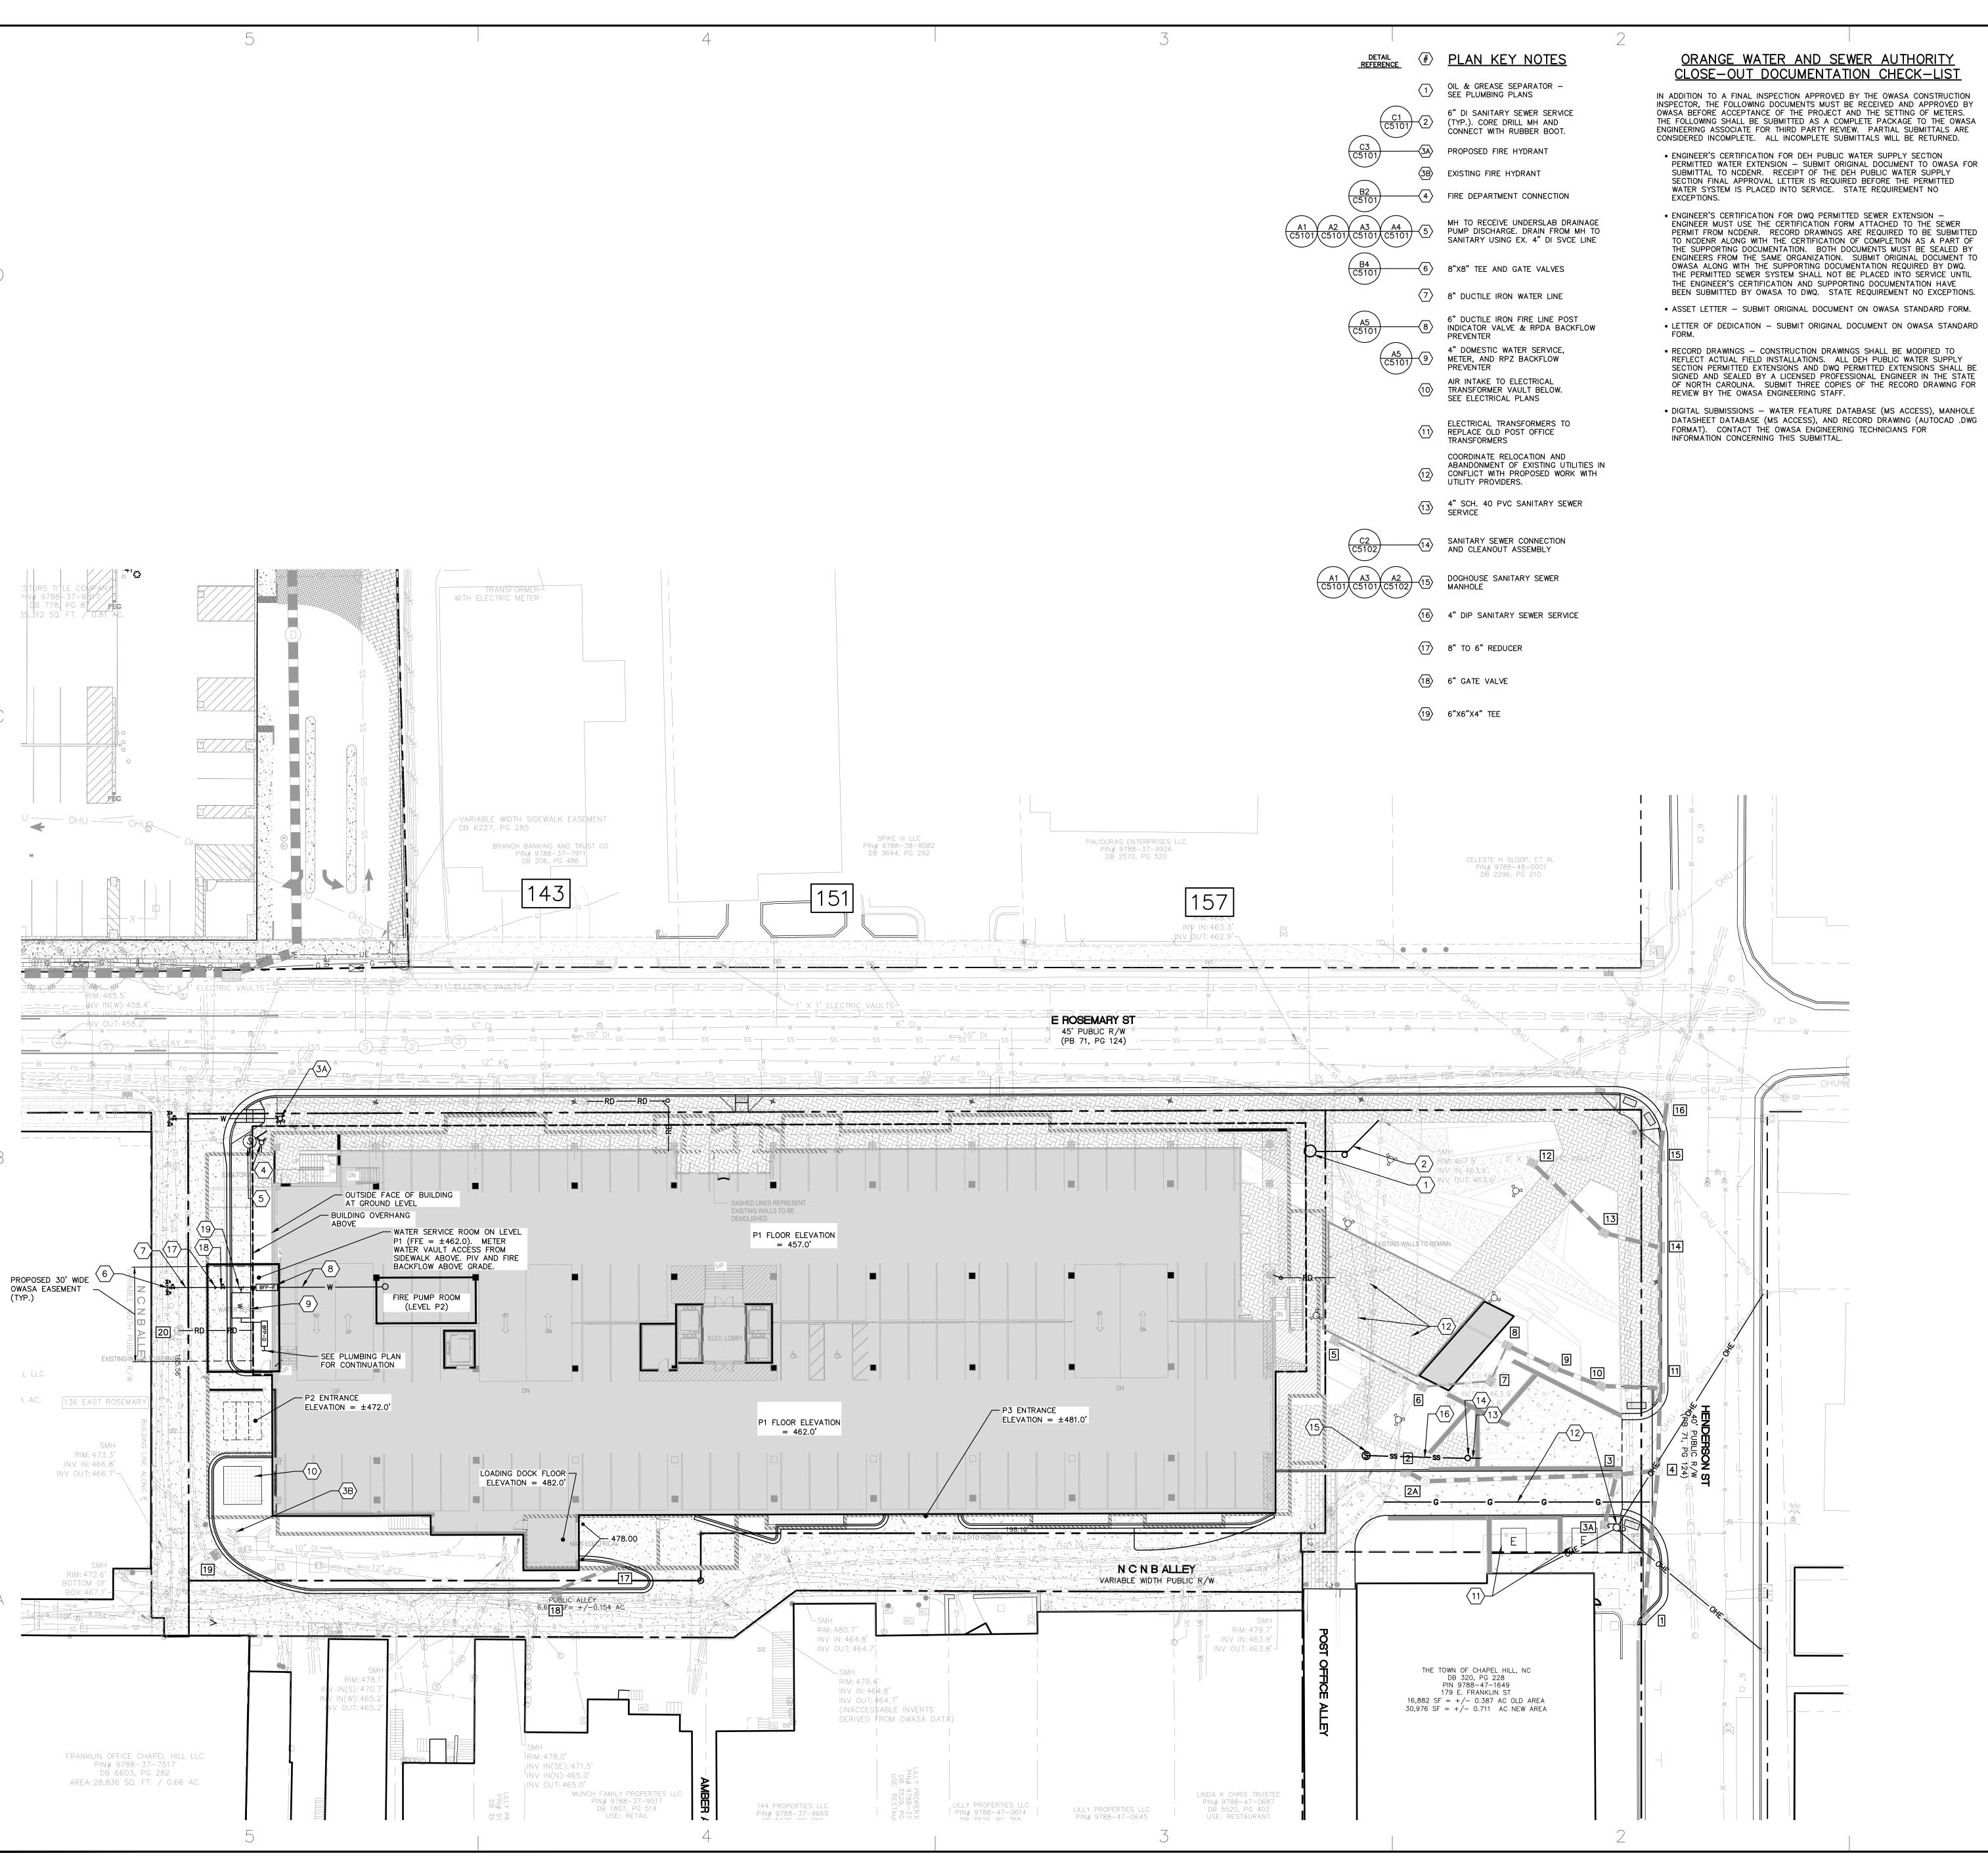

# **UTILITY PLAN NOTES**

- 1. ALL CONSTRUCTION SHALL BE IN ACCORDANCE WITH OWASA STANDARDS
- AND APPLICABLE NC PLUMBING AND FIRE CODE SECTIONS. ABOVE GROUND SUCH AS BACKFLOW PREVENTERS AND TRANSFORMERS.
- CONTRACTOR SHALL LOCATE ALL EXISTING UTILITIES (PRIVATE AND PUBLIC)
  PRIOR TO BEGINNING CONSTRUCTION AND NOTIFY THE ENGINEER OF ANY DISCREPANCIES OR CONFLICTS PRIOR TO BEGINNING CONSTRUCTION. NOT ALL UTILITIES ARE SHOWN ON THIS PLAN AND THE ONES THAT ARE SHOWN SHALL BE CONSIDERED APPROXIMATE AND MUST BE VERIFIED BY
- 3.1. NORTH CAROLINA ONE CALL: 811 OR 1-800-632-4949
- 4. CONTRACTOR SHALL PROTECT ALL EXISTING UTILITIES DURING CONSTRUCTION.
- 5. THE SITE CONTRACTOR SHALL COORDINATE WITH UTILITY COMPANIES AND INSTALL ALL REQUIRED CONDUITS (NUMBER AND LOCATION).

6. THE SITE CONTRACTOR SHALL COORDINATE AND REVIEW SEWER MANHOLE RIM

- ADJUSTMENTS WITH OWASA INSPECTOR PRIOR TO FINAL LIFT OF ASPHALT. 7. A MINIMUM OF 10' HORIZONTAL SEPARATION SHALL BE PROVIDED BETWEEN
- SANITARY AND STORM SEWERS. 8. WATER & SEWER:
- 8.1. OWASA: NICK PARKER (919) 537-4201
- 8.2. MINIMUM UTILITY VERTICAL SEPARATION DISTANCES: SANITARY SEWER MAINS AND STORM SEWER - 24" SANITARY SEWER MAINS AND WATER - 18" STORM SEWER AND WATER - 18"
- 8.3. SANITARY SEWER SERVICE LINE WITHIN OWASA EASEMENTS SHALL BE DIP.
- 9. GAS: BRIAN SMITH WITH PSNC ENERGY (919) 598-7454
- 10. ELECTRICAL: CHRISTIAN HERNANDEZ (984) 209-9387)
- 11. TELECOM: SPECTRUM: GEORGE STOTLER (919) 427-5506

# **DRAWING LEGEND**

# SYMBOL/ABBREVIATION

3 IMBOL/AB	BREVIATION	
<b>EXISTING</b>	PROPOSED	DESCRIPTION
 		PROPERTY LINE
		RIGHT-OF-WAY LINE
		ADJOINER PROPERTY LINE
		EASEMENT LINE
X	X	FENCE LINE
—— SD —— SD ——		STORM DRAIN LINE
W	w	WATER LINE
SS	——ss ——	SANITARY SEWER LINE
UE	UE	UNDERGROUND ELECTRIC LINE
OHE	—— OHE ——	OVERHEAD ELECTRIC LINE
G	G	GAS LINE
T	T	TELEPHONE LINE
——— FO ———	——F0——	FIBER OPTIC LINE
~~~~~	~~~~~	TREE LINE
		RETAINING WALL
•		EXISTING IRON PIPE
		SIGN
M		MAIL BOX
•		BOLLARD
•		BORE HOLE
		CATCH BASIN
		DROP INLET
		JUNCTION BOY

WATER VALVE FIRE HYDRANT FIRE DEPARTMENT CONNECTION BACKFLOW PREVENTER BLOW OFF VALVE 45° - BEND PIPE 90° - BEND PIPE TEE - BEND PIPE


SANITARY SEWER MANHOLE SANITARY SEWER CLEANOUT

POWER POLE LIGHT POLE ELECTRIC BOX ELECTRIC TRANSFORMER

HVAC UNIT GAS METER TELEPHONE PEDESTAL

TELEPHONE VAULT TELEPHONE MANHOLE

# **UTILITY PLAN**

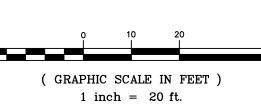

**REVIEW DRAWING** 

C1101 NOT FOR CONSTRUCTION

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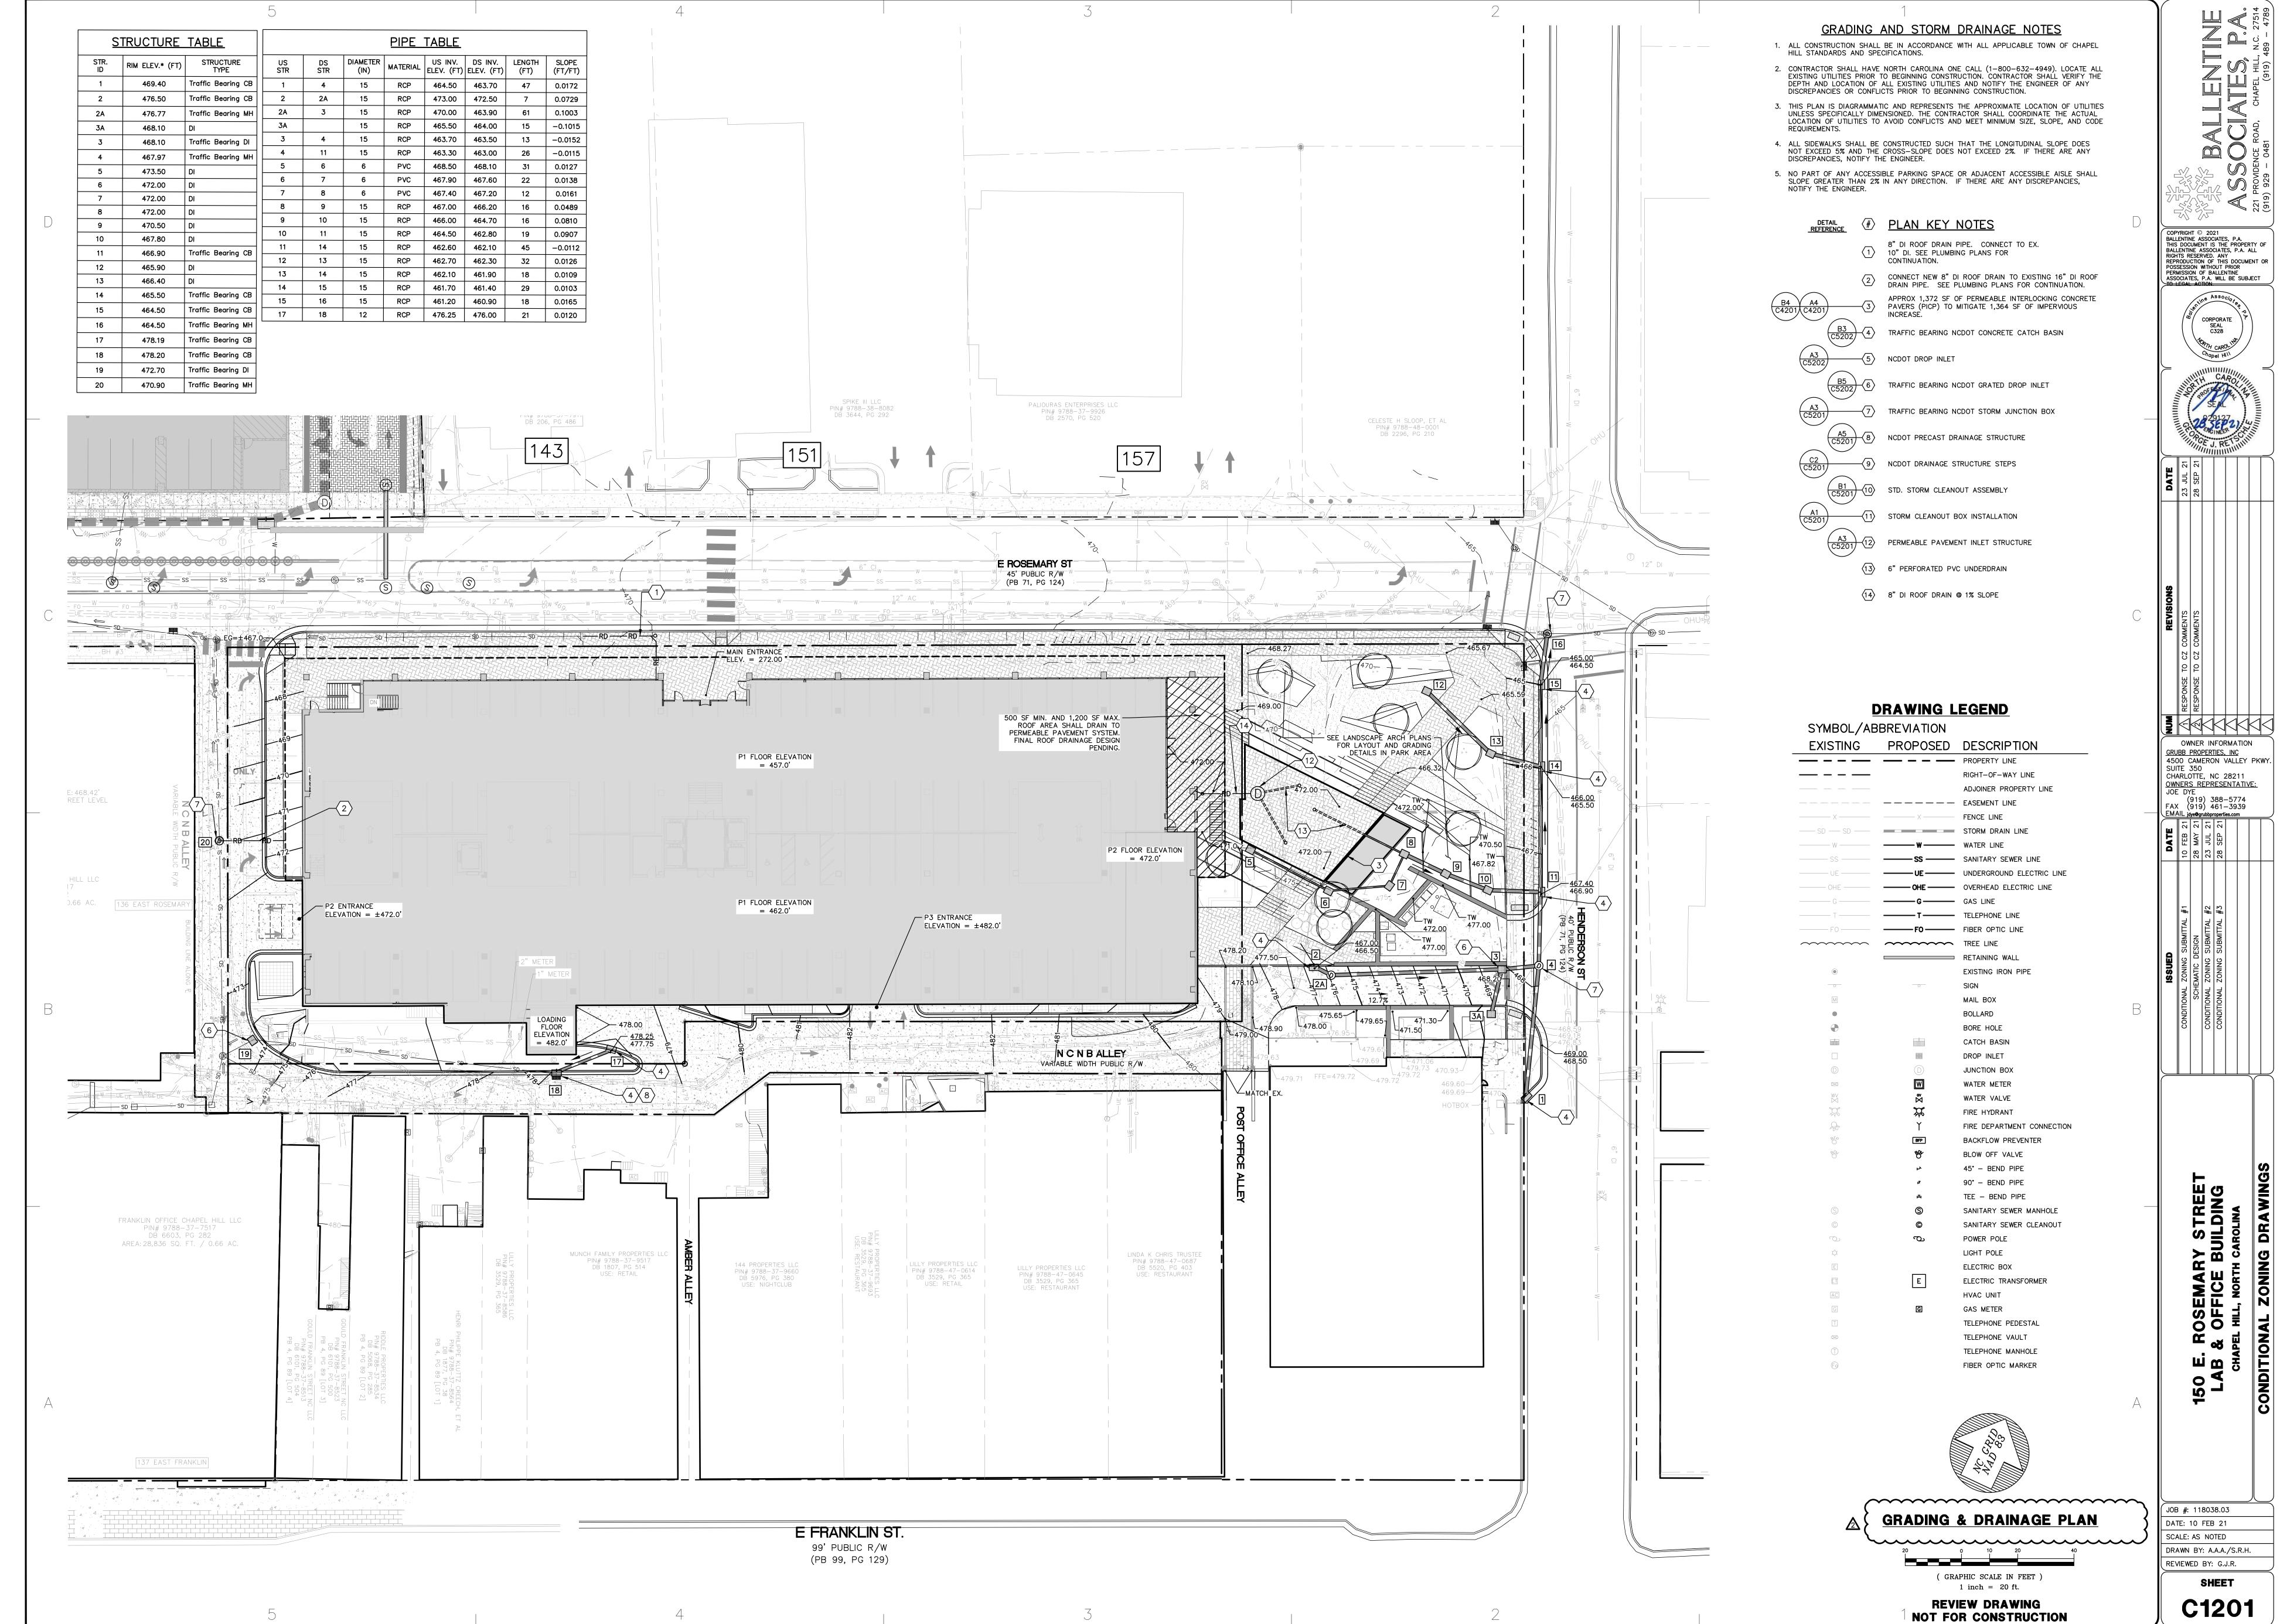
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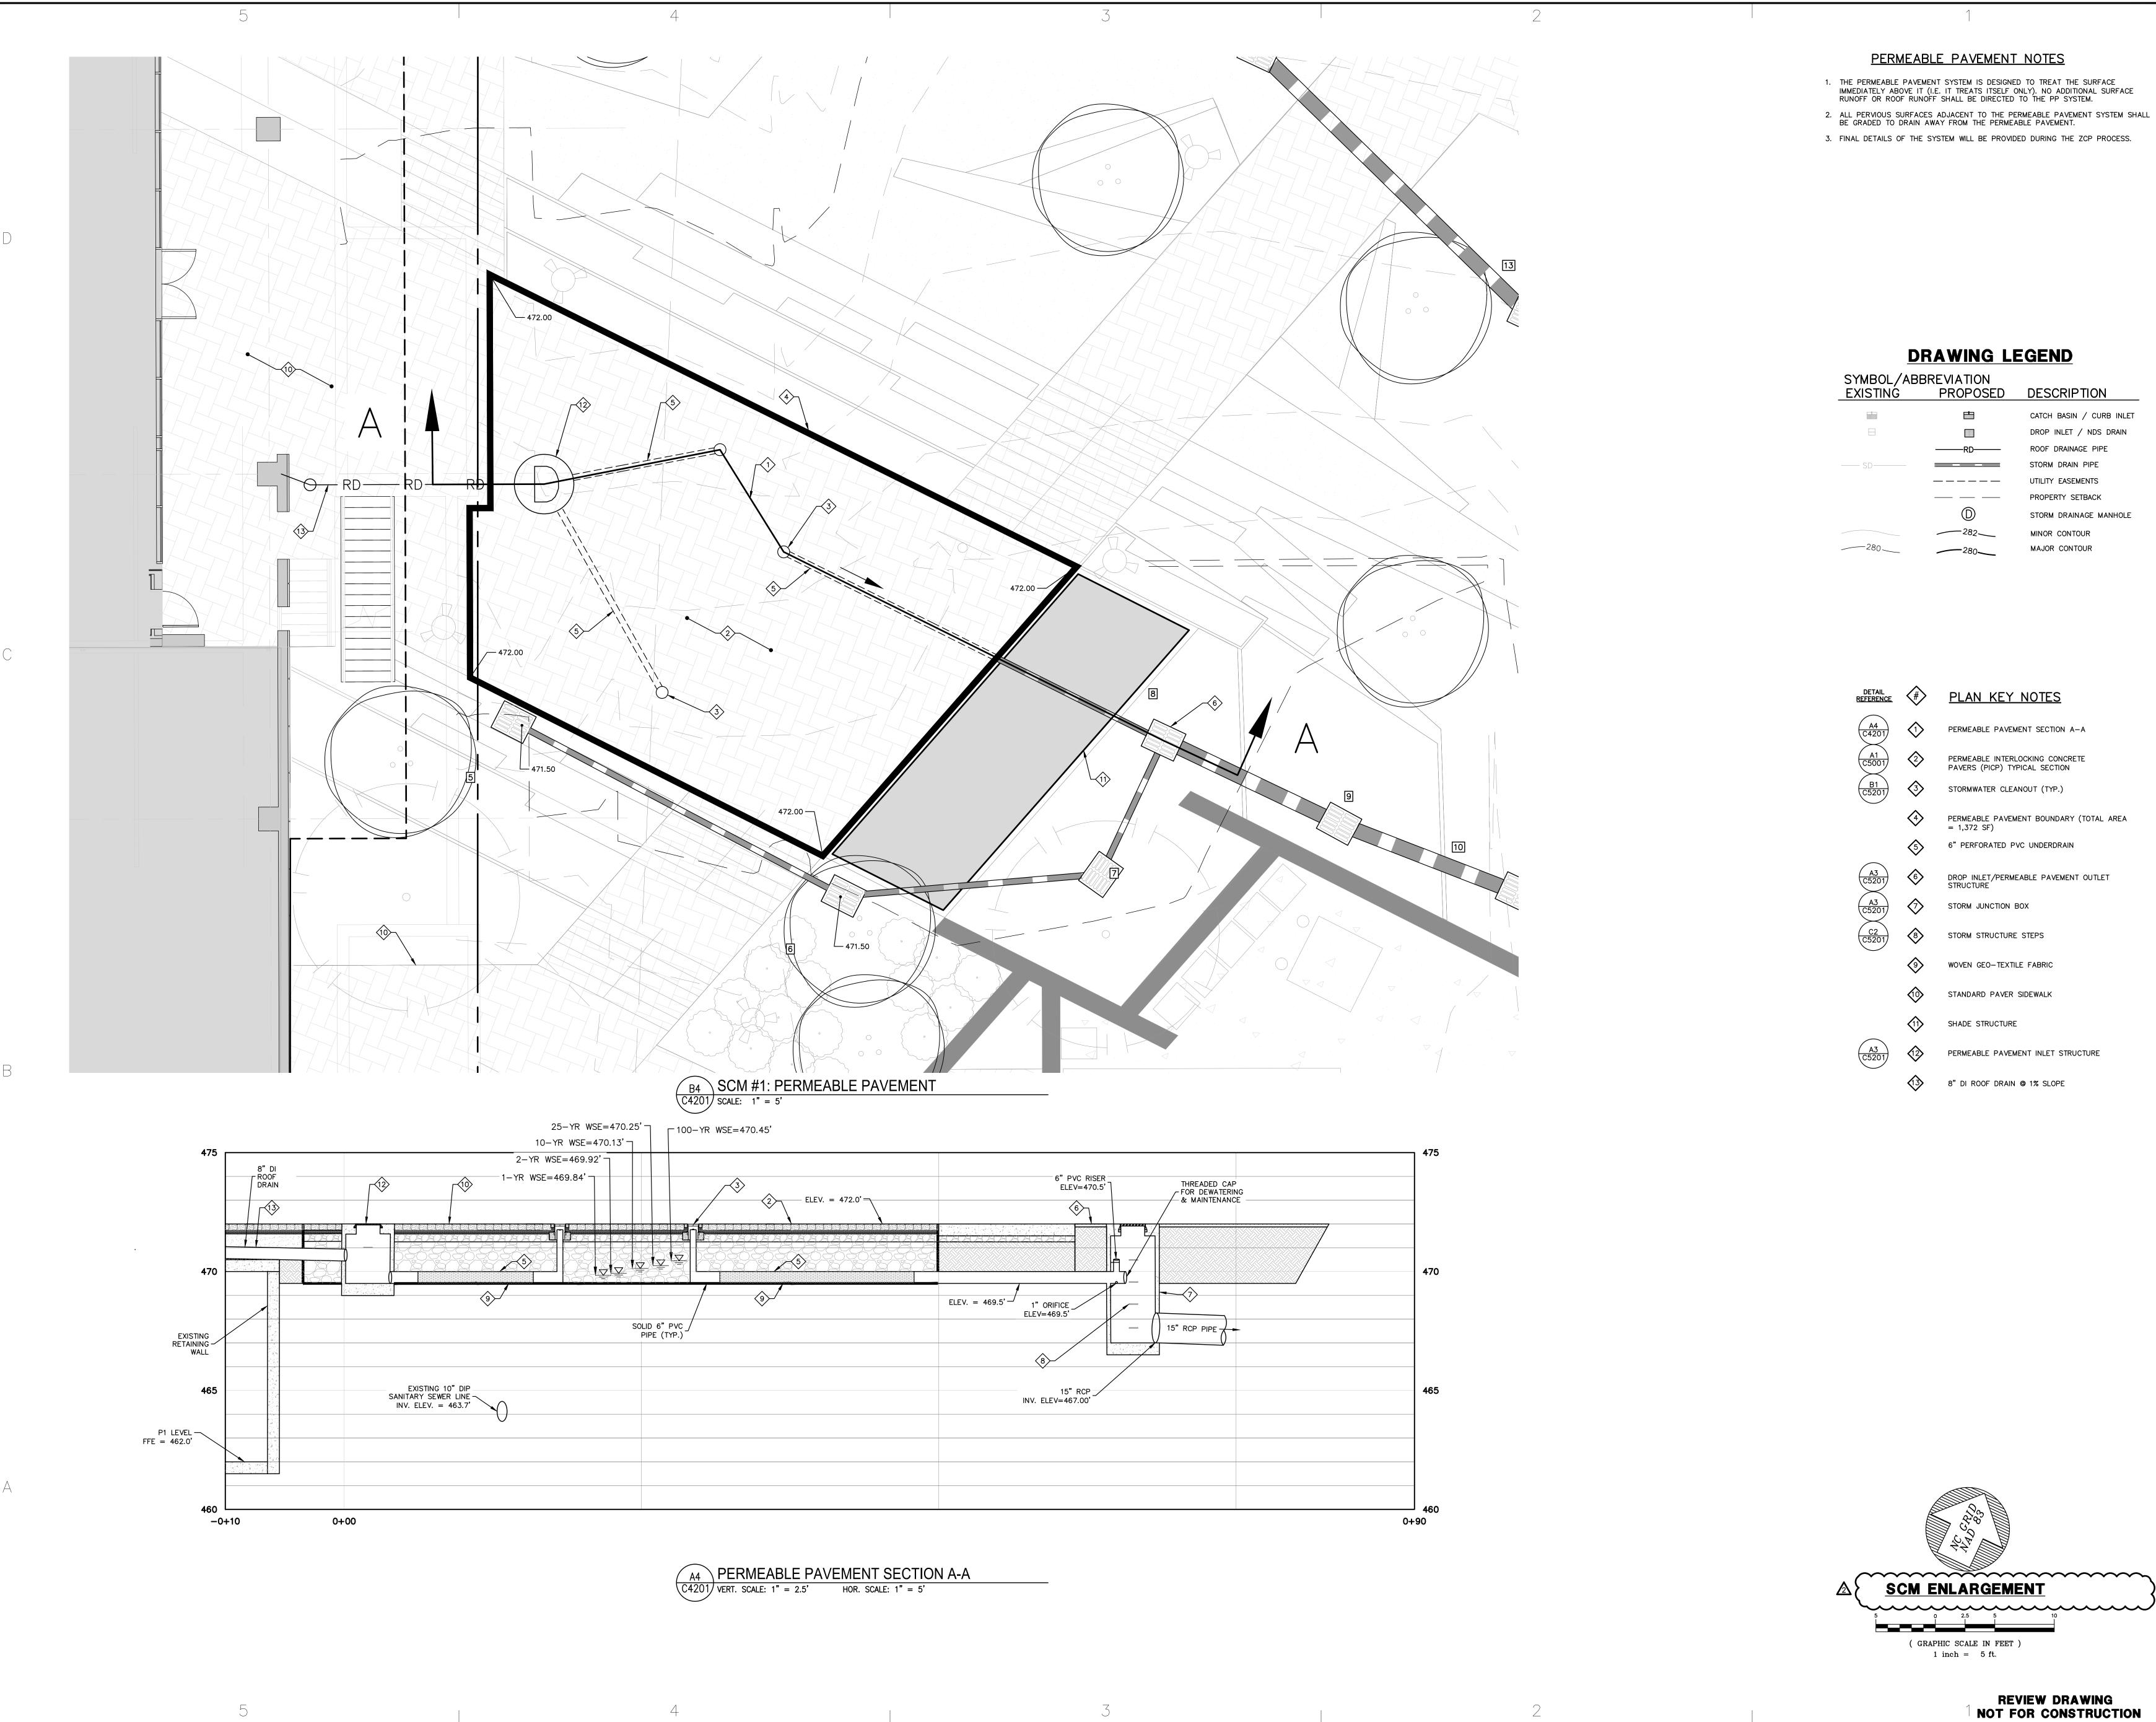
GRUBB PROPERTIES, INC 4500 CAMERON VALLEY PKWY. SUITE 350 CHARLOTTE, NC 28211 OWNERS REPRESENTATIVE: (919) 388-5774 FAX (919) 461-3939

JOB #: 118038.03 DATE: 10 FEB 21 SCALE: AS NOTED

DRAWN BY: A.A.A./S.R.H. REVIEWED BY: G.J.R. SHEET



C1201



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SUITE 350
CHARLOTTE, NC 28211
OWNERS REPRESENTATIVE: JOE DYE (919) 388-5774
FAX (919) 461-3939
EMAIL jdye@grubbproperties.com


#2 #2

150 LA

JOB #: 118038.03 DATE: 10 FEB 21 SCALE: AS NOTED DRAWN BY: A.A.A./S.R.H.

REVIEWED BY: G.J.R. SHEET

C4201

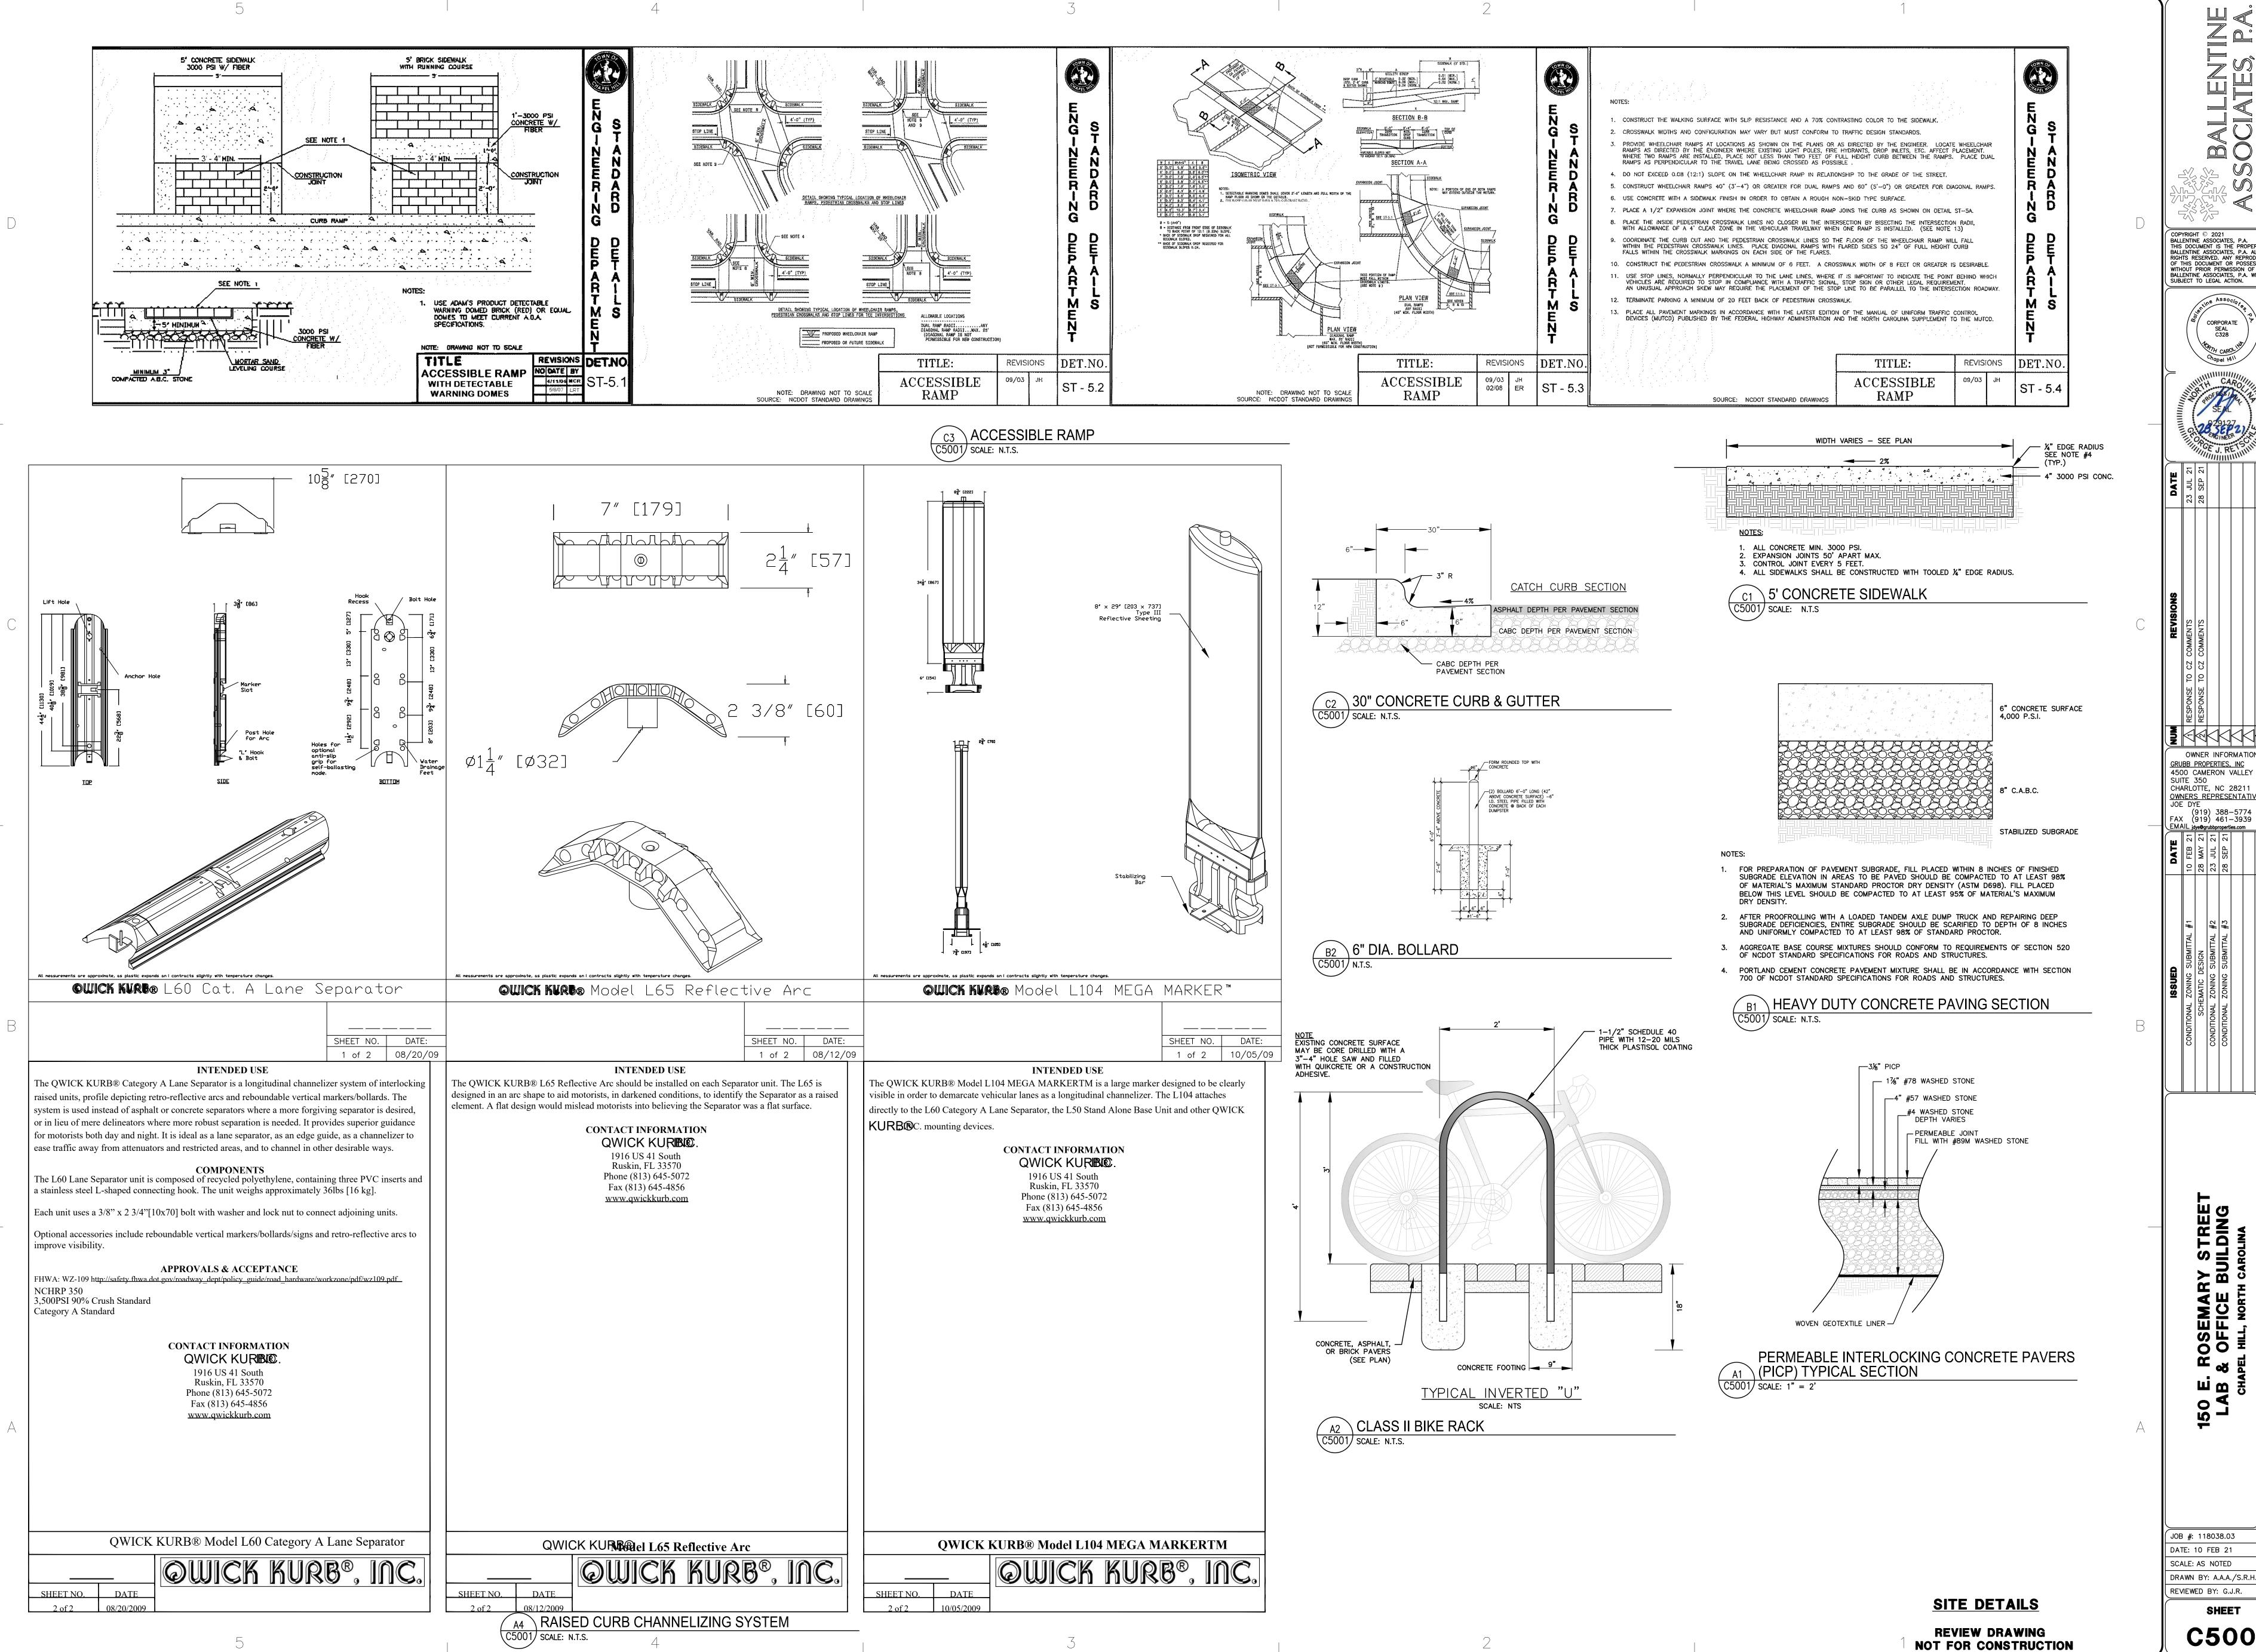

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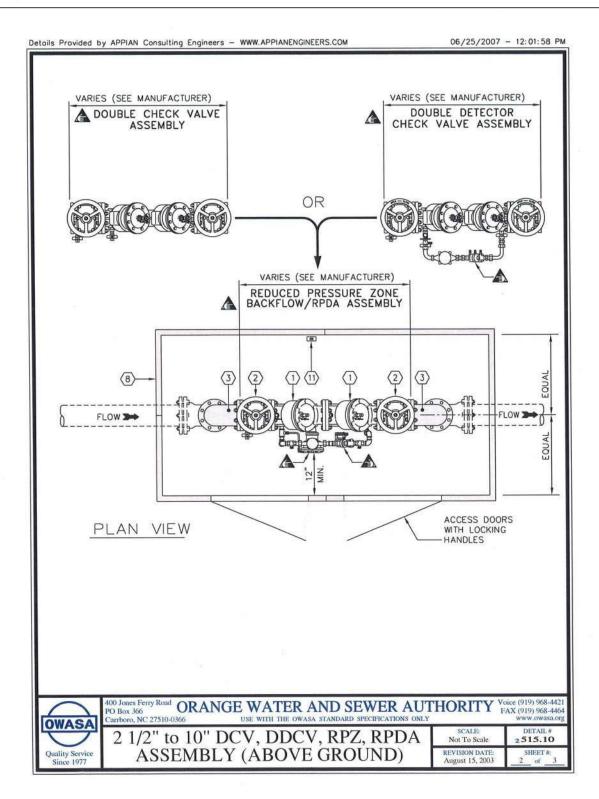
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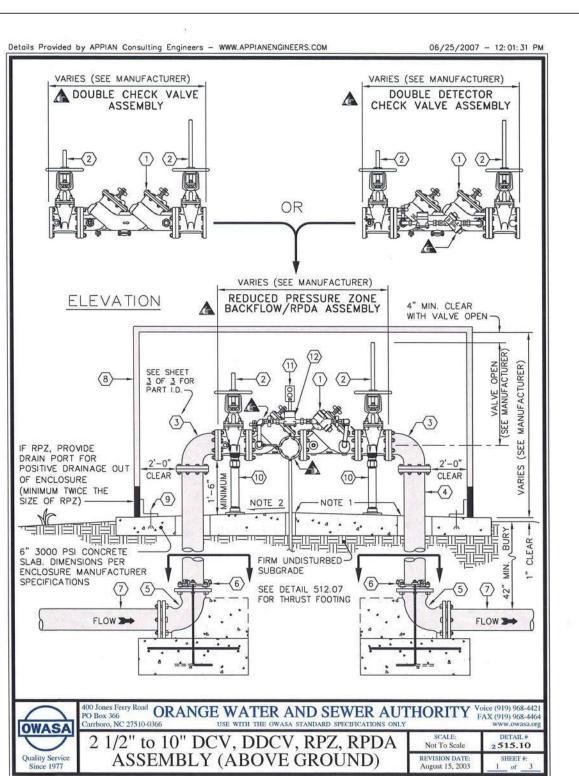
(919) 388-5774 FAX (919) 461-3939


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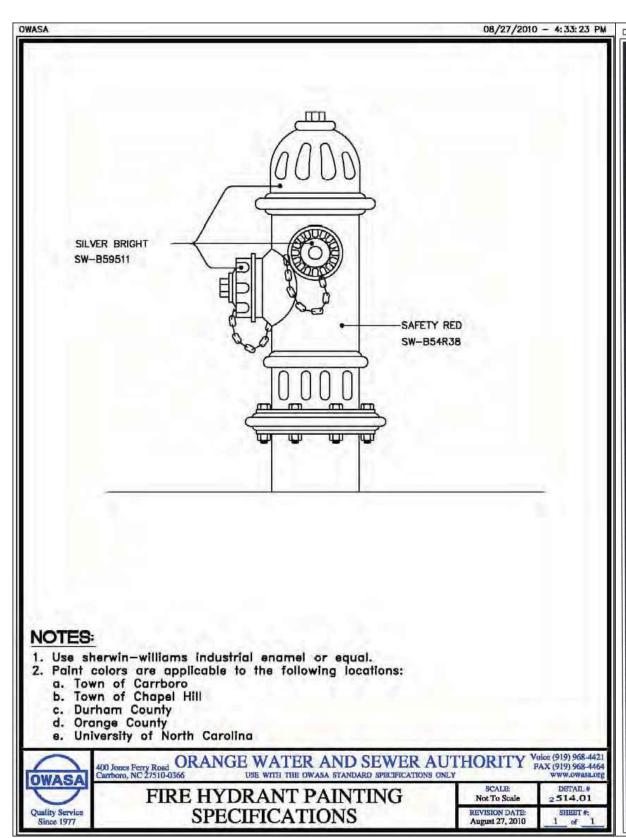
NOT FOR CONSTRUCTION


SHEET C5001








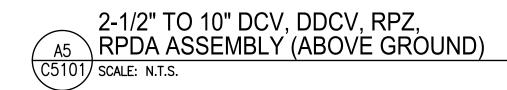


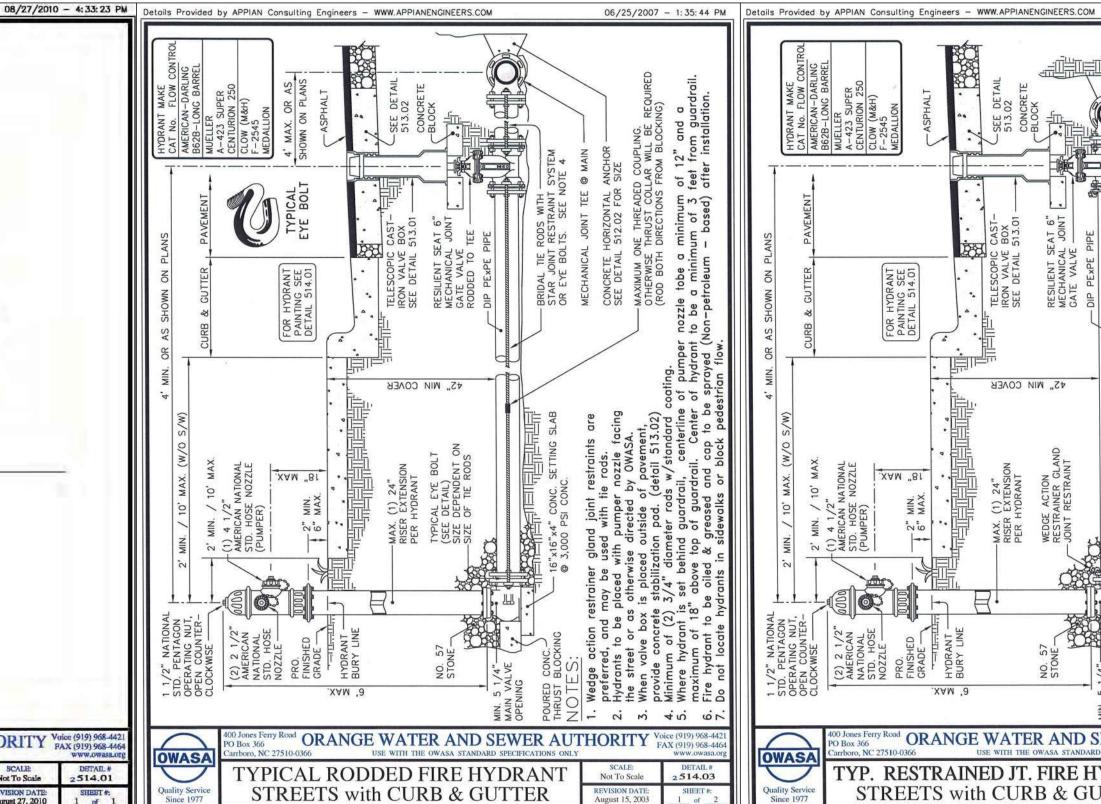


FIRE HYDRANT

(C5101/ SCALE: N.T.S.

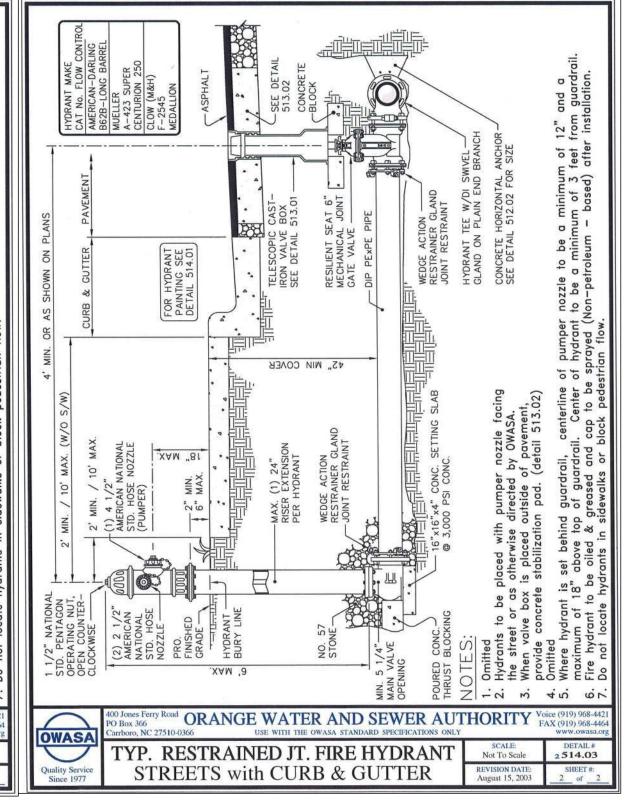

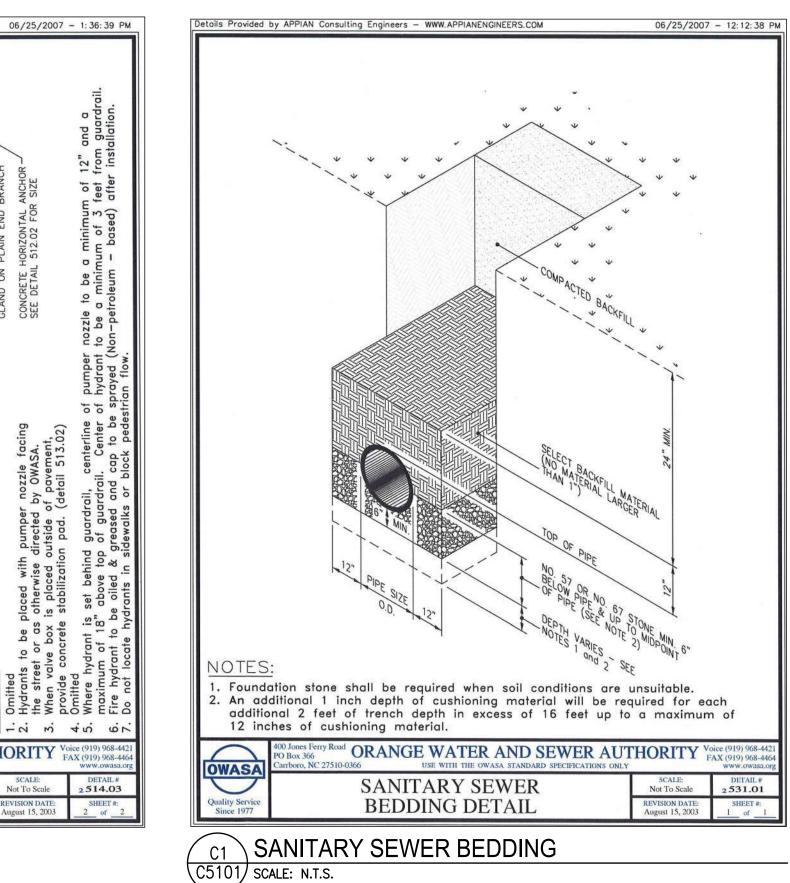



Details Provided by APPIAN Consulting Engineers - WWW.APPIANENGINEERS.COM 06/25/2007 - 11:21:54 AM PLAN VIEW JNDISTURBED EARTH -CONCRETE BLOCKING VALVE BOX STABILIZING PAD VALVE BOX DETAIL SEE DETAIL 513.01 -- BACKFILLED EARTH FLANGE FITTING ----CONCRETE BRICK -GATE VALVE RESTRAINER GLAND JOIN RESTRAINT REQUIRED IN HIGH PRESSURE AREAS -UNDISTURBED EARTH CONCRETE BRICK BLOCKIN SECTION A-A POUR 3000 PSI CONCRETE BLOCKING - AND FOOTING UNDER ASSEMBLY AS SHOWN . Concrete blocking is to be formed to ensure accesibility to fittings and poured against undisturbed earth. . Fittings are to be completely wrapped with plastic, prior to pouring concrete. Concrete to be minimum 3,000 psi. © 28 days. Taps onto in-service mains by OWASA personnel only. ORANGE WATER AND SEWER AUTHORITY FA 4" to 12" STANDARD TAPPING SLEEVE and VALVE ASSEMBLY

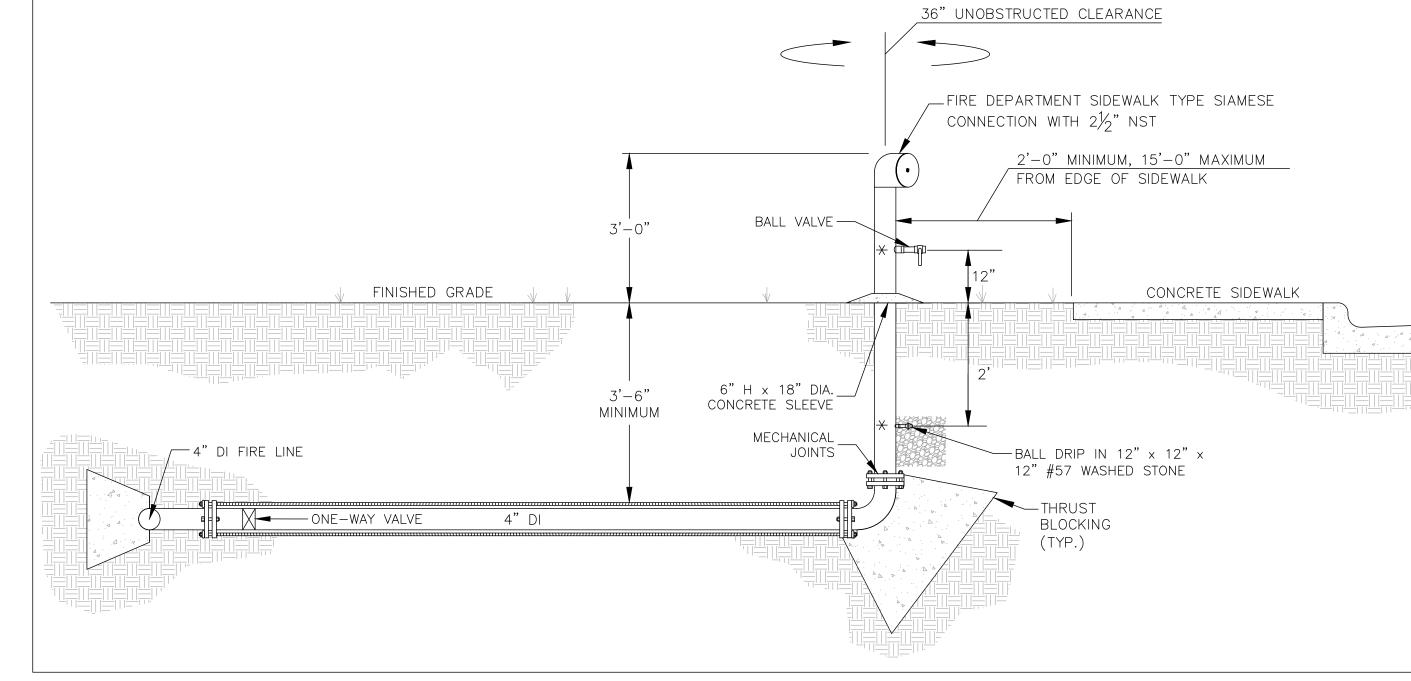







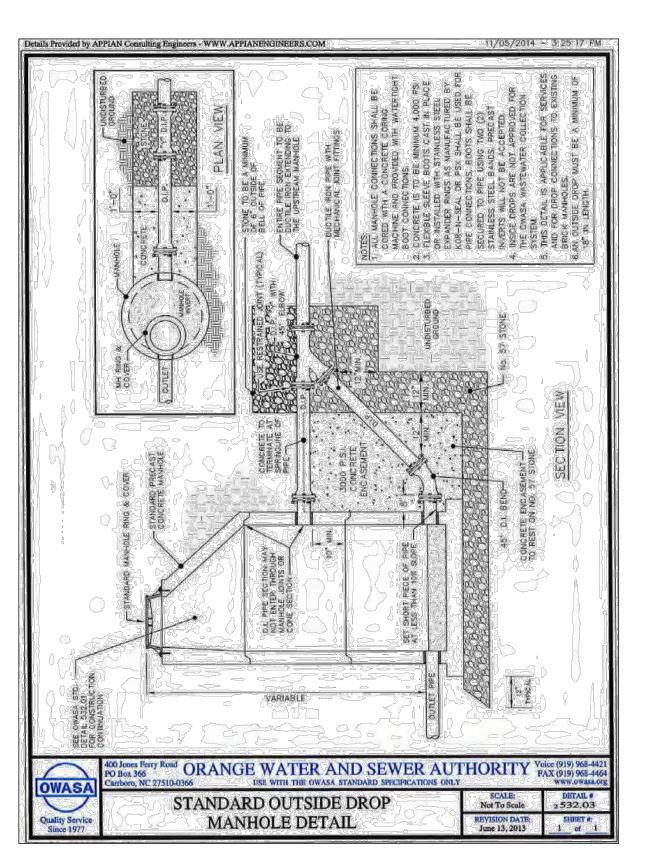

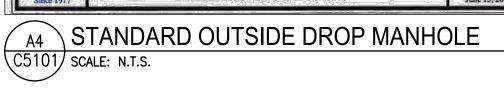


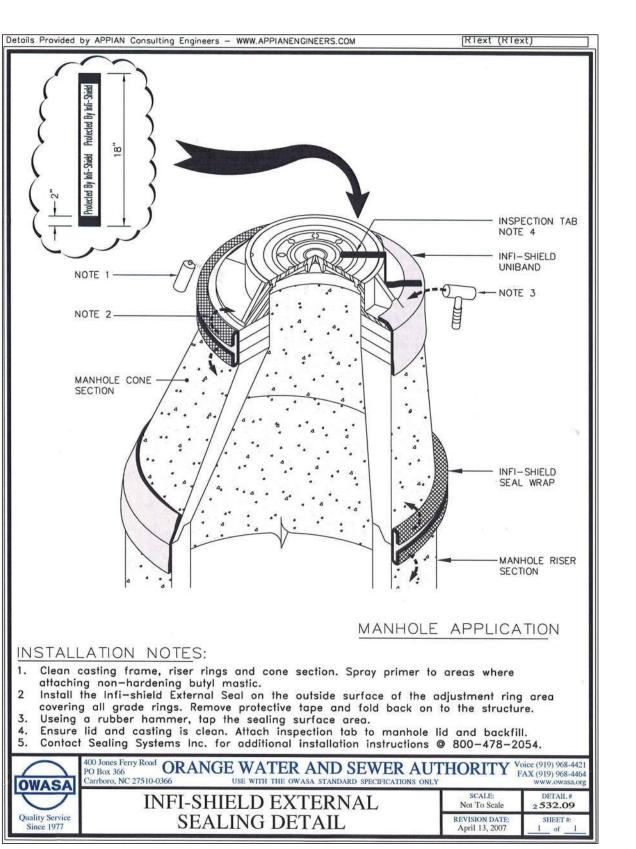



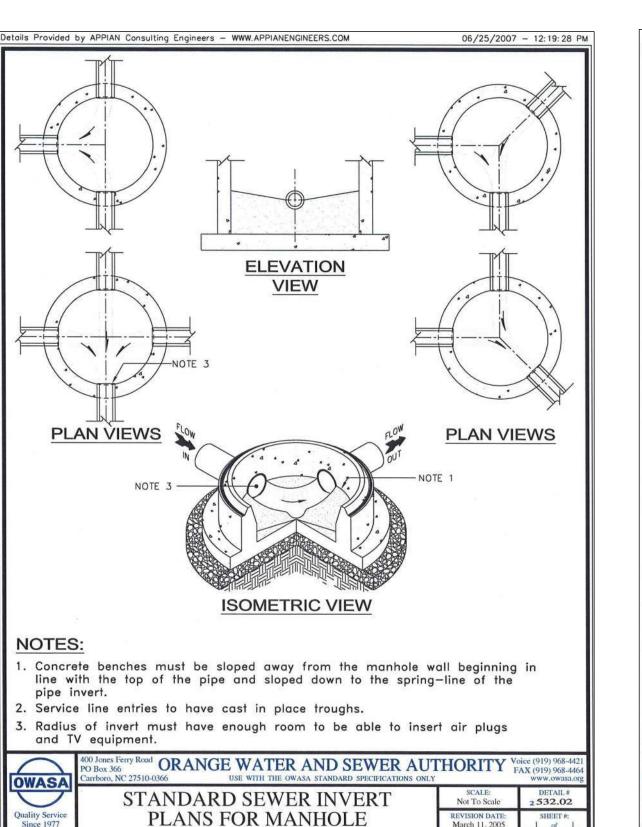

A2	SAN. SEWER MANHOLE INVERT
C5101	SCALE: N.T.S.

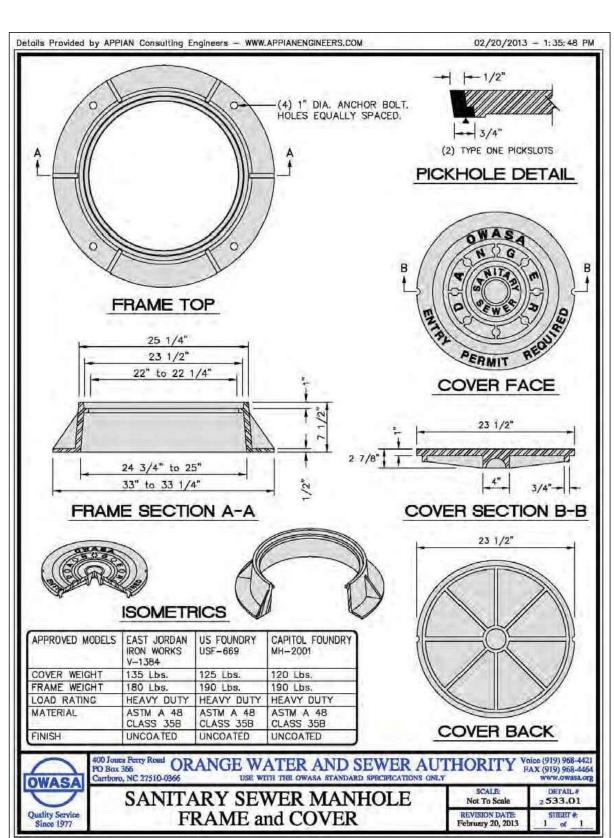

A1 SAN. SEWER MANHOLE COVER (C5101) SCALE: N.T.S.

NO PARKING IN

FRONT OF FDC.

DRIVE AISLE

OWNER INFORMATION GRUBB PROPERTIES, INC 4500 CAMERON VALLEY PKWY. SUITE 350 CHARLOTTE, NC 28211 OWNERS REPRESENTATIVE: (919) 388-5774 FAX (919) 461-3939 #1

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**UTILITY DETAILS REVIEW DRAWING NOT FOR CONSTRUCTION** 

SHEET C5101

150 LA

JOB #: 118038.03


DATE: 10 FEB 21


SCALE: AS NOTED

DRAWN BY: A.A.A./S.R.H.

REVIEWED BY: G.J.R.



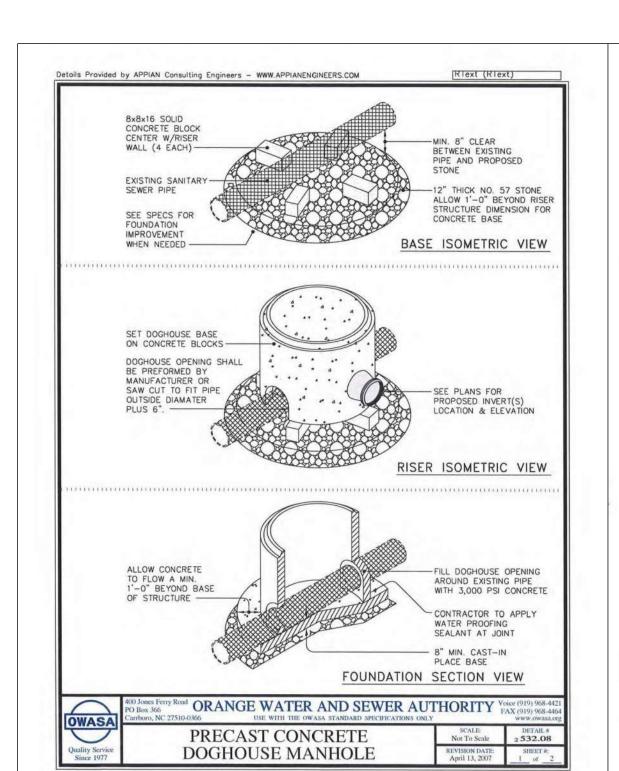

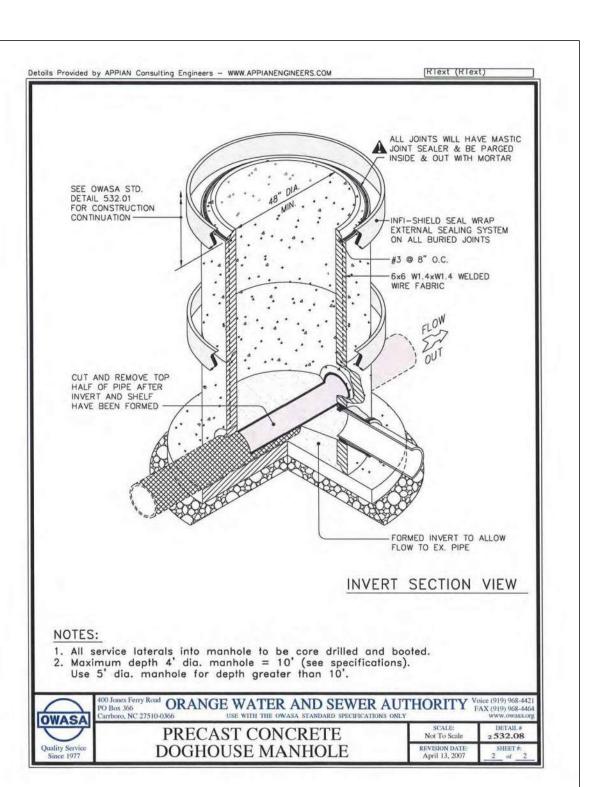

PRECAST CONCRETE DOGHOUSE MANHOLE
C5102 SCALE: N.T.S.

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Chapel Hill

150 LA

#2 #3

∫ JOB #: 118038.03 DATE: 10 FEB 21 SCALE: AS NOTED DRAWN BY: A.A.A./S.R.H.

REVIEWED BY: G.J.R. SHEET

C5102

NOTES:
INSTALL ALL STEPS PROTRUDING 4" FROM INSIDE FACE OF STRUCTURE WALL.
STEPS DIFFERING IN DIMENSIONS, CONFIGURATION, OR MATERIALS FROM THOSE SHOWN MAY ALSO BE USED PROVIDED THE CONTRACTOR HAS FURNISHED THE ENGINEER WITH DETAILS OF THE PROPOSED STEPS AND HAS RECEIVED WRITTEN APPROVAL FROM THE ENGINEER FOR THE USE OF SUCH STEPS.

CAST IRON

SECTION A-A

STORM CLEANOUT A1
BOX INSTALLATION C5201

FINISHED GRADE —

C2 NCDOT DRAINAGE STUCTURE STEPS C5201) SCALE: N.T.S.

CLEANOUT ASSEMBLY IN PAVEMENT AND GRASS

C5201 SCALE N.T.S.

PERMEABLE PAVEMENT

C5201 SCALE: N.T.S.

CLEANOUT BOX

WITH PAVEMENT

MANUFACTURER

SPECIFICATIONS

A1 STORM CLEANOUT BOX INSTALLATION

GRAY IRON ASTM — A48 CLASS 35B W/

BITUMEN COATING.

US FOUNDARY 7610

(OR APPROVED EQUAL)

3000 PSI CONC.

PERMEABLE -

— RING & FC COVER

INDICATE "STORM"

**ELEVATION** 

1412"

**ELEVATION** 

**ELEVATION** 

\_\_\_ SET C.O. IN STD. STORM CLEANOUT BOX

W/ TOP FLUSH WITH FINISHED GRADE,

PLUG 2" (MIN.) BELOW GRADE

CAST IRON

SIDE ELEVATION

NOTE: DO NOT USE IN SANITARY SEWER MANHOLES.

REINFORCING STEEL

STANDARD BRONZE CLEANOUT PLUG

CLEANOUT FERRULE WITH PLUG

STYLES ACCEPTED:

INVERTED NUT

RAISED NUT

B1 STD. STORM CLEANOUT ASSEMBLY

--#6 BAR OR #8 BAR GALV'D.

150 LA

JOB #: 118038.03 DATE: 10 FEB 21 SCALE: AS NOTED

DRAWN BY: A.A.A./S.R.H. REVIEWED BY: G.J.R. SHEET C5201

**STORM DRAINAGE DETAILS REVIEW DRAWING NOT FOR CONSTRUCTION** 

GRASS APPLICATION


STORM

**PROFILE** 

STANDARD STORM

CAP FLUSH WITH FINISHED GRADE

CLEANOUT BOX

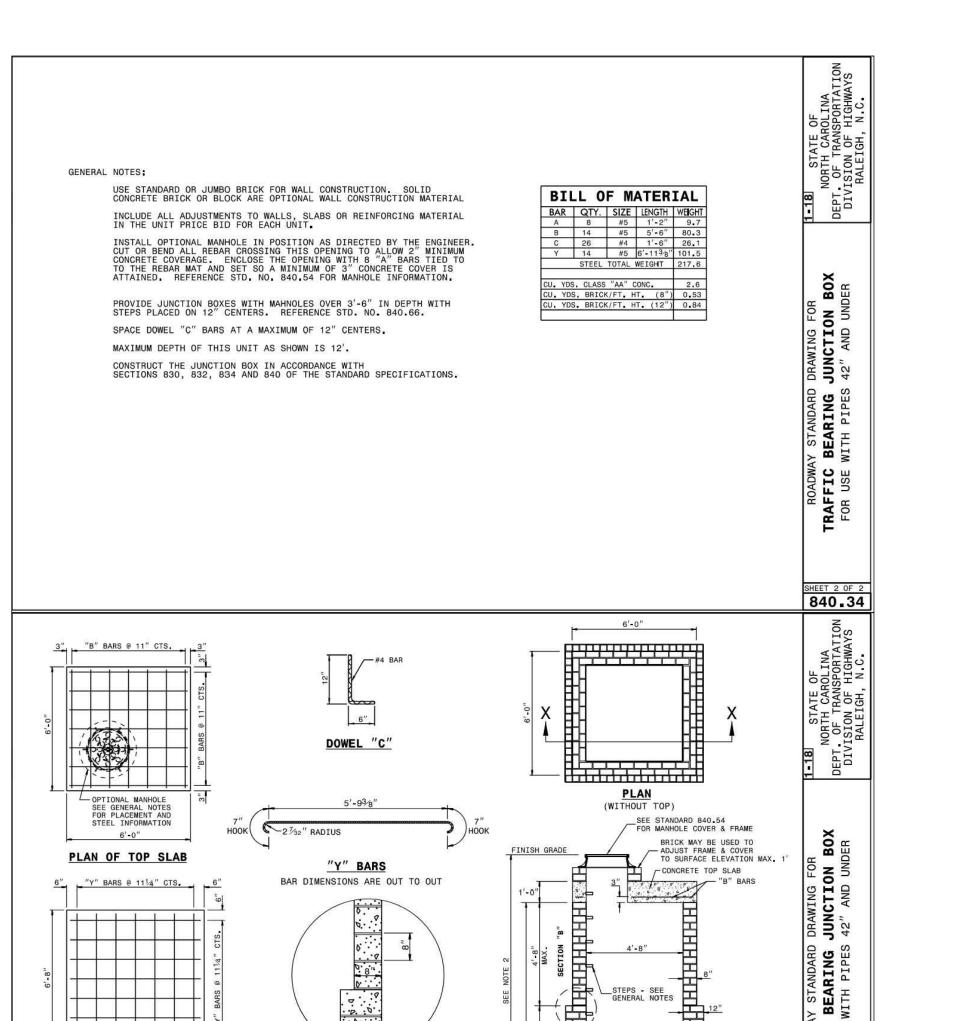

# NCDOT STD. DETAIL 840.34 (TRAFFIC BEARING JUNCTION BOX)

CONCRETE BOTTOM SLAB SECTION X-X

INSET "A"

CONCRETE BLOCK


6'-8"

PLAN OF BOTTOM SLAB


NOTE 1: CONSTRUCT SECTION "B" OF THE PROPOSED WALL 8" THICK.
AND SECTION "A" 12" THICK.

NOTE 2: IF PROPOSED STRUCTURE EXCEEDS 12'-0" VERTICAL HEIGHT A DESIGN WILL BE REQUIRED FOR APPROVAL.


NOTE 3: USE SINGLE MAT REINFORCING STEEL;
EXCEPT DOUBLE MAT STEEL MAY BE USED IN LIEU OF HOOK BARS IN BASE SLAB.

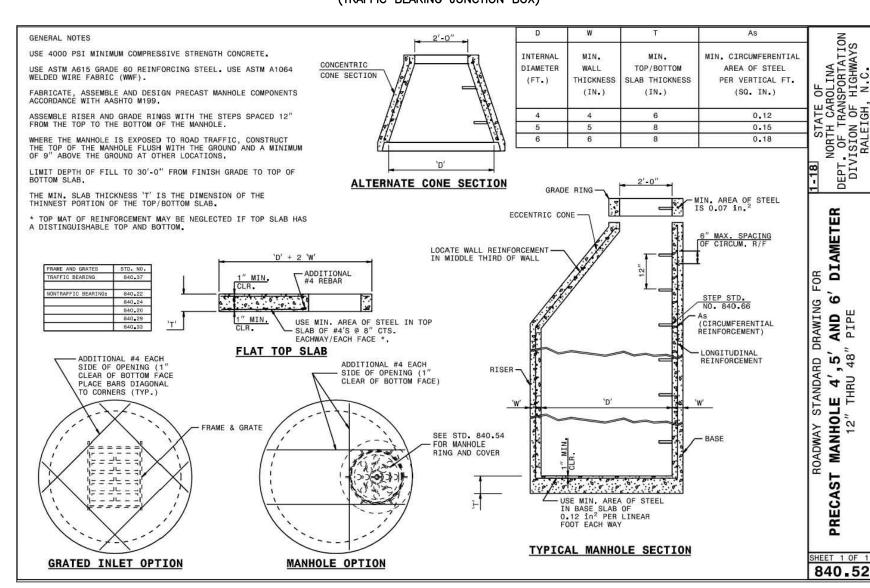


NCDOT STD. DETAIL 840.52 (PRECAST MANHOLE - 12" TO 48" PIPE)

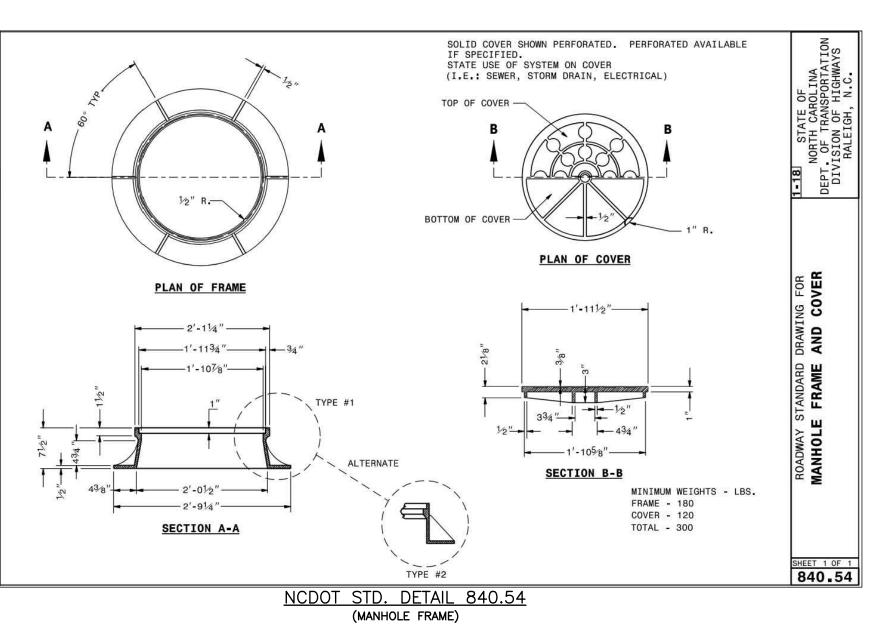

A3 TRAFFIC BEARING NCDOT STORM JUNCTION BOX C5201) SCALE: N.T.S.

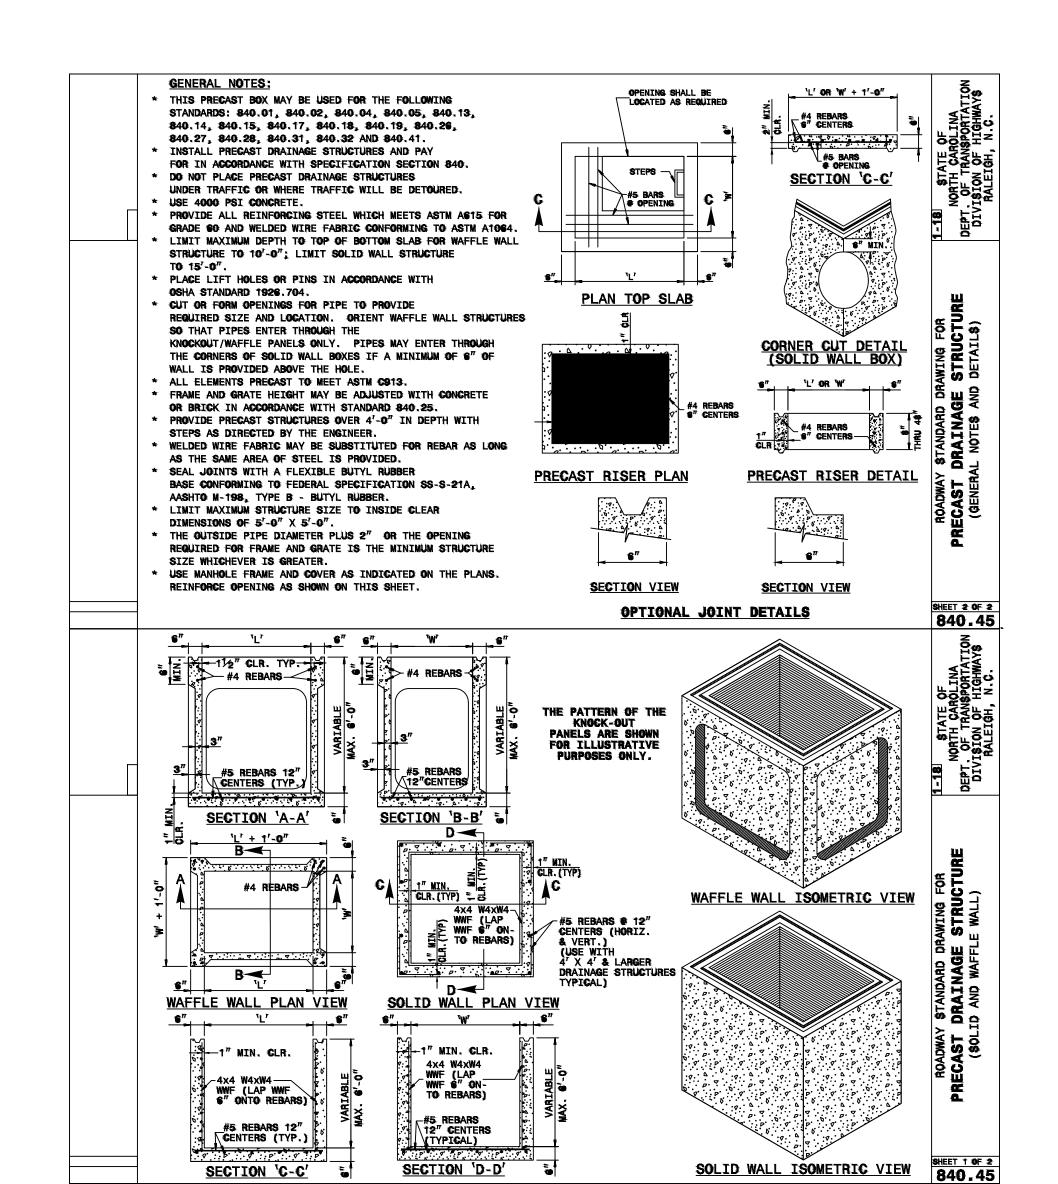



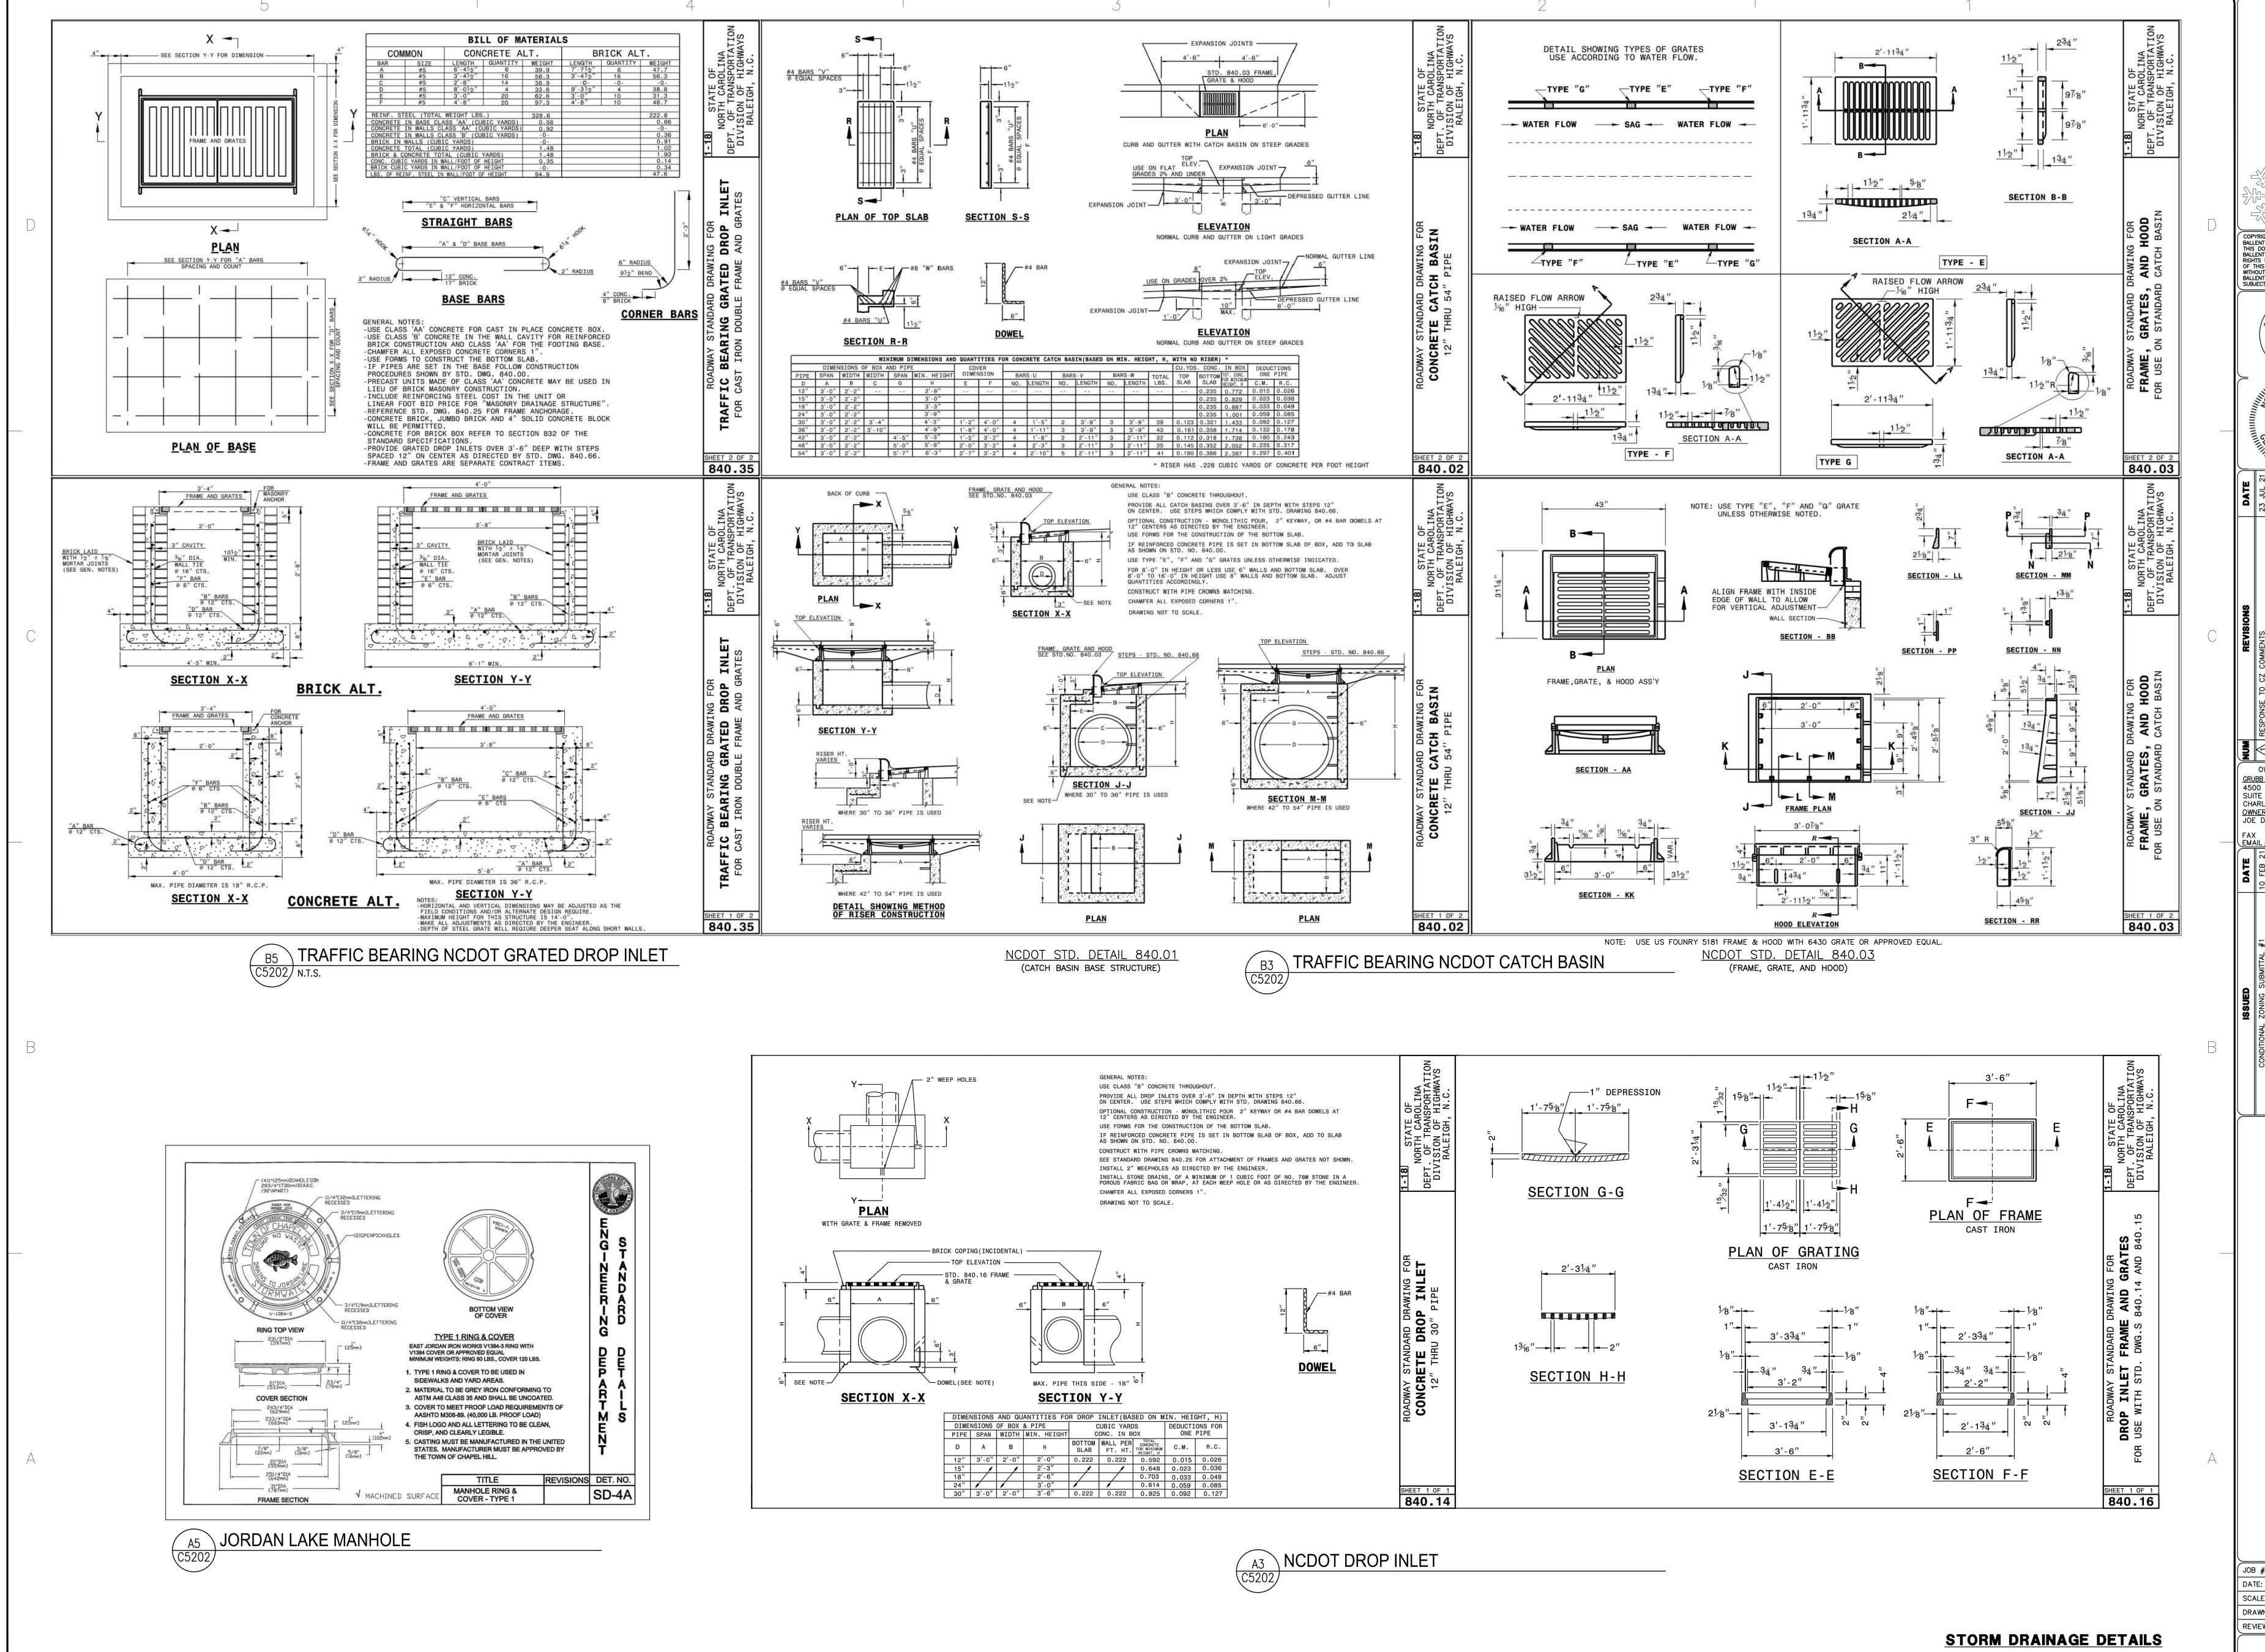

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150 LA


( JOB #: 118038.03 DATE: 10 FEB 21 SCALE: AS NOTED DRAWN BY: A.A.A./S.R.H.

REVIEWED BY: G.J.R. SHEET C5202

**REVIEW DRAWING** NOT FOR CONSTRUCTION



EASTMAN
555 Fayetteville Street
Suite 300
Raleigh, NC 27601
T. + 1 704 927 0484

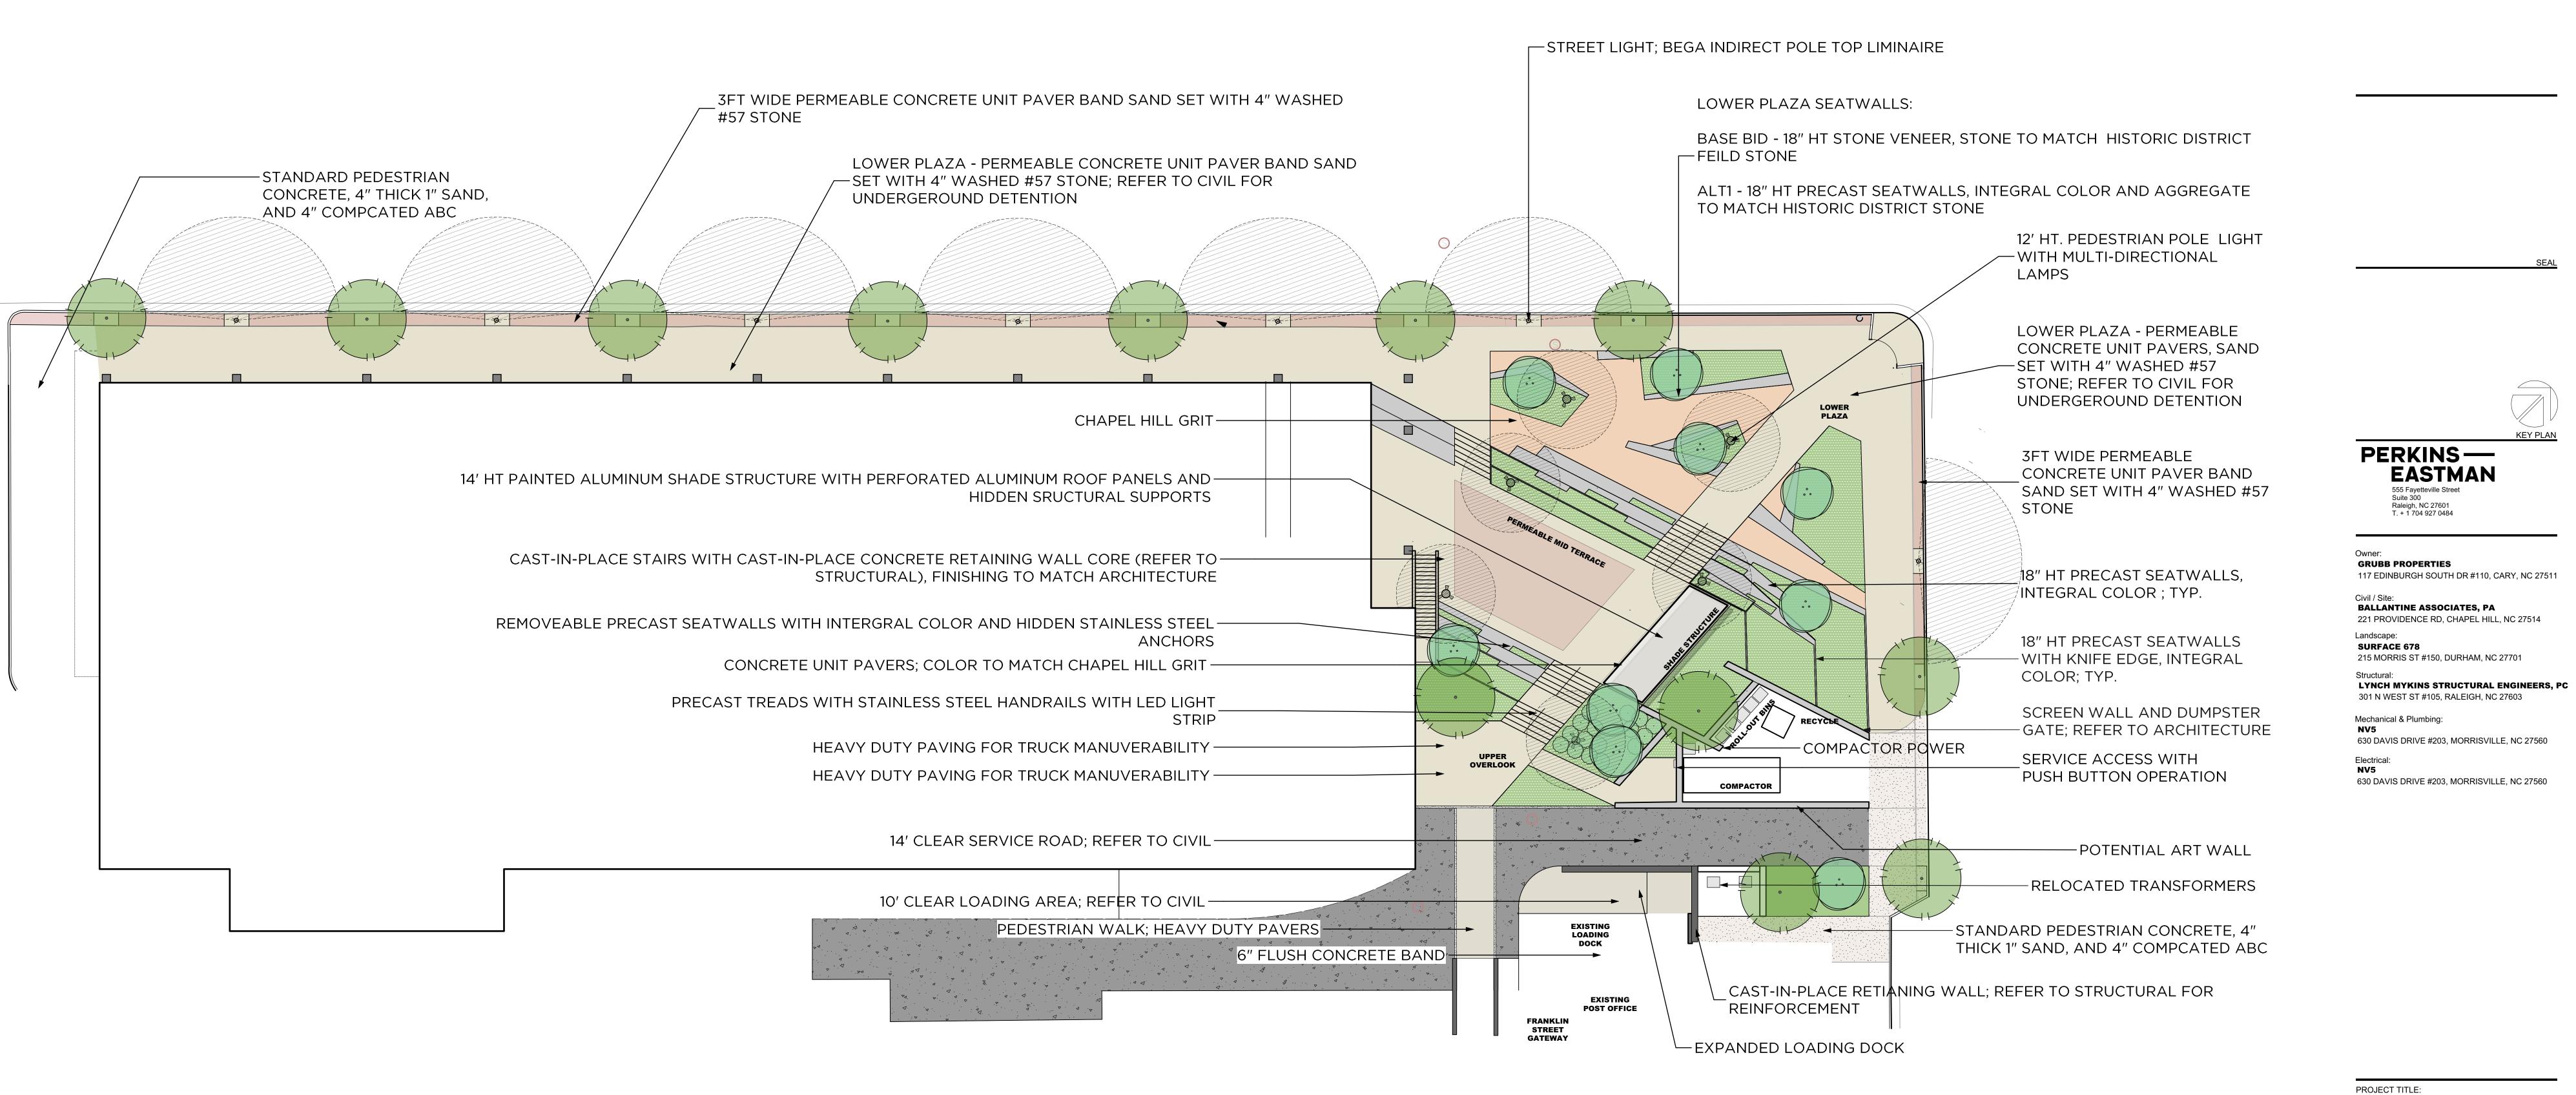

PROJECT TITLE:

150 E ROSEMARY ST LAB/OFFICE BUILDING

PROJECT No: 87280


DRAWING TITLE:

SD HARDSCAPE PLAN

**L200** 

SCHEMATIC DESIGN


JULY 15, 2021

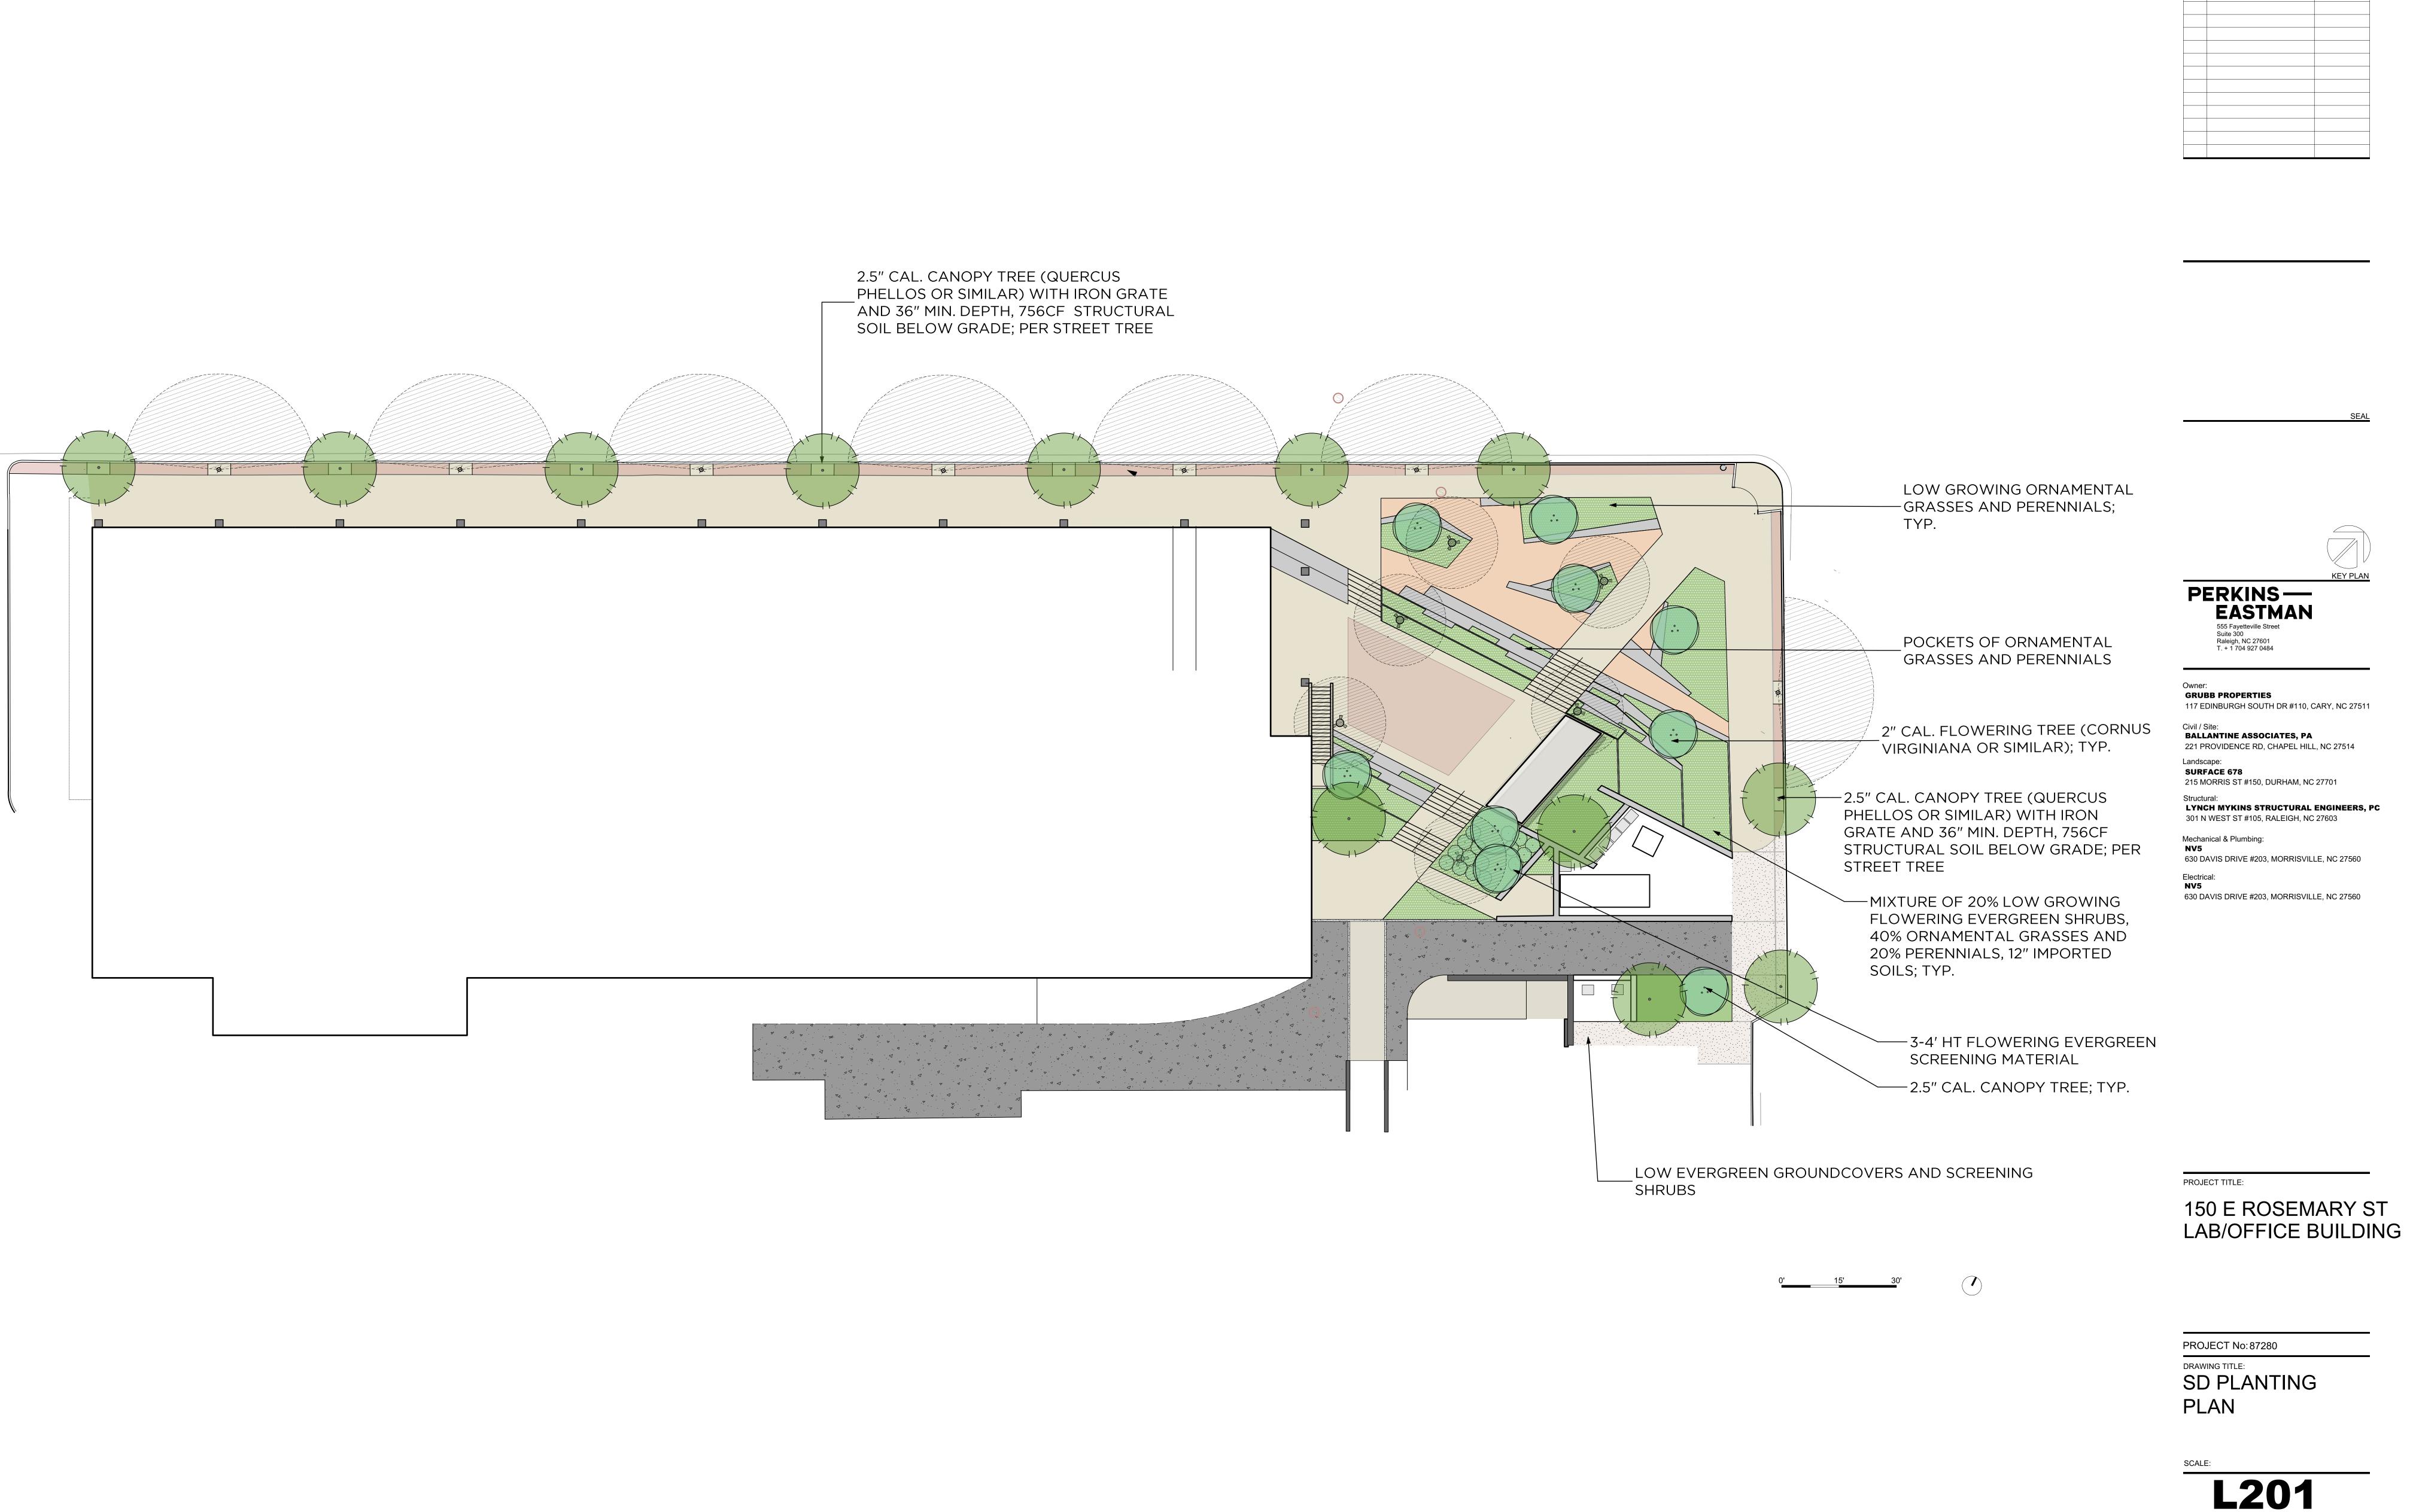


SCHEMATIC DESIGN

JULY 15, 2021



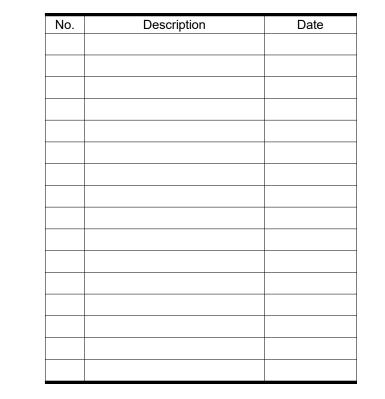

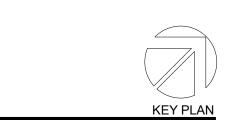

# PERKINS— EASTMAN 555 Fayetteville St., Suite 300 Raleigh, NC 28202

GRUBB PROPERTIES
117 EDINBURGH SOUTH DR #110, CARY, NC 27511

Civil / Site: **BALLANTINE ASSOCIATES, PA**221 PROVIDENCE RD, CHAPEL HILL, NC 27514

**SURFACE 678**215 MORRIS ST #150, DURHAM, NC 27701

LYNCH MYKINS STRUCTURAL ENGINEERS, PC 301 N WEST ST #105, RALEIGH, NC 27603

Mechanical & Plumbing:

630 DAVIS DRIVE #203, MORRISVILLE, NC 27560

Electrical:

630 DAVIS DRIVE #203, MORRISVILLE, NC 27560

PROJECT TITLE:

150 E ROSEMARY ST LAB/OFFICE BUILDING

PROJECT No: 87280


FLOOR PLANS - P1 & P2 / 1ST FLOOR


SCALE: 1/16" = 1'-0"

**A-101** 

SCHEMATIC DESIGN

JUNE 01, 2021

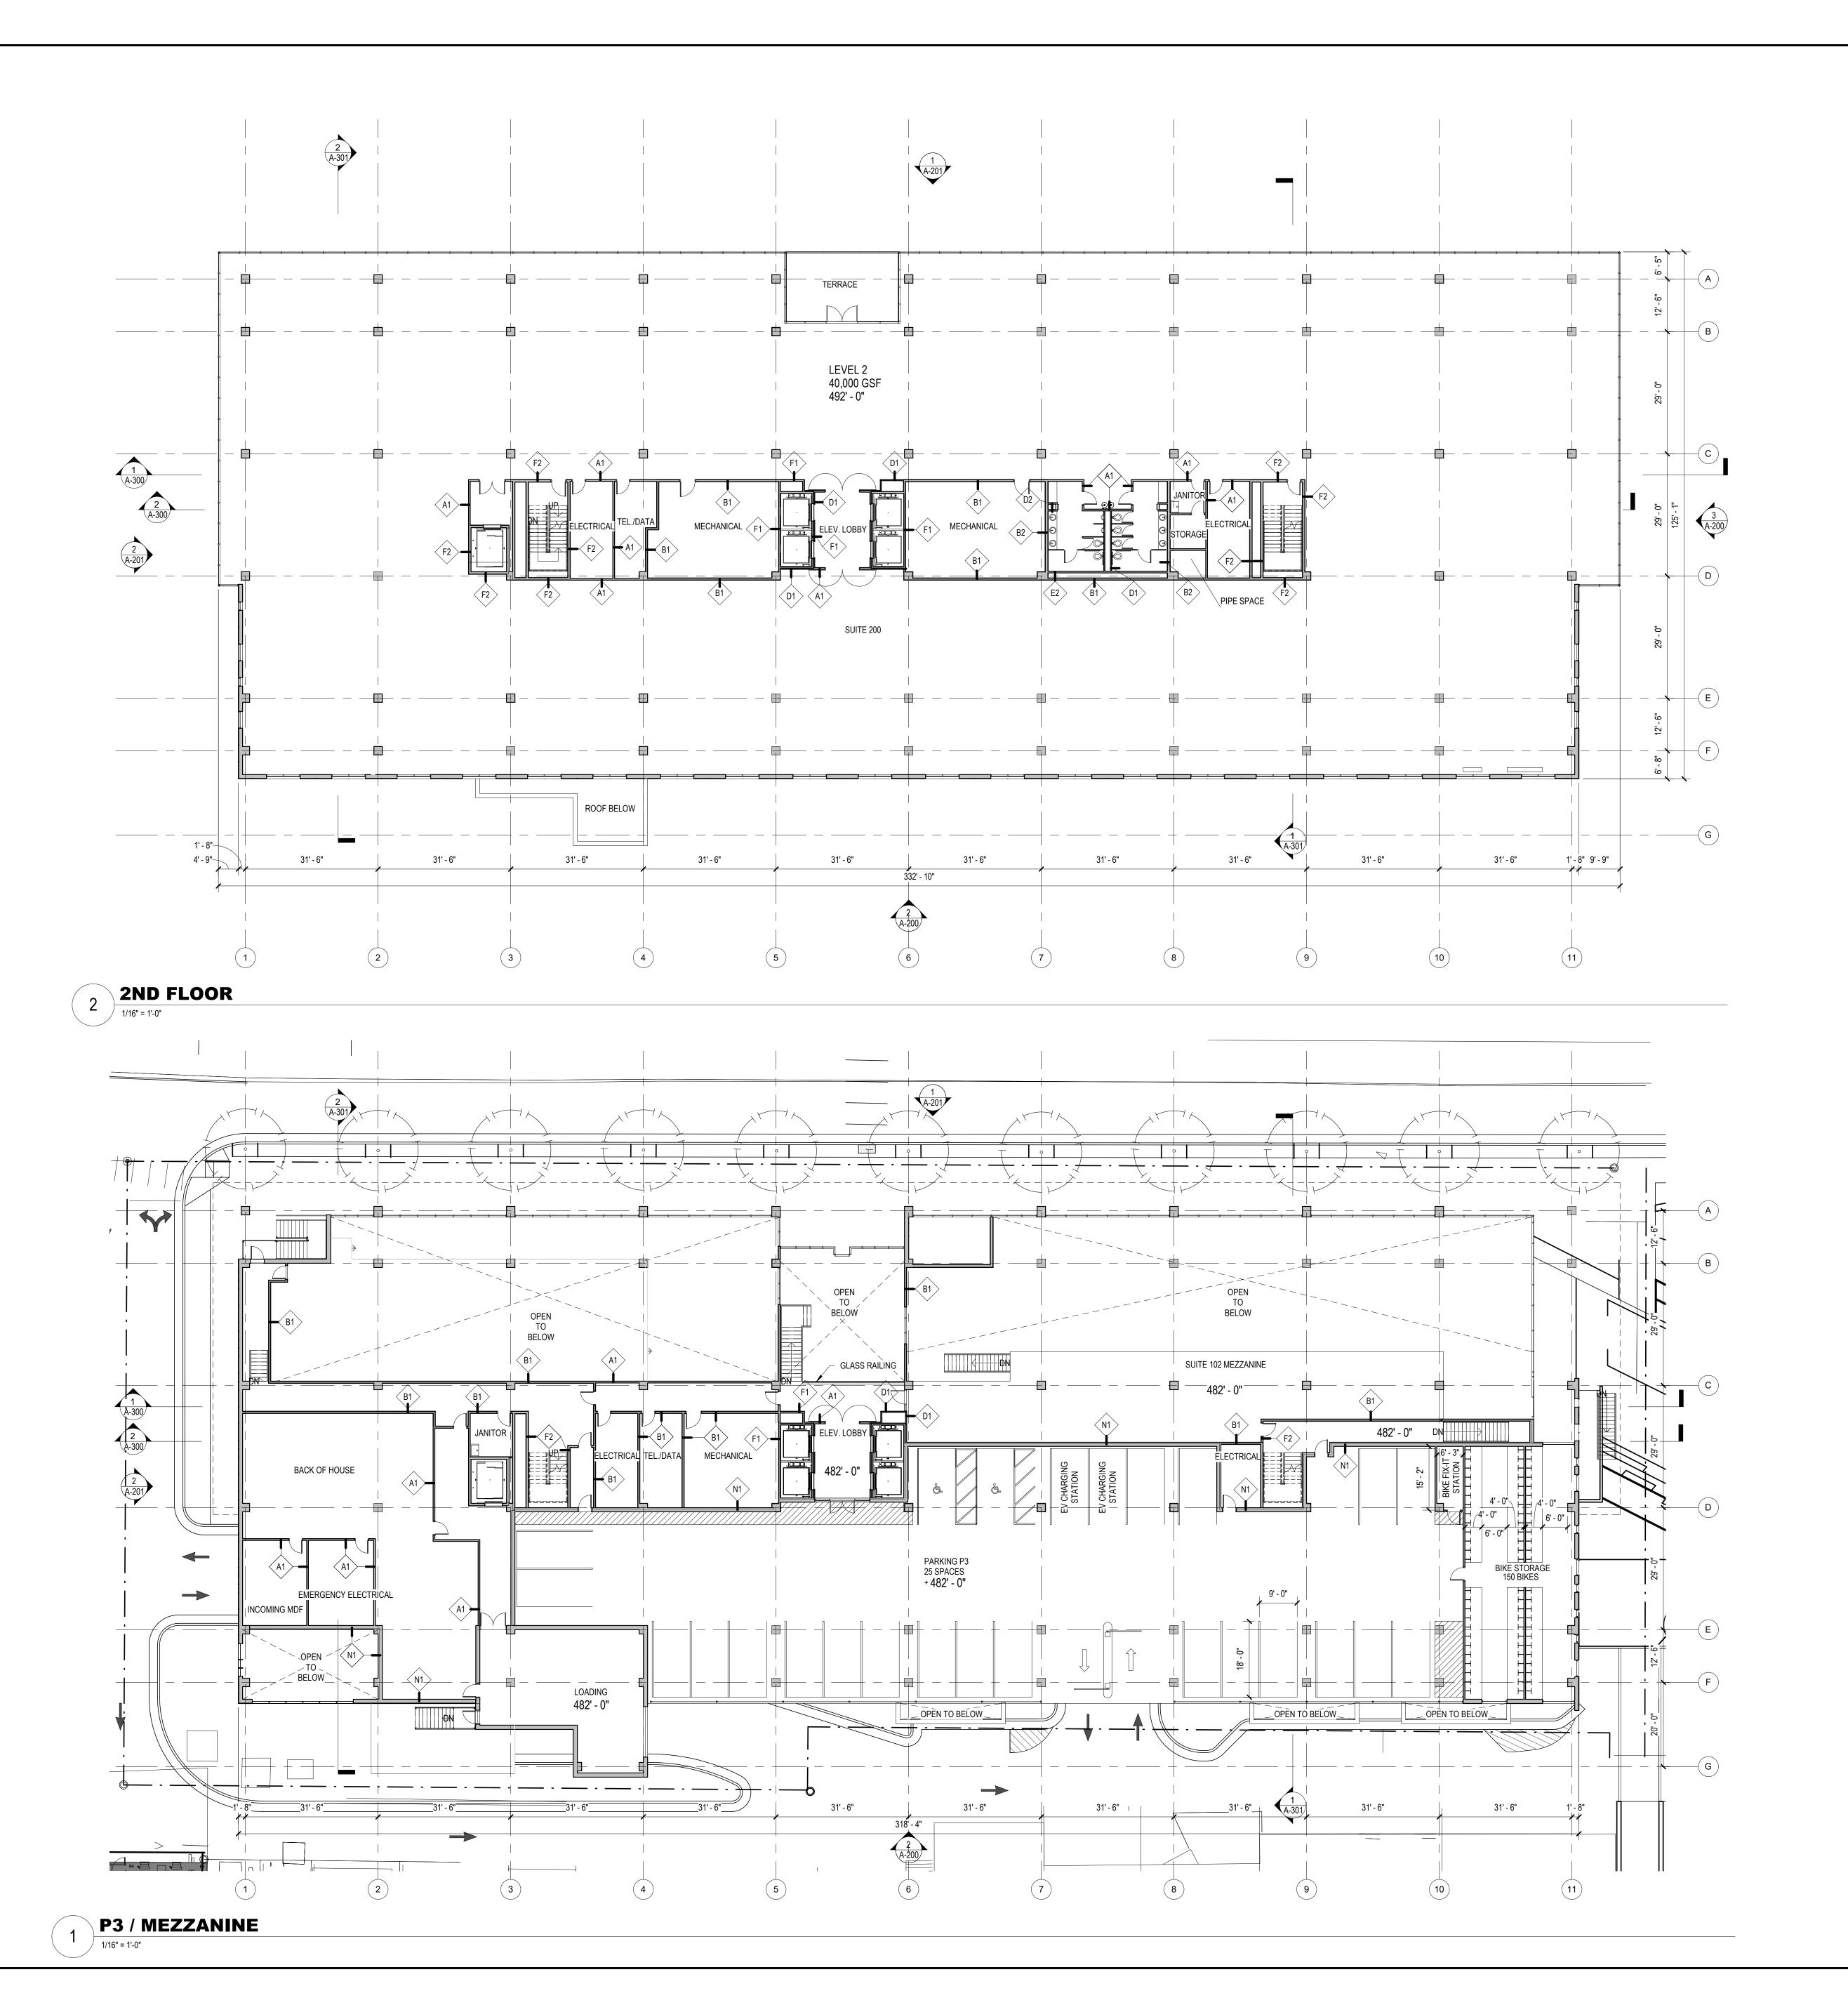

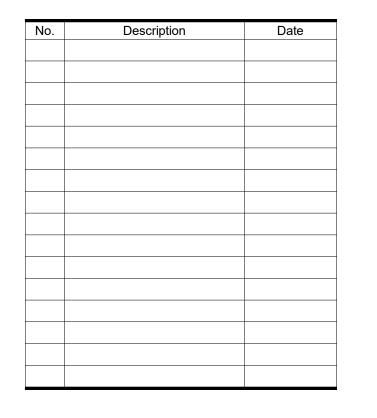

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**GRUBB PROPERTIES**117 EDINBURGH SOUTH DR #110, CARY, NC 27511

Civil / Site: **BALLANTINE ASSOCIATES, PA**221 PROVIDENCE RD, CHAPEL HILL, NC 27514

**SURFACE 678** 215 MORRIS ST #150, DURHAM, NC 27701

LYNCH MYKINS STRUCTURAL ENGINEERS, PC 301 N WEST ST #105, RALEIGH, NC 27603

Mechanical & Plumbing:

**NV5** 630 DAVIS DRIVE #203, MORRISVILLE, NC 27560

630 DAVIS DRIVE #203, MORRISVILLE, NC 27560

PROJECT TITLE:

150 E ROSEMARY ST LAB/OFFICE BUILDING

PROJECT No: 87280

DRAWING TITLE: FLOOR PLANS - P3 / **MEZZANINE & 2ND** 


**FLOOR** 

SCALE: 1/16" = 1'-0"

**A-102** 

SCHEMATIC DESIGN

JUNE 01, 2021

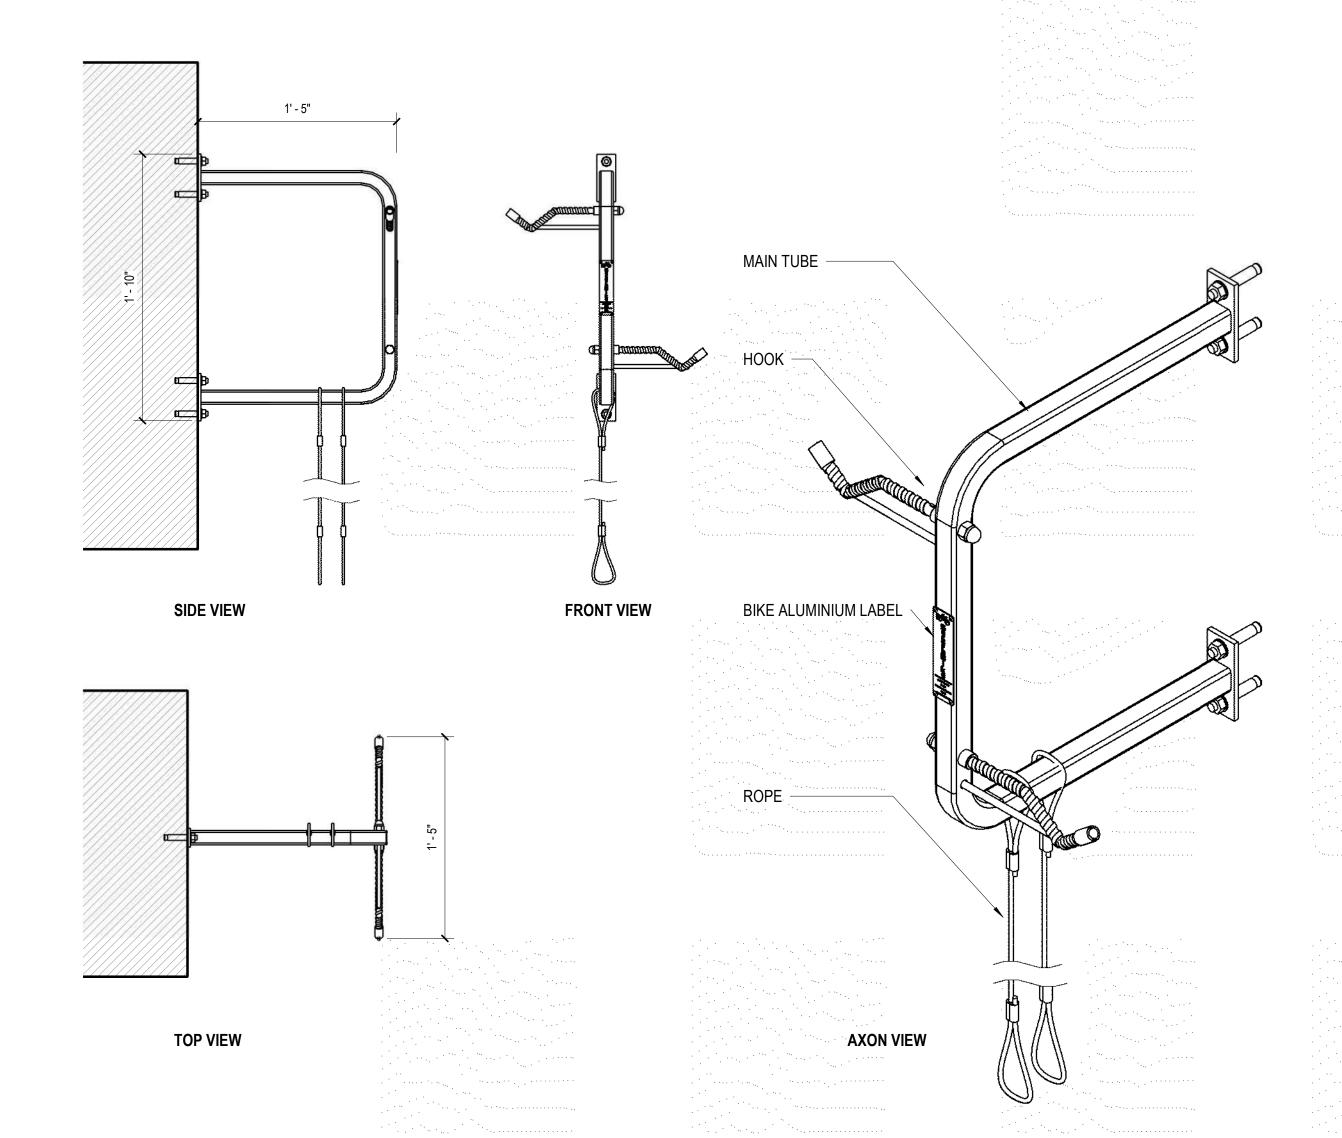



**3D AXON VIEW** 



# **EASTMAN** 555 Fayetteville St., Suite 300 Raleigh, NC 28202

Owner: **GRUBB PROPERTIES** 117 EDINBURGH SOUTH DR #110, CARY, NC 27511

Civil / Site: BALLANTINE ASSOCIATES, PA 221 PROVIDENCE RD, CHAPEL HILL, NC 27514

Landscape: **SURFACE 678** 215 MORRIS ST #150, DURHAM, NC 27701

Structural: LYNCH MYKINS STRUCTURAL ENGINEERS, PC 301 N WEST ST #105, RALEIGH, NC 27603

Mechanical & Plumbing:

630 DAVIS DRIVE #203, MORRISVILLE, NC 27560 Electrical:

NV5 630 DAVIS DRIVE #203, MORRISVILLE, NC 27560

PROJECT TITLE:

150 E ROSEMARY ST LAB/OFFICE BUILDING

PROJECT No: 87280 DRAWING TITLE:

DETAILS


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SCHEMATIC DESIGN

WALL MOUNT BIKE RACK DETAIL

JUNE 01, 2021

:\REVIT LOCAL\87280 /20/2021 6:11:11 PM

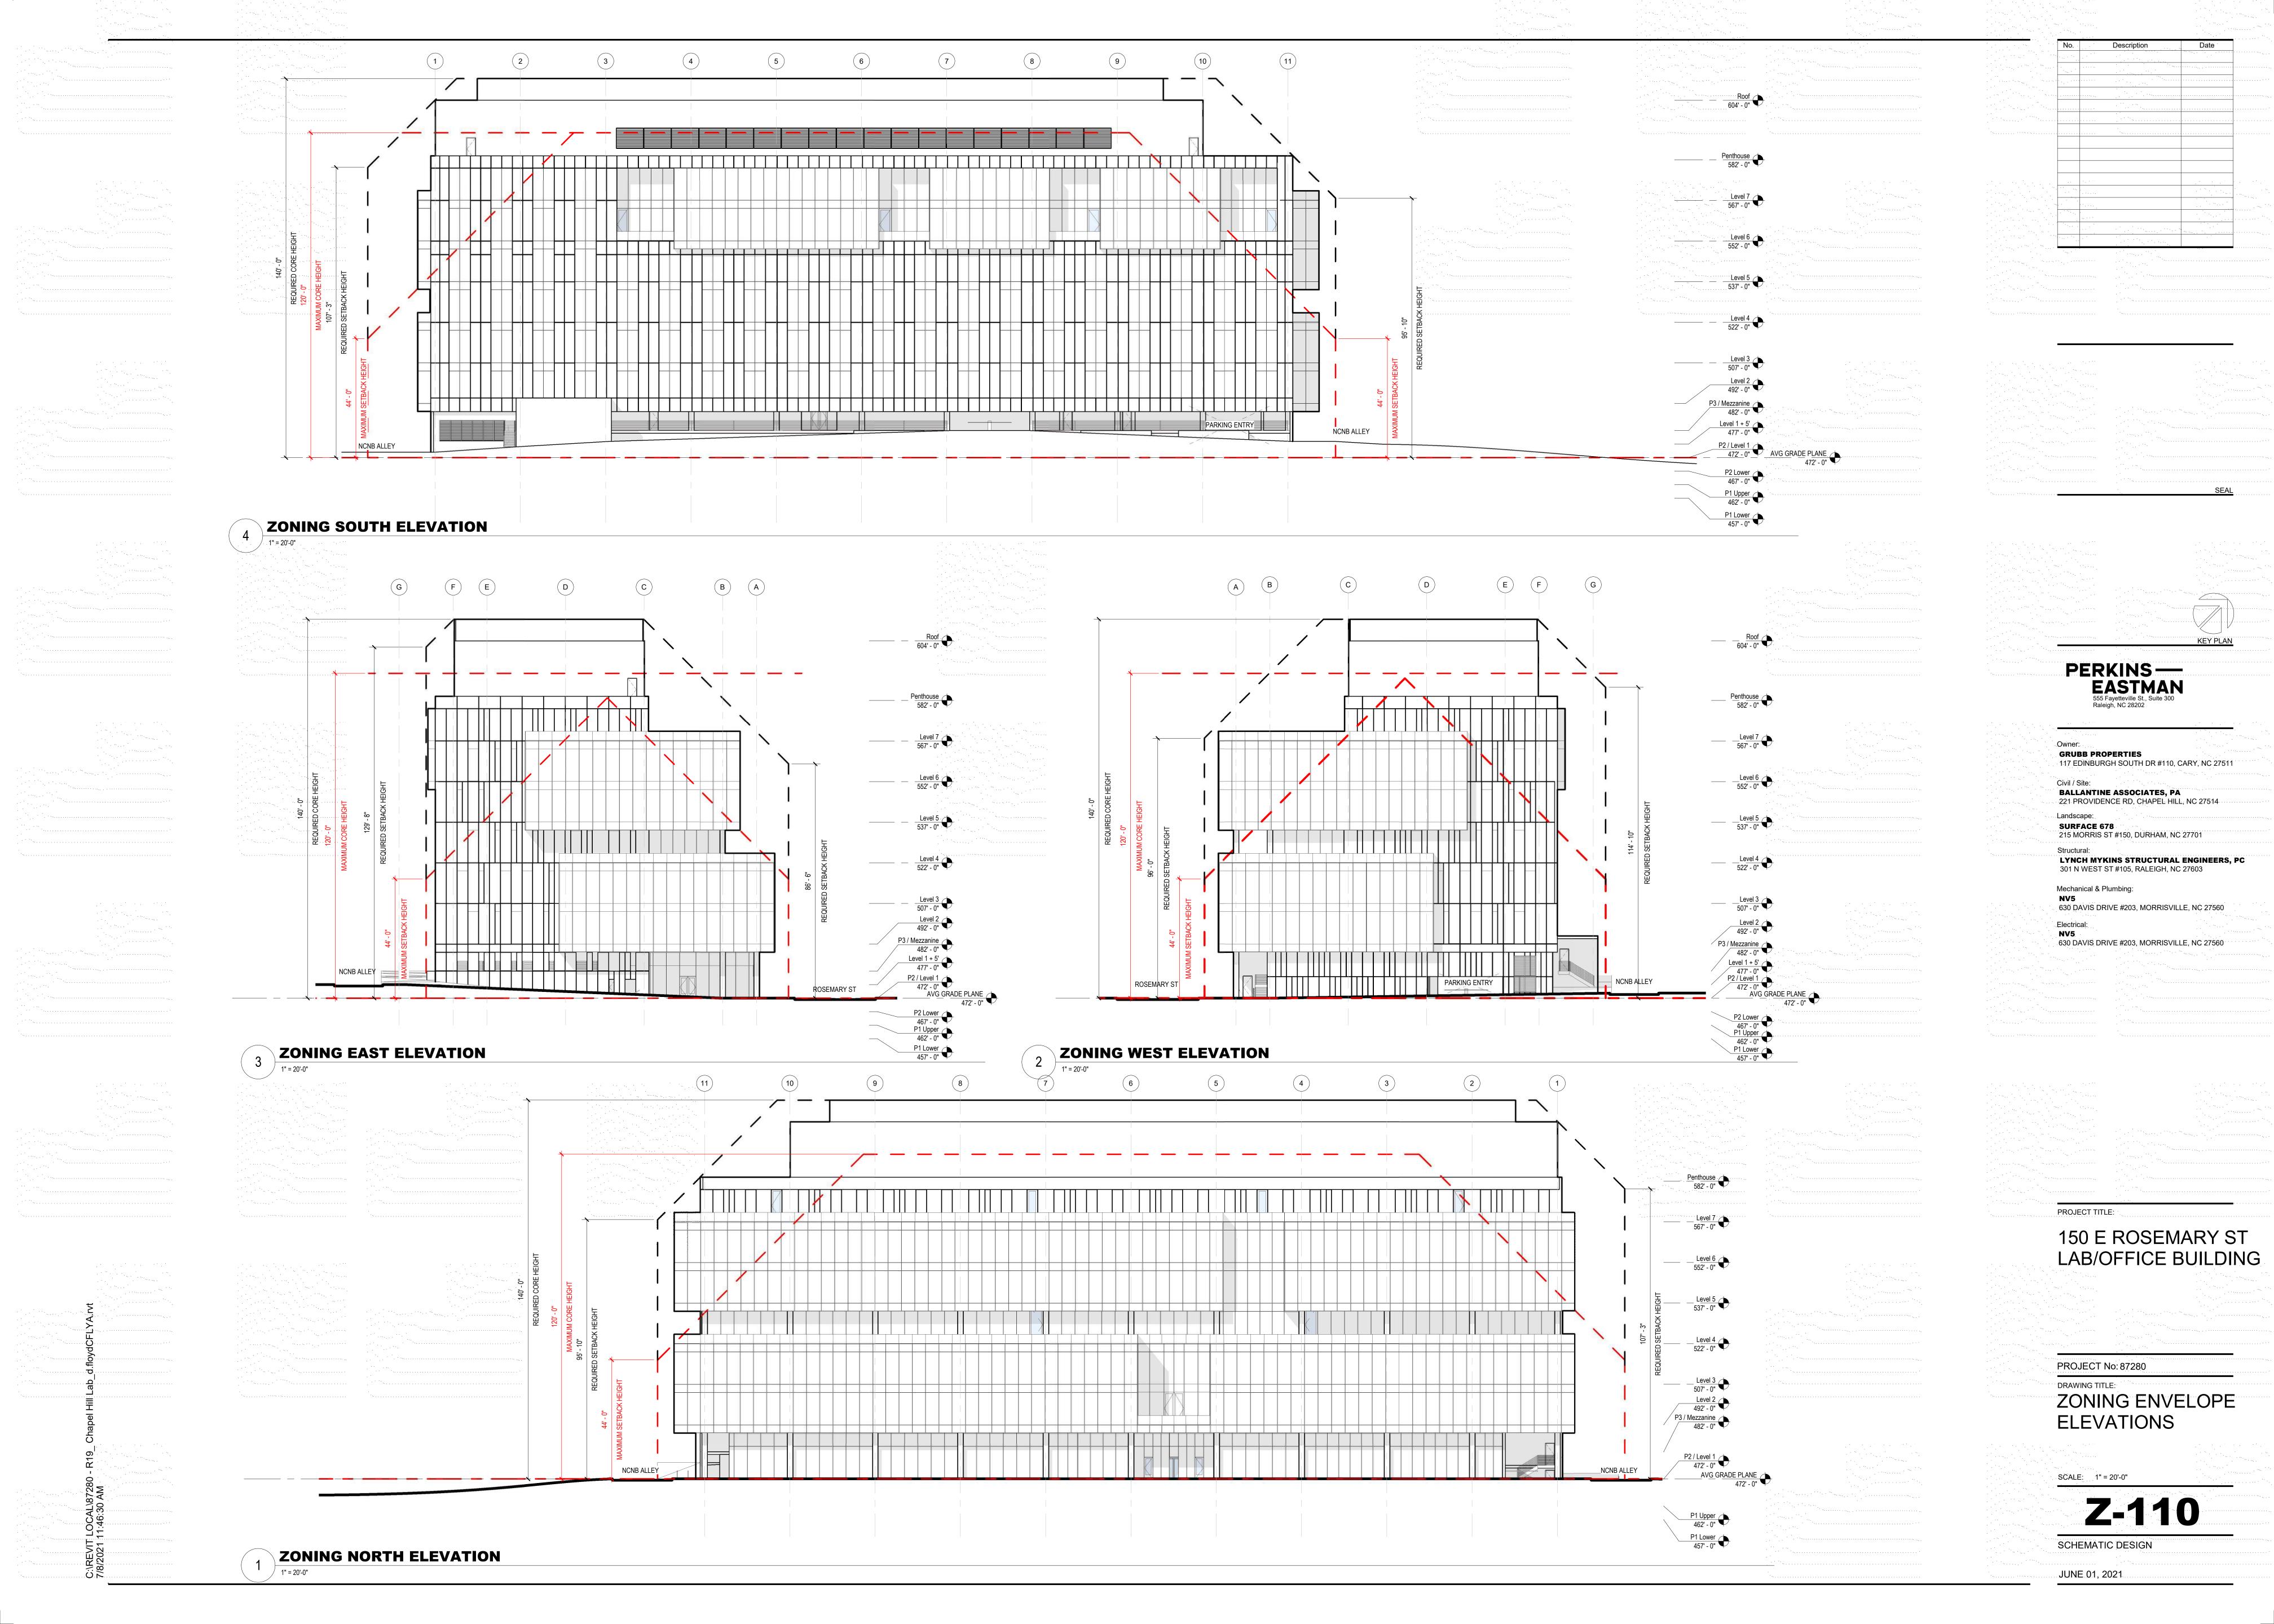

# 150 EAST ROSEMARY STREET OFFICE BUILDING REDEVELOPMENT

# TRANSPORTATION IMPACT ANALYSIS UPDATE

**EXECUTIVE SUMMARY - DRAFT** 



# Prepared for:

The Town of Chapel Hill Public Works Department - Engineering

# Prepared by:

HNTB North Carolina, PC

343 East Six Forks Road Suite 200 Raleigh, NC 27609

NCBELS License #: C-1554

October 2021



# 150 EAST ROSEMARY STREET OFFICE BUILDING REDEVELOPMENT

# TRANSPORTATION IMPACT ANALYSIS UPDATE

# **EXECUTIVE SUMMARY - DRAFT**



# Prepared for:

The Town of Chapel Hill Public Works Department - Engineering

# Prepared by:

HNTB North Carolina, PC

343 East Six Forks Road Suite 200 Raleigh, NC 27609

NCBELS License #: C-1554

October 2021



# 150 East Rosemary Street - Proposed Office Building Redevelopment

### **EXECUTIVE SUMMARY**

### **Project Overview**

A new office building and parking deck are being proposed as a combined redevelopment project along E. Rosemary Street, just east of its intersection with NC 86 (N. Columbia Street) in Chapel Hill, NC. A Transportation Impact Analysis (TIA) was completed by HNTB in October 2020 for the Town of Chapel Hill that provided a complete analysis for both redevelopment projects with the understanding that the new Town parking deck would be completed first, the existing Wallace Deck then demolished, and the proposed office building project built on the Wallace Deck site. This TIA update focuses on site plan changes to the proposed Office Building redevelopment related to site access driveway locations and configurations as well as changes to the office building square footage and number of on-site parking spaces provided by the Applicant. Figure ES-1 shows the general location of the site.

This TIA report update analyzes the full build-out scenario for the office building redevelopment in the year 2023 (assumes full build-out of the new parking deck prior to that year). The proposed office building preliminary site plan shows a provision for two limited access driveways that connect the redevelopment to E. Rosemary Street with a right-turn in/right-turn out only (RIRO) driveway and a new exit only access point along Henderson Street. Figure ES-2 displays the preliminary site plan for the office building and nearby land uses and roadways.

# **Site Traffic Generation**

Table ES-1 shows revised ITE Trip Generation Manual weekday trip generation estimates for the proposed office building. The proposed building square footage was assumed to be 200,000 square feet in the initial TIA. This has been revised to 228,000 square feet, per information from the Applicant. The table also shows the assumed breakout of vehicular trips using leased parking space provided in the E. Rosemary Parking Deck and actual on-site structured parking spaces. The on-site parking proportion of trips also has changed from 200 on-site spaces assumed initially to 158 spaces in the current TIA update.

**AM** Noon PM **Daily Estimate Facility** Units **Peak Hour Peak Hour Peak Hour** Out | Total Out Total Out **Total** In ln Out **Total** In 228k 1,003 1,003 2,006 257 35 292 114 96 48 220 **General Office Building** 210 268 E. Rosemary Deck Leased Spaces 542 542 1,084 139 19 158 62 52 114 26 119 145 Office Building Structured Parking 461 461 922 118 16 134 52 44 96 22 101 123

Table ES-1. Weekday Vehicle Trip Generation Summary

### **Impact Analysis**

#### **Peak Hour Intersection Level of Service**

The 2023 analysis scenarios that include proposed office building site trip effects cause no additional study area intersections to operate over capacity in the three weekday peak hours analyzed, compared to "no-build" conditions where the site is closed on not redeveloped. Site traffic impacts are limited to mostly marginal delay and vehicular queuing increases. Intersections that experience deficient conditions in at least one peak hour in 2023 also generally experience the same conditions currently and geometric or capacity improvement options at these locations are very limited. A summary of the traffic operations for each intersection, related to vehicular delays (intersection average as a whole if signalized, critical movement if stop-controlled) and the corresponding Level-of-Service (LOS) is shown in **Table ES-2** on the following page.





150 East Rosemary Street - Proposed Office Building Redevelopment

Table ES-2. Peak Hour Intersection Capacity Analysis Summary

Intersections	Peak		023 Build	2023	Build	Intersections	2023 No-Build		2023 Build	
	Hour	LOS	Delay	LOS	Delay		LOS	Delay	LOS	Delay
W. Doogman, Ctroot 9	AM	Α	9.4	Α	9.6	E. Franklin Street &	С	22.5	С	22.5
W. Rosemary Street & Church Street	NOON	Α	9.4	Α	9.5	Hillsborough Street /	C	24.0	C	23.8
Charch Street	PM	В	13.8	В	13.8	Raleigh Street	С	21.4	С	21.6
W Bosomory Stroot 9	AM	C	24.2	С	24.8	NC 86 (MLK Jr. Blvd) &	В	11.5	В	11.8
W. Rosemary Street & NC 86	NOON	O	26.5	С	27.3	N. Columbia Street /	В	19.8	В	20.1
110 00	PM	C	34.2	D	37.4	North Street <sup>#@</sup>	O	23.7	C	24.4
F. Doggmany Ctroot 9	AM	Α	9.4	Α	9.8	NC OC (MLK In Divid) 9	Α	9.6	Α	9.7
E. Rosemary Street & Henderson Street	NOON	В	12.6	В	14.9	NC 86 (MLK Jr. Blvd) & Longview Street	Α	5.6	Α	5.6
	PM	В	11.6	В	15.2		Α	8.1	Α	8.1
E. Rosemary Street & Hillsborough Street	AM	В	15.1	В	15.3	W. Cameron Avenue & NC 86 (Pittsboro Street)	В	17.4	В	17.4
	NOON	В	15.7	В	15.7		C	20.4	C	20.6
	PM	В	17.7	В	17.4		O	20.3	C	20.1
W. Franklin Chrook 9	AM	Α	7.7	Α	7.6	Cameron Avenue & NC 86 (S. Columbia St)	С	28.5	С	28.8
W. Franklin Street & Church Street	NOON	В	13.1	В	13.3		С	33.5	С	33.9
Charch Street	PM	В	18.9	В	19.1		Ε	59.3	Ε	65.3
Cameron Ave/Country	AM	С	23.4	С	24.0	E. Rosemary St & Parking Deck Primary	В	14.2	В	14.3
Club Rd & Raleigh	NOON	O	20.9	С	21.1		С	16.1	C	16.4
Street	PM	C	30.6	С	30.9	Driveway#	C	16.2	C	16.9
Franklin Street &	AM	С	30.3	С	29.9	E. Rosemary St &	N/A	N/A	В	13.1
NC 86 (Columbia	NOON	D	40.7	D	41.4	Office Bldg RIRO	N/A	N/A	В	12.6
Street)	PM	Ε	59.5	Ε	61.9	Driveway	N/A	N/A	C	15.6
F. Franklin Chrook 9	AM	Α	7.9	Α	7.5	E. Rosemary St &	N/A	N/A	В	13.1
E. Franklin Street & Henderson Street	NOON	В	12.5	В	14.0	Office Bldg Exit-Only	N/A	N/A	В	12.6
Tienderson Street	PM	В	12.5	В	19.6	Driveway	N/A	N/A	C	15.6
North Street &	AM	Α	8.9	Α	8.9					
Proposed Deck	NOON	Α	9.4	Α	9.4					
Access Driveway	PM	В	10.2	В	10.3					

BOLD/ITALICS - Critical Movement or Overall Intersection Requires Mitigation Analysis Per Town TIA Guidelines # - Worst-Case LOS/Delay for Two-Way Unsignalized/Stop-Controlled Critical Movement @ - Assumed Signalized

#### **Access Analysis**

Per information from the Applicant and shown in Figure ES-2, two restricted access locations are proposed. A right-turn in/right-turn out (RIRO) driveway is proposed at the current alley location along E. Rosemary Street. The current internal alley would continue to serve as access for the site structure parking areas and an exit-only driveway extension is proposed to connect to Henderson Street. Median delineators are proposed along E. Rosemary Street to prevent left-turns at the alley driveway and help facilitate full access movements for left-turning traffic at the adjacent offset E. Rosemary Parking Deck Main Access intersection.

# Mitigation Measures/Recommendations

# **Planned Improvements**

There are no planned transportation improvement projects by NCDOT expected to be complete between 2020 and 2023 in the immediate project study area. The Town of Chapel Hill is in the process of designing and implementing the West Franklin Street Lane Reallocation project to reduce the number of through travel lanes on West Franklin Street west of NC 86. The reallocated lanes will be



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150 East Rosemary Street - Proposed Office Building Redevelopment

used for parking, loading zones, bicycle lanes and other amenities. This project was expected to be complete by the 2023 analysis year and was also assumed to include signal retiming throughout the downtown area to account for vehicular flow changes in the lane reallocation vicinity. Details are shown on **Figure ES-3**.

The Town also has the North-South Bus Rapid Transit Project, which will provide dedicated lanes for transit along the NC 86 corridor, along with other transit amenity improvements scheduled for construction in 2022. As final design details are not complete as of the submittal of this TIA, no specific lane usage changes were analyzed as part of this study.

# **Background Committed Improvements**

Based on traffic capacity analyses for the 2023 design year, and analyses of existing study area turning bay storage lengths and site access for the proposed parking deck, the improvements shown in the original TIA (see pages 31 and 32 of the full TIA report) that were recommended specifically due to proposed Parking Deck impact were included in this TIA update as being necessary for adequate transportation network operations (see **Figure ES-3**). These are considered background committed improvements for this TIA update.

An additional improvement to prevent right-turns out of the North Street Parking Deck driveway was added to further reduce cut-through traffic potential in the North Street area and its impacts were included in this analysis.

## **Applicant Committed Improvements**


Based on the updated site plan provided by the Applicant, the proposed Office Building redevelopment will utilize two access driveways with the connection to E. Rosemary Street limited to RIRO access only. Raised median delineators will be installed to prevent left-turns into this site access point while preserving full access for the adjacent Main Access Driveway to the proposed E. Rosemary Street Parking Deck.

A second access point for traffic exiting the proposed Office Building structured parking will be provided on Henderson Street. Full access (left and right-turns out) will be provided at the exit from a single lane. No ingress will be allowed at this location. Existing on-street parking spaces are shown on the site plan to be removed to allow adequate sight distance at the intersection.

### **Necessary Improvements**

Based on traffic capacity analyses for the 2023 design year, and analyses of existing study area turning bay storage lengths and Office Building potential site access issues, the following improvements are recommended as being necessary for adequate transportation network operations (see **Figure ES-3**). These improvements are made with the assumptions that the 2022 Parking Deck analysis year Necessary Improvements listed above are all completed by the 2023 analysis year for the proposed Office Building.

- 1) To reduce potential conflicts with queues along Henderson Street for exiting Office Building traffic, signal timing adjustments may be necessary at the E. Rosemary Street and Franklin Street intersections to provide more green time for Henderson Street approaches.
- 2) "Do Not Block Intersection" signage and pavement markings on Henderson Street may be necessary to avoid vehicular conflicts at the Exit-Only Driveway intersection with Henderson Street.

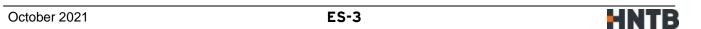



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Regardless of whether or not the proposed Office Building redevelopment occurs, additional signal timing adjustments and the lengthening of the existing westbound left-turn lane storage to 250 feet at the Franklin Street and NC 86 (Columbia Street) intersection may need to be considered once the W. Franklin Street lane reallocation project is complete. This improvement is necessary to reduce potential queueing for all westbound traffic along Franklin Street upstream of this intersection and may require the elimination of several on street parking spaces along the south side of the facility.



