SOUTH CREEK

MIXED USE DEVELOPMENT S COLUMBIA ST, CHAPEL HILL, NC 27514

CONDITIONAL ZONING SET FEBRUARY 17, 2023

13860 Ballantyne Corporate Place, Suite 425 Charlotte, NC 28227

> CIVIL **PERMIT PLAN SET**

REEK EVELOPMENT

PROJECT NO: 02/17/23 DATE ISSUED:

DESIGNED BY DRAWN BY: CHECKED BY:

SHEET NAME: COVER SHEET

SHEET NO:

PROJECT TEAM

WOOLPERT ARCHITECTURE | ENGINEERING | GEOSPATIAL

13860 Ballantyne Corporate Place

<u>DEVELOPER</u> BEECHWOOD OBEY CREEK LLC 7621 LITTLE AVENUE SUITE 111 CHARLOTTE, NC 28226 TEL: (704)582-3989

POTABLE WATER & SANITARY SEWER ORANGE COUNTY WATER AND SEWER AUTHORITY (OWASA) TEL: (919)560-4326

DUKE ENERGY CAROLINAS/PROGRESS 4412 HILLSBOROUGH RD DURHAM, NC 27705 TEL: (800)777-9898

GAS DOMINION GAS 66 N CHATHAM PKWY CHAPEL HILL, NC 27517 TEL: (877)776-2427

TOWN OF CHAPEL HILL CONSTRUCTION PLAN APPROVAL

ALL CONSTRUCTION METHODS AND MATERIALS SHALL BE IN ACCORDANCE WITH THE TOWN OF CHAPEL HILL, ORANGE WATER AND SEWER AUTHORITY (OWASA), AND NCDOT STANDARDS AND SPECIFICATIONS. IN THE EVENT OF A CONFLICT BETWEEN STANDARDS, THE MORE STRINGENT SHALL GOVERN UNLESS A WAVER IS ISSUED BY THE TOWN ENGINEER AND/OR AUTHORITY HAVING JURISDICTION (AHJ). UTILITY INSTALLATIONS AND OTHER PUBLIC FACILITIES. INCLUDING STREETS, SIDEWALKS, STORMWATER AND HANDICAP RAMPS, HAVE BEEN APPROVED BY THE TOWN OF CHAPEL HILL AND SHALL BE SO INSTALLED UNLESS A CHANGE IS AUTHORIZED BY PRIOR WRITTEN APPROVAL. PUBLIC WATER/SANITARY SEWER, STORMWATER AND UTILITY EASEMENTS SHALL BE RECORDED PRIOR TO FINAL ACCEPTANCE AND/OR ISSUANCE OF A CERTIFICATE OF OCCUPANCY BY THE TOWN.

THE TOWN OF CHAPEL HILL MAY REQUIRE REDESIGN AND/OR RECONSTRUCTION OF WORK SHOWN ON THE APPROVED PLANS, SUBSEQUENT TO SUCH APPROVAL. IF IT BECOMES EVIDENT THAT THE DESIGN IS INADEQUATE TO MEET THE ACTUAL FIELD CONDITIONS AND/OR IS BASED ON INCOMPLETE, INSUFFICIENT, INACCURATE OR MISLEADING DATA PORTRAYED ON THE APPROVED PLANS. THE TOWN OF CHAPEL HILL ACCEPTS NO RESPONSIBILITY FOR COSTS INVOLVED IN SUCH REDESIGN AND/OR RECONSTRUCTION.


ENGINEERING SIGNATURE:

NOTE: THE FOLLOWING IS A LIST OF JURISDICTIONAL AGENCIES KNOWN TO HAVE PERMIT AUTHORITY OVER THE SUBJECT PROPERTY. APPROVALS SHOULD BE OBTAINED PRIOR TO COMMENCEMENT OF CONSTRUCTION.

ENTITY	PERMIT NO.	APPROVAL DATE	EXPIRATION DATE
	_	1	_
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	ı	1	_
	-	1	
	-	1	_
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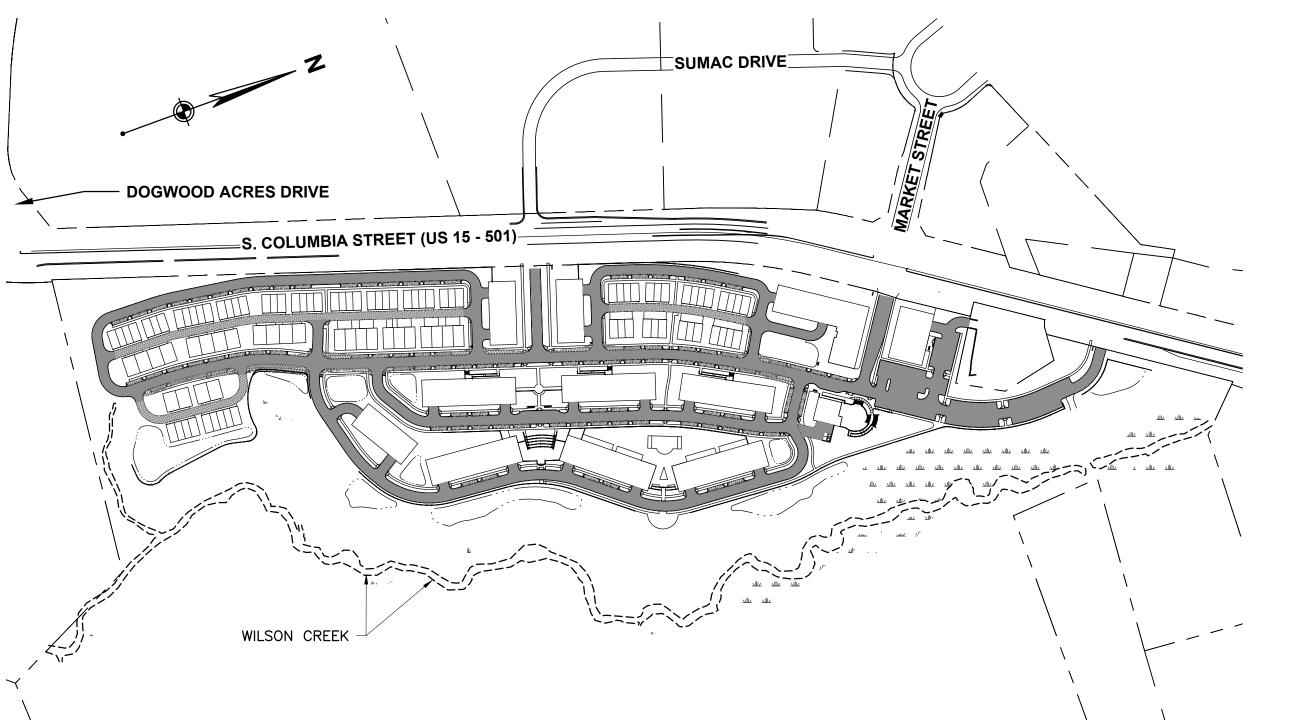
VICINITY MAP

SCALE: 1" = 1000'

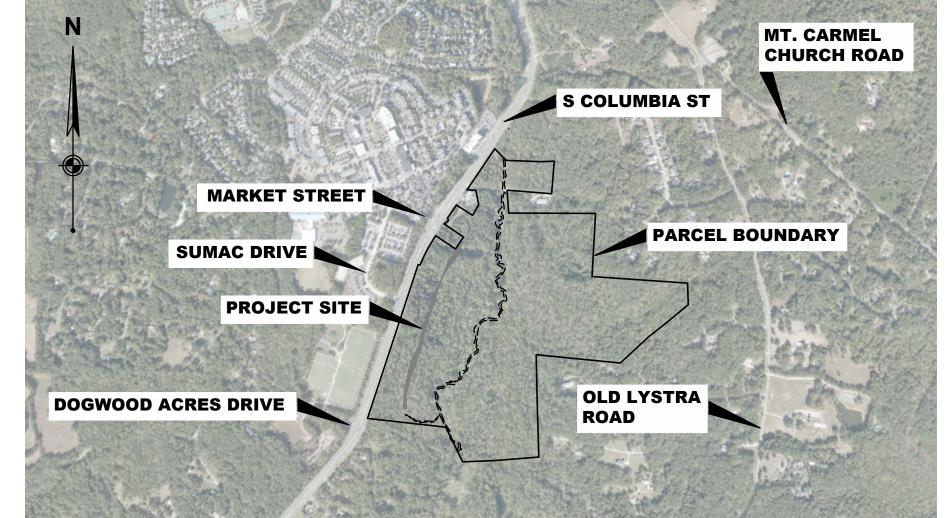

SITE PLAN

SCALE: 1" = 250'



C-103 OVERALL DEMOLITION PLAN C-104 **DEMOLITION PLAN** C-105 **DEMOLITION PLAN** DEMOLITION PLAN C-107 OVERALL PRELIMINARY PLAT C-108 PRELIMINARY PLAT C-109 PRELIMINARY PLAT C-201 OVERALL SITE PLAN C-202 SITE PLAN C-203 SITE PLAN C-204 SITE PLAN C-205 CONSTRUCTION MANAGEMENT PLAN STEEP SLOPES PLAN C-206 C-207 SOLID WASTE PLAN AERIAL FIRE APPARATUS ACCESS PLAN C-301 OVERALL GRADING & DRAINAGE PLAN C-302 GRADING & DRAINAGE PLAN C - 303GRADING & DRAINAGE PLAN GRADING & DRAINAGE PLAN C - 304C - 305DRAINAGE PROFILES C-306 DRAINAGE PROFILES C-307 DRAINAGE PROFILES C-308 DRAINAGE PROFILES C - 309DRAINAGE PROFILES C-310 DRAINAGE PROFILES C - 311DRAINAGE PROFILES DRAINAGE PROFILES C - 312C - 313DRAINAGE PROFILES C - 314DRAINAGE PROFILES C-315 DRAINAGE PROFILES C-401 OVERALL UTILITY PLAN C-402 UTILITY PLAN C-403 UTILITY PLAN C-404 UTILITY PLAN C-801 DETAILS C-802 DETAILS L-101 LANDSCAPE PLAN L-102 LANDSCAPE PLAN L-103 LANDSCAPE PLAN L-104 LANDSCAPE PLAN ARCHITECTURAL DRAWINGS Architect Sheet Title TYPICAL 'LONG' CONDOMINIUM ELEVATIONS TYPICAL 'SHORT' CONDOMINIUM ELEVATIONS TYP OFFICE-OVER-RETAIL BUILDING - 1 505 TYP. TOWNHOME BUILDING TYPE A - 2

SHEET INDEX

COVER SHEET

STORMWATER DATA

EXISTING CONDITIONS

ADDITIONAL NOTES & LEGENDS

GENERAL NOTES

STREAM EXHIBIT

SITE DATA

AREA PLAN

SHEET INDEX

C-003

C-004

C-005

C-102

Sheet Number Sheet Title

505 TYP. TOWNHOME BUILDING TYPE B - 3 TYP. TOWNHOME BUILDING TYPE C - 4

PHONE: (704) 582-3989

PROPERTY ADDRESS: US 15/501 TOWN OF CHAPEL HILL, NC GROSS TRACT AREA: 120.88 ACRES (ACROSS 6 PARCELS)

EXISTING SITE DATA

	LOT 1	LOT 2	LOT 3	LOT 4	LOT 5	LOT 6	TOTAL
PROPERTY OWNER:	BEECHWOOD OBEY CREEK VENTURES, LLC	BEECHWOOD OBEY CREEK	BEECHWOOD OBEY CREEK	BEECHWOOD OBEY CREEK	BEECHWOOD OBEY CREEK	TOWN OF CHAPEL HILL	
PROPERTY ADDRESS:	4511 S COLUMBIA ST	_	4210 S COLUMBIA ST	_	-	_	-
PIN NUMBER:	9787130667	9787238844	9787144852	9787244637	9787141770	9787241209	-
DEED BOOK:	4387, PG. 61	4387, PG. 61	4812, PG. 499	4812, PG. 499	6061, PG. 498	1573, PG. 193	-
PLAT BOOK:	114, PG. 7	114, PG. 7	114, PG. 6	114, PG. 6	104, PG. 113	78, PG. 31	_
ZONING:	DA-1 ¹	R-LD1	DA-1 ¹	R-LD1	DA-1 ¹	$DA-1^{1}/R-LD1$	-
USE:	VACANT	UNDEVELOPED	VACANT SINGLE FAMILY RES	UNDEVELOPED	GRAVEL DRIVEWAY	UNDEVELOPED	-
LOT AREA (SF/AC):	1,308,915/30.05	2,603,489/59.77	476,024/10.93	734,216/16.86	37,090/0.85	105,675/2.43	5,265,409/120.88

1 PER EXISTING DEVELOPER AGREEMENT DATED ______

PROPOSED LOT 1 SITE DATA

PROPERTY OWNER:	OBEY CREEK VENTURES, LLC
ZONING:	MU-V-CZD (ARTERIAL)
USE:	MIXED-USE
LOT AREA (SF/AC):	1,864,355/42.800
NET LAND AREA (SF/AC):	1,864,355/42.800
CREDITED STREET AREA (SF/AC):	186,435/4.280
CREDITED OPEN SPACE (SF/AC):	0
GROSS LAND AREA (SF/AC):	2,050,790/47.080

	REQUIRED BY LUMO	LOT 1
MINIMUM LOT SIZE (SF/AC):	11,000/0.253	2,050,790/47.080
MAXIMUM LOT DENSITY (UNITS/AC):	20.0	12.4
MINIMUM LOT FRONTAGE (FT):	80	500.9
MINIMUM LOT WIDTH (FT):	62	500.9
MAXIMUM BUILDING HEIGHT (FT): SETBACK: CORE:	70 114 ±52	N/A ³
MINIMUM STREET SETBACK (FT):	0	17.6
MINIMUM INTERIOR SETBACK (FT):	0	92.9
MAXIMUM IMPERVIOUS SURFACE (SF/RATIO):	1,435,553/0.700	733,239/0.358
MAXIMUM FLOOR AREA (GSF/RATIO):	1,704,858/0.914 ⁴	740,114/0.397

² MU-V-CZD ARTERIAL ROAD

VEHICULAR PARKING SPACES:

BICYCLE PARKING SPACES:

MINIMUM RECREATION SPACE⁵ (SF/RATIO):

MAXIMUM DISTURBANCE TO SLOPES >25% (SF/%)

DWELLING UNITS:

RESOURCE CONSERVATION DISTRICT (RCD) DATA

94,336/0.046

48,974/25%

REFER TO ANALYSIS THIS PAGE

REFER TO ANALYSIS THIS PAGE

100,140/0.049

86,336/48.1%

		•	-
	STREAMSIDE ZONE	MANAGED USE ZONE	UPLAND ZONE
LOT 1 AREA (SF/AC):	291,798 / 6.699	156,756 / 3.599	147,596 / 3.388
IMPERVIOUS AREA (SF/AC):	2,751 / 0.063	0 / 0.000	8,003 / 0.184
DISTURBED AREA (SF/AC):	34,031 / 0.781	2,087 / 0.048	79,003 / 1.814
FLOOR AREA RATIO: (MAX. PER LUMO 3.6/PROPOSED)	0.010 / 0.000	0.019 / 0.000	0.500 / 0.000
SEWERED IMPERVIOUS AREA RATIO: (MAX. PER LUMO 3.6/PROPOSED)	0.100 / 0.009	0.200 / 0.000	0.200 / 0.054
DISTURBED AREA RATIO: (MAX. PER LUMO 3.6/PROPOSED)	0.200 / 0.117	0.400 / 0.013	0.400 / 0.535

WATER PROTECTION DISTRICT (WPD) DATA

	OPTIONS:	LAND USE	DRAINAGE/STORMWATER REQUIREMENTS	STANDARDS
PROPOSED:	HIGH DENSITY	OTHER	USE STORMWATER CONTROL MEASURES	35.8% (70% MAX)

JORDAN WATERSHED RIPARIAN BUFFER DATA

PROPOSED

17,827 / 0.409 ZONE 1 DISTURBED AREA (SF/AC): ZONE 2 DISTURBED AREA (SF/AC): 16,205 / 0.372

VEHICULAR PARKING ANALYSIS

RESIDENTIAL PARKING	VEHICULAR		PROVIDED						
STRUCTURE UNIT TYPE	STUDIO	1 BED	2 BED	COUNT 3 BED	4 BED	SUBTOTAL	REQUIRED MIN.	BY CODE ⁶ MAX.	OFF-STREET PARKING
BUILDING 1 CONDO BUILDING 2 CONDO BUILDING 3 CONDO BUILDING 4 CONDO BUILDING 5 CONDO BUILDING 6 CONDO BUILDING 7 CONDO BUILDING 8 CONDO BUILDING 9 CONDO BUILDING 11 APARTMENT	4 4 5 5 0 4 0 0 5 3	16 16 25 25 45 16 45 44 24 27	14 14 32 32 26 14 22 20 30 27	5 6 6 2 5 2 2 6 3	0 0 0 0 0 0 0	39 39 68 68 73 39 69 66 65 60	49 49 86 86 85 49 80 76 82 73	61 61 108 108 107 61 100 95 102 92	48 48 80 80 80 48 80 80 74
NON-RESIDENTIAL PARKING STRUCTURE UNIT TYPE BUILDING 10 RESTAURANT BUILDING 11 COMMERCIAL BUILDING 12 OFFICE	LUMO BUSINE BUSINE	NG USE P 5.9.7 ESS, REST ESS, GENE	AURANT [RAL	UNIT (QTY 7350 5500 18578	COUNT UNIT SF SF		VEHICULAR REQUIRED MIN. 67 18 53		PROVIDED OFF-STREET PARKING 61 25 59

⁶ Calculation of spaces provided by the Town of Chapel Hill * 50% Reduction per LUMO

FLOOR AREA DATA

NON-RESIDENTIAL TOTALS

TOTAL

STRUCTURE	UNIT TYPE	P2	P1	L1	L2	L3	L4	L5	SUBTOTAL
BUILDING 1 BUILDING 2 BUILDING 3 BUILDING 4 BUILDING 5 BUILDING 6 BUILDING 7 BUILDING 8 BUILDING 9 BUILDING 10	CONDO NON-RESIDENTIAL	0 0 0 0 0 0 0	0 0 0 0 0 0	11,315 11,315 16,767 16,767 16,767 11,315 11,315 16,760 16,760 4,050	11,315 11,315 16,767 16,767 16,767 11,315 11,315 16,760 16,760 3,300	11,315 11,315 16,767 16,767 16,767 11,315 11,315 16,760 16,760	11,315 11,315 16,767 16,767 16,767 11,315 11,315 16,760 16,760	16,767 16,767 16,767 16,760 16,760	45,260 45,260 83,835 83,835 83,835 45,260 45,260 83,800 7,350
BUILDING 11 BUILDING 11 BUILDING 12	NON-RESIDENTIAL APARTMENT NON-RESIDENTIAL	0 0 0	5,500 0 0	23,322 6,586	23,322 11,992	23,322			5,500 69,966 18,578

425 1095 843

	740,114 SF			
STRUCTURE	UNIT TYPE	GFA	QTY	SUBTOTAL
TYPE 1A TYPE 1B TYPE 2A TYPE 2B TYPE 3 TYPE 4	TOWNHOME TOWNHOME TOWNHOME TOWNHOME TOWNHOME TOWNHOME	1,455 1,752 1,816 2,084 2,895 3,096	21 24 14 16 11	30,555 42,048 25,424 33,344 31,845 49,536
	212,752 SF			
	952,866 SF			

BICYCLE PARKING ANALYSIS


		UNIT	BICYCLE PARKING
STRUCTURE	UNIT TYPE	COUNT	REQ'D BY CODE ⁶ PROVIDED
BUILDING 1	CONDO	39	
BUILDING 2	CONDO	39	
BUILDING 3	CONDO	68	
BUILDING 4	CONDO	68	
BUILDING 5	CONDO	73	
BUILDING 6	CONDO	39	
BUILDING 7	CONDO	69	
BUILDING 8	CONDO	66	
BUILDING 9	CONDO	65	
BUILDING 11	APARTMENT	60	
RESID	ENTIAL TOTALS	586	147 147**

NON-RE	SIDE	NTIAL TOTALS			48	70
BUILDING '	12	OFFICE	18578	SF	19	
BUILDING	11	COMMERCIAL	5500	SF	12	
BUILDING '	10	RESTAURANT	7350	SF	17	
STRUCTURE	Ξ	UNIT TYPE		UNIT	REQ'D BY CODE ⁶	
NON-RE	SIDE	ENTIAL PARKING	UNIT C	OLINIT	BICYCLE PA	DIZINIC

⁶ Calculation of spaces provided by the Town of Chapel Hill **Bicycle parking provided on interior of buildings

ARCHITECTURE | ENGINEERING | GEOSPATIAL

13860 Ballantyne Corporate Place, Suite 425 Charlotte, NC 28227

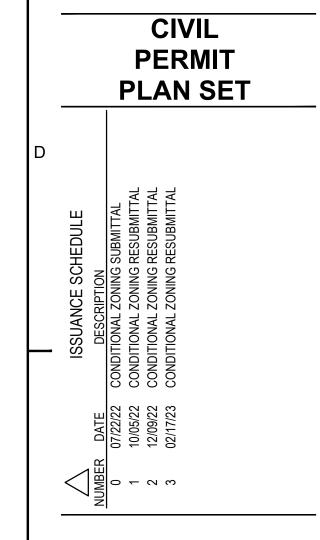

OD HOMES

CREEK


DEVELOPMENT **BEECHWOOD** PROJECT NO:

02/17/23 DATE ISSUED: **DESIGNED BY:** DRAWN BY: CHECKED BY:

SHEET NAME: SITE DATA

SHEET NO:

³ BUILDINGS PLACED AWAY FROM SETBACK (0 FT SETBACK)
4 COMPOSITE FAR PER LUMO SECTION 3.8
5 MINIMUM RECREATION SPACE = GLA x 0.046

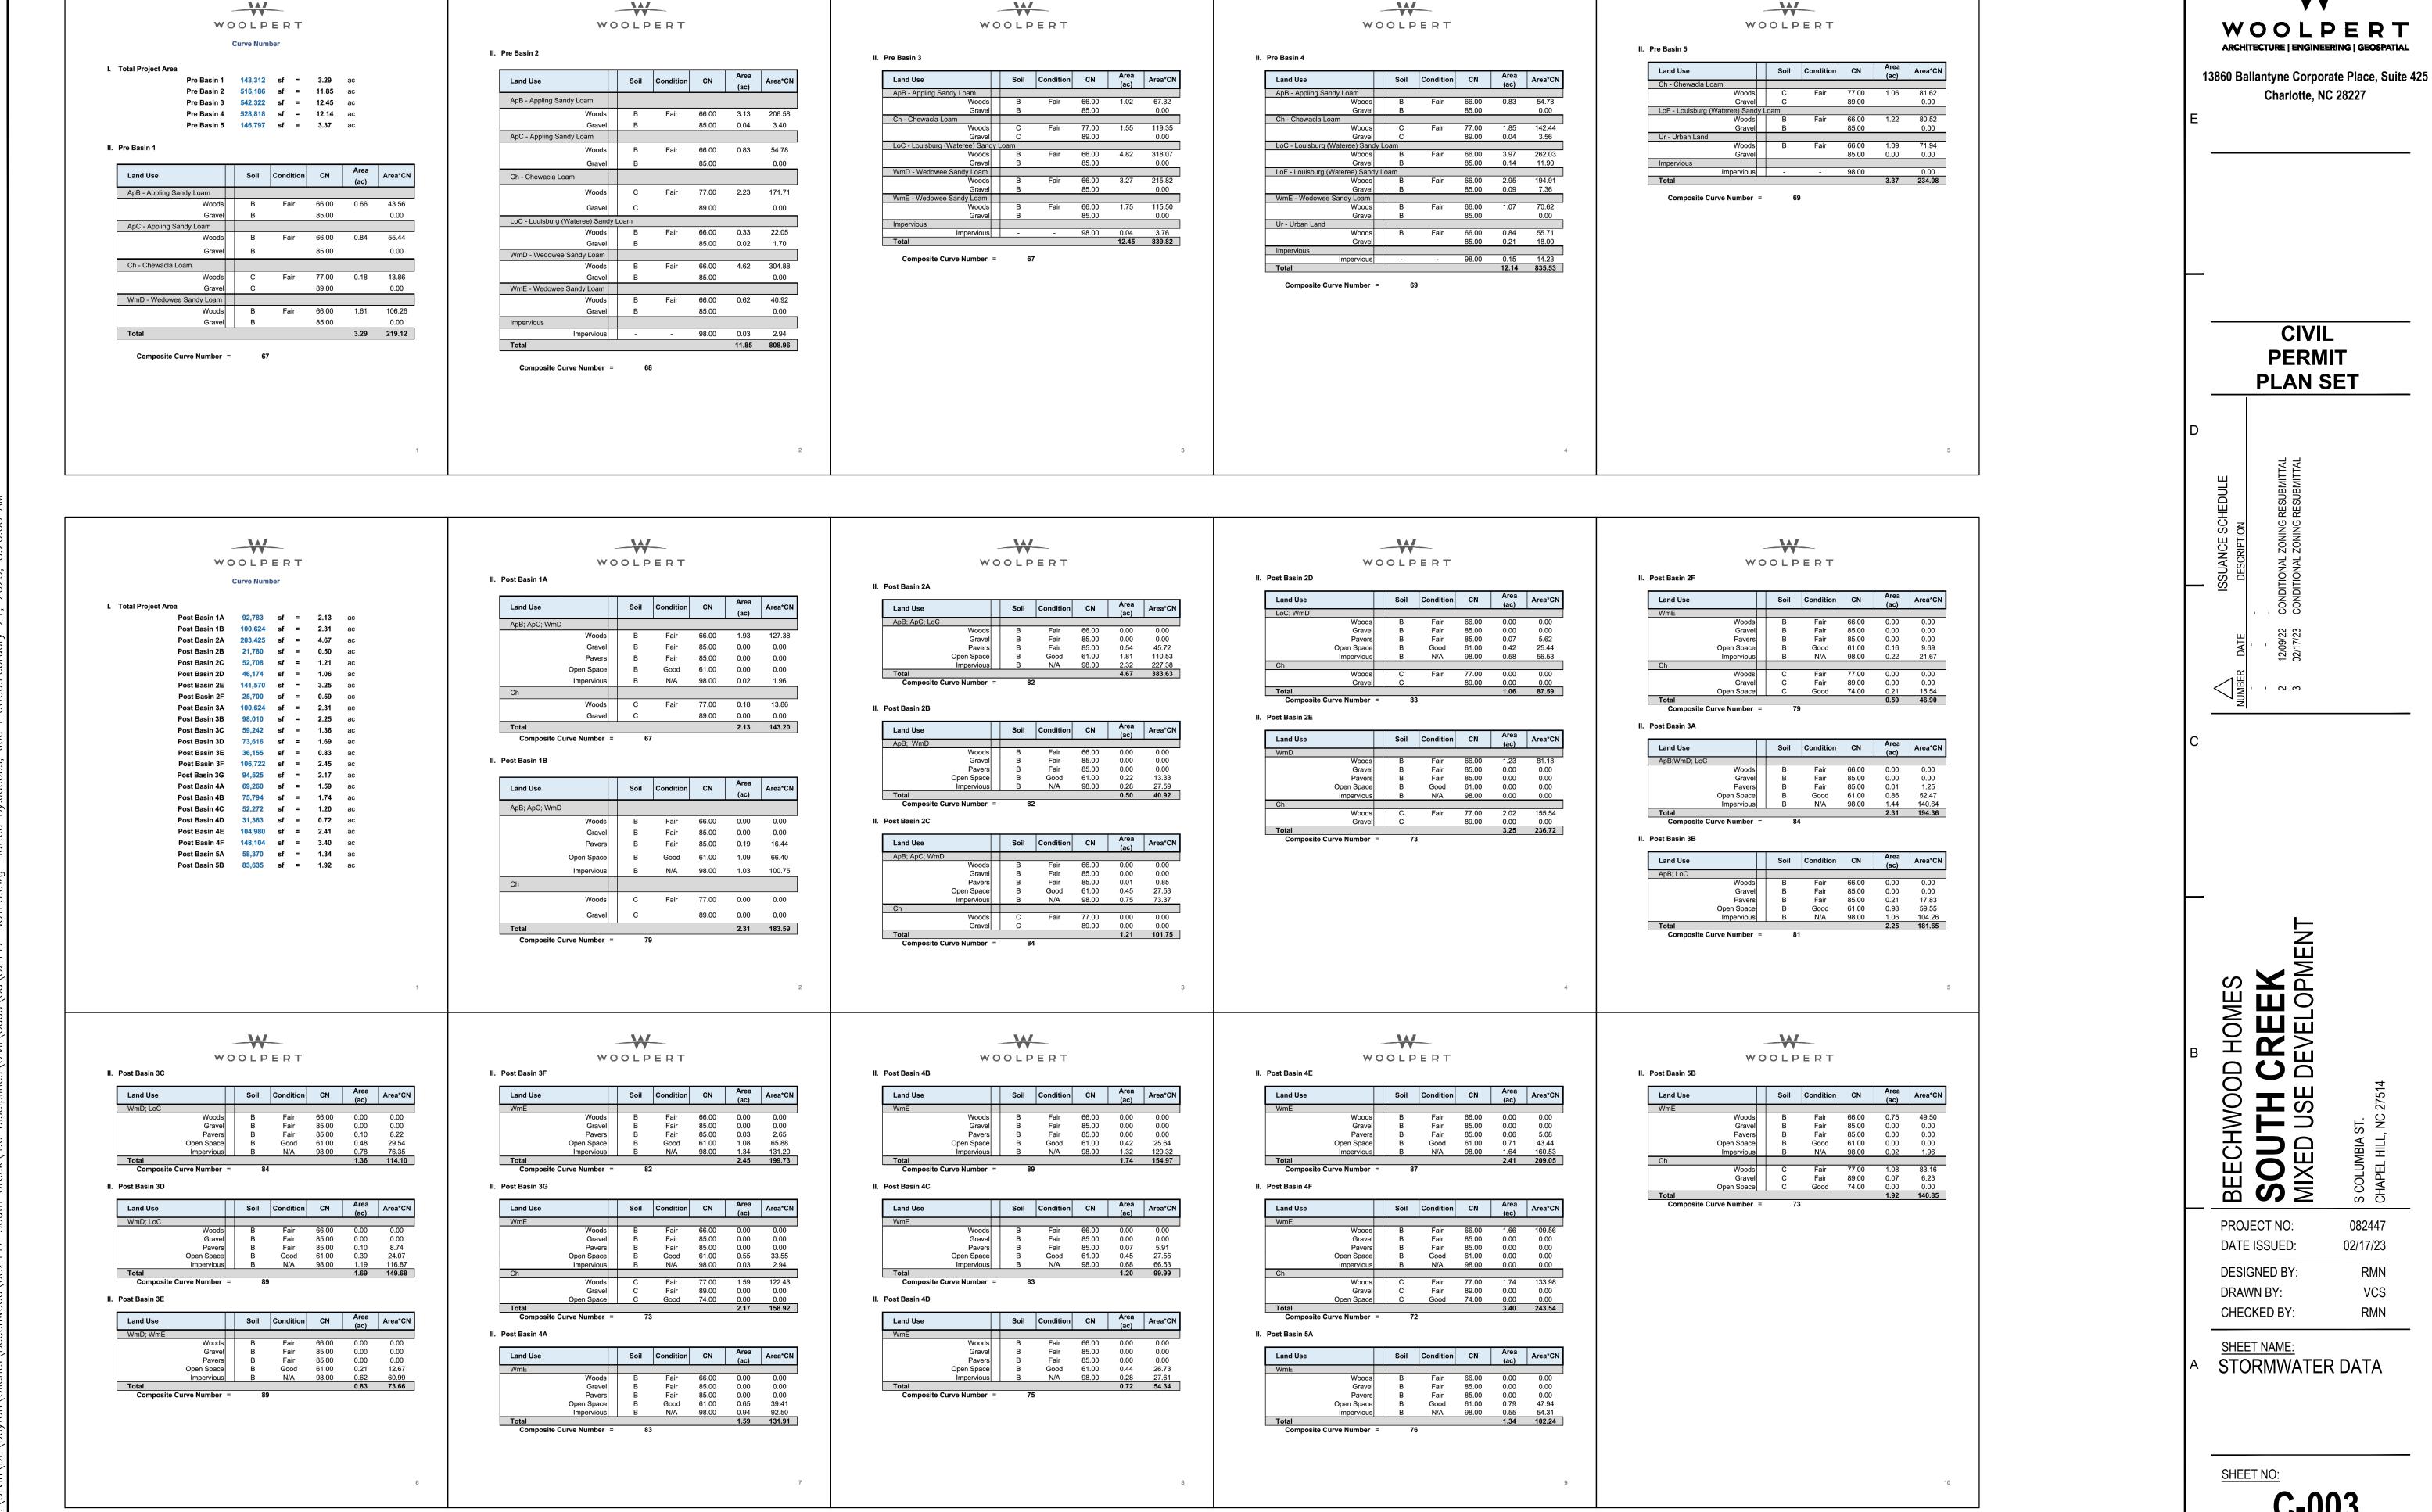

C-003

2. THE CONTRACTOR SHALL BE FAMILIAR WITH THE DRAWINGS, THE SITE'S EXISTING CONDITIONS, AND ANY DIFFICULTIES LIKELY TO BE ENCOUNTERED IN THE CONSTRUCTION OF THIS PROJECT.

3. THE CONTRACTOR SHALL PROVIDE ALL PERMITS AND LICENSES, AND PAY ALL CHARGES AND FEES NECESSARY FOR THE CONSTRUCTION OF THE PROJECT AS DETAILED IN THIS SET OF CONSTRUCTION DOCUMENTS. REQUIRED PRE-CONSTRUCTION MEETINGS SHALL BE SECURED, OR HELD PRIOR TO COMMENCEMENT OF CONSTRUCTION.

4. EXISTING UNDERGROUND UTILITIES ARE SHOWN IN THEIR APPROXIMATE LOCATIONS ACCORDING TO THE BEST AVAILABLE INFORMATION. THE CONTRACTOR SHALL HAVE INQUIRY OF THE LOCAL GAS, TELEPHONE, ELECTRIC, AND PETROLEUM CARRIERS TO DETERMINE IF THEY HAVE UNDERGROUND UTILITIES IN THE AREA OF WORK UNDER THIS CONTRACT. THE CONTRACTOR SHALL CONTACT NC811 (www.nc811.org) 48 HOURS PRIOR TO COMMENCING CONSTRUCTION OF SITE.

5. ROADS, SIDEWALKS, AND OTHER APPURTENANCES DAMAGED DURING CONSTRUCTION SHALL BE RESTORED, RECONSTRUCTED, REPLACED, OR PROTECTED BY THE CONTRACTOR AT HIS EXPENSE. ALL DAMAGES TO EXISTING IMPROVEMENTS, EXCAVATION, AND/OR REMOVAL OF ANY AND ALL EXISTING IMPROVEMENTS SHALL BE KEPT TO A MINIMUM AND RESTORED OR REPLACED TO AT LEAST THEIR ORIGINAL CONDITION.

6. ALL WORK PERFORMED ON THIS PROJECT SHALL CONFORM TO ALL APPLICABLE SECTIONS OF THE NORTH CAROLINA DEPARTMENT OF TRANSPORTATION (NCDOT) "STANDARD SPECIFICATIONS FOR HIGHWAY CONSTRUCTION", "STANDARD DRAWINGS FOR ROAD CONSTRUCTION", LATEST EDITION, PROJECT PLANS AND SPECIFICATIONS, AND ALL APPLICABLE REQUIREMENTS OF TOWN OF CHAPEL HILL AND ORANGE COUNTY STANDARD SPECIFICATIONS. ALL PRIVATE WATER DISTRIBUTION AND SANITARY SEWER SHALL BE CONSTRUCTED IN ACCORDANCE WITH THE TOWN OF CHAPEL HILL STANDARDS UNLESS OTHERWISE APPROVED.

7. THE CONTRACTOR SHALL BE PROVIDED WITH THE ELECTRONIC DRAWING FILES FOR CONSTRUCTION STAKING AND LAYOUT. THE FILES PROVIDED WILL BE IN AUTOCAD CIVIL 3D 2020 FORMAT. IT IS THE CONTRACTOR'S RESPONSIBILITY TO COORDINATE AND VERIFY ACCURACY IN THE FIELD.

8. ALL CONSTRUCTION STAKING SHALL BE THE RESPONSIBILITY OF THE CONTRACTOR. CONTRACTOR SHALL VERIFY ALL CONTROL POINTS PRIOR TO PERFORMING ANY WORK.

9. CONTRACTOR SHALL COORDINATE ALL CONSTRUCTION WITH INFRASTRUCTURE AND RETAINING WALL CONSTRUCTION.

10. PRIOR TO COMMENCEMENT OF CONSTRUCTION, THE CONTRACTOR SHALL VERIFY ALL DIMENSIONS AND CONDITIONS AFFECTING WORK WITH THE ACTUAL CONDITIONS AT THE JOB SITE. IN ADDITION, THE CONTRACTOR SHALL VERIFY THE ENGINEER'S LINES AND GRADES. IF THERE ARE ANY DISCREPANCIES FROM WHAT IS SHOWN ON THE CONSTRUCTION PLANS AND/OR SPECIFICATIONS, THE CONTRACTOR SHALL SECURE WRITTEN INSTRUCTION FROM THE ENGINEER PRIOR TO PROCEEDING WITH ANY PART OF THE WORK AFFECTED BY THE DISCREPANCY. FAILING TO SECURE SUCH INSTRUCTION, THE CONTRACTOR WILL BE CONSIDERED TO HAVE PROCEEDED AT HIS OWN RISK AND EXPENSE.

11. CONTRACTOR IS RESPONSIBLE FOR PROTECTION OF ALL PROPERTY CORNERS AND REPLACING ALL SURVEY PINS AND/OR MARKERS DISTURBED OR DAMAGED DURING CONSTRUCTION.

12. CONTRACTOR SHALL PROVIDE ALL MEASURES NECESSARY TO PREVENT PUBLIC FROM ENTERING THE WORK AREA. CONTRACTOR SHALL PHASE WORK AS NECESSARY TO MAINTAIN VEHICULAR ACCESS TO EXISTING RESIDENCES ALONG WORK

13. CONTRACTOR IS RESPONSIBLE FOR REPLACEMENT OF ALL EXISTING OR NEW PAVEMENT DAMAGED DURING CONSTRUCTION. REPAIR OF ANY DAMAGED PAVEMENTS SHALL COMPLY WITH THE ROADWAY OWNER'S STANDARDS.

14. THE USE OF EXPLOSIVES AND BURNING OF DEBRIS ON SITE IS PROHIBITED

15. CONTRACTOR, OR CONTRACTOR SURVEYOR, SHALL PREPARE AS-BUILT DRAWINGS UPON COMPLETION OF CONSTRUCTION. AS-BUILT DRAWINGS SHALL NOTE ANY DEVIATIONS FROM THE PROPOSED LOCATIONS AND/OR ELEVATIONS SHOWN ON THESE PLANS. CONTRACTOR SHALL PROVIDE AS-BUILT DRAWINGS, SIGNED AND SEALED BY A LICENSED SURVEYOR, INDICATING RIMS, TOP OF GRATES, AND INVERTS OF ALL STORM DRAINAGE, WATER LINES, AND SANITARY SEWER SYSTEM AS WELL AS AN AS-BUILT OF ALL MODIFICATIONS TO THE FOREBAY OF THE ABOVE-GROUND DETENTION FACILITIES. AS-BUILTS SHALL BE DETAILED ENOUGH TO VERIFY CONFORMANCE OF CONSTRUCTION WITH THE APPROVED CONSTRUCTION PLANS. TO INCLUDE FINISH ELEVATION OF THE CENTERLINE AND EDGE OF TRAVEL LANE AT 100 FOOT INCREMENTS ALONG THRU ROADWAY AND AS NECESSARY TO DETAIL BOTH TRUCK WELL AND TRUCK TURN-AROUND.

16. CONTRACTOR SHALL ADHERE TO ANY TECHNICAL SPECIFICATIONS, GEO-TECHNICAL REPORT, AND/OR PROJECT BID MANUAL ISSUED FOR THIS PROJECT.

17. WHEN A CONFLICT EXISTS BETWEEN PLANS, TECHNICAL SPECIFICATIONS, GEO-TECHNICAL REPORT, OR PROJECT BID MANUAL, THE CONTRACTOR SHALL NOTIFY THE ENGINEER OF RECORD. THE ENGINEER SHALL DECIDE WHICH GOVERNS. GENERALLY, THE MORE RESTRICTIVE, MORE SPECIFIC, OR STRICTER PROVISION SHALL GOVERN. IF ANY DISCREPANCIES ARE DISCOVERED BETWEEN ANY OF THE AFOREMENTIONED DOCUMENTS, THE CONTRACTOR SHALL NOTIFY THE ENGINEER AND OBTAIN CLARIFICATION OF THE INTENT FROM THE ENGINEER PRIOR TO CONSTRUCTION OR INSTALLATION OF PROPOSED IMPROVEMENTS.

18. CONTRACTOR SHALL MAKE WORK AVAILABLE FOR TESTING AND INSPECTION BY OWNER AND OWNER'S REPRESENTATIVES.

19. PROVIDE SAFETY PRECAUTIONS TO PREVENT THE PUBLIC FROM BEING INJURED AND SECURE JOB SITE DAILY. CONTRACTOR SHALL ABIDE BY ALL OSHA REGULATIONS.

20. THE PORTION OF THE SITE TO BE DEVELOPED IS LOCATED WITHIN FLOOD ZONE X AS DEFINED BY FEMA FIRM COMMUNITY PANEL No. 3710978700K EFFECTIVE 17 NOVEMBER 2017.

Demolition Notes

1. THE CONTRACTOR SHALL CONTACT THE OWNER/ARCHITECT UPON COMPLETION OF THE LAYOUT OF THE CONSTRUCTION LIMITS AND FLAGGING OF THE CLEARING LIMITS FOR APPROVAL.

2. CONTRACTOR SHALL PROPERLY NOTIFY AND COORDINATE DEMOLITION WITH OWNER PRIOR TO COMMENCEMENT.

3. THE CONTRACTOR SHALL MAKE EVERY EFFORT TO CONFINE DISTURBED AREAS TO A MINIMUM. ALL TREES AND OTHER VEGETATION SHALL REMAIN UNLESS SHOWN OTHERWISE ON THE DRAWINGS OR THEIR REMOVAL IS AUTHORIZED BY THE OWNER. ALL AREAS DISTURBED BY THE CONTRACTOR DURING CONSTRUCTION SHALL BE SEEDED.

4. COORDINATE WITH UTILITY COMPANIES FOR CONFIRMATION OF ACTIVE LINES AND SHUT-OFF OF SERVICES AS NECESSARY (NC811, www.nc811.org). DEMOLISH AND COMPLETELY REMOVE FROM SITE, EXISTING UNDERGROUND UTILITIES INDICATED TO BE REMOVED.

5. WITH THE EXCEPTION OF EXISTING FOUNDATIONS AS MAY BE PRESENT WITHIN THE SITE LIMITS, UTILITIES OR STRUCTURES NOT DESIGNATED FOR REMOVAL OR MODIFICATION ARE TO REMAIN AND BE PROTECTED FROM DAMAGE. EXISTING FOUNDATIONS AS MAY BE ENCOUNTERED WITHIN THE SITE LIMITS DURING EARTHWORK OPERATIONS SHALL BE BROUGHT TO THE ATTENTION OF THE OWNER AND GEOTECHNICAL ENGINEER.

6. ALL STRUCTURES/UTILITIES DESIGNATED FOR MODIFICATION SHALL BE PROTECTED BY THE CONTRACTOR DURING CONSTRUCTION.

7. REMOVE ALL CLEARING WASTE FROM THE SITE AND DISPOSE OF THESE MATERIALS IN A MANNER ACCEPTABLE TO NCDEQ AND THE TOWN OF CHAPEL HILL.

8. ANY EXISTING PAVEMENTS NOTED TO BE REMOVED FROM THE SITE SHALL BE PROPERLY DISPOSED OF IN A LEGAL MANNER.

CONSTRUCTION OPERATIONS.

10. SALVAGEABLE FILL MATERIALS FROM SITE DEMOLITION DETERMINED TO BE ACCEPTABLE BY AND INDEPENDENT SOILS

TESTING LABORATORY SHALL BE UTILIZED FOR FILL MATERIAL WHERE APPROPRIATE.

CONTRACTOR SHALL REMOVE FROM THE SITE AND DISPOSE OF LEGALLY, ALL MATERIALS AND DEBRIS WHICH RESULT FROM

11. CONTRACTOR SHALL LEAVE THE SITE IN A NEAT AND ORDERLY CONDITION.

Layout Notes

1. ALL DIMENSIONS, STATIONING, COORDINATES, ELEVATIONS, ETC. SHOWN ON THESE PLANS ARE IN FEET UNLESS OTHERWISE NOTED. DIMENSIONS SHOWN HEREON ARE HORIZONTAL GROUND DISTANCES.

2. BEARINGS AND ELEVATIONS SHOWN HEREON ARE BASED UPON THE NAD83 HORIZONTAL AND NAVD88 VERTICAL DATUM RESPECTIVELY OF THE NORTH CAROLINA GRID SYSTEM.

3. ALL DIMENSIONS AND COORDINATES IN CURBED AREAS SHALL BE FACE OF CURB TO FACE OF CURB UNLESS OTHERWISE NOTED. ALL DIMENSIONS AND COORDINATES IN AREAS WITHOUT CURB SHALL BE TO EDGE OF PAVEMENT. ALL DIMENSIONS FROM BUILDING SHALL BE FROM FACE OF BUILDING, UNLESS OTHERWISE NOTED.

4. ALL RADII SHALL BE TO FACE OF CURB IN CURBED AREAS AND TO EDGE OF PAVEMENT IN PAVED AREAS WITHOUT CURBS UNLESS OTHERWISE NOTED.

5. PROVIDE SMOOTH TRANSITION FROM NEW AREAS TO EXISTING FEATURES AS NECESSARY.

6. ACCESSIBLE RAMPS AND SIGNAGE SHALL BE IN ACCORDANCE WITH FEDERAL, STATE, AND LOCAL CODES, WHICHEVER HAS JURISDICTION.

. SEE PLAN FOR LOCATION AND SITE DETAILS. SPECIFICATIONS AND APPLICABLE STANDARDS MAY BE REFERENCED OR UNDERSTOOD AS APPLICABLE.

8. ALL PAVEMENT MARKINGS SHALL BE IN ACCORDANCE WITH NCDOT STANDARDS UNLESS OTHERWISE NOTED.

9. CONTRACTOR TO COORDINATE WITH UTILITY FOR INSTALLATION OF PARKING LOT LIGHTING.

10. ALL PARKING LOT SPACES, ACCESSIBLE SPACES, CROSSWALKS, AND TRAFFIC MARKINGS SHALL BE AS INDICATED ON THE SITE PLAN AND/OR DETAILS.

11. SUBMIT ALL SHOP DRAWINGS TO THE ENGINEER/ARCHITECT OF RECORD REVIEW AND APPROVAL.

12. REFER TO THE PROPOSED PLAT PREPARED BY MSS LAND CONSULTANTS FOR SUPPLEMENTAL INFORMATION AND LOT DESCRIPTIONS.

Grading Notes

1. PRIOR TO ANY GRADING, THE CONTRACTOR SHALL CONDUCT A PRE-CONSTRUCTION MEETING WITH THE DESIGNATED REPRESENTATIVES FROM THE APPROVAL AGENCY. CONTRACTOR SHALL NOTIFY ENGINEER OF RECORD AND OWNER 48 HOURS PRIOR TO ANY PRE-CONSTRUCTION MEETING.

2. THE CONTRACTOR SHALL BE RESPONSIBLE FOR REVIEWING THE GEO-TECHNICAL REPORT PREPARED FOR THIS PROJECT. ALL EARTHWORK AND GRADING OPERATIONS SHALL COMPLY WITH RECOMMENDATIONS INCLUDED IN THE REPORT AND PER THE DIRECTION OF THE OWNER'S ON-SITE GEO-TECHNICAL REPRESENTATIVE.

3. CONTRACTOR SHALL VERIFY ADA PARKING DOES NOT EXCEED 2% SLOPE IN ANY DIRECTION. CONTRACTOR SHALL VERIFY ALL ACCESSIBLE ROUTES SHALL MEET ALL STATE AND FEDERAL ADA STANDARDS.

4. CONTRACTOR SHALL BE RESPONSIBLE FOR ADJUSTING ALL EXISTING CATCH BASINS, MANHOLES, AND OTHER STRUCTURES TO GRADE, AS REQUIRED.

5. ELEVATIONS SHOWN REFER TO FINISHED GRADE, UNLESS NOTED OTHERWISE. FINISH GRADE ELEVATIONS FOR STRUCTURES WITH FRAME, GRATE AND HOOD SHALL BE THE EDGE OF PAVEMENT.

6. CLEARING AND GRUBBING LIMITS SHALL BE LIMITED TO AREAS NECESSARY FOR SITE CONSTRUCTION AND AS INDICATED ON PLANS.

7. ALL EXISTING VEGETATION AND TOPSOIL SHALL BE REMOVED FROM WITHIN THE LIMITS OF CONSTRUCTION PRIOR TO PLACING

8. GRADING SHALL BE WITHIN 0.1 FEET OF PLAN SUBGRADE IN ALL PAVED AREAS. GRADING SHALL BE WITHIN 0.12 FEET OF PLAN GRADE IN ALL OTHER AREAS. POSITIVE DRAINAGE SHALL BE MAINTAINED IN ALL AREAS.

FILL AREAS SHALL BE PROOF ROLLED AND APPROVED BY THE GEO-TECHNICAL ENGINEER PRIOR TO THE PLACEMENT OF ANY FILL MATERIALS. AREAS NOT PASSING A PROOF-ROLL OR THAT ARE OTHERWISE UNACCEPTABLE TO THE GEO-TECHNICAL ENGINEER SHALL BE REMOVED OR STABILIZED IN ANOTHER APPROVED MANNER PRIOR TO THE PLACEMENT OF FILL MATERIALS. ALL SUBGRADES MUST BE PROOF-ROLLED PRIOR TO THE PLACEMENT OF CURB AND GUTTER OR PAVEMENT.

10. THE CONTRACTOR SHALL SCHEDULE AND COORDINATE WITH THE GEO-TECHNICAL ENGINEER TO PERFORM COMPACTION TESTS. COMPACTION TESTS SHALL BE PERFORMED AND DOCUMENTED FOR EACH FILL LIFT. LIFTS IN FILL AREAS SHALL NOT EXCEED 8" IN LOOSE DEPTH, AND SHALL BE REDUCED IN DEPTH IF NECESSARY TO MEET THE COMPACTION REQUIREMENTS.

11. UNLESS SPECIFIED OTHERWISE ON A DESIGN CROSS SECTION OR WITHIN THE RECOMMENDATIONS OF THE GEO-TECHNICAL REPORT FOR THE PROJECT, COMPACTION OF SUBGRADE SURFACES SHALL BE AS FOLLOWS: WALKWAYS, PAVEMENTS BELOW 12 INCHES OF SUBGRADE, OUTPARCELS, AND TRENCHES: 95% STANDARD PROCTOR DENSITY (ASTM D698); LAWN OR UNIMPROVED AREAS: 90%; BUILDING AND PAVEMENT SUBGRADES (TOP 12 INCHES).

12. IF APPLICABLE, GRADING AND COMPACTION WITHIN STATE ROAD RIGHT-OF-WAY, BIO-RETENTION BANKS & DETENTION AREA BANKS & SLOPES SHALL BE PER THE SPECIFICATIONS FOR EMBANKMENT CONSTRUCTION, NORTH CAROLINA DEPARTMENT OF TRANSPORTATION.

13. ON-SITE STRUCTURAL FILL MATERIALS SHALL CLASSIFY AS GM, GC, SW, SP, SM, SC, CL, AND/OR ML IN ACCORDANCE WITH ASTM D2487. IMPORTED STRUCTURAL FILL MATERIALS SHALL BE PER THE GEO-TECHNICAL REPORT.

14. FILL MATERIALS CLASSIFYING AS OL, CH, MH, OH, OR PT ARE CONSIDERED UNSUITABLE FILL MATERIALS AND SHALL NOT BE USED AS STRUCTURAL FILL, PARTICULARLY WITHIN THE STRUCTURAL LIMITS OF ANY BUILDINGS OR PAVEMENT SECTIONS. WHERE UNSUITABLE FILL MATERIAL IS ENCOUNTERED IN AREAS TO RECEIVE STRUCTURAL FILL, THE CONTRACTOR SHALL REMOVE ALL UNSUITABLE MATERIALS AND BACKFILL WITH STRUCTURAL FILL.

15. DE-WATERING AND DRYING OF AREAS TO BE EXCAVATED OR FILLED SHALL BE THE RESPONSIBILITY OF THE CONTRACTOR.

16. CONTRACTOR SHALL EXERCISE CAUTION WHEN CONDUCTING FILL OPERATIONS IN AREAS OF PROPOSED AND EXISTING UTILITIES. LARGE ROCKS OR BOULDERS SHALL NOT BE PLACED ON TOP OF UTILITY LINES OR WITHIN UTILITY TRENCHES.

17. CURB AND GUTTER SHALL "SHED" INSTEAD OF "CATCH" WITHIN THE GUTTER PAN WHEN USED ON THE HIGH SIDE OF THE ROADWAY OR GRADED AWAY FROM THE FACE OF CURB.

Traffic Control Notes

1. CONTRACTOR SHALL BE RESPONSIBLE FOR THE INSTALLATION AND MAINTENANCE OF ADEQUATE SIGNS, TRAFFIC CONTROL DEVICES, AND WARNING DEVICES TO INFORM AND PROTECT THE PUBLIC DURING ALL PHASES OF CONSTRUCTION.

2. TRAFFIC CONTROL DURING CONSTRUCTION SHALL BE PROVIDED BY THE CONTRACTOR AND MAINTAINED IN ACCORDANCE WITH THE MANUAL OF UNIFORM TRAFFIC CONTROL DEVICES (MUTCD), LATEST EDITION, AND/OR THE APPLICABLE STATE AND LOCAL REQUIREMENTS. THE CONTRACTOR SHALL PROVIDE ALL NECESSARY STANDARD CONSTRUCTION WARNING SIGNS, BARRICADES, DRUMS, OR OTHER TRAFFIC HANDLING DEVICES AS REQUIRED BY MUTCD.

OWASA Pool Notes

1. PERMIT FROM OWASA WILL BE OBTAINED TO DISCHARGE BACKWASH TO THE SANITARY SEWER SYSTEM.

Storm Drainage Notes

1. THE DESIGN STORM DRAINAGE PIPE IS CLASS III REINFORCED CONCRETE PIPE WITH TONGUE AND GROOVE JOINTS MEETING ASTM C76 UNLESS OTHERWISE NOTED ON THE PLAN. DEVIATION SHALL BE APPROVED IN WRITING BY OWNER WITH NOTIFICATION TO AND APPROVAL BY THE ENGINEER OF RECORD. SHOULD CONTRACTOR ELECT TO USE HDPE OR CORRUGATED METAL THE DESIGN INVERT ELEVATION MAY REQUIRE REVISION. STORM DRAIN PIPE EXCEEDING 20' IN FILL HEIGHT SHALL BE CLASS IV RCP; STORM DRAIN PIPE EXCEEDING 30' IN FILL HEIGHT SHALL BE CLASS V RCP. REFER TO NC DOT STD DWG NO. 300.01 FOR ADDITIONAL INFORMATION.

2. ALL DRAINAGE PIPE NOTED AS HDPE SHALL BE ADVANCED DRAINAGE SYSTEM N-12 OR EQUAL

3. ALL DRAINAGE STRUCTURES SHALL MEET THE SPECIFICATIONS OF THE NCDOT STANDARD DRAWINGS, SECTION 838 AND 840, LATEST EDITION.

4. TOP OF GRATE AND RIM ELEVATIONS INDICATED FOR DROP INLETS AND MANHOLES ARE AT THE CENTER OF THE GRATE OR COVER. RIM ELEVATIONS INDICATED FOR CURB INLETS HAVING A FRAME, GRATE AND HOOD SHALL BE THE ADJACENT EDGE OF PAVEMENT ELEVATION.

5. ALL PIPES ENTERING STORM STRUCTURES SHALL BE GROUTED TO ASSURE THE CONNECTION IS WATERTIGHT.

6. THE JOINTS OF ALL DRAINAGE PIPE LYING WITHIN OR WITHIN 5' OF THE GEOGRID REINFORCEMENT ZONE SHALL BE WRAPPED WITH MIRAFI 140N OR EQUIVALENT.

7. ALL FIELD TILE ENCOUNTERED SHALL BE REPLACED AND/OR CONNECTED TO THE STORM SEWER SYSTEM AND LOCATED AND IDENTIFIED ON "AS-BUILT" PLANS BY THE CONTRACTOR.

8. 2" WEEP HOLES & STONE DRAINS SHALL BE INSTALLED AT ALL DROP INLETS AND CURB INLETS.

9. STORM MANHOLES SHALL BE SET SUCH THAT THE MANHOLE TOP IS FLUSH WITH ADJACENT GRADES.

10. FOUNDRY FRAME, GRATE AND HOOD IDENTIFIED FOR REFERENCE. CONTRACTOR MAY USE APPROVED EQUAL WITH ENGINEER'S APPROVAL.

11. CONTRACTOR SHALL BE REQUIRED TO CLEAN PROPOSED AND EXISTING DRAINAGE SYSTEMS PRIOR TO ACCEPTANCE BY

Erosion & Sediment Control Notes

1. A LAND DISTURBANCE PERMIT WILL BE REQUIRED PRIOR TO THE COMMENCEMENT OF ANY LAND DISTURBING ACTIVITY.

2. THE EROSION CONTROL PLAN SHALL BE IMPLEMENTED ON ALL DISTURBED AREAS WITHIN THE CONSTRUCTION SITE. PLEASE REFER TO THE C-300 SERIES FOR THE ANTICIPATED LIMITS OF DISTURBANCE. GRADING BEYOND THE LIMITS SHOWN ON THE PLAN IS A VIOLATION OF THE NCDEQ EROSION CONTROL ORDINANCE AND IS SUBJECT TO A FINE.

3. NO ONSITE BURIAL PITS SHALL BE PERMITTED. OFFSITE SOIL SPOIL AND/OR BORROW SITE IS NOT INCLUDED IN THE LAND DISTURBANCE ACREAGE. IF AN OFFSITE SOIL SPOIL OR BORROW IS UTILIZED BY SITE CONTRACTOR, PLEASE NOTIFY THE ENGINEER OR RECORD AND TOWN OF CHAPEL HILL IMMEDIATELY. ADDITIONAL DISTURBED AREA FOR SPOIL AND/OR BORROW MUST BE INCLUDED IN THE LAND DISTURBANCE PLAN AND PERMIT UNLESS THE ADDITIONAL AREA IS ALREADY INCLUDED IN AN EXISTING PERMIT AREA.

4. ALL MEASURES INVOLVING EROSION CONTROL PRACTICES SHALL BE INSTALLED UNDER THE GUIDANCE OF QUALIFIED PERSONNEL EXPERIENCED IN EROSION CONTROL, AND FOLLOWING THE PLANS AND SPECIFICATIONS INCLUDED HEREIN. REFER TO THE PLAN SHEET FOR SEQUENCE OF IMPLEMENTATION.

5. EXISTING VEGETATION SHALL BE PROTECTED. IF TREE PROTECTION IS REQUIRED BY THE TOWN OF CHAPEL HILL, A TREE PROTECTION CERTIFICATION MUST BE SUBMITTED TO THE TOWN, AND ALL EROSION CONTROL AND SLOPE CONTROL PRACTICES SHALL BE IN ACCORDANCE WITH THE NORTH CAROLINA DEPARTMENT OF ENVIRONMENTAL QUALITY.

6. ALL EROSION CONTROL DEVICES SHALL BE PROPERLY MAINTAINED DURING ALL PHASES OF CONSTRUCTION UNTIL ALL LAND DISTURBING AND CONSTRUCTION ACTIVITIES HAVE CEASED. ALL TEMPORARY CONTROL DEVICES SHALL BE REMOVED ONCE CONSTRUCTION IS COMPLETE AND THE SITE IS STABILIZED.

7. THE CONTRACTOR SHALL CONTROL WASTES, GARBAGE, DEBRIS, WASTEWATER, AND OTHER SUBSTANCES ON THE SITE IN SUCH A WAY THAT THEY SHALL NOT BE TRANSPORTED FROM THE SITE BY THE ACTION OF WINDS, STORM WATER RUNOFF, OR OTHER FORCES. PROPER DISPOSAL AND MANAGEMENT OF ALL WASTES AND UNUSED BUILDING MATERIAL, APPROPRIATE TO THE NATURE OF THE WASTES AND MATERIALS IS REQUIRED. COMPLIANCE IS REQUIRED WITH ALL APPLICABLE REGULATIONS REGARDING WASTE DISPOSAL.

8. THE CONTRACTOR SHALL STOCKPILE TOPSOIL FOR USE IN FINAL LANDSCAPING. THE LOCATION OF THE STOCKPILE AREA SHALL BE DETERMINED BY THE CONTRACTOR AND APPROVED BY THE OWNER AND ENGINEER OF RECORD AND ALL NECESSARY EROSION AND SEDIMENTATION PREVENTION MEASURES SHALL BE IMPLEMENTED.

9. IT IS THE RESPONSIBILITY OF THE CONTRACTOR TO REMOVE ALL MUD, DIRT, GRAVEL, AND ANY OTHER MATERIALS TRACKED ONTO ANY PUBLIC OR PRIVATE STREETS, SIDEWALKS, OR RIGHTS-OF-WAY. THE CONTRACTOR MUST USE WATER OR OTHER METHODS TO KEEP AIRBORNE DUST TO A REQUIRED MINIMUM.

10. INLET PROTECTION SHALL BE INSTALLED AND MAINTAINED AROUND ALL STORM DRAINAGE INLETS.

11. CONTRACTOR SHALL REMOVE ACCUMULATED SEDIMENT FROM ALL UTILITY STRUCTURES PRIOR TO FINAL SITE STABILIZATION. AT COMPLETION OF CONSTRUCTION, THE CONTRACTOR SHALL COORDINATE THE TRANSFER OF MAINTENANCE RESPONSIBILITIES OF ANY PERMANENT SEDIMENT CONTROL STRUCTURES WITH THE OWNER. MAINTENANCE OF ALL STRUCTURES SHALL BE IN ACCORDANCE WITH NORTH CAROLINA EROSION AND SEDIMENT CONTROL PLANNING AND DESIGN MANUAL.

12. ALL TEMPORARY EROSION AND SEDIMENT CONTROL PRACTICES SHALL BE REMOVED AND DISPOSED OF WITHIN THIRTY DAYS AFTER FINAL SITE STABILIZATION IS ACHIEVED, OR AFTER THE TEMPORARY PRACTICES ARE NO LONGER NEEDED. ACCUMULATED SEDIMENT SHALL BE PERMANENTLY STABILIZED OR PROPERLY DISPOSED.

13. PROVIDE SILT FENCE AND/OR OTHER CONTROL DEVICES, AS MAY BE REQUIRED, TO CONTROL SOIL EROSION DURING UTILITY CONSTRUCTION. ALL DISTURBED AREAS SHALL BE CLEANED, GRADED, AND STABILIZED IMMEDIATELY AFTER THE UTILITY INSTALLATION.

14. THE APPROVED EROSION AND SEDIMENT CONTROL PLAN MUST BE RETAINED ON-SITE AT ALL TIMES DURING THE PERIOD OF CONSTRUCTION.

15. ADDITIONAL MEASURES TO CONTROL EROSION AND SEDIMENT MAY BE REQUIRED BY A REPRESENTATIVE OF THE NCDEQ, THE TOWN OF CHAPEL HILL OR THE ENGINEER OF RECORD.

16. SLOPES SHALL BE GRADED NO STEEPER 3:1. FILL SLOPES GREATER THAN 10' REQUIRE ADEQUATE TERRACING.

17. AN INSPECTION IS REQUIRED PRIOR TO CONVERTING BASINS USED DURING CONSTRUCTION PHASE TO STORMWATER FACILITIES.

18. CONTRACTOR SHALL BE RESPONSIBLE FOR CORRECTING ANY EROSION AND SEDIMENTATION THAT MAY OCCUR DURING OR AFTER CONSTRUCTION TO INCLUDE NECESSARY REPAIRS TO EXISTING CONDITIONS OUTSIDE THE LIMITS OF CONSTRUCTION UNTIL SUCH TIME THAT FINAL STABILIZATION IS DEEMED ACCEPTABLE BY NCDEQ AND ENGINEER OF RECORD. REFER TO THE NC EROSION AND SEDIMENT CONTROL PLANNING AND DESIGN MANUAL FOR ADDITIONAL INFORMATION.

19. SKIMMER SHALL BE MAINTAINED IN GOOD OPERATING CONDITION DURING CONSTRUCTION.

20. SEDIMENT SHALL BE REMOVED / HAULED FROM THE SITE UNLESS AN APPROVED ON-SITE LOCATION IS IDENTIFIED BY THE OWNER. REMOVAL AND HAULING SHALL BE AT NO ADDITIONAL COST TO THE OWNER.

21. ALL DISTURBED AREAS SHALL RECEIVE TEMPORARY SEED AND STRAW IN ACCORDANCE WITH NCDEQ SCHEDULE.

22. REFER TO EROSION CONTROL PHASING PLANS AND SEQUENCING ON THE SHEET _____ FOR ADDITIONAL INFORMATION.

WOOLPERT

ARCHITECTURE | ENGINEERING | GEOSPATIAL

13860 Ballantyne Corporate Place, Suite 425 Charlotte, NC 28227

ISSUANCE SCHEDULE

NUMBER DATE DESCRIPTION

0 07/22/22 CONDITIONAL ZONING RESUBMITTAL
1 10/05/22 CONDITIONAL ZONING RESUBMITTAL
2 12/09/22 CONDITIONAL ZONING RESUBMITTAL
3 02/17/23 CONDITIONAL ZONING RESUBMITTAL
3 02/17/23 CONDITIONAL ZONING RESUBMITTAL

BEECHWOOD HOMES
SOUTH CREEK
MIXED USE DEVELOPMENT

PROJECT NO: 082447

DATE ISSUED: 02/17/23

DESIGNED BY: RMN

DRAWN BY: VCS

CHECKED BY: RMN

SHEET NAME:

A GENERAL NOTES

C-00

4. THE CONTRACTOR SHALL OBTAIN ALL REQUIRED PERMITS PRIOR TO COMMENCEMENT OF CONSTRUCTION.

SEWER, STORM SEWER AND WATER SUPPLY LINE, UNLESS OTHERWISE INDICATED.

THE CONTRACTOR SHALL BE RESPONSIBLE FOR COORDINATING THE SEQUENCING OF CONSTRUCTION FOR ALL UTILITY LINES SO THAT WATER LINES, GAS LINES, AND UNDERGROUND ELECTRIC DO NOT CONFLICT WITH SANITARY SEWERS OR STORM SEWERS. INSTALL UTILITIES PRIOR TO PAVEMENT CONSTRUCTION.

MAINTAIN MINIMUM 10-FOOT HORIZONTAL AND MINIMUM 18-INCH VERTICAL SEPARATION BETWEEN SANITARY

7. ALL TRENCH SPOILS SHALL BECOME THE PROPERTY OF THE CONTRACTOR UNLESS OTHERWISE DESIGNATED.

. SANITARY SEWER SHALL BE <PVC-SDR 35 PER ASTM D-3034> OR APPROVED EQUAL (CONFORMING TO <NAME OF CITY OR COUNTY> WATER & SEWER DEPARTMENT RULES AND REGULATIONS) INSTALLED AT A MINIMUM SLOPE OF TWO PERCENT (2.00%) UNLESS OTHERWISE NOTED. SANITARY SERVICE SHALL BE INSTALLED AT A MINIMUM DEPTH OF FOUR FEET (4') UNLESS OTHERWISE NOTED. A MINIMUM OF 18" CLEARANCE SHALL BE MAINTAINED AT ALL WATERLINE & STORM SEWER CROSSINGS. SANITARY SERVICE JOINTS SHALL CONFORM TO ASTM D-3212.

9. SANITARY SEWER IS TO BE BEDDED WITH CLEAN GRANULAR MATERIAL-AGGREGATES <NOT TO BE LARGER THAN 3/4" AND NOT SMALLER THAN NO. 8 SIEVE, FREE OF SILT AND FINES, AASHTO M43 SIZE #67, 7 OR 8. BEDDING TO BE MINIMUM OF 6" BELOW & 12"> ABOVE THE PIPE.

10. DISTANCES SHOWN FOR BOTH SANITARY AND STORM SEWER PIPES ARE MEASURED FROM CENTER OF STRUCTURE, CONTRACTOR RESPONSIBLE FOR ACTUAL FIELD CUT LENGTH. COORDINATES FOR STORM & SANITARY STRUCTURES ARE SHOWN TO THE CENTER STRUCTURE. UNLESS OTHERWISE NOTED.

11. ROOF DRAINS, FOUNDATION DRAINS AND ALL OTHER CLEAR WATER CONNECTIONS TO THE SANITARY SEWER SYSTEMS ARE PROHIBITED.

12. ADJUST ALL EXISTING UTILITY SURFACE FEATURES INCLUDING BUT NOT LIMITED TO CASTINGS, VALVE BOXES, PEDESTALS, CLEANOUTS, ETC. TO MATCH PROPOSED FINISHED GRADES, UNLESS OTHERWISE INDICATED.

13. THE CONTRACTOR SHALL PROVIDE RECORD DRAWINGS OF ALL IMPROVEMENTS. INCLUDE AT LEAST TWO DIMENSIONS TO EACH VALVE AND MANHOLE FROM KNOWN SITE FEATURES. DRAWINGS SHALL INCLUDE HORIZONTAL AND VERTICAL INFORMATION ON ALL NEW UTILITIES AS WELL AS EXISTING UTILITIES ENCOUNTERED.

14. MECHANICAL/ELECTRICAL CONTRACTORS SHALL BRING ALL UTILITIES 5' OUTSIDE BUILDING WALL. COORDINATE WITH CONSTRUCTION MANAGER/ARCHITECT/ENGINEER/OWNER.

15. ALL WATERLINE CROSSINGS SHALL MAINTAIN A VERTICAL SEPARATION OF 18" MINIMUM. SANITARY SEWER SHALL BE LOCATED A MINIMUM OF 18" BELOW WATERLINE AT ALL CROSSINGS. WATERLINE SHALL BE LOCATED A MINIMUM OF 10' HORIZONTALLY FROM ANY SANITARY SEWER OR STORM SEWER. ALL MEASUREMENTS SHALL BE TAKEN FROM OUTSIDE OF SEWER PIPE TO THE OUTSIDE OF WATERLINE PIPE. ONE FULL LENGTH OF WATERLINE PIPE SHALL BE LOCATED AT ALL CROSSINGS TO ENABLE BOTH JOINTS TO BE LOCATED AS FAR FROM SEWER AS POSSIBLE.

16. ALL WATER SERVICE PIPE SIZES 3" THRU 12" SHALL BE <DUCTILE IRON PIPE CLASS <51, 52, 53>, PVC <C-900> OR PVC <C909>> PIPE PER LOCAL JURISDICTION, FROM WATERMAIN THRU METER SETTING(S) INCLUDING THE METER BYPASS.

17. ALL WATER SERVICE PIPE, 2" AND SMALLER, SHALL BE K SOFT COPPER.

18. ALL WATER SERVICE PIPE, <2" AND SMALLER>, SHALL BE K SOFT COPPER FROM WATERMAIN THRU CURB STOP; K SOFT COPPER OR <UTILITY AGENCY / DISTRICT / MUNICIPALITY / COMPANY> APPROVED POLYTUBING FROM <CURB STOP THRU METER SETTING IN BUILDING>.

19. WATERLINE IS TO BE BEDDED WITH CLEAN GRANULAR MATERIAL-AGGREGATES <NOT TO BE LARGER THAN 3/4" AND NOT SMALLER THAN NO. 8 SIEVE, FREE OF SILT AND FINES, AASHTO M43 SIZE #67, 7 OR 8. BEDDING TO BE MINIMUM OF 6" BELOW & 12"> ABOVE THE PIPE

20. ELECTRICAL, HEATING, VENTILATION, PLUMBING, AIR CONDITIONING EQUIPMENT AND OTHER SERVICE FACILITIES SHALL BE DESIGNED, LOCATED, AND/OR ELEVATED TO PREVENT WATER FROM ENTERING OR ACCUMULATING WITHIN THE COMPONENTS DURING CONDITIONS OF FLOODING. THESE INCLUDE BUT ARE NOT LIMITED TO: HVAC EQUIPMENT, WATER SOFTENER UNITS, BATH/KITCHEN FIXTURES, DUCTWORK, ELECTRIC AND GAS METER PANELS/BOXES, UTILITY AND CABLE BOXES, APPLIANCES SUCH AS WASHERS, DRYERS, REFRIGERATORS, AND FREEZERS, HOT WATER HEATER, AND ELECTRIC OUTLET SWITCHES.

Landscape Notes

THE FOLLOWING NOTES, CONDITIONS, INCLUDING LANDSCAPE PLAN AND SPECIFICATIONS ARE TO BE STRICTLY
FOLLOWED IN ORDER TO RECEIVE A FINAL CERTIFICATE OF OCCUPANCY OR FINAL INSPECTION. ANY CHANGES IN
SPECIES, QUANTITY, OR SIZE MUST BE APPROVED PRIOR TO INSTALLATION BY THE CITY OR COUNTY LANDSCAPE
ARCHITECT. THE PLANT MATERIALS AND SIZES ARE SPECIFIED AS MINIMUMS AND WILL BE MEASURED FOR
COMPLIANCE AT THE TIME OF FINAL INSPECTION.

1. ALL DISTURBED AREAS NOT TO BE COVERED BY IMPERVIOUS SURFACE OR LANDSCAPING MATERIAL SHALL RECEIVE A MINIMUM OF 4" OF TOPSOIL AND BE SEEDED AND MULCHED OR SODDED AS SPECIFIED. INSTALL TEMPORARY GRASS AS NOTED ON THE EROSION CONTROL PLANS.

2. MULCH ALL AREAS UNDER AND AROUND ALL PLANTS AND ALL OTHER AREAS INDICATED ON THE PLAN WITH A 3" LAYER OF SHREDDED HARDWOOD MULCH (SUBMIT SAMPLE FOR APPROVAL).

ALL PLANTS SHALL BE DENSE, UNIFORM AND FREE OF INSECTS AND DISEASE. PLANT SELECTIONS SHALL NOT INCLUDE LOOSE, OPEN PLANTS OR OTHER "NATIVE" MATERIALS GATHERED FROM WOODLAND CONDITIONS. ALL PLANTS MEET OR EXCEED THE MINIMUM STANDARDS IN AMERICAN STANDARDS FOR NURSERY STOCK BY THE AMERICAN ASSOCIATION OF NURSERYMEN, INC. WASHINGTON, D.C. (LATEST EDITION)

4. CONTRACTOR IS RESPONSIBLE FOR WATERING DAILY AND MAINTAINING ALL LANDSCAPING, INCLUDING MATERIAL STORED ON-SITE UNTIL PROJECT IS COMPLETED. PLANT MATERIAL SHALL NOT STAY ON SITE MORE THAN 48 HOURS PRIOR TO PLANTING. PLANT STORAGE ON-SITE WILL REQUIRE THE CONTRACTOR TO HEEL IN PLANTS AND COVER ROOT BALLS WITH MULCH.

5. ALL PLANTS SHALL BE GUARANTEED TO BE IN HEALTHY CONDITION (1) YEAR AFTER ACCEPTANCE.

1. REMOVE ALL TREATED OR PLASTIC COATED BURLAP, WIRE, STRAPPING OR NYLON TWINE FROM PLANT BALL

2. INSTALL TOP OF PLANT BALL MIN. 2" / MAX 3" ABOVE FINISH GRADE.

3. SOAK PLANT BALL AND PIT IMMEDIATELY AFTER INSTALLATION

A DO NOT INSTALL DURING REPIONS OF WET OR EROZEN SOIL CONDITION

4. DO NOT INSTALL DURING PERIODS OF WET OR FROZEN SOIL CONDITIONS

SET TREES VERTICAL IN ALL DIRECTIONS.

6. STAGING AREA FOR MATERIALS ON-SITE TO BE COORDINATED WITH OWNER. NO EQUIPMENT SHALL BE STORED UNDER EXISTING VEGETATION.

 UNINSTALLED PLANT MATERIAL STORED ON SITE, AS WELL AS INSTALLED MATERIAL SHALL BE WATERED BY THE INSTALLER PER SPECIFICATIONS.

 PLANT LIST IS SUPPLIED FOR CONVENIENCE ONLY. CONTRACTOR IS RESPONSIBLE FOR ALL QUANTITIES ON THE PLAN

9. ALL DISTURBED TURF AREAS SHALL BE SCARIFIED TO A DEPTH OF 4"-6" TO PROVIDE A UNIFORM SEED BED.

Sequence of Construction

WITH ENGINEER.

THE FOLLOWING SEQUENCE OF CONSTRUCTION IS GENERAL AND COVERS MAJOR WORK ITEMS. IT IS NOT INTENDED TO LIMIT THE CONTRACTOR TO CERTAIN MEANS, METHODS AND/OR TIMES FOR DOING WORK. THE CONTRACTOR SHALL BE SOLELY RESPONSIBLE FOR SCHEDULING AND PERFORMING HIS/HER WORK. THE CONTRACTOR SHALL NOTIFY THE ENGINEER SHOULD THERE BE ANY FORESEEN SIGNIFICANT CONFLICTS WITH THE INTENT OF THIS SEQUENCE AND SHALL PROVIDE IN WRITING TO THE ENGINEER RECOMMENDATIONS FOR ALTERING THE SEQUENCE.

1. CONTRACTOR SHALL OBTAIN ALL NECESSARY PERMITS AND APPROVALS PRIOR TO THE START OF CONSTRUCTION.

2. CONTRACTOR SHALL PERFORM SUBSURFACE UTILITY INVESTIGATION PRIOR TO THE START OF CONSTRUCTION.

4. CONTRACTOR SHALL SET UP A PRE-CONSTRUCTION MEETING WITH THE PERMIT APPROVING AUTHORITIES AT

CONTRACTOR SHALL CALL MISS UTILITY (811) 72 HOURS PRIOR TO THE START OF CONSTRUCTION.

APPROVAL AT LEAST TWO (2) WEEKS PRIOR TO THE START OF CONSTRUCTION.

LEAST ONE (1) WEEK PRIOR TO STARTING ANY LAND DISTURBING ACTIVITIES.

5. CONTRACTOR SHALL SUBMIT SHOP DRAWINGS FOR ALL PROPOSED WORK TO ENGINEER FOR REVIEW AND

6. CONTRACTOR SHALL COORDINATE WITH LOCAL UTILITY AUTHORITIES A MINIMUM OF 30 DAYS PRIOR TO THE REQUIRED WORK.

7. CONTRACTOR IS RESPONSIBLE FOR COORDINATING ALL WORK REQUIRING CERTIFICATIONS FOR THIS PROJECT

8. INSTALL TEMPORARY CONSTRUCTION ENTRANCE(S) AND REQUIRED SIGNAGE. THE STONE AREA OF THE CONSTRUCTION ENTRANCE IS TO BE CHECKED REGULARLY TO ENSURE IT IS SUFFICIENT TO REDUCE TRACKING OF MATERIAL OFF SITE. ANY AND ALL MATERIAL OR DEBRIS TRACKED ONTO A PUBLIC OR PRIVATE ROAD SHALL BE REMOVED THOROUGHLY AT THE END OF EACH DAY. SEDIMENT SHALL BE REMOVED FROM ROADS BY SHOVELING OR SWEEPING AND MAY BE TRANSPORTED TO A SEDIMENT CONTROLLED DISPOSAL AREA. LOCATION OF CONSTRUCTION ENTRANCE(S) SHOWN ON THIS PLAN ARE APPROXIMATE AND SHALL BE FIELD VERIFIED BY CONTRACTOR PRIOR TO INSTALLATION. CONSTRUCTION ENTRANCE SHALL NOT BE LOCATED WITHIN (3) FEET OF WATER METERS, SEWER CLEANOUTS, TRANSFORMERS, LIGHT POLES, FIRE HYDRANTS, OR ANY OTHER ABOVE GROUND APPURTENANCES.

9. ESTABLISH A WORKING PERIMETER WITH SILT FENCE AND TREE PROTECTION. SILT FENCE AND TREE PROTECTION ARE TO BE CHECKED REGULARLY FOR UNDERMINING OR DETERIORATION OF THE FABRIC. SEDIMENT SHALL BE REMOVED WHEN THE LEVEL OF SEDIMENT DEPOSITION REACHES $\frac{1}{3}$ HEIGHT TO THE TOP OF THE BARRIER. WHERE PUBLIC SIDEWALK EXISTS, CONTRACTOR SHALL ENSURE SILT FENCE AND TREE PROTECTION DOES NOT IMPEDE PEDESTRIAN TRAFFIC.

10. ALL AREAS OUTSIDE OF LIMITS OF DISTURBANCE ARE NOT TO BE DISTURBED AND SHALL BE LEFT IN A NATURAL STATE.

11. INSTALL INLET AND/OR OUTLET PROTECTION, TEMPORARY WATTLE(S), ROCK CHECK DAM(S), TEMPORARY SEDIMENT BASINS/TRAPS, AND OTHER EROSION CONTROL MEASURES AS REQUIRED IN AREAS RECEIVING RUNOFF FROM CONSTRUCTION ACTIVITIES. LOCATIONS SHOWN ON THE PLAN ARE APPROXIMATE AND SHALL BE FIELD VERIFIED BY THE CONTRACTOR TO ENSURE COMPLIANCE WITH ALL LOCAL, STATE AND FEDERAL REGULATIONS. CHECK REGULARLY FOR SETTLEMENT, EROSION, AND DISPLACEMENT TO ENSURE THAT THEY ARE STRUCTURALLY SOUND AND HAVE NOT BEEN DAMAGED BY EROSION OR CONSTRUCTION EQUIPMENT. REPAIR OR REPLACE IMMEDIATELY. SEDIMENT SHALL BE REMOVED IN ACCORDANCE WITH EROSION & SEDIMENT CONTROL (E&S) MINIMUM STANDARDS AND SPECIFICATIONS.

12. ALL E&S MEASURES SHALL BE INSTALLED AND MAINTAINED IN ACCORDANCE WITH THE LATEST STATE AND LOCAL STANDARDS AND SPECIFICATIONS. E&S MEASURES SHALL BE INSTALLED BEFORE CONSTRUCTION AND MAINTAINED UNTIL FINAL VEGETATIVE COVER IS ESTABLISHED. E&S MEASURES ARE TO BE CHECKED WEEKLY UNLESS OTHERWISE SPECIFIED AND AFTER EACH SIGNIFICANT RAINFALL EVENT.

13. THE CONTRACTOR SHALL CONTROL DUST THROUGHOUT THE PROJECT DURATION, WITHIN THE PROJECT AREA AND AT ALL OTHER AREAS AFFECTED BY THE CONSTRUCTION OF THE PROJECT. DUST CONTROL SHALL NOT BE CONSIDERED EFFECTIVE WHERE THE AMOUNT OF DUST CREATES A POTENTIAL OR ACTUAL UNSAFE CONDITION, PUBLIC NUISANCE OR CONDITION ENDANGERING THE VALUE OR APPEARANCE OF ANY PROPERTY.

14. INSTALL UNDERGROUND UTILITIES AND STORM DRAINAGE, PROVIDING APPROVED SEDIMENT PROTECTION AT NEW DRAINAGE CONVEYANCE STRUCTURES AS REQUIRED, INCLUDING INLET AND/OR OUTLET PROTECTION, ROCK CHECK DAMS, WATTLES, AND MATTING. IF TEMPORARY DIVERSIONS ARE REQUIRED, TEMPORARY SEDIMENT FILTRATION AND VELOCITY CONTROL MEASURES MUST BE INSTALLED. IMMEDIATELY UPON COMPLETION OF INSTALLATION, ALL DISTURBED AREAS ARE TO BE LEVELED OUT, SEEDED, AND MULCHED. DISTURBED AREAS ARE NOT TO LAY EXPOSED LONGER THAN OUTLINED ON THESE PLANS.

15. INSTALL RETAINING WALLS, CURB AND/OR GUTTER AND/OR CONCRETE EDGE RESTRAINTS.

16. CONTRACTOR SHALL VERIFY THAT THE BASE IS DRY AND MEETS ALL MATERIAL, INSTALLATION AND GRADE SPECIFICATIONS AND ENSURE THAT THE BASE IS READY TO SUPPORT THE IMPOSED LOADS.

17. PLACE BASE STONE IN ROADWAY, PARKING, AND SIDEWALK AREAS.

18. PAVE ROADWAYS, PARKING AREAS. AND SIDEWALKS.

19. ESTABLISH FINAL GRADES FOR POSITIVE DRAINAGE.

20. INSTALL FINAL SITE IMPROVEMENTS, INCLUDING FENCING, PAVEMENT MARKINGS AND SIGNAGE.

21. INSTALL PERMANENT LANDSCAPING AND SEEDING. ALL AREAS TO BE LANDSCAPED AND/OR SEEDED SHALL BE LOOSENED TO A DEPTH OF 6".

22. AFTER VEGETATION AND PERMANENT STORMWATER CONTROL MEASURES HAVE BEEN ESTABLISHED AND UPON AUTHORIZATION FROM THE DESIGNATED INSPECTOR, REMOVE REMAINING EROSION AND SEDIMENT CONTROL MEASURES WITHIN 30 DAYS AFTER FINAL SITE IS STABILIZED WITH VEGETATIVE COVER.

23. CONTRACTOR SHALL PROVIDE WRITTEN NOTICE OF PROJECT COMPLETION TO THE OWNER AT LEAST THIRTY (30) CALENDAR DAYS IN ADVANCE OF SCHEDULED PROJECT COMPLETION.

Civil Abbreviations Existing Legend

ARV

APPROX

ARCH

BRL

CB

CE

CI

CONC

CSPP

DI

DS

DT

EA

ELEC

ELEV

EXIST

ET

FFE

FH

FM

FS

GV

HDPE

HORIZ

INV

LF

LP

MAX

MECH

MIN

MG

OC

PIV

PVC

RCD

RS

R/W

SCH

SF

SS

SSCO

SSMH

STA

STRUCT

SW

TC

TEL

TP

TSA

TOFA

TYP

TST

VΒ

VERT

WM

POLYVINYL CHLORIDE

RUNWAY SAFETY AREA

GRAVITY SEWER LINE

SANITARY SEWER CLEAN OUT

SANITARY SEWER MANHOLE

RIGHT OF WAY

REDUCER

SCHEDULE

STATION

SWALE

TYPICAL

VALVE BOX

WATER LINE

WATER METER

WATER VALVE

VERTICAL

STRUCTURAL

TOP OF CURB

TREE PROTECTION

TAXIWAY SAFETY AREA

TAXIWAY OBJECT FREE AREA

TEMPORARY SEDIMENT TRAP

TELEPHONE

SILT FENCE

TEMPORARY ROCK CHECK DAM

REDUCED PRESSURE BACKFLOW PREVENTER


REINFORCED CONCRETE PIPE

ASPHALTIC CONCRETE ————·800·——— 5' CONTOUR AIR RELEASE VALVE PROPERTY BOUNDARY **APPROXIMATE** EASEMENT **ARCHITECTURAL** TREE/SHRUB LINE **BUILDING RESTRICTION LINE** WOOD FENCE CATCH BASIN — — — — SD — STORM & SIZE IF INDICATED CONSTRUCTION ENTRANCE — — — — — WTR — WATER & SIZE IF INDICATED CAST IRON SANITARY & SIZE IF INDICATED CONCRETE — — — — G — GAS & SIZE IF INDICATED CONSTRUCTION SAFETY PHASING PLAN — — — — — UE — UNDERGROUND ELECTRIC DUCTILE IRON — — — — — UT — UNDERGROUND TELEPHONE DIAMETER PAVEMENT/CURB REMOVAL DOWN SPOUT SANITARY MANHOLE DITCH STORM MANHOLE **EACH** CATCH BASIN **ELECTRICAL CURB INLET ELEVATION** HEADWALL **EXISTING** WATER METER PIT WATER VALVE FINISHED FLOOR ELEVATION SPRINKLER FIRE HYDRANT **TRANSFORMER** FLOW LINE ELECTRIC METER FORCE MAIN UTILITY/LIGHT POLE FIRE SERVICE LINE **GROUND LIGHT** GATE VALVE **TELEPHONE PEDESTAI** CORRUGATED PLASTIC PIPE GAS METER **HORIZONTAL** HIGH POINT **INVERT** INLET PROTECTION **EVERGREEN TREE** LATERAL FOUND IRON PIN LINEAR FEET FOUND DRILL HOLE LOW POINT FOUND MAG NAIL MAXIMUM SET IRON PIN **MECHANICAL** SET CHISELED X MINIMUM BUILDING MATCH GRADE REMOVE PAVEMENT OFF CENTER LIMITS OF CLEARING POST INDICATOR VALVE

----799-----

1' CONTOUR

Proposed Legend

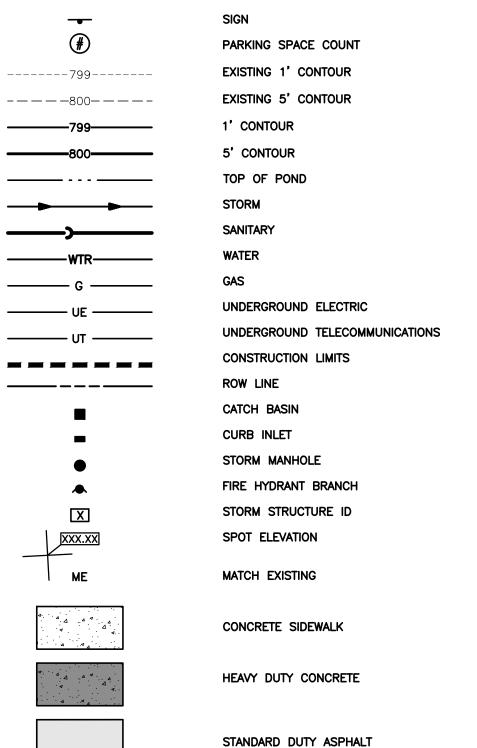

HEAVY DUTY ASPHALT

SIGHT DISTANCE TRIANGLES

WOOLPER

ARCHITECTURE | ENGINEERING | GEOSPATIAL

13860 Ballantyne Corporate Place, Suite 425

Charlotte, NC 28227

CIVIL

ISSUANCE SCHEDULE

NUMBER DATE DESCRIPTION

0 07/22/22 CONDITIONAL ZONING SUBMITTAL
1 10/05/22 CONDITIONAL ZONING RESUBMITTAL
2 12/09/22 CONDITIONAL ZONING RESUBMITTAL
3 02/17/23 CONDITIONAL ZONING RESUBMITTAL
3 02/17/23 CONDITIONAL ZONING RESUBMITTAL

CHWOOD HOMES

UTH CREEK

ED USE DEVELOPMENT

BIA ST.

PROJECT NO: 082447
DATE ISSUED: 02/17/23
DESIGNED BY: RMN
DRAWN BY: VCS
CHECKED BY: RMN

SHEET NAME:
ADDITIONAL NOTES &
LEGENDS

SHEET NO:

C-005

