PROJECT NARRATIVE > East Lakeview Townhomes

February 27, 2025

Background Summary

- EB Capital Partners proposes and R-6-CZD rezoning for a multifamily development located at 5640 Old Chapel Hill Road within the Parkline East Village development area. The site is generally located within the US 15/501 and Old Chapel Hill Road transportation corridor, as well as adjacent to retail centers and employment centers.
- In 2022, Town staff created a cohesive development framework for this area in the southwest quadrant of the I-40 and US-15 intersection. Multiple surrounding properties have previously received zoning approvals in line with this proposed development.
- EB Capital Partners proposed development includes approximately 4.0 Acres of multifamily units containing 68 dwelling units.
- The small parcel size which also provides the Cowan Boulevard ROW extension and Connected Roads Plan connection of E Lakeview Drive to White Oak Drive makes provision of multiple housing types impractical on the site.

Site Location/Area Map

- The property is located within the North 15-501 Corridor, Sub-area A, which calls for multi-family residential of 4-6 stories in height. This project would fulfill the direction of the Parkline East framework by providing multi-family residential of 4 stories.
- The proposed plans will be consistent with other multi-family developments adjacent the site including in massing, density, and height as well as the Parkline development framework.

Existing Conditions

- The site is located on the northeast corner of Old Chapel Hill Road and East Lakeview Drive.
- The site generally slopes north towards two discharge points along the northern property line. The drainage then drains to the north to an intermittent stream and flows toward I-40.
- The site is mostly wooded and this development plans to landscape per the Town of Chapel Hill requirements.

Steep Slope Plan

• There are limited areas of steep slopes within the project site in the 15.01%-25% range and 0.11 acres of 25% or greater. These areas do not require special design or construction considerations as the majority of these slopes are a result of improvements made within the Old Chapel Hill Road ROW. Their locations will not impact any environmental areas.

Site Plan

• The project is located on the north side of Old Chapel Hill Road and east of East Lakeview Drive and within the Parkline East Village development area of Chapel Hill. The project is 4.0+/- acres and includes 68 townhome units in 8 buildings. Parking for the individual units include an interior garage space and an exterior space in front of each garage for a total of parking 158 spaces.

BIRMINGHAM · AUBURN · ORANGE BEACH



PROJECT NARRATIVE > East Lakeview Townhomes

Additional visitor spaces are included throughout the development. The project will also include exterior greenspaces and amenities as well as connections to the existing pedestrian sidewalk network along Old Chapel Hill Road and the future Cowan Boulevard greenway.

• The site is accessed via a full access from East Lakeview Drive and Old Chapel Hill Road with connections to adjacent developments via Cowan Blvd to the north and a private connection to the east. The layout of this project focuses on multi-modal forms of transportation, with pedestrian and bicycle traffic routes accessing each public ROW, the future greenway, and throughout the proposed development. Central to the layout are green spaces including a central lawn and additional amenity space on the eastern portion of the development.

Stormwater Management Plan

 All stormwater quantity and quality management requirements will be met via underground detention systems. These underground control measures will be designed per Town of Chapel Hill requirements and route the 100-year storm. Two stormwater control measures (SCMs) are anticipated; one east and one west of the future greenway traversing north to south bisecting the property. The Grading and Drainage Plans depict the approximate locations and sizes of proposed SCMs.

Landscape Protection and Planting Plan

• The minimum requirement of 30% tree coverage on the north side will be provided by new tree plantings throughout the project. Tree coverage on the overall project will meet Town of Chapel Hill code.

Grading and Erosion Control Plan

- The proposed grading will maintain existing drainage patterns as much as possible.
- A site retaining wall will be required along the northeast property line to allow for fire access.
- Proposed stormwater management design will adhere to Town of Chapel Hill requirements per Section 5.4 of the Chapel Hill Land Use Management Ordinance (LUMO).
- A combination of diversion ditches, riser catch basins, and silt fence will control and convey drainage from on-site improvements to sediment basins located in the low areas of the site.
- Sediment basins will be converted into below grade stormwater management vaults as final grading and stabilization occurs.

Solid Waste Plan

Garbage will be provided by a private waste service company and will be picked up per unit.

Building Elevations

- Mulitfamily buildings located on site will be a maximum of five stories.
 - Each unit contains interior ground floor garage parking and two floors of living above.

Fire Safety Plan

BIRMINGHAM · AUBURN · ORANGE BEACH



PROJECT NARRATIVE > East Lakeview Townhomes

- All proposed buildings on site will require aerial fire access coverage. The proposed site design meets all provisions of the North Carolina Fire Prevention Code, Appendix D.
- All structures will have NFPA 13 fire suppression systems.

BIRMINGHAM · AUBURN · ORANGE BEACH

CONDITIONAL ZONING PERMIT PLANS

FOR

East Lakeview Townhomes

5640 Old Chapel Hill Road PIN: 9799995053, 9799985902, 9799997097



	DRAWING INDEX
SHEET NO.	SHEET TITLE
T0.1	COVER SHEET
C0.1	AREA MAP
C0.2	EXISTING CONDITIONS PLAN
C0.3	STEEP SLOPE PLAN
C1.0	SITE LAYOUT PLAN
C1.1	SOLID WASTE PLAN
C1.2	INTERSECTION SIGHT LINE TRIANGLES
C2.0	GRADING PLAN
C2.1	STORMWATER MANAGEMENT PLAN
C3.0	FIRE SAFETY PLAN
A1.0	BUILDING ELEVATIONS
L1.0	LANDSCAPE PLAN
L2.0	LANDSCAPE PLAN
L3.0	LANDSCAPE PLAN
L4.0	LANDSCAPE DETAILS & SCHEDULE

Project Contacts:

DEVELOPER **EB CAPITAL PARTNERS**

ENGINEER KADRE ENGINEERING 157 E FRANKLIN ST P.O. BOX 101205 CHAPEL HILL, NC 27514 IRONDALE, AL 35210 TEL: (205) 586-3062 TEL: (205) 795-3434 CONTACT: ERNEST BROWN CONTACT: BRIAN HATCHER

SURVEYOR

6310 CHAPEL HILL RD, STE 250 RALEIGH, NC 27607 TEL: (919) 851-4422

CONTACT: DAN GREGORY


LANDSCAPE ARCHITECT

RENTA URBAN LAND DESIGN 5236 CALDWELL MILL RD BIRMINGHAM, AL 35242 TEL: (205) 545-7639 CONTACT: TONY RENTA

Prepared For: EB Capital Partners 5/28/25

THE TOTAL NUMBER OF PROPOSED TOWNHOMES FOR THIS DEVELOPMENT WILL RANGE FROM 36 TO 72.



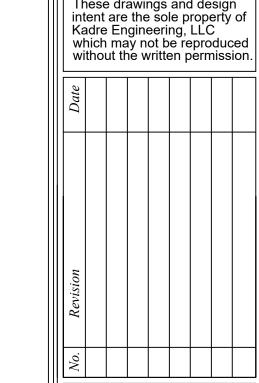


ownhome East


SHEET TITLE


CHECKED BY:


PROJECT NUMBER: SCALE:



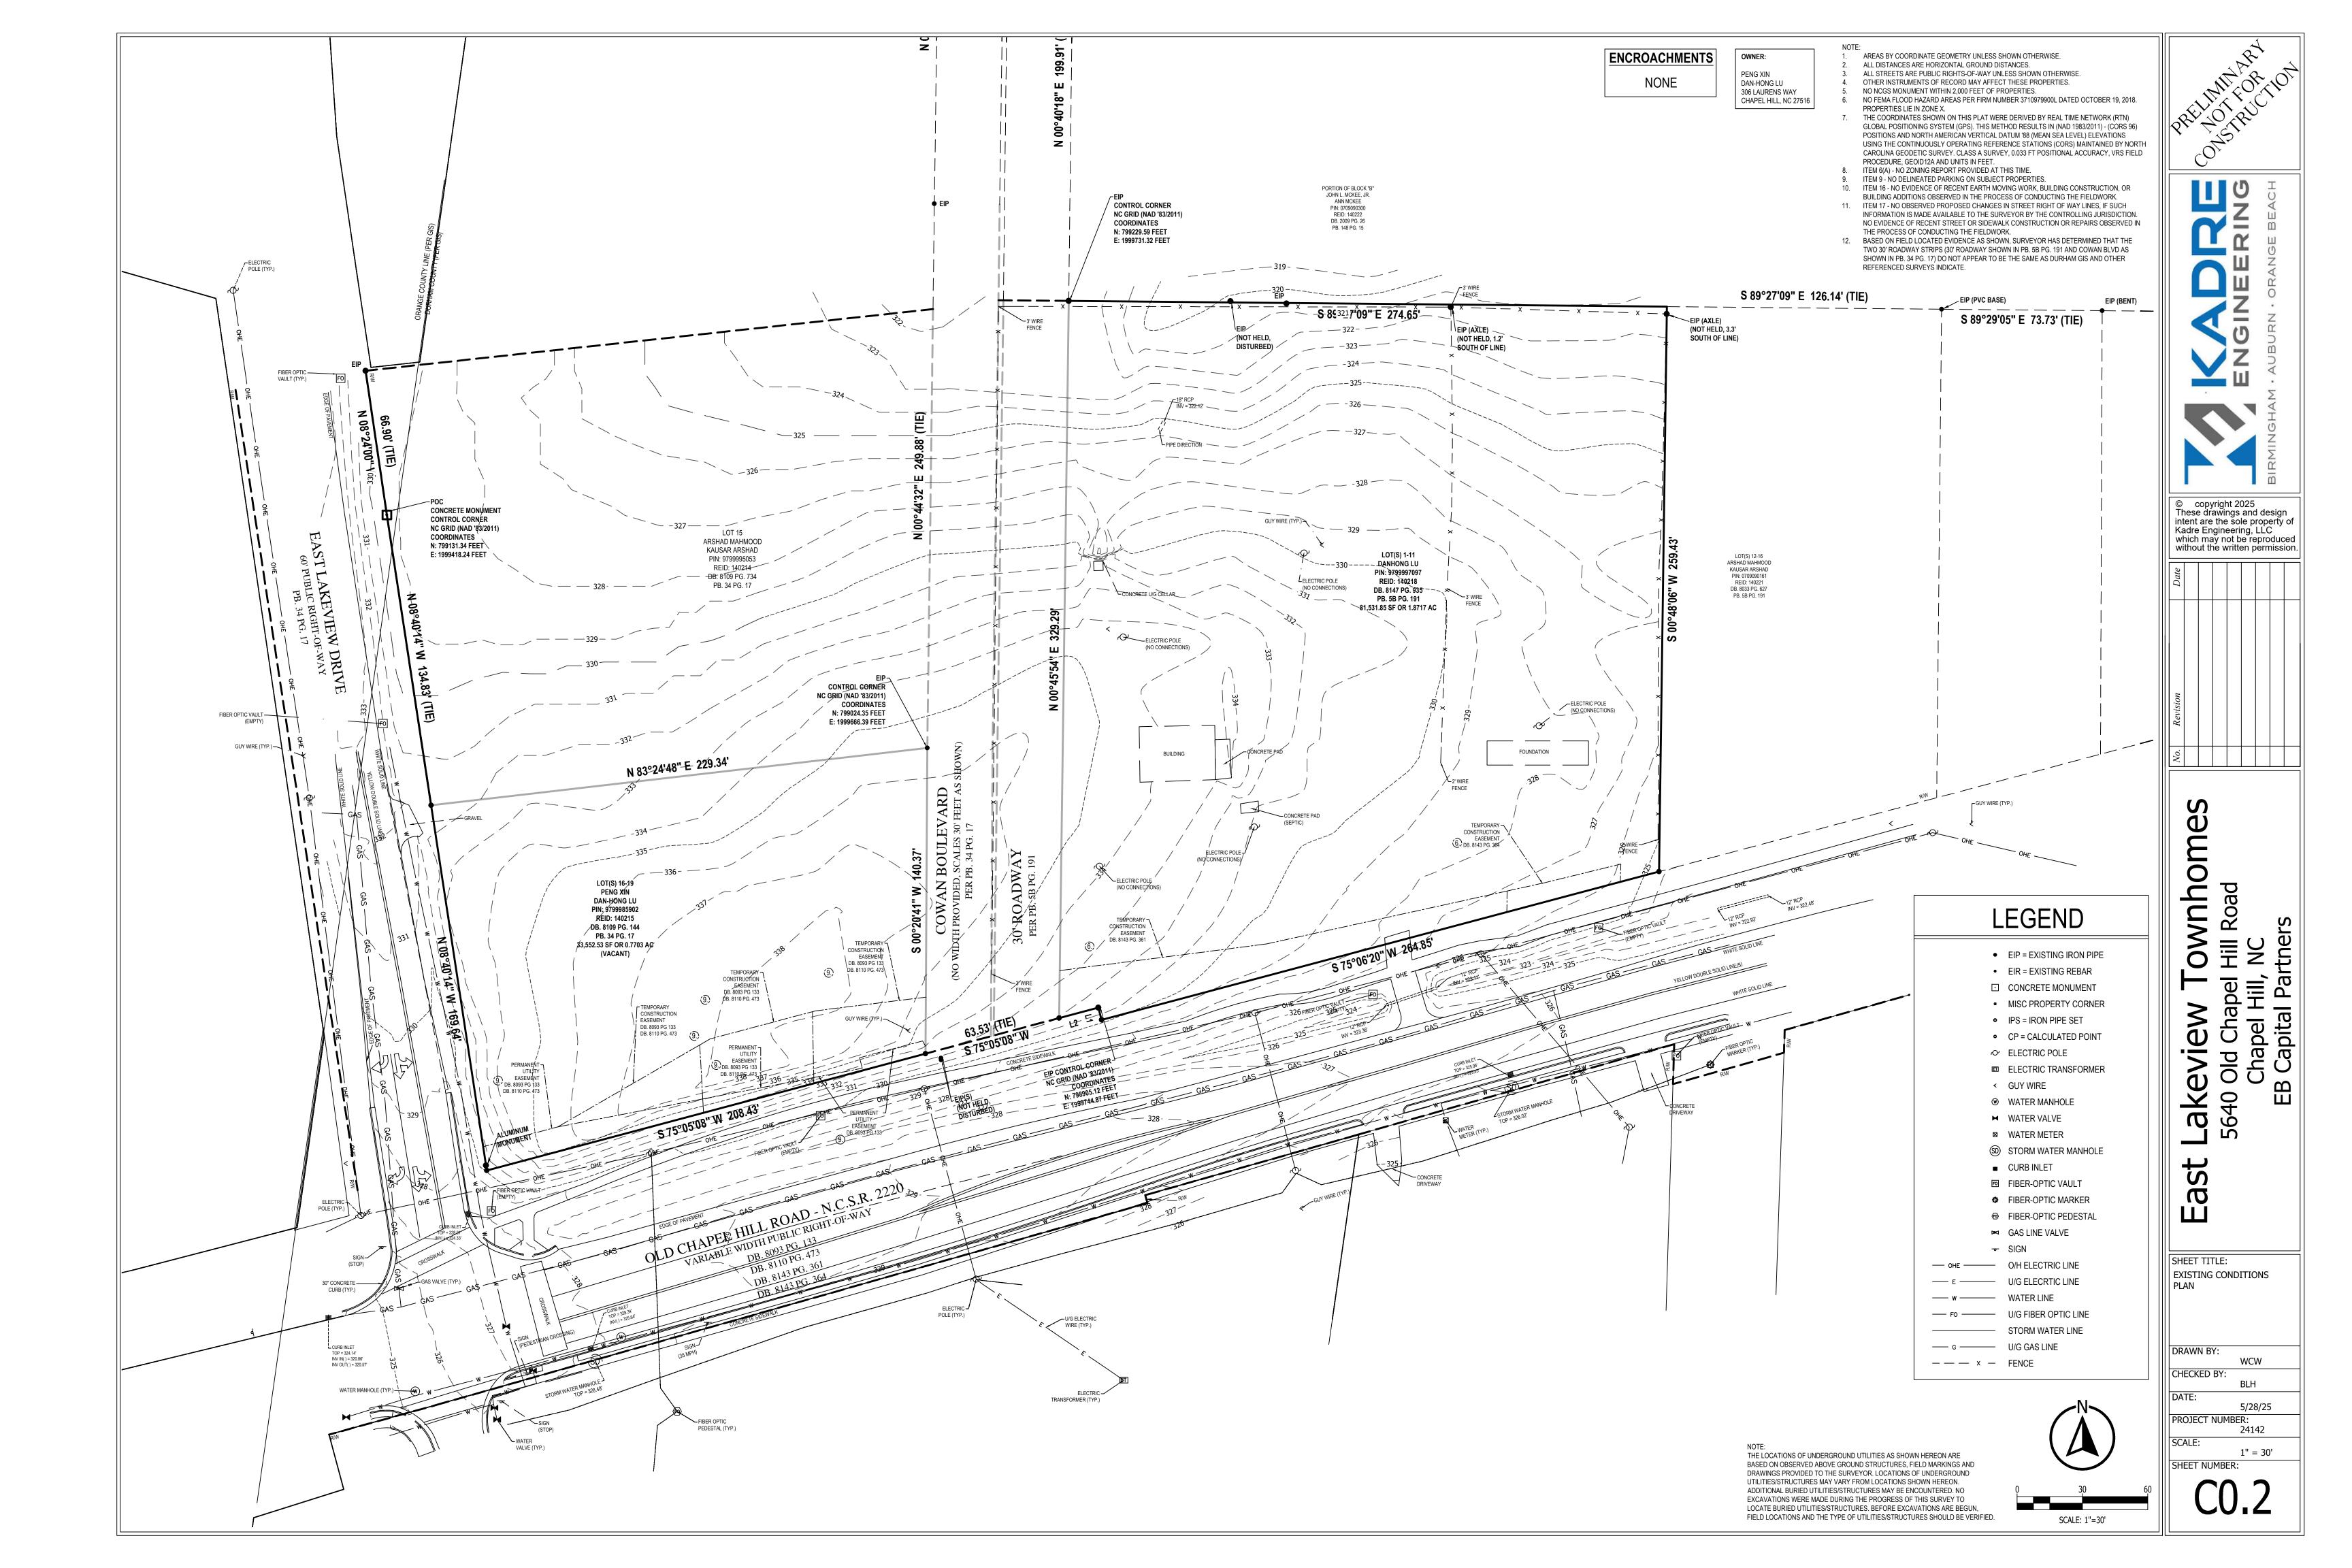


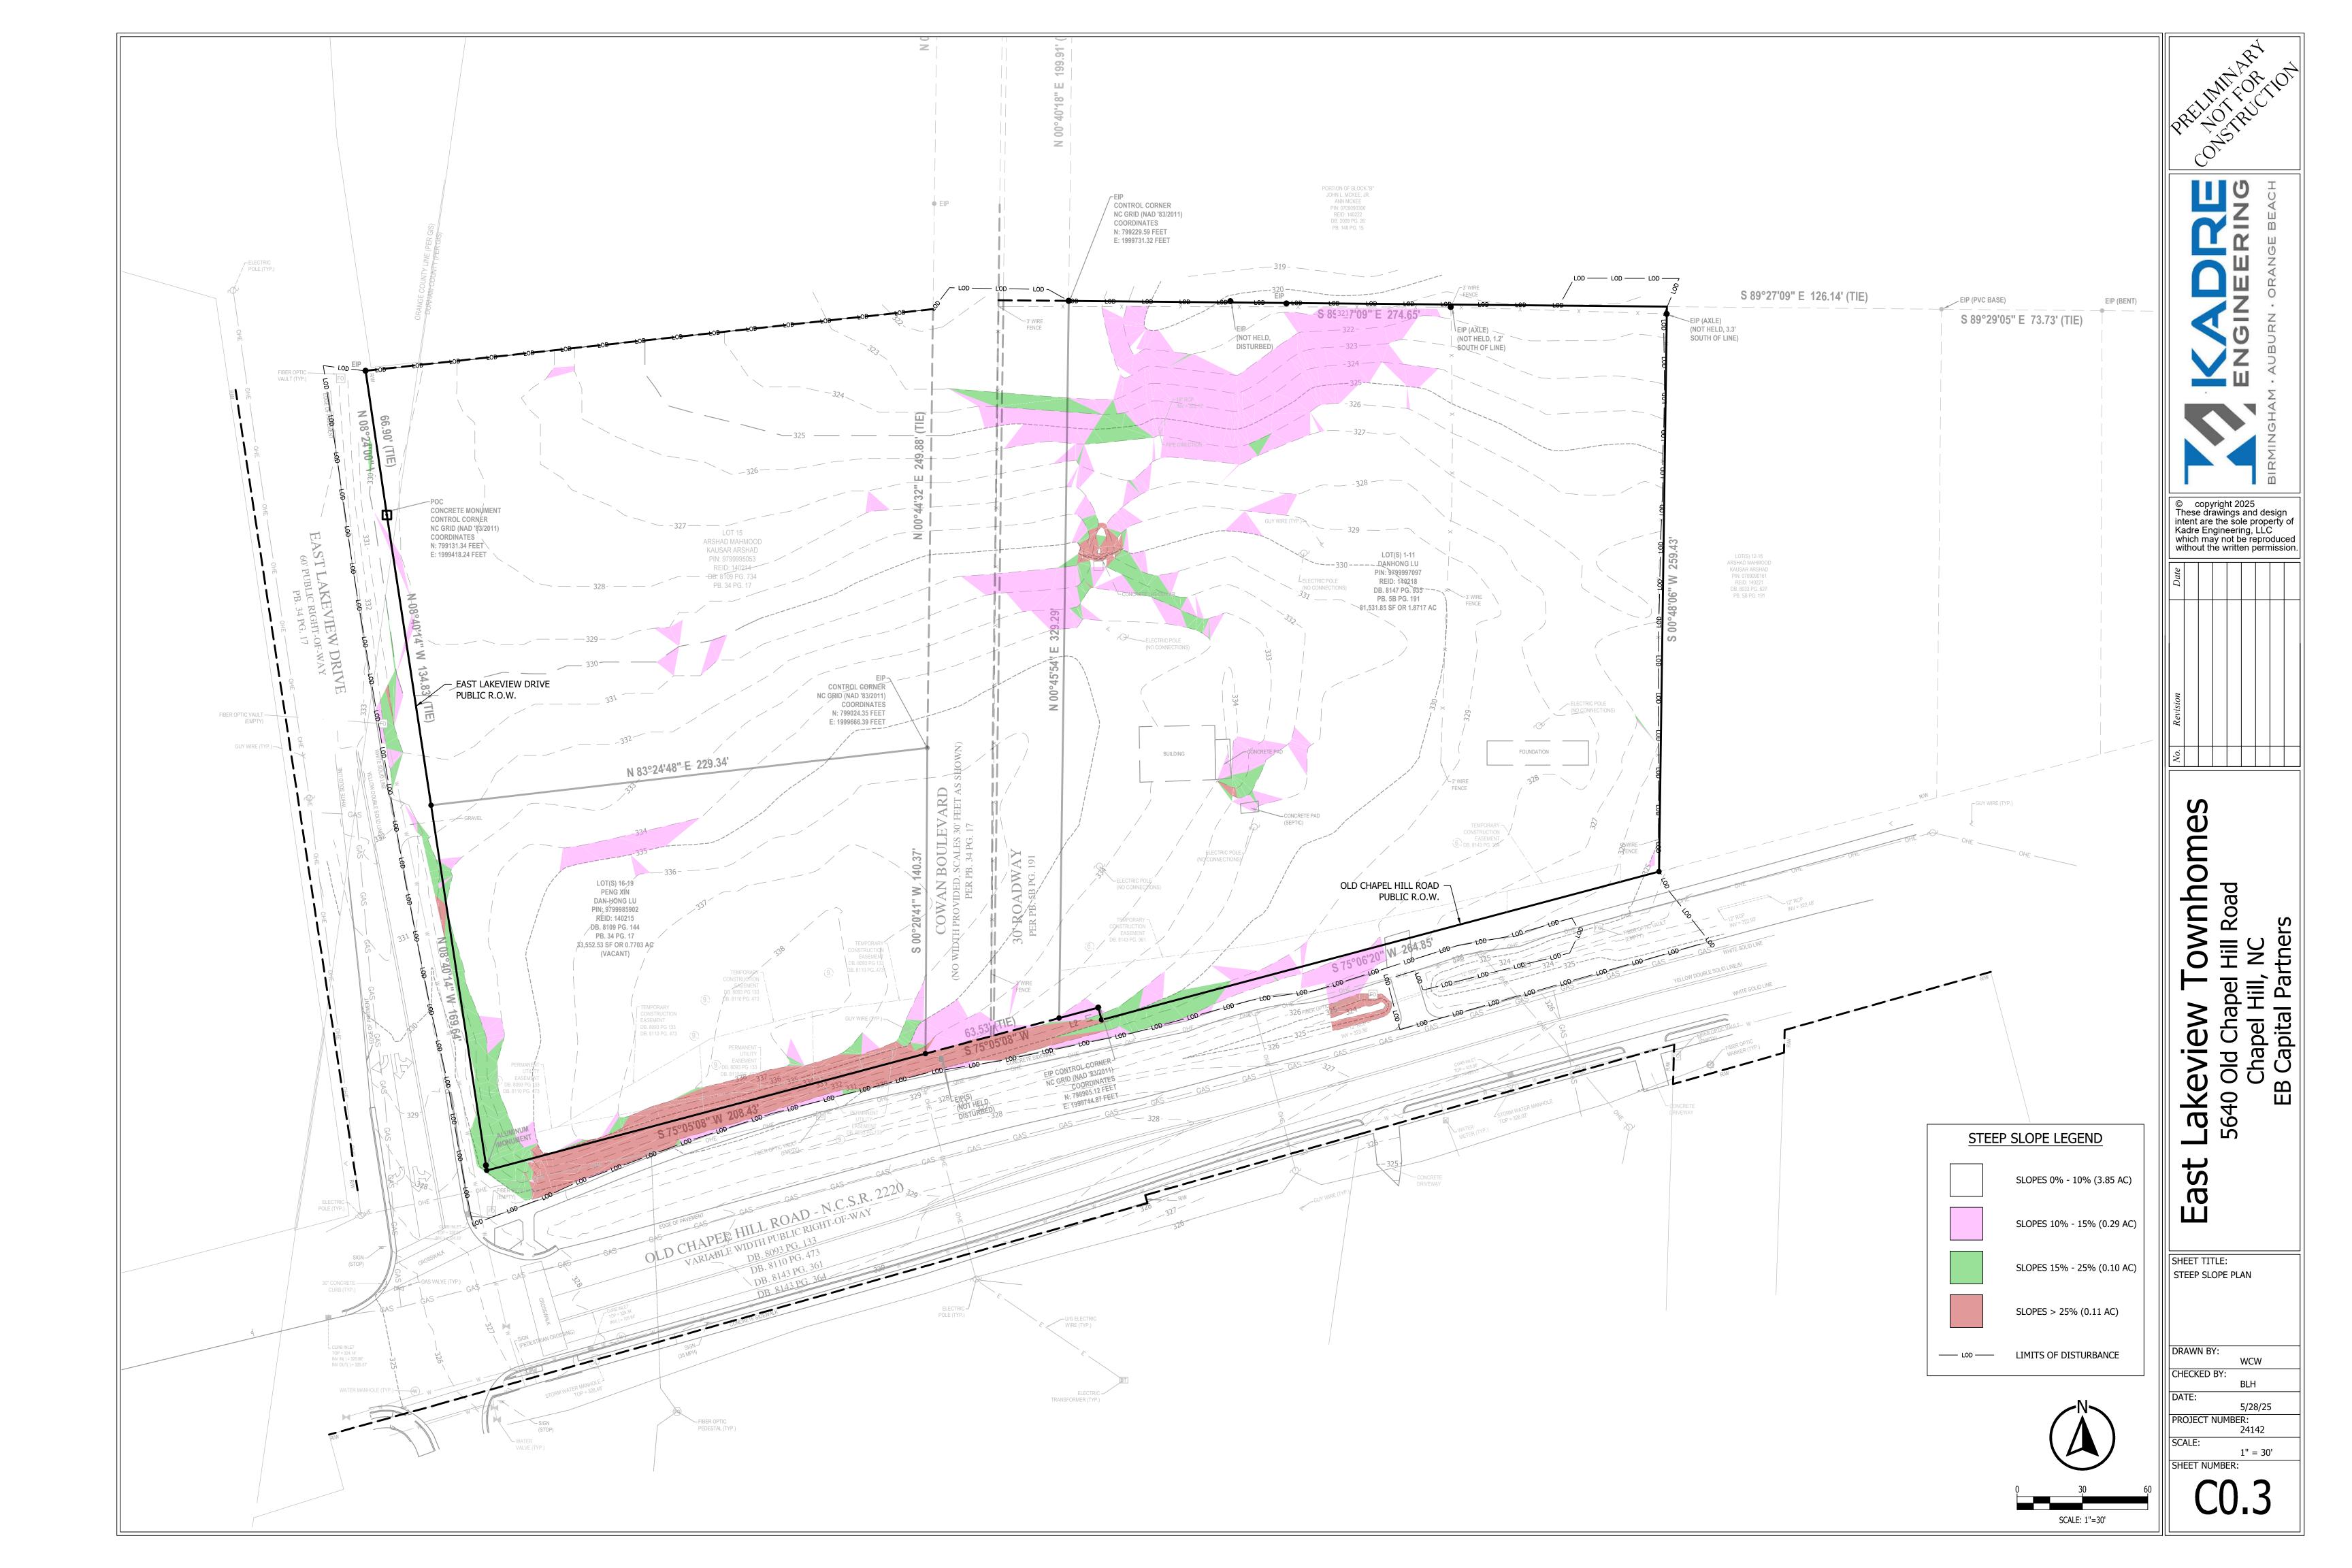


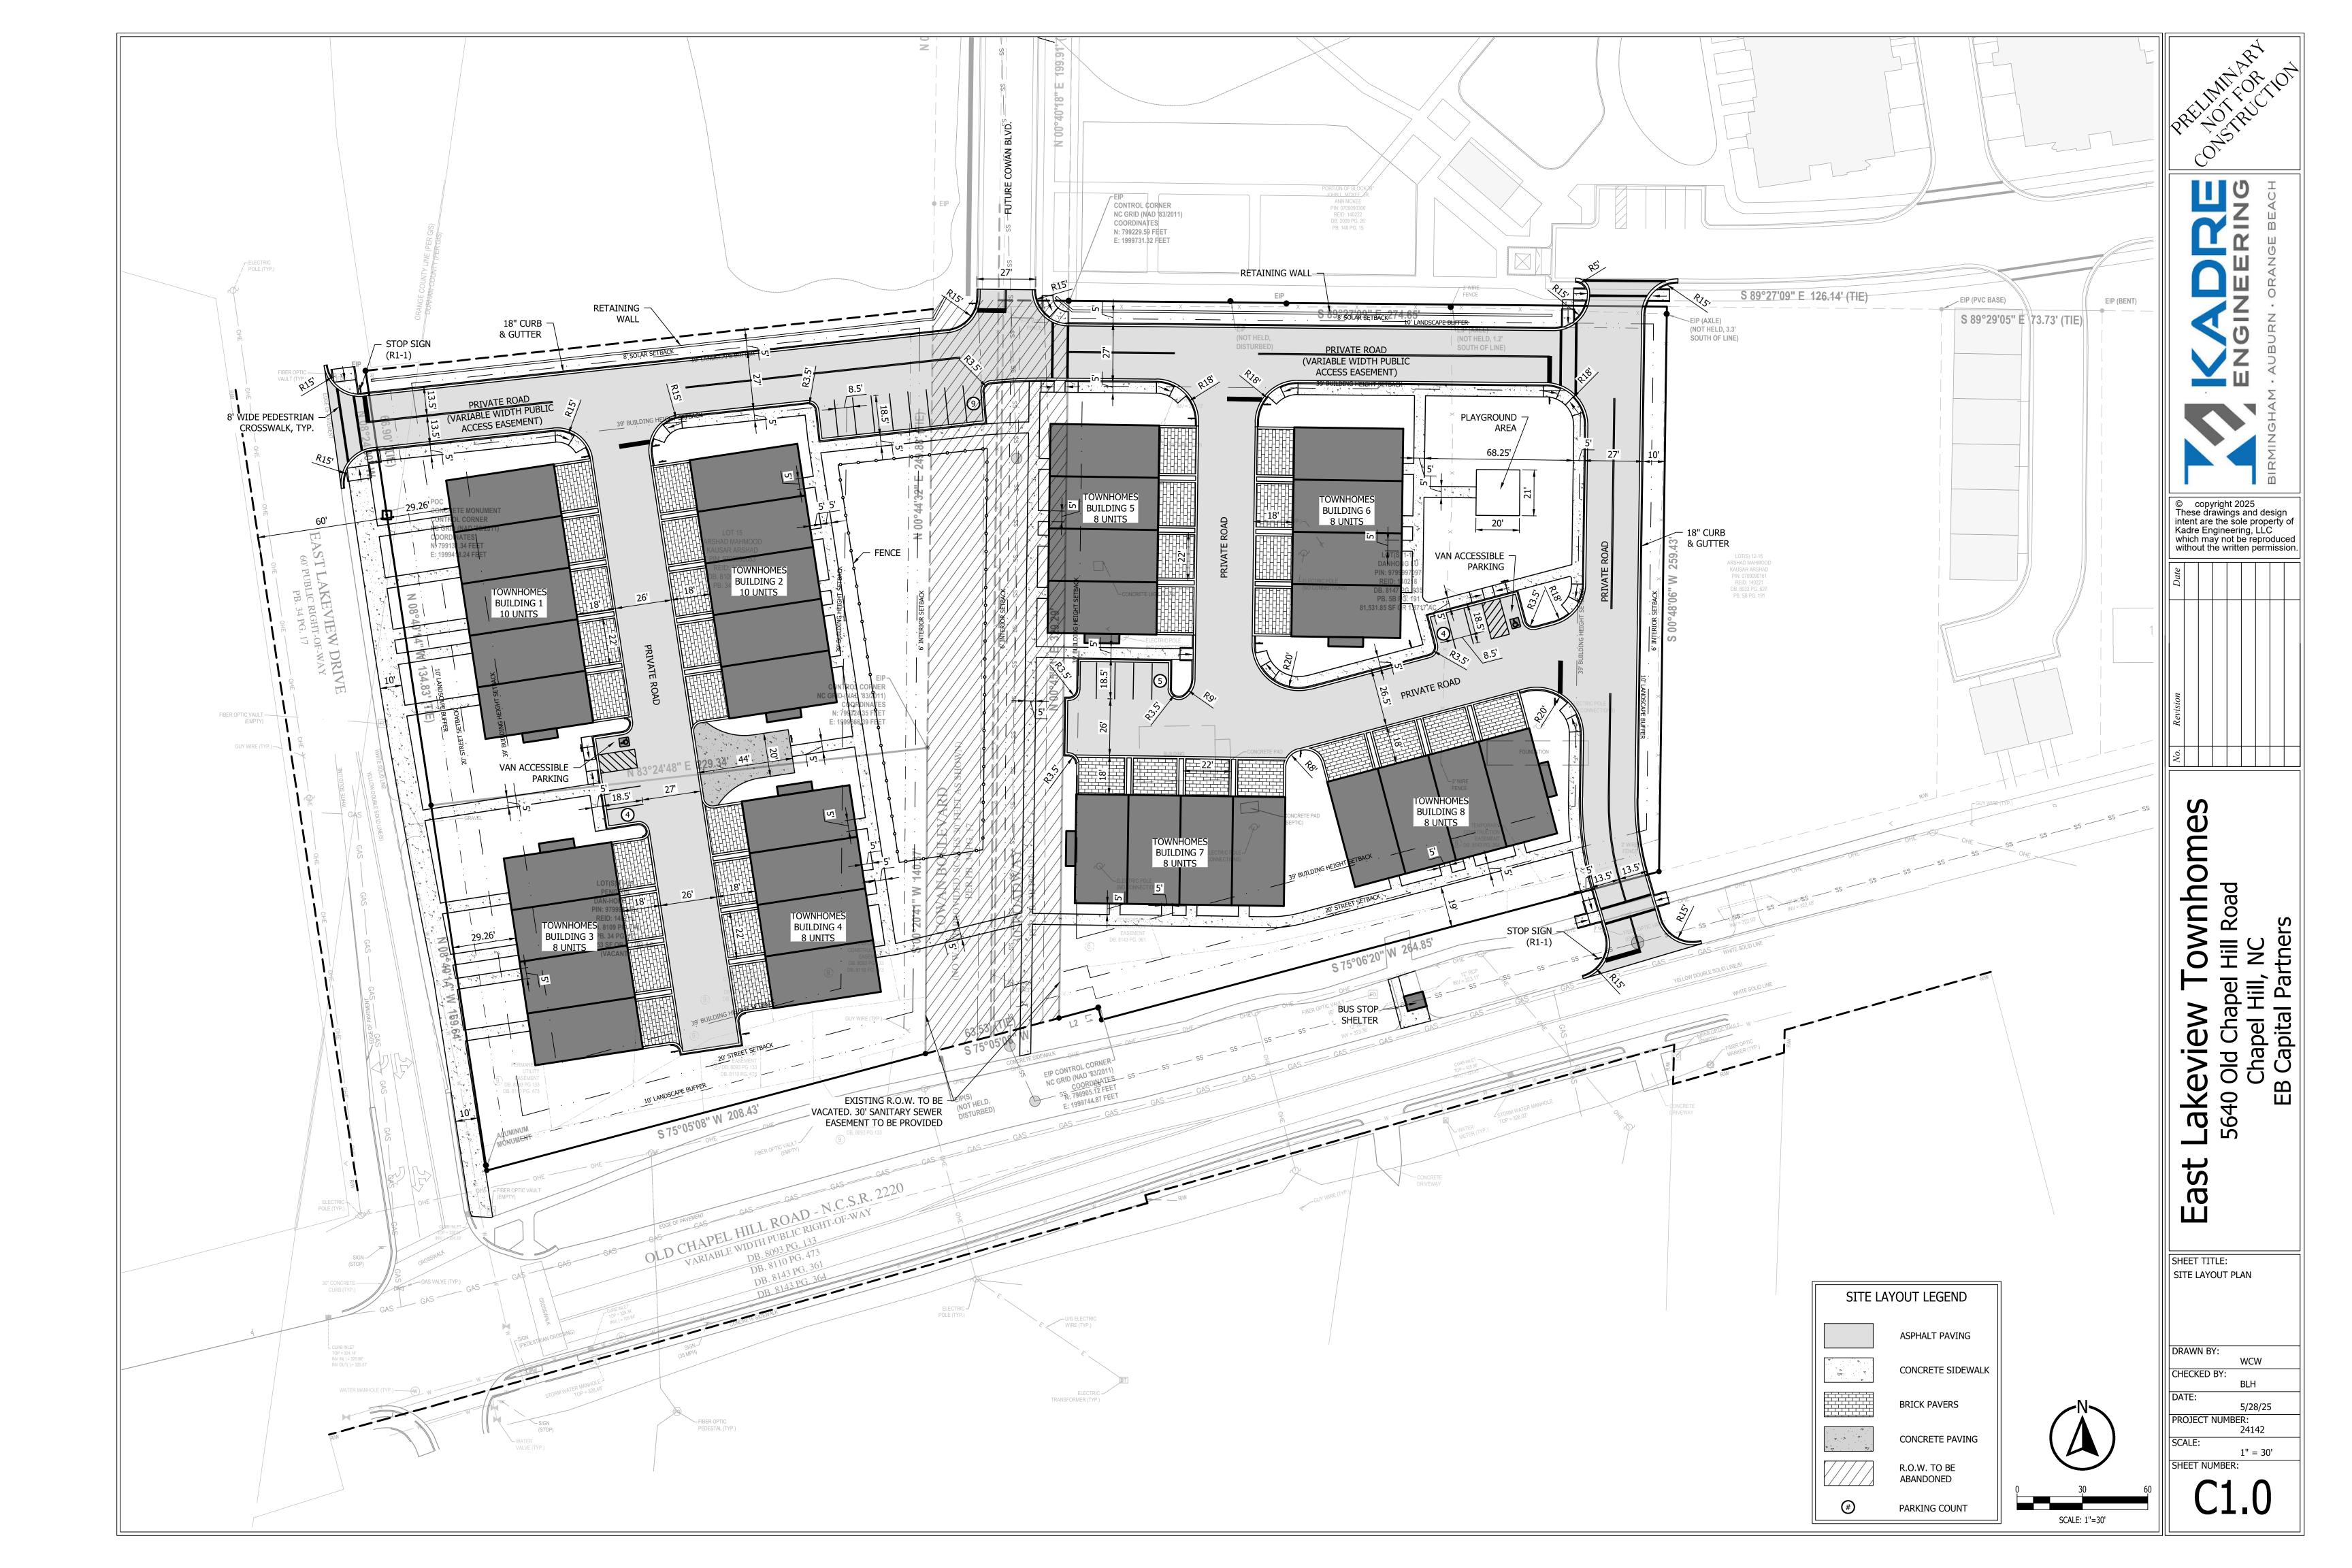

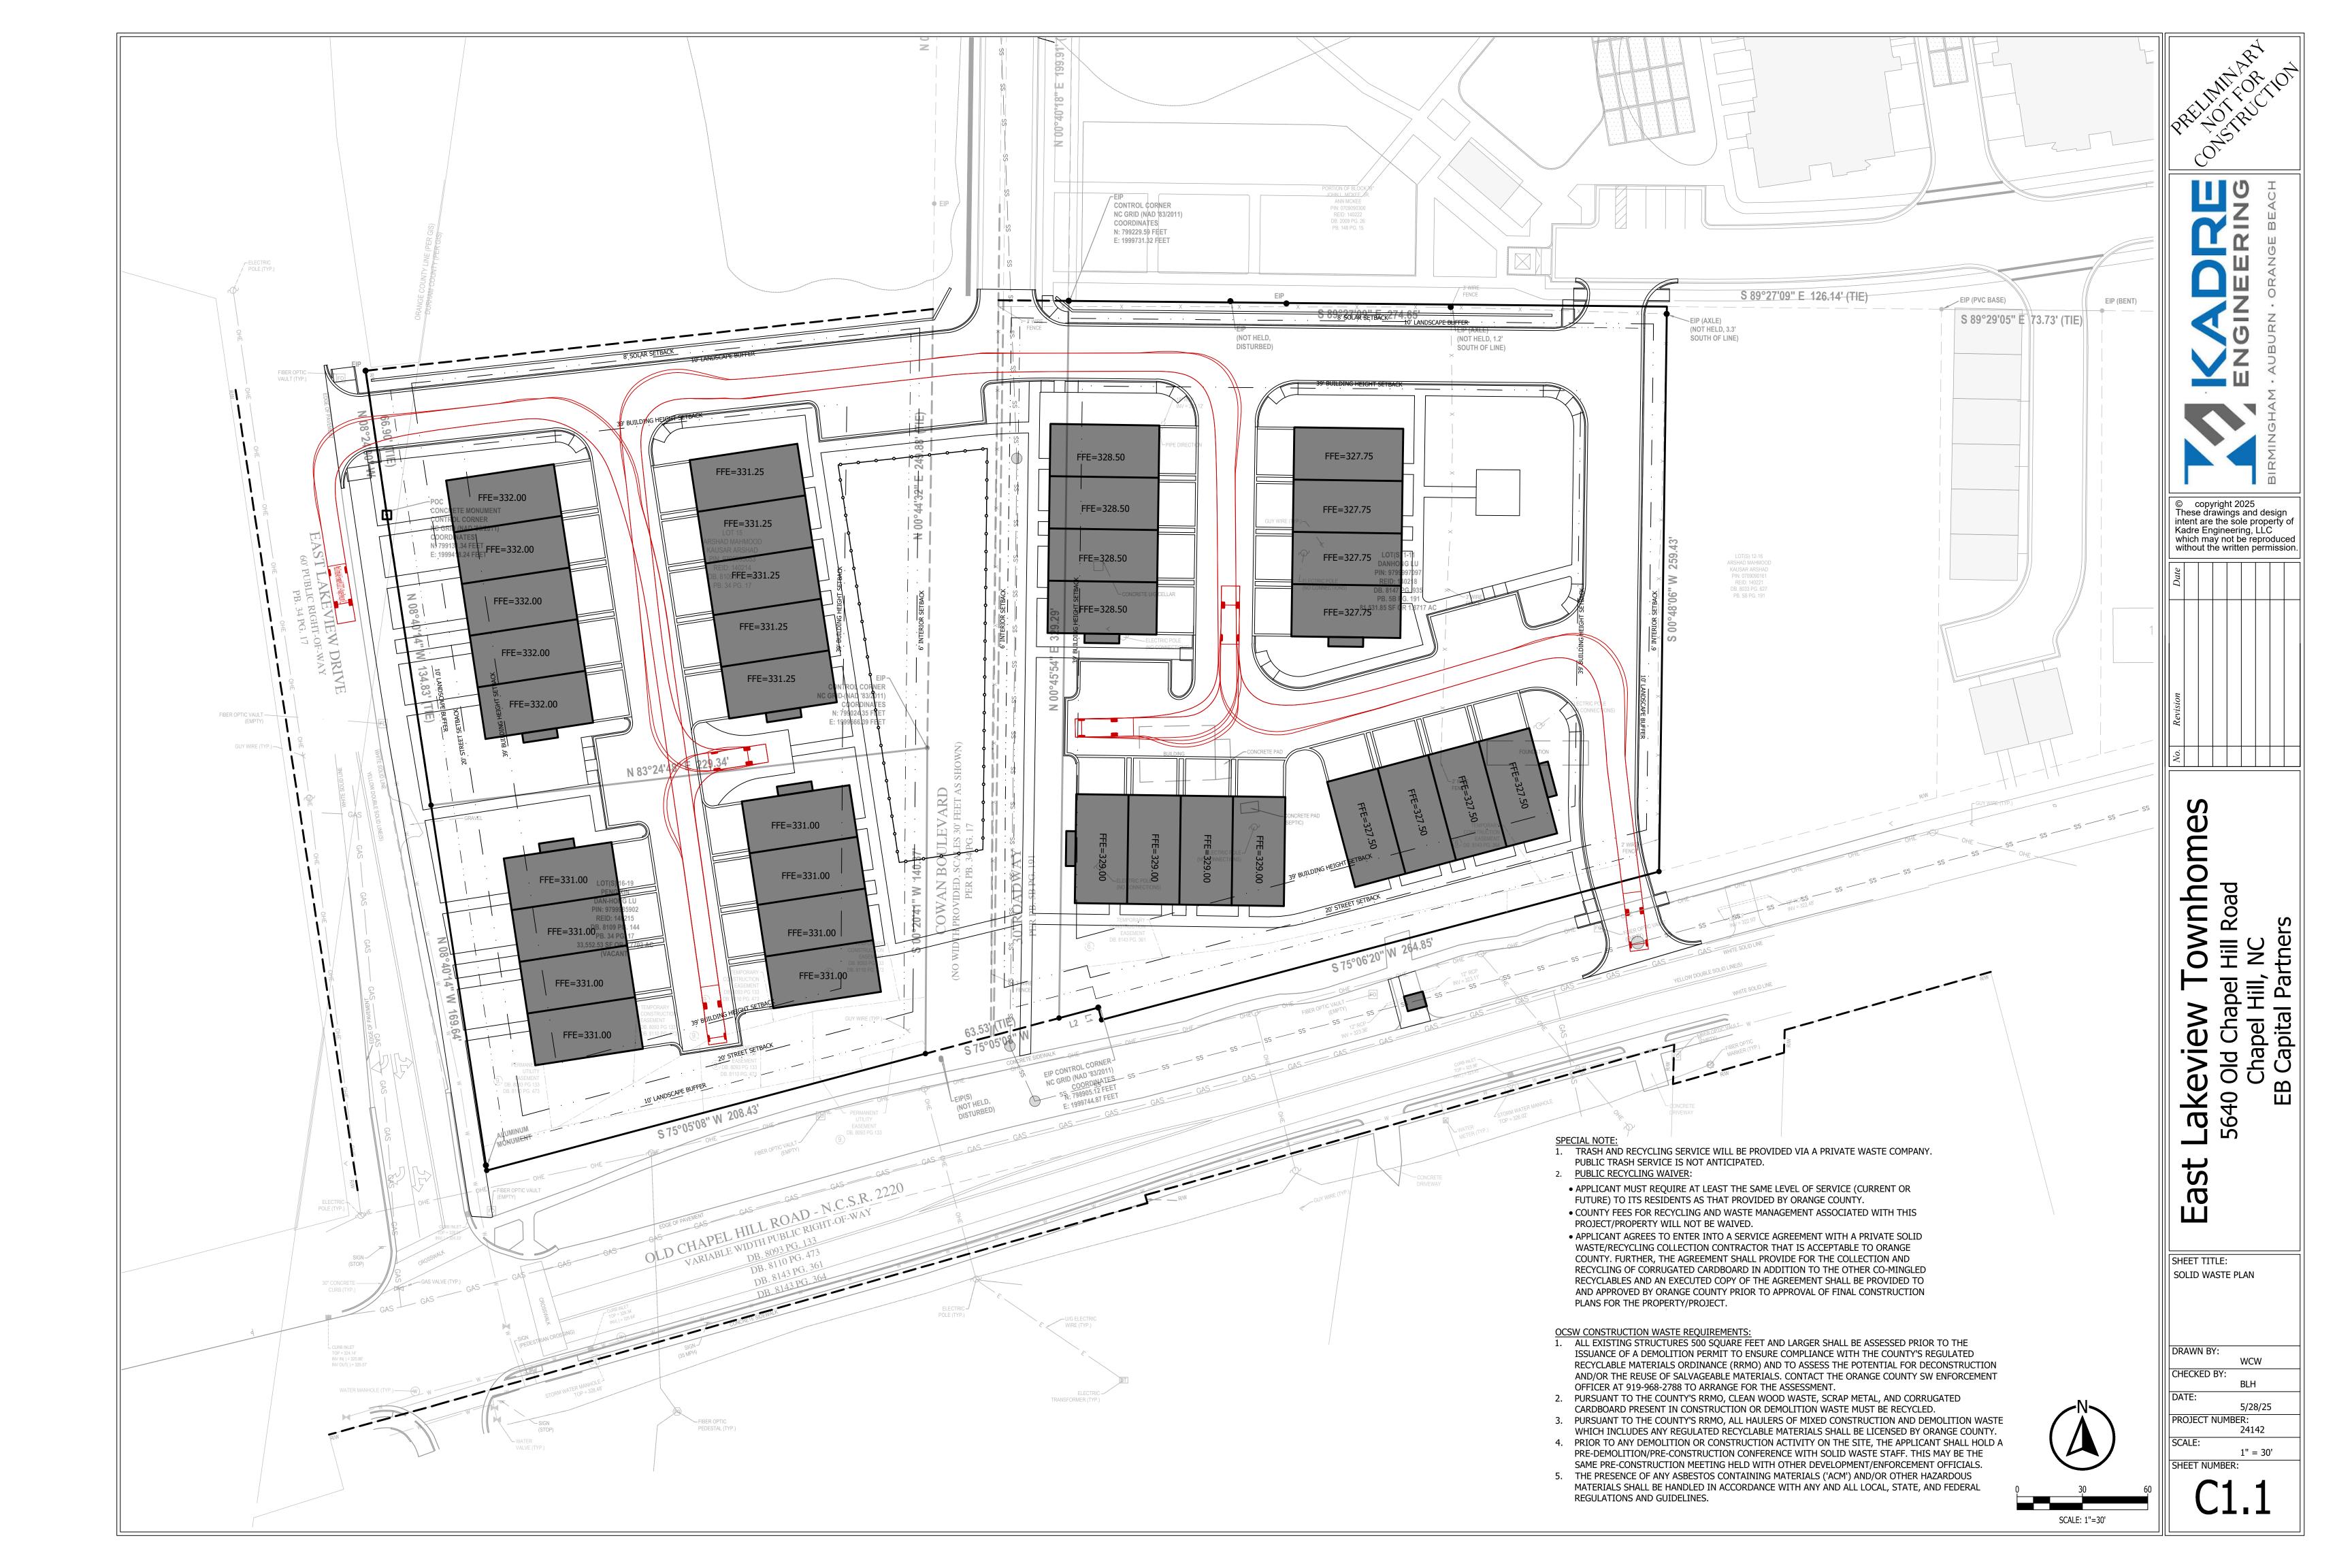





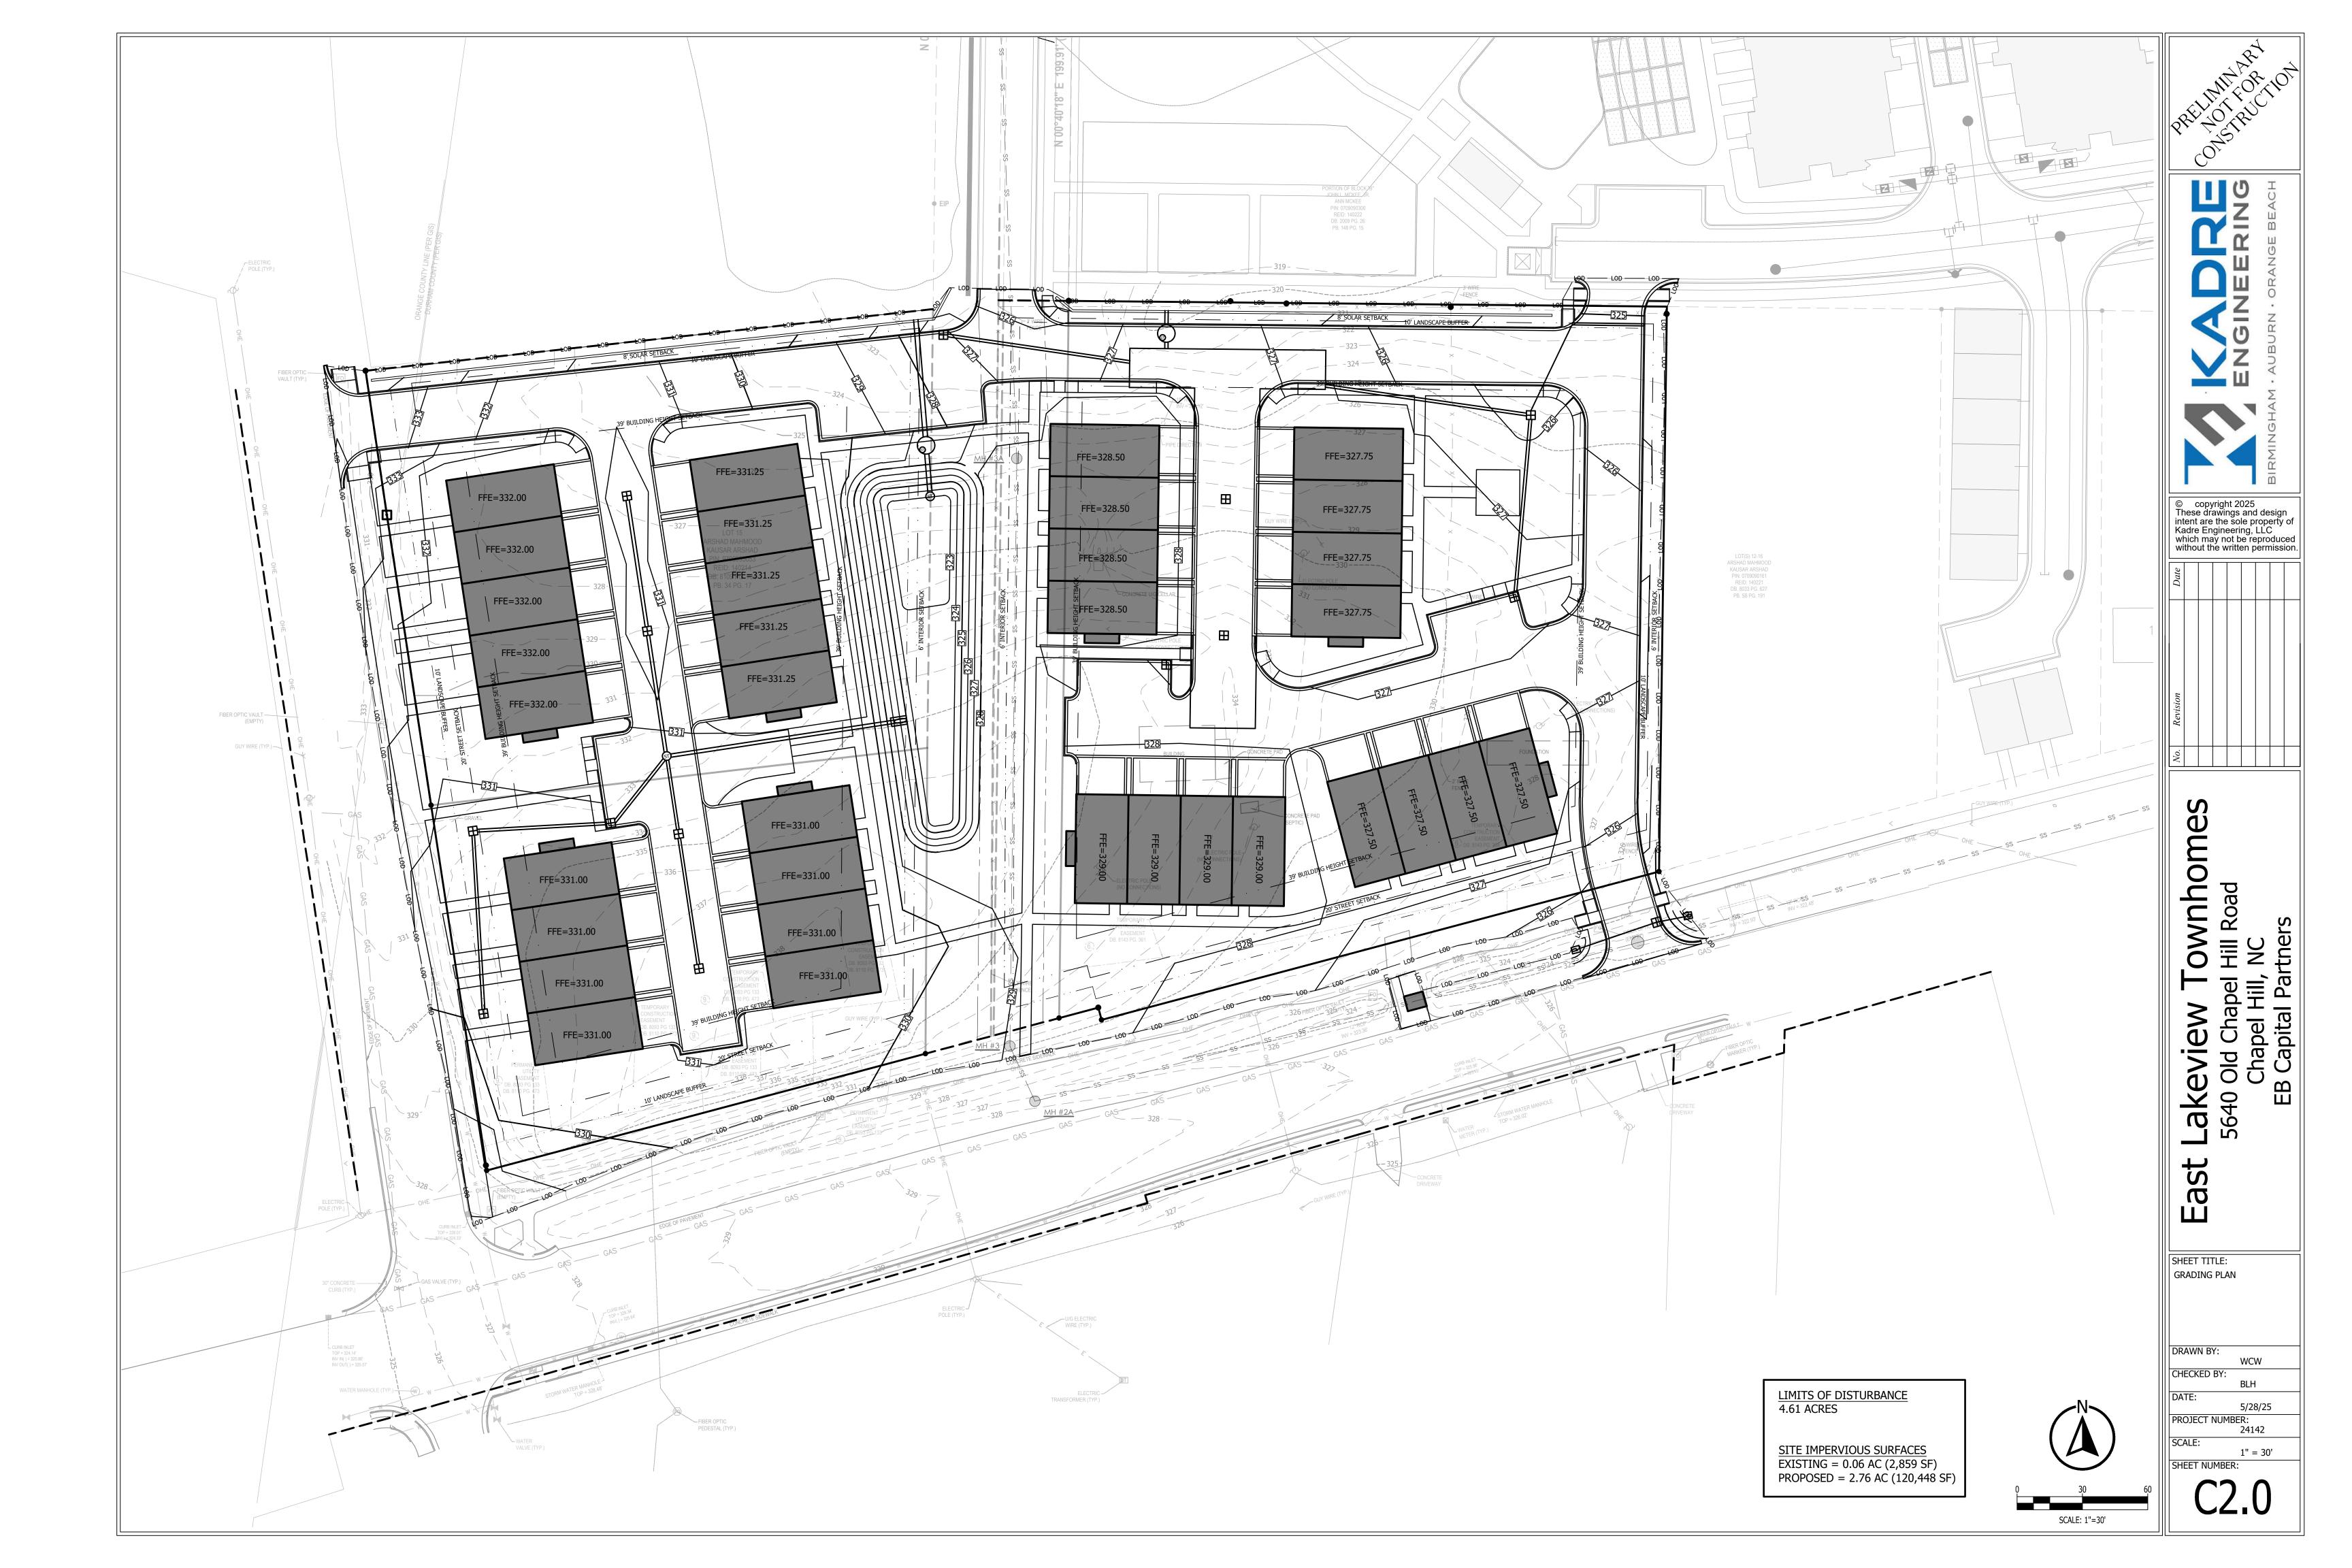

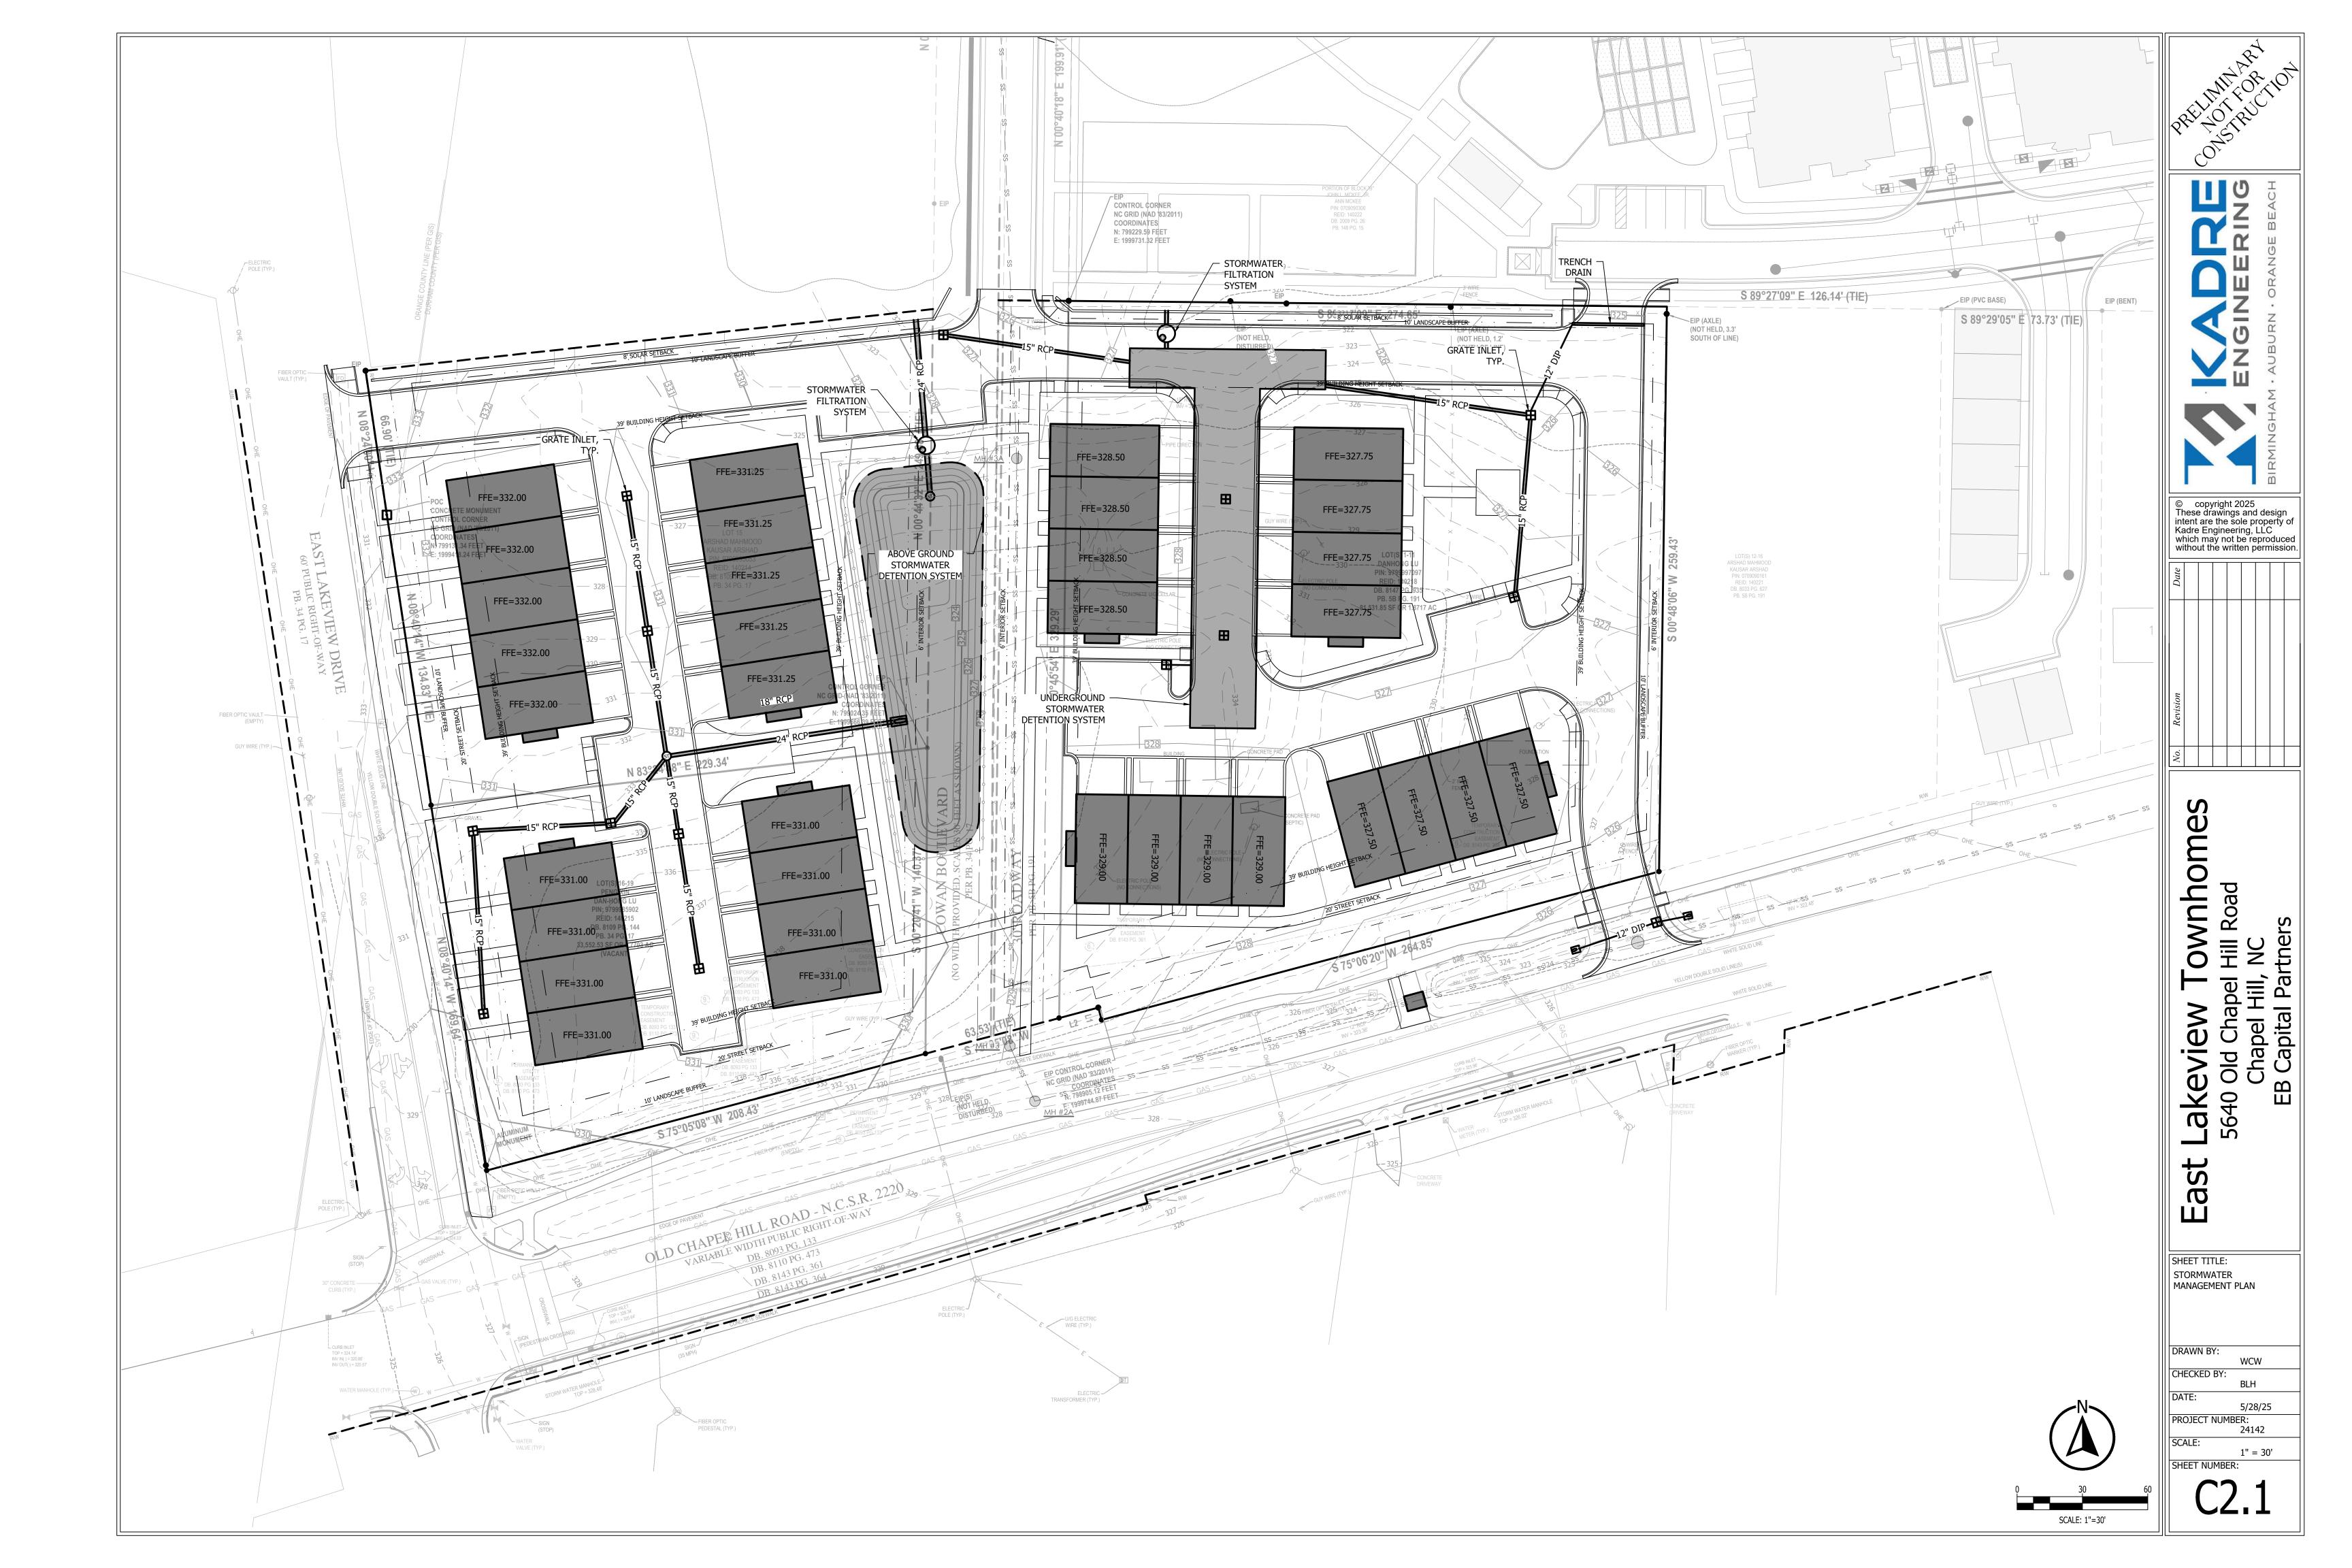




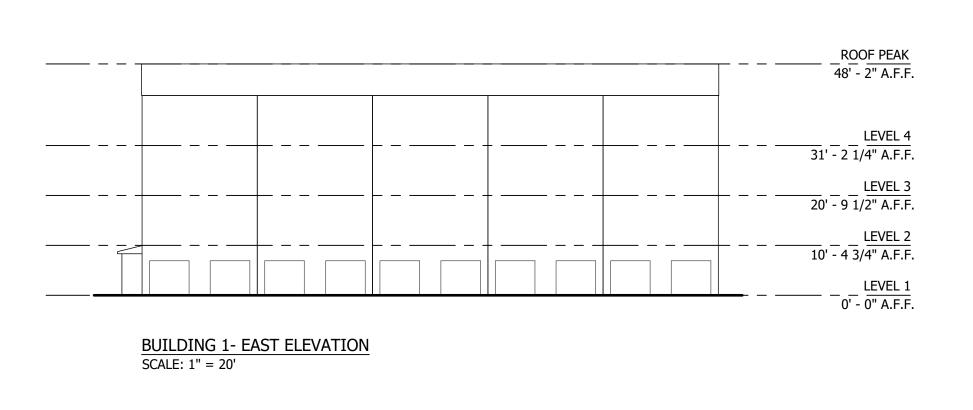


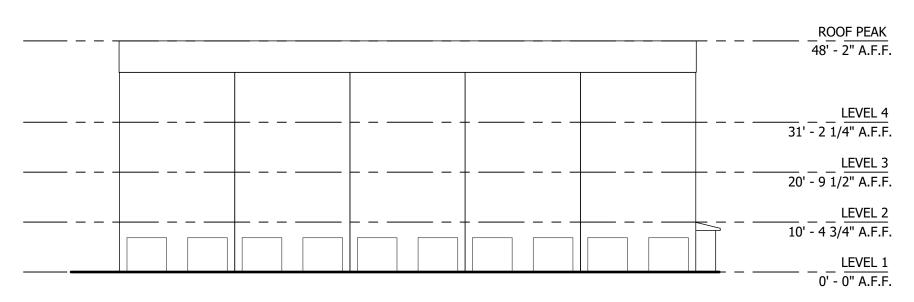


BUILDING 2 - WEST ELEVATION SCALE: 1" = 20'

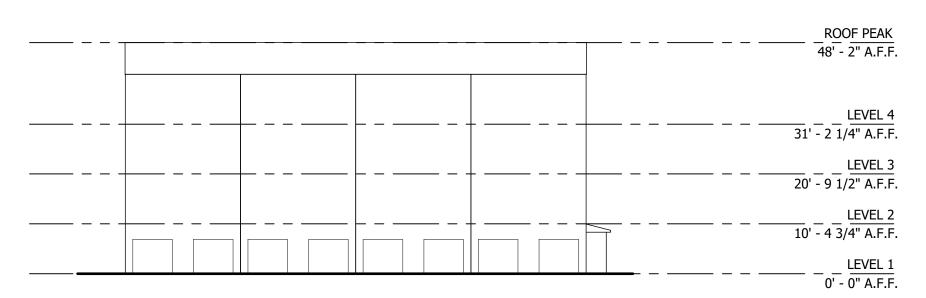


BUILDING 3 - EAST ELEVATION / BUILDING 6 - WEST ELEVATION / BUILDING 7 NORTH ELEVATION SCALE: 1" = 20'

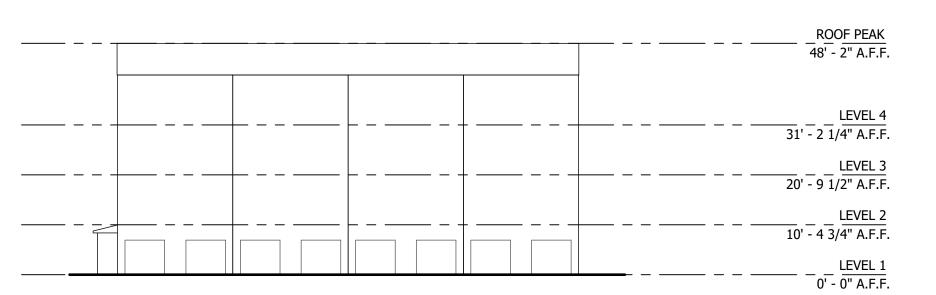

BUILDING 4 - WEST ELEVATION / BUILDING 5 - EAST ELEVATION / BUILDING 8 NORTH ELEVATION SCALE: 1" = 20'

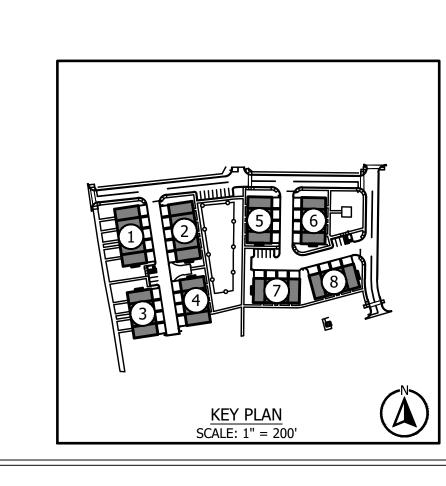



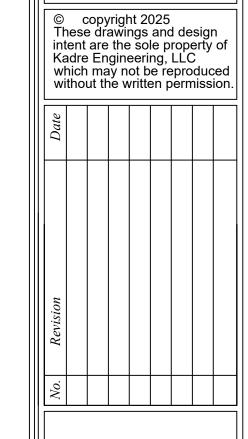


East Lakeview Townhomes
5640 Old Chapel Hill Road
Chapel Hill, NC
EB Capital Partners

DRAWN BY:
WCW
CHECKED BY:
BLH
DATE:

DATE: 5/28/25
PROJECT NUMBER: 24142
SCALE: 1" = 20'

SHEET NUMBER:

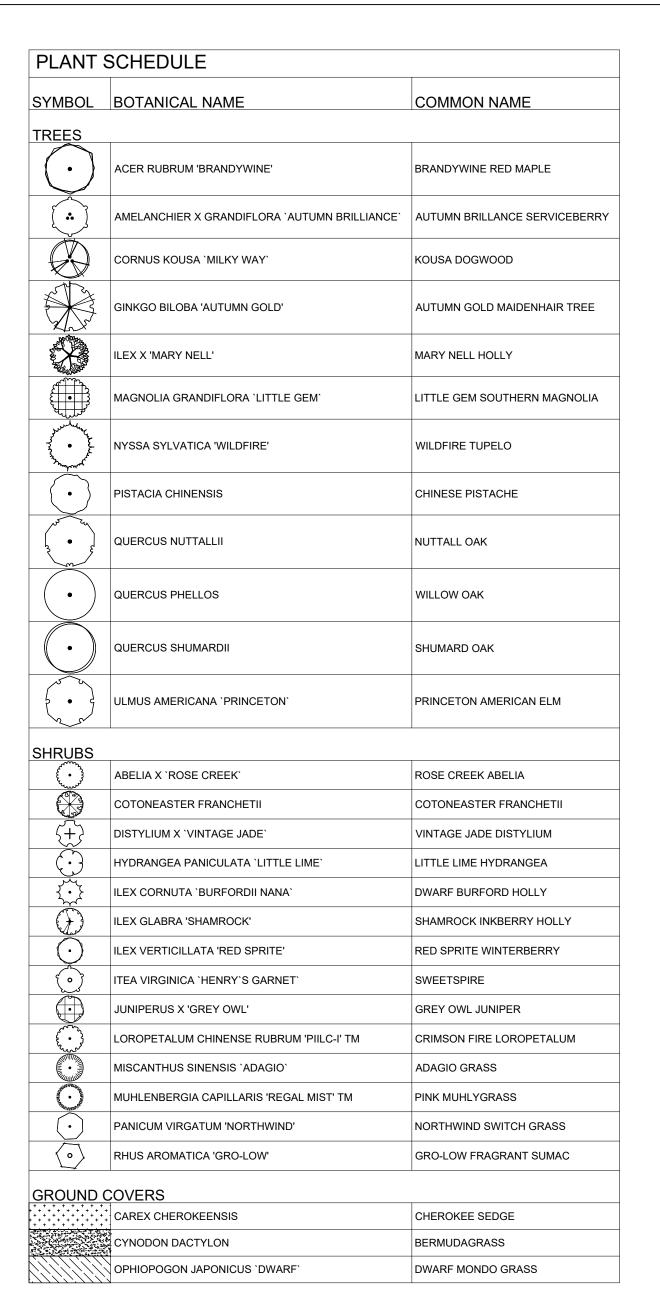

TREE PROTECTION REQUIREMENTS	
REQUIRED MINIMUM CANOPY COVERAGE: 30%	
LOTSIZE: 185,270 SQ FT.	REPLACEMENT TREES PROV

EXISTING CANOPY PROTECTED: 0 SQ FT

CANOPY DEFICIT: 55,581 SQ FT

CANOPY COVERAGE REQUIRED: 55,581 SQ FT

CANOPY COVERAGE PROVIDED: 56,000 SQ FT (30.22%)

Landscape Buffer	Required Type	Proposed Type
North (R-1 Zoning)	Type B—10' Internal	Type B 10' Buffer
South (Old Chapel Hill Rd)	Type C—20' External	Modified Type C 15' Buffer
East (R-1 Zoning)	Type B—10' Internal	Type B 10' Buffer
West (ELakeview Dr)	Type C—20' External	Modified Type C 10' Buffer

PARKING LOT SHADING CALCULATION

REQUIRED: One large canopy tree per 2,000SF of paved surface area planted within 10' of the parking lot

TOTAL PAVED SURFACE: 53,757 SQ FT

REQUIRED: 27 LARGE CANOPY TREES

PROVIDED: 27 LARGE CANOPY TREES

RECREATION SPACE CALCULATION RECREATION SPACE RATIO: .218

RECREATION SPACE RATIO: .218
GROSS LAND AREA: 185,270 SQ FT
REQUIRED RECREATION SPACE: 40,389 SQ FT
PROVIDED RECREATION SPACE: 28,333 SQ FT
RECREATION SPACE DEFICIT: 12,056 SQ FT






NOT FOR CONSTRUCTION

FOR REVIEW

T LAKEVIEW TOWNHOUSE OLD CHAPEL HILL RD CHAPEL HILL, NC

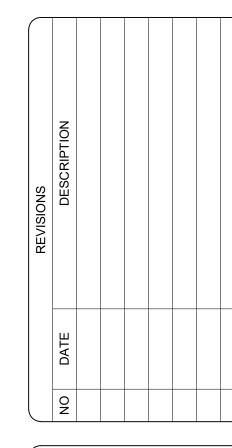

LANDSCAPE PLAN

JOB NO: KADR-2412

DATE: 04/18/2025

DRAWN BY: TJC

CHECKED BY: AJR

SHEET NUMBER:

L1.0

SYMBOL	BOTANICAL NAME	COMMON NAME			
TREES					
(*)	AMELANCHIER X GRANDIFLORA 'AUTUMN BRILLIANCE'	AUTUMN BRILLANCE SERVICEBERRY			
	CORNUS KOUSA 'MILKY WAY'	KOUSA DOGWOOD			
	GINKGO BILOBA 'AUTUMN GOLD'	AUTUMN GOLD MAIDENHAIR TREE			
	ILEX X 'MARY NELL'	MARY NELL HOLLY			
	MAGNOLIA GRANDIFLORA 'LITTLE GEM'	LITTLE GEM SOUTHERN MAGNOLIA			
and the second	NYSSA SYLVATICA 'WILDFIRE'	WILDFIRE TUPELO			
lacksquare	PISTACIA CHINENSIS	CHINESE PISTACHE			
•	QUERCUS PHELLOS	WILLOW OAK			
\$. c	ULMUS AMERICANA 'PRINCETON'	PRINCETON AMERICAN ELM			
SHRUBS					
(·)	ABELIA X 'ROSE CREEK'	ROSE CREEK ABELIA			
Ä	COTONEASTER FRANCHETII	COTONEASTER FRANCHETII			
ζ+}	DISTYLIUM X 'VINTAGE JADE'	VINTAGE JADE DISTYLIUM			
(``)	HYDRANGEA PANICULATA 'LITTLE LIME'	LITTLE LIME HYDRANGEA			
	ILEX CORNUTA 'BURFORDII NANA'	DWARF BURFORD HOLLY			
$\widetilde{\bigcirc}$	ILEX VERTICILLATA 'RED SPRITE'	RED SPRITE WINTERBERRY			
~~~~~~~~~~~~~~~~~~~~~~~~~~~~~~~~~~~~~~	LOROPETALUM CHINENSE RUBRUM 'PIILC-I' TM	CRIMSON FIRE LOROPETALUM			
•	MISCANTHUS SINENSIS 'ADAGIO'	ADAGIO GRASS			
JUNION AND COLOR	MUHLENBERGIA CAPILLARIS 'REGAL MIST' TM	PINK MUHLYGRASS			
•	PANICUM VIRGATUM 'NORTHWIND'	NORTHWIND SWITCH GRASS			
· ·	RHUS AROMATICA 'GRO-LOW'	GRO-LOW FRAGRANT SUMAC			
GROUND	COVERS				
	CAREX CHEROKEENSIS	CHEROKEE SEDGE			






NOT FOR CONSTRUCTION

FOR REVIEW

LAKEVIEW TOWNHOUSE OLD CHAPEL HILL RD CHAPEL HILL. NC

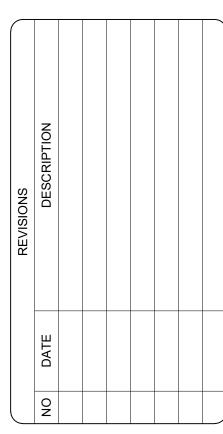

LANDSCAPE PLAN

JOB NO: KADR-2412


DATE: 04/18/2025


DRAWN BY: TJC

CHECKED BY: AJR

SHEET NUMBER:

20

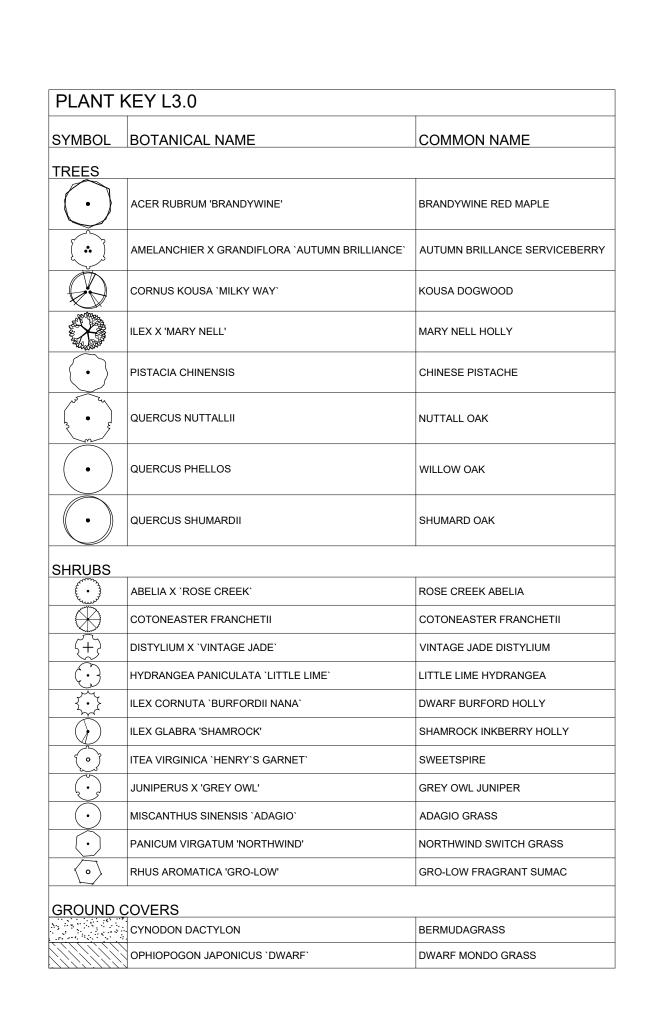

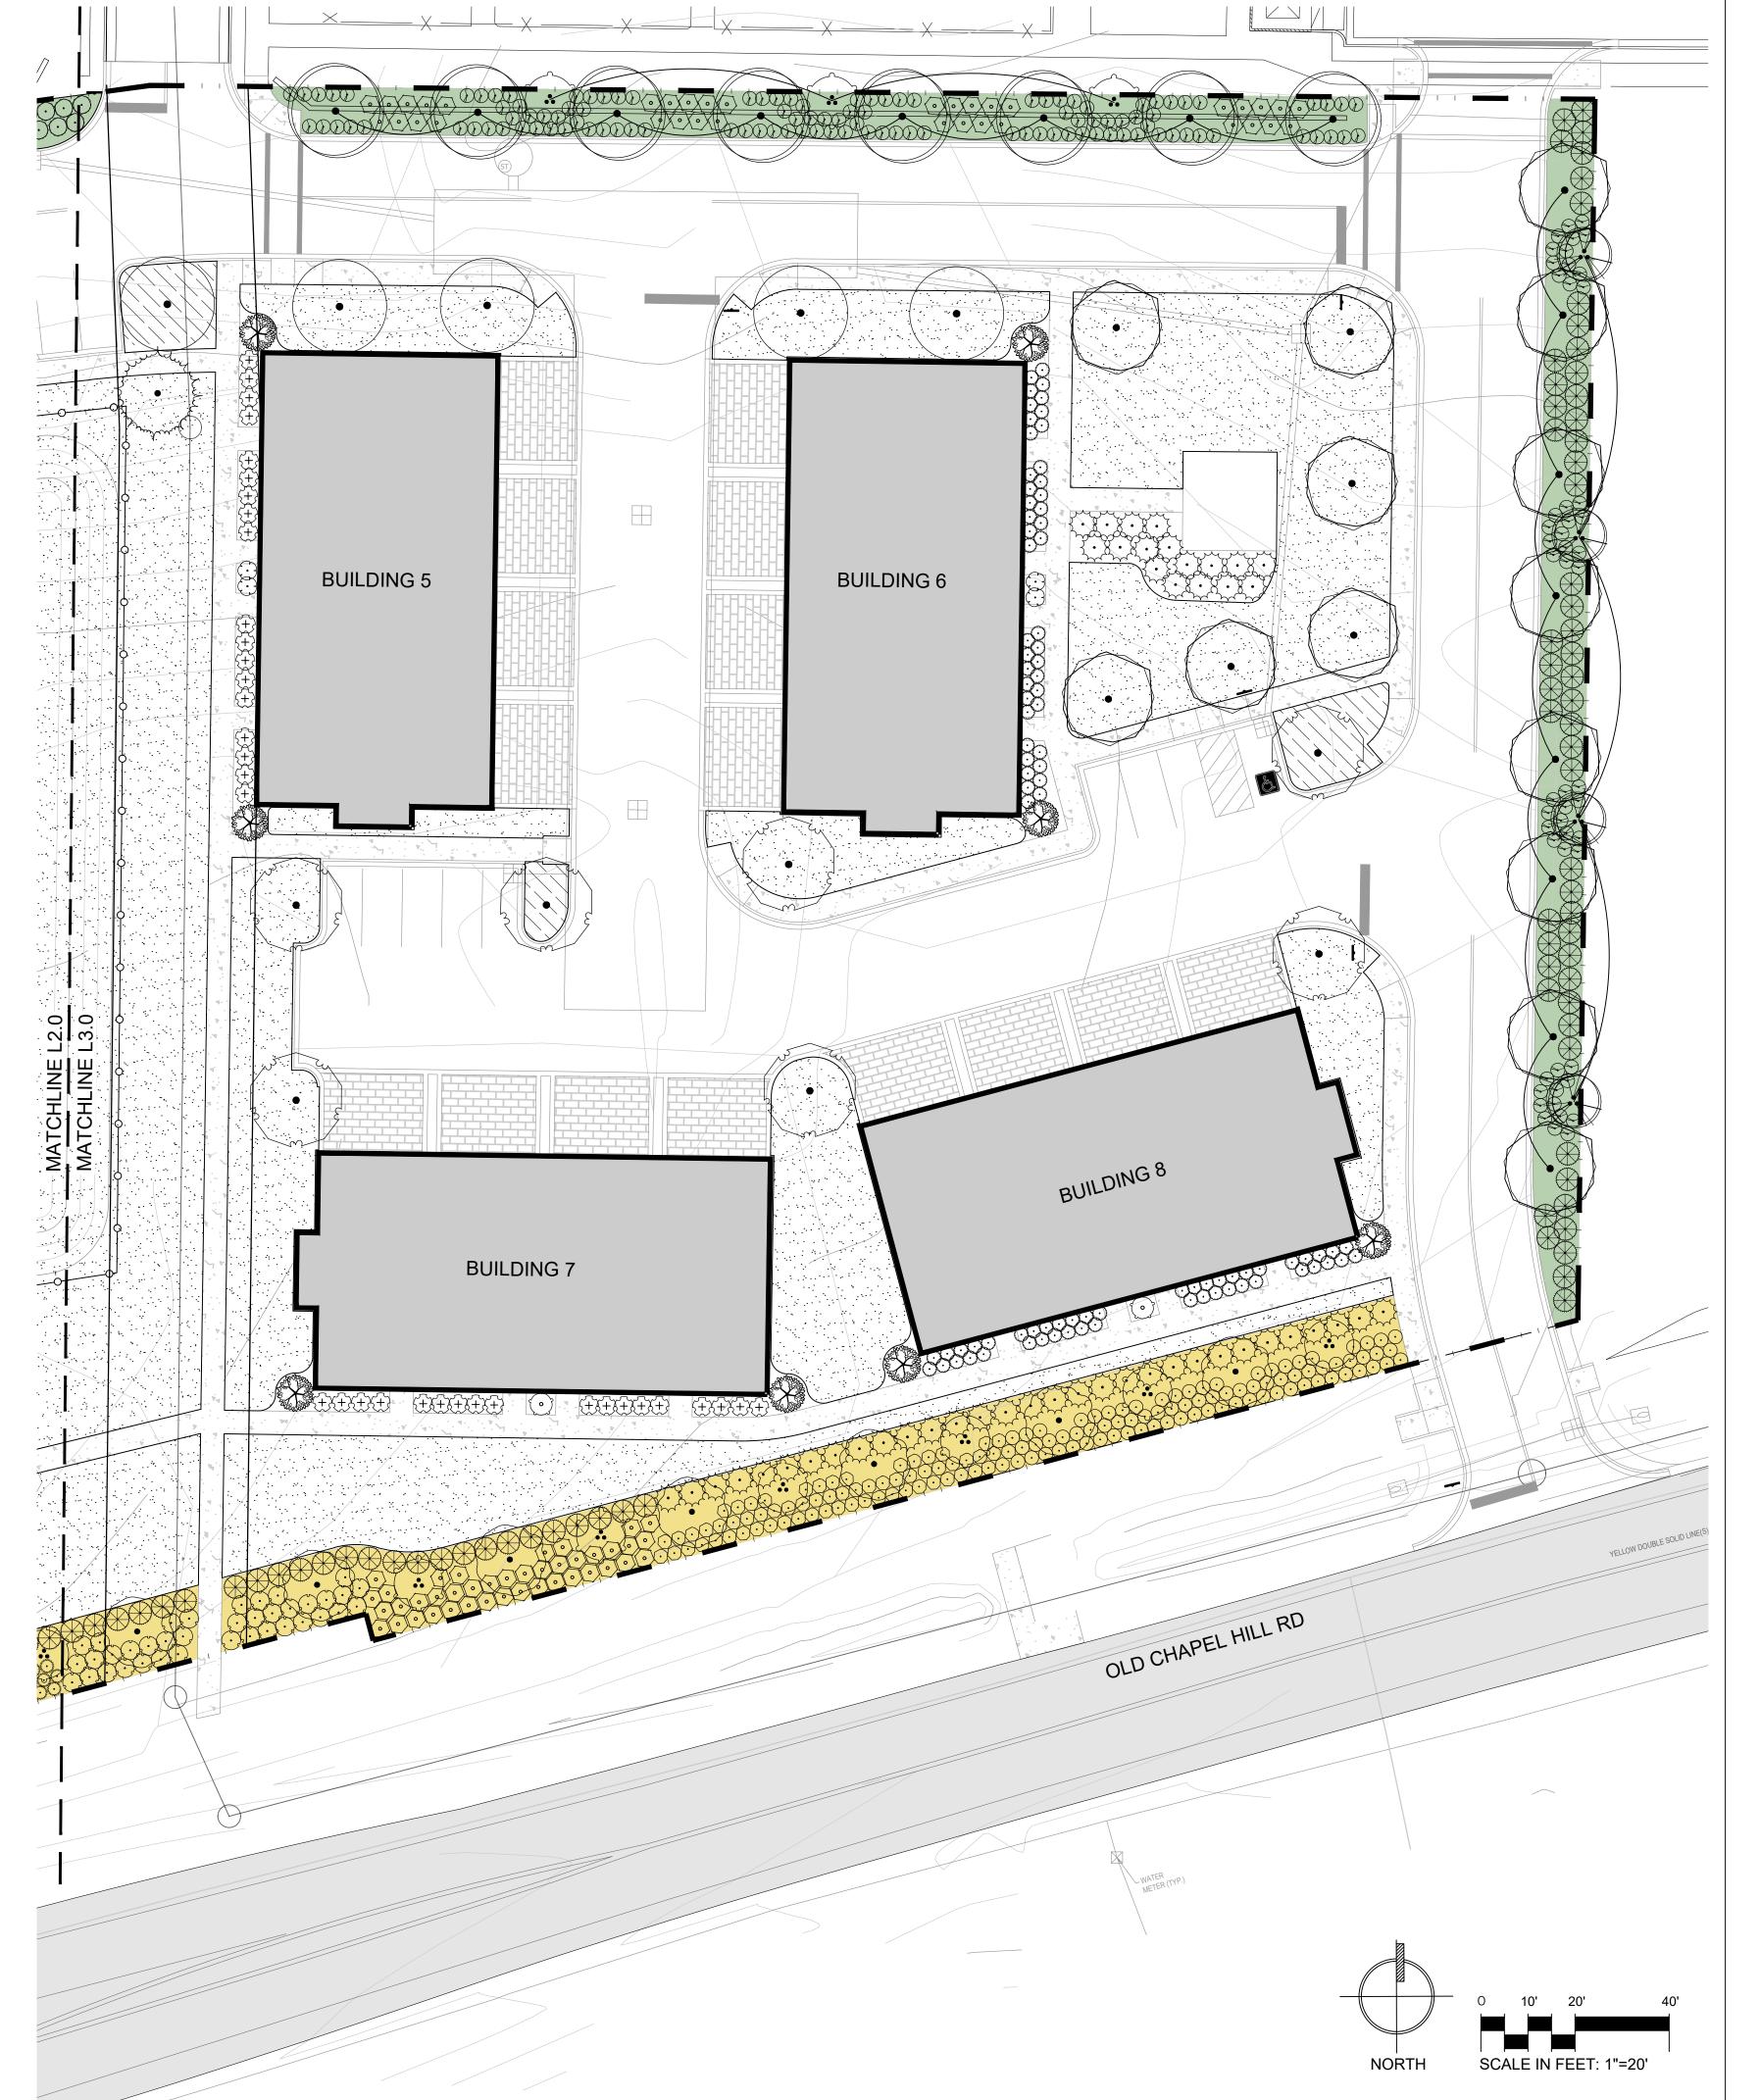




NOT FOR CONSTRUCTION

FOR REVIEW

AST LAKEVIEW TOWNHOUSE OLD CHAPEL HILL RD CHAPEL HILL, NC

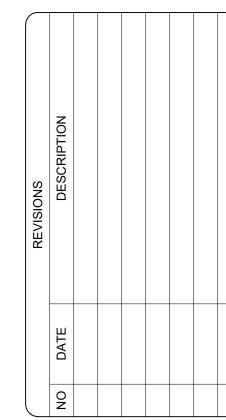

LANDSCAPE PLAN

JOB NO: KADR-2412

DATE: 04/18/2025

DRAWN BY: TJC

CHECKED BY: AJR

SHEET NUMBER:

L3.0

#### GENERAL NOTES:

- CONTRACTOR SHALL BE RESPONSIBLE FOR THE SITE INSPECTION PRIOR TO LANDSCAPE CONSTRUCTION AND INSTALLATION IN ORDER TO ACQUAINT HIMSELF WITH EXISTING CONDITIONS.
- 2. THE LOCATION OF ALL SURFACE AND UNDERGROUND STRUCTURES AND UTILITIES SHALL BE VERIFIED BY THE CONTRACTOR AT GROUND BREAK. THE CONTRACTOR SHALL BE RESPONSIBLE FOR PROTECTING ALL EXISTING STRUCTURES AND UTILITIES TO REMAIN FROM DAMAGE AS REQUIRED DURING CONSTRUCTION AND TO REPAIR ANY DAMAGE WHICH SHOULD OCCUR TO THE SATISFACTION OF THE OWNER/OR DAMAGED PARTY.
- 3. CONTRACTOR SHALL VERIFY PLANT COUNT FROM PLAN AND REPORT DIFFERENCES PRIOR TO CONSTRUCTION.
- 4. ALL PLANTING AREAS SHALL BE FREE OF OBSTRUCTIONS LARGER THAN 1 1/2" IN SIZE.
- 5. ALL TREES AND SPECIMEN PLANT MATERIAL SHALL BE LOCATED BY THE CONTRACTOR AT APPROVED NURSERIES OR THEIR EQUAL APPROVED PRIOR TO BIDDING.
- 6. ALL PLANT MATERIALS ARE SUBJECT TO APPROVAL OR REFUSAL BY THE LANDSCAPE ARCHITECT AT THE JOB SITE.
- THE LOCATION OF ALL TREES SHALL BE APPROVED BY THE LANDSCAPE ARCHITECT BEFORE THE DIGGING OF PITS. PLANTING SHALL BE LOCATED WHERE SHOWN ON THE DRAWINGS OR WHERE FIELD LOCATED BY LANDSCAPE ARCHITECT.
- 8. THE LOCATION OF ALL PLANTING BEDS SHALL BE APPROVED BY LANDSCAPE ARCHITECT BEFORE THE PREPARATION OF BEDS PLANTING SHALL BE LOCATED WHERE SHOWN ON THE DRAWINGS OR WHERE FIELD LOCATED BY LANDSCAPE ARCHITECT.A MINIMUM 72 HOUR NOTICE SHOULD BE GIVEN AND ANTICIPATED BY THE CONTRACTOR FOR THIS REVIEW.
- 9. MINIMIZE ALL ROOT DISTURBANCE WITHIN THE DRIP LINE OF ALL EXISTING TREES.
- 10. CONTRACTOR SHALL SUPPLY AND SPREAD 6" TOP-SOIL IN SHRUB BEDS AND ALL AREAS TO BE SEEDED UNLESS OTHERWISE NOTED IN SPECIFICATIONS.
- 11. THE LANDSCAPE CONTRACTOR SHALL PROVIDE APPROVED TOPSOIL TO PERFORM INCIDENTAL GRADING
- WORK.


  12. CONTRACTOR SHALL BE RESPONSIBLE FOR PROVIDING POSITIVE DRAINAGE IN ALL PLANT AREAS.
- 13. PLANTS SHALL BE WELL FORMED, VIGOROUS, GROWING SPECIMENS WITH GROWTH TYPICAL OF VARIETIES SPECIFIED AND SHALL BE FREE FROM INJURY, INSECTS AND DISEASES. PLANTS SHALL EQUAL OR SURPASS QUALITY AS DEFINED IN THE CURRENT ISSUE OF NURSERY "AMERICAN STANDARDS FOR NURSERY STOCK" AS PUBLISHED BY THE AMERICAN NURSERYMEN. INC.
- 14. ALL PLANT MATERIAL SHALL BE BALLED AND BURLAPPED OR CONTAINER GROWN.
- 15. ALL SHRUBS, TREES AND GROUND COVERS SHALL BE PLANTED WITH A SOIL MIXTURE CONSISTING OF 50% TOPSOIL AND ORGANIC MATERIAL AND PER SPECIFICATIONS.
- FRONT ROW OF SHRUBS SHALL BE PLANTED MINIMUM 24" BEHIND BED LINE @ LAWNS OR WALKS AND MINIMUM 36" BACK OF CURB @ PARKING SPACES.
- 17. BACK ROW OF SHRUB PLANTING SHALL BE PLANTED @ 36" OFF FACE OF BUILDING WALL, GROUND COVERS SHALL BE 12" OUT FROM BUILDING AS REQUIRED BY PLANT SPECIFICATIONS.
- 18. EXCAVATE EDGE OF ALL PLANTING BEDS TO 4" DEPTH TO FORM A NEAT CRISP DEFINITION.
- 19. ALL PLANTING BEDS AND TREE PITS SHALL BE MULCHED WITH A 3" SETTLED LAYER OF PINESTRAW.
- 20. MULCH ALL AREAS OF ANNUALS AND SPREADING GROUND COVER MASS PLANTING WITH 3 INCHES OF DOUBLE HAMMERED BROWN MULCH.
- 21. GRASS: ALL AREAS TO BE GRASSED SHALL BE TILLED AND GRADED TO A DEPTH OF 6". SLAG OF LIME SHALL BE APPLIED AT A RATE OF 100 POUNDS PER 1000 SQ. FT. ADD TURF GREEN OR EQUAL (12-5-8 SLOW RATE) AT A RATE OF 50 POUNDS PER 1000 SQ. FT. SEEDED AREAS SHALL BE COVERED WITH A THIN LAYER OF WHEAT
- 22. ALL DISTURBED AREAS NOT PLANTED WITH SHRUBS, TREES, OR SOD SHALL BE SEEDED.
- 23. GRADE ALL AREAS FOR APPROVAL BY LANDSCAPE ARCHITECT BEFORE SODDING.
- 24. SEASONAL COLOR SHALL BE PLANTED IN FLOWERING STATE.
- 25. CONTRACTOR SHALL GUARANTEE ALL PLANT MATERIAL, INCLUDING GRASS FOR ONE FULL YEAR FROM DATE OF SUBSTANTIAL COMPLETION.
- 26. REMOVE ALL GUY WIRES AND STAKES AT END OF GUARANTEE PERIOD.
- 27. WHEN TREES ARE PLANTED THE MONTHS OF MARCH THRU OCTOBER, THE LANDSCAPE CONTRACTOR SHALL AMEND THE SOIL MIX WITH A MOISTURE RETENTION AGENT AS 'TERRA-SORB' OR EQUAL FOR EACH TREE INSTALLATION.
- NOTE: ALL TREES AND SHRUBS NOT COVERED BY IRRIGATION TO BE AMENDED WITH TERRA SORB WATER RETAINING AGENT AS PER MANUFACTURERS RECOMMENDATIONS.

#### LAYOUT NOTES:


1. THE LOCATION OF ALL SURFACE AND UNDERGROUND STRUCTURES AND UTILITIES SHALL BE VERIFIED BY THE CONTRACTOR AT GROUND BREAK. THE CONTRACTOR SHALL BE RESPONSIBLE FOR PROTECTING ALL EXISTING STRUCTURES AND UTILITIES TO REMAIN FROM DAMAGE AS REQUIRED DURING CONSTRUCTION AND TO REPAIR ANY DAMAGE WHICH SHOULD OCCUR TO THE SATISFACTION OF THE OWNER/OR DAMAGED

#### 2. THE FINISHED GRADES SHALL BE FREELY DRAINING.


- 3. ALL SITE ELEMENT LOCATIONS SHALL BE APPROVED BY LANDSCAPE ARCHITECT PRIOR TO EXCAVATION/INSTALLATION.
- 4. IF APPLICABLE, THE LOCATION OF ALL FOOTINGS SHALL BE APPROVED BY THE LANDSCAPE ARCHITECT PRIOR TO EXCAVATION. FOOTINGS SHALL BE LOCATED WHERE SHOWN ON THE DRAWINGS OR WHERE FIELD LOCATED BY LANDSCAPE ARCHITECT.
- 5. THE LOCATION OF ALL PAVED AREAS SHALL BE APPROVED BY THE LANDSCAPE ARCHITECT PRIOR TO EXCAVATION. PAVED AREAS SHALL BE LOCATED WHERE SHOWN ON THE DRAWINGS OR WHERE FIELD LOCATED BY LANDSCAPE ARCHITECT.
- 6. MINIMIZE ALL ROOT DISTURBANCE WITHIN THE DRIP LINE OF ALL EXISTING TREES.
- 7. COORDINATE SLEEVE LOCATION/INSTALLATION WITH LANDSCAPE CONTRACTOR. INSTALLATION IS THE RESPONSIBILITY OF GENERAL CONTRACTOR.
- 8. IRRIGATION SLEEVES ARE TO BE SCHEDULE 40 PVC PIPE, PER SPECIFICATIONS, EXTENDED 18" MINIMUM BEYOND CURB OR PAVEMENT EDGE.
- 9. IRRIGATION SLEEVES ARE TO BE MARKED (EACH END) WITH A 2" X 4" STAKE FOR EASE OF LOCATION BY THE LANDSCAPE CONTRACTOR. SECURE OR CAP EACH END OF SLEEVE DURING INSTALLATION TO PREVENT

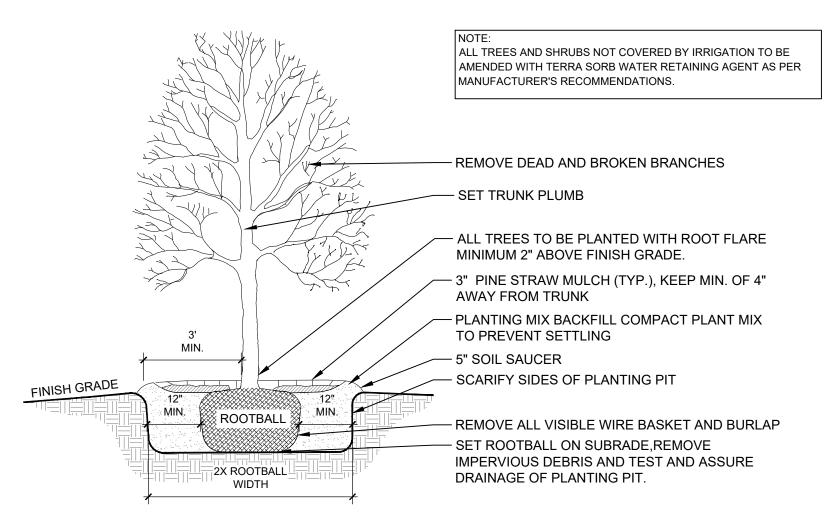

## TYPICAL TREE PLANTING

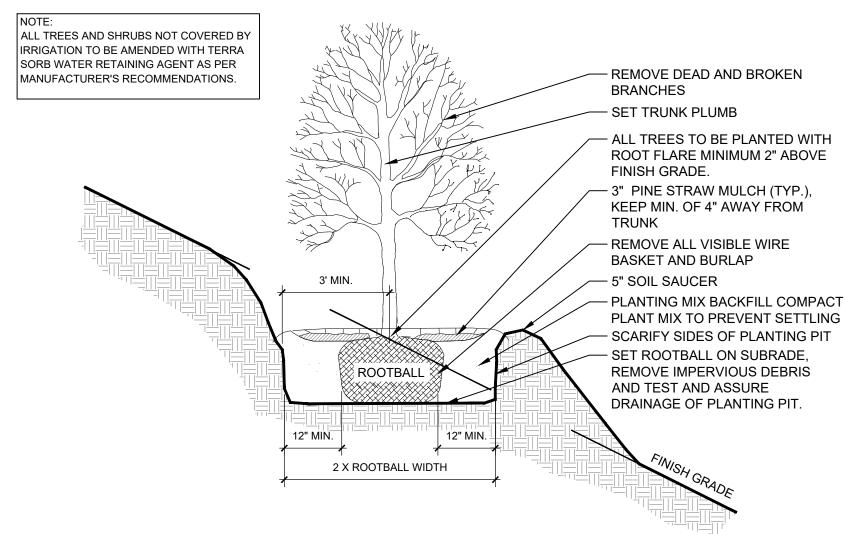


## 2 TYPICAL SLOPE PLANTING

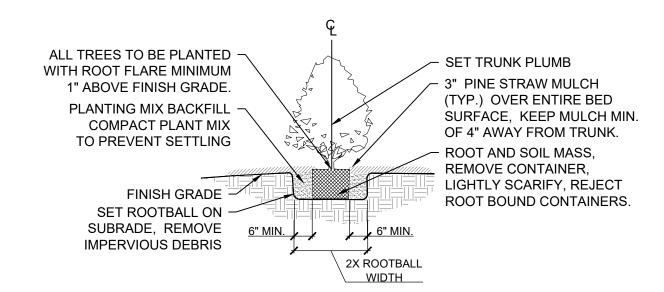


## TYPICAL CONTAINERIZED SHRUB PLANTING NTS

TRENCH EDGE TO BE LOCATED BETWEEN
PLANTING BEDS AND ALL LAWN AREAS AND
AROUND TREE PITS LOCATED IN LAWN AREAS.

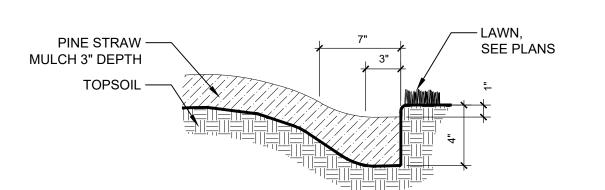



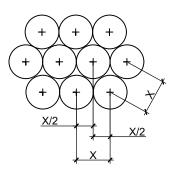

 SEE PLANTING PLANS FOR SHRUB & GROUNDCOVER BED AREAS.
 ROWS SHALL BE STRAIGHT & PARALLEL.
 SPACING SHOWN ON PLANT SCHEDULE (X).

## 5 TYPICAL STAGGERED ROW PLANTING


PLANT :	SCHEDU	JLE						
SYMBOL	QTY	BOTANICAL NAME	COMMON NAME	CAL	HT	SPREAD	SPACING	REMARKS
TREES								
$\bigcirc$	14	ACER RUBRUM 'BRANDYWINE'	BRANDYWINE RED MAPLE	4" CAL.	17` - 19` MIN.	8` - 10` MIN.	AS DRAWN	FULL, STRONG CENTRAL LEADER, NC NATIVE
•	14	AMELANCHIER X GRANDIFLORA 'AUTUMN BRILLIANCE'	AUTUMN BRILLANCE SERVICEBERRY	B & B	8` - 10`	4`-5`	AS DRAWN	MIN. 3 TRUNKS, EACH TRUNK 1.5" CAL, NC NATIVE
	13	CORNUS KOUSA 'MILKY WAY'	KOUSA DOGWOOD	B & B	6`-7`	5` - 6`	AS DRAWN	FULL, HEALTHY PLANT
	4	GINKGO BILOBA 'AUTUMN GOLD'	AUTUMN GOLD MAIDENHAIR TREE	4" CAL.	13` - 15`	4`-5`	AS SHOWN	STRONG CENTRAL LEADER, HEALTHY
	16	ILEX X 'MARY NELL'	MARY NELL HOLLY	B & B	6`-7`	3'-4'	AS DRAWN	FULL TO GROUND, HEALTHY PLANT
	5	MAGNOLIA GRANDIFLORA `LITTLE GEM`	LITTLE GEM SOUTHERN MAGNOLIA	B & B	8` - 9` MIN.	4` - 5` MIN.	AS DRAWN	FULL TO GROUND, HEALTHY, NC NATIVE
- Let	13	NYSSA SYLVATICA 'WILDFIRE'	WILDFIRE TUPELO	4" CAL.	16` - 18` MIN.	8` - 10` MIN.	AS DRAWN	FULL, STRONG CENTRAL LEADER, NC NATIVE
•	12	PISTACIA CHINENSIS	CHINESE PISTACHE	2.5" CAL.	9` - 11`	4` - 5`	AS DRAWN	STANDARD TRUNK, HEALTHY PLANT
200	7	QUERCUS NUTTALLII	NUTTALL OAK	2.5" CAL.	12` - 14` MIN.	5` - 6` MIN.	AS DRAWN	FULL, STRONG CENTRAL LEADER, NC NATIVE
•	7	QUERCUS PHELLOS	WILLOW OAK	4" CAL.	18` MIN.	8` - 10` MIN.	AS DRAWN	FULL, STRONG CENTRAL LEADER, NC NATIVE
	8	QUERCUS SHUMARDII	SHUMARD OAK	2.5" CAL.	12`-14`	4'-5'	AS DRAWN	FULL, STRONG CENTRAL LEADER, NC NATIVE
	9	ULMUS AMERICANA `PRINCETON`	PRINCETON AMERICAN ELM	2.5" CAL.	12`-14`	5` - 6`	AS DRAWN	FULL, STRONG CENTRAL LEADER, NC NATIVE
YMBOL	QTY	BOTANICAL NAME	COMMON NAME	SIZE	HT.	SPREAD	SPACING	REMARKS
HRUBS								
	191	ABELIA X `ROSE CREEK`	ROSE CREEK ABELIA	3 GAL.	12"-15" MIN.	12"-16" MIN.	36" O.C.	FULL, HEALTHY PLANT
<u> </u>	98	COTONEASTER FRANCHETII	COTONEASTER FRANCHETII	3 GAL	18"-24" MIN.	15" - 18" MIN.	5` O.C.	FULL, HEALTHY PLANT
+	139	DISTYLIUM X 'VINTAGE JADE'	VINTAGE JADE DISTYLIUM	3 GAL	12"-15" MIN.	12"-16" MIN.	4` O.C.	FULL, HEALTHY PLANT
	14	HYDRANGEA PANICULATA `LITTLE LIME`	LITTLE LIME HYDRANGEA	3 GAL	18"-24" MIN.	18"-24" MIN.	4` O.C.	FULL, HEALTHY PLANT
***	68	ILEX CORNUTA 'BURFORDII NANA'	DWARF BURFORD HOLLY	7 GAL	24" - 30" MIN.	24" - 30" MIN.	6` O.C.	FULL, HEALTHY PLANT
	167	ILEX GLABRA 'SHAMROCK'	SHAMROCK INKBERRY HOLLY	3 GAL.	15"-18" MIN.	10"-14" MIN.	36" O.C.	FULL, HEALTHY PLANT, NC NATIVE
$\bigcirc$	120	ILEX VERTICILLATA 'RED SPRITE'	RED SPRITE WINTERBERRY	3 GAL	18" - 24" MIN.	12"-16" MIN.	48" O.C.	FULL, HEALTHY PLANT, NC NATIVE
(0)	2	ITEA VIRGINICA 'HENRY'S GARNET'	SWEETSPIRE	3 GAL	18" - 24" MIN.	15" - 18" MIN.	5` O.C.	FULL, HEALTHY PLANT, NC NATIVE
<u> </u>	38	JUNIPERUS X 'GREY OWL'	GREY OWL JUNIPER	3 GAL	12"-15" MIN.	15" - 18" MIN.	48" O.C.	FULL, HEALTHY PLANT
{~~~~	57	LOROPETALUM CHINENSE RUBRUM 'PIILC-I' TM	CRIMSON FIRE LOROPETALUM	3 GAL.	18" - 24" MIN.	15" - 18" MIN.	36" O.C.	FULL, HEALTHY PLANT
$\overline{\bullet}$	136	MISCANTHUS SINENSIS 'ADAGIO'	ADAGIO GRASS	3 GAL	15"-18" MIN.	10"-14"	36" O.C.	FULL, HEALTHY PLANT
JANANANA PARA	133	MUHLENBERGIA CAPILLARIS 'REGAL MIST' TM	PINK MUHLYGRASS	3 GAL	15"-18" MIN.	12" - 18" MIN.	36" O.C.	FULL, HEALTHY PLANT, NC NATIVE
$\overline{\bullet}$	156	PANICUM VIRGATUM 'NORTHWIND'	NORTHWIND SWITCH GRASS	3 GAL.	12"-15" MIN.	10"-14" MIN.	36" O.C.	FULL, HEALTHY PLANT, NC NATIVE
· >	109	RHUS AROMATICA 'GRO-LOW'	GRO-LOW FRAGRANT SUMAC	3 GAL.	10" - 14" MIN	10"-14"	48" O.C.	FULL, HEALTHY PLANT, NC NATIVE
YMBOL	QTY	BOTANICAL NAME	COMMON NAME	CONT	HT.	SPREAD	SPACING	REMARKS
ROUND (	COVERS							
* * * * * * * * * * * * * * * * * * *	121	CAREX CHEROKEENSIS	CHEROKEE SEDGE	1 GAL	MIN. 6" HT.		18" O.C.	FULL, HEALTHY PLANT, NC NATIVE
	46,092 SF	CYNODON DACTYLON	BERMUDAGRASS	FLAT				HEALTHY, NO YELLOWING OR PESTS, CUT NO MORE THAN 24 HRS. BEFORE LAYING
11111111	1,279	OPHIOPOGON JAPONICUS 'DWARF'	DWARF MONDO GRASS	4"POT	3" - 4" MIN.		10" O.C.	FULL, HEALTHY PLANT



NOT FOR CONSTRUCTION

FOR REVIEW

AST LAKEVIEW TOWNHOUSES OLD CHAPEL HILL RD CHAPEL HILL, NC

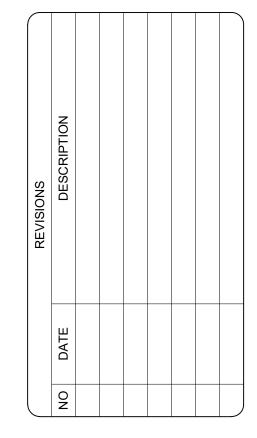

LANDSCAPE DETAILS & SCHEDULE

 JOB NO:
 KADR-2412

 DATE:
 04/18/2025

 DRAWN BY:
 TJC

 CHECKED BY:
 AJR

SHEET NUMBER:

L4.0