### **CONDITIONAL ZONING APPLICATION**



#### **TOWN OF CHAPEL HILL Planning Department**

405 Martin Luther King Jr. Blvd. Chapel Hill, NC 27514 phone (919) 969-5040 fax (919) 969-2014 www.townofchapelhill.org

Parcel Ider	ntifier Number (PIN	): <u>9778-37-4748, 9778-37</u>	-6817		Da	ate: 22 May 2020
Section A	: Project Inform	ation				
Project Name:		Rosemary Street Parking D	eck			
Property A	address:	125 E Rosemary St			Zip Code:	27514
Use Group	s (A, B, and/or C):	С			Existing Zoning District:	TC-2
During Do		Demolition of 276 space ex	kisting pa	arking deck a	nd construction of a 1,00	0 to 1,100 space deck
Project De	scription:					
Saction B	· Applicant Ow	ner, and/or Contract Pu	ırchasa	r Informat	ion	
					1011	
		(to whom correspondenc	e will be	e mailed):		
Name:		ates, attn: George Retschle				
Address:	221 Providence R	0ad				
City:	Chapel Hill		State:	NC OI	Zip Cod	le: 27514
Phone:	(919) 929-0481		Email:	georger@b	apa.eng.pro	
The u	ndersigned applic	cant hereby certifies that,	to the b	est of their	knowledge and belief,	all information
suppl	ied with this appli	ication and accurate.				
Signature:	B	6			Date: 22 M	ay 2020
Owne	er/Contract Purch	naser Information:				
$\boxtimes$ o	wner		⊠ Con	tract Purch	aser	
Name:	Grubb Manageme	ent LLC c/o Grubb Properties	s, Inc			
Address:	113 Edinburgh So	outh Drive Suite 120				
City:	Cary		State:	NC	Zip Cod	le: 27511
Phone:	(919) 388-5774		Email:	JDye@grub	obproperties.com	
The u	ndersigned applic	cant hereby certifies that,	to the b	est of their	knowledge and belief.	all information
		ication and accurate.	to the b	rest of their	Mowledge and belief,	an information
Signature:		For M			Date: 22 M	ay 2020
		75				
		Click <u>here</u> for a	pplicatio	n submittal i	nstructions.	

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### **CONDITIONAL ZONING**



TOWN OF CHAPEL HILL Planning and Development Service

Conditional Rezoning applications are reviewed by staff, Planning Commission, and Town Council. The application is part of an open public process that enables Town Council to discuss and decide on the key issues of a rezoning proposal. If a rezoning is approved, the applicant may then submit a detailed final plan application to staff for compliance review with the technical development standards and with the Council rezoning approval.

The establishment of a Conditional Zoning District shall be consistent with the Land Use Plan in the Comprehensive Plan. A proposed Conditional Zoning District is deemed consistent if the proposed District will be located in conformance with an adopted small area plan and/or in one of the following Land Use Categories:

- Medium Residential
- High Residential
- Commercial
- Mixed Use, Office/Commercial Emphasis
- Mixed Use, Office Emphasis
- Town/Village Center
- Institutional
- Office
- University
- Development Opportunity Area
- Light Industrial Opportunity Area

If the proposed conditional zoning districts is located in a Low Residential or a Rural Residential Land Use Category, the Town Council must approve a Land Use Plan amendment prior to proceeding.

SIGNED CONDITIONS: All conditions shall be in writing, prepared by the owner of the property or an attorney and must be signed by all property owners and contract purchasers, if applicable. The Town Attorney may require additional signatures if necessary and will determine whether or not the conditions statement is legally sufficient. Within thirty (30) days after receipt of the conditions the Planning Division Manager will notify the applicant of any deficiencies in the conditions statement or if any additional information is needed. The applicant may make changes to the written conditions statement provided it is submitted at least thirty (30) prior to Planning Commission meeting or thirty (30) days prior to Town Council public hearing.

RECORDATION OF CONDITIONS: After a rezoning has been approved by the Town Council, the conditions statement shall be recorded with the Register of Deeds Office. After a rezoning has been approved by Town Council and recorded by the Register of Deeds Office, the conditions may not be amended except through a new rezoning application.



### PROJECT FACT SHEET

TOWN OF CHAPEL HILL

Planning and Development Service

Section A: Project Information								
Use Type: (check/list all that apply)								
☐ Office/Institutional ☐ Residential ☐ Mixed-Use ☐ Other:								
Overlay District: (check all that apply)								
☐ Historic District ☐ Neighborhoo	d Conservation Distric	ct 🔲 Airport Haza	rd Zone					
Section B: Land Area								
Net Land Area (NLA): Area within zoning lot boo	undaries			NLA=	73,097	sq. ft.		
Choose one, or both, of of-way	Area (total adjacent fr	ontage) x ½ width of p	ublic right-	CSA=	7,310	sq. ft.		
the following (a or b), not to exceed 10% of NLA  b) Credited Perma dedicated open sp		al adjacent frontage) x	½ public or	COS=		sq. ft.		
TOTAL: NLA + CSA and/or COS = Gross Land Are	a (not to exceed NLA	+ 10%)		GLA=	80,407	sq. ft.		
Special Protection Areas: (check all those to Dordan Buffer Resource Conservation Areas: Conservation Areas: Resource Conservation A	hat apply)	d Impervious Area	☐ Wate	rshed Pro	otection Dist	rict		
Land Disturbance					Total (sq. ft.)			
Area of Land Disturbance (Includes: Footprint of proposed activity plus work a all grading, including off-site clearing)	area envelope, staging a	rea for materials, access/	equipment pa	ths, and	79,000			
Area of Land Disturbance within RCD					0			
Area of Land Disturbance within Jordan Buffer					0			
Impervious Areas Existing (sq. ft.) Demolition (sq. ft.) Proposed (sq. ft.)						q. ft.)		
Impervious Surface Area (ISA)	66,548	66,548	64,496		64,496			
Impervious Surface Ratio: Percent Impervious Surface Area of Gross Land Area (ISA/GLA)%	82.76	82.76	80.21		80.21			
If located in Watershed Protection District, % of impervious surface on 7/1/1993								



### PROJECT FACT SHEET

TOWN OF CHAPEL HILL

Planning and Development Service

### Section D: Dimensions

Dimensional Unit (sq. ft.)	Existing (sq. ft.)	Demolition (sq. ft.)	Proposed (sq. ft.)	Total (sq. ft.)
Number of Buildings	1 +/- 200 sf enclosed	all	1,415 enclosed	1,415
Number of Floors	3	3	6-7	6-7
Recreational Space	n/a	n/a	n/a	n/a

Residential Space						
Dimensional Unit (sq. ft.)	Existing (sq. ft.)	Demolition (sq. ft.)	Proposed (sq. ft.)	Total (sq. ft.)		
Floor Area (all floors – heated and unheated)						
Total Square Footage of All Units						
Total Square Footage of Affordable Units						
Total Residential Density						
Number of Dwelling Units						
Number of Affordable Dwelling Units						
Number of Single Bedroom Units						
Number of Two Bedroom Units						
Number of Three Bedroom Units						

Non-Residential Space (Gross Floor Area in Square Feet)							
Use Type	Existing	Proposed	Uses	Existing	Proposed		
Commercial							
Restaurant			# of Seats				
Government							
Institutional							
Medical							
Office		5000					
Hotel			# of Rooms				
Industrial							
Place of Worship			# of Seats				
Other	200	1000 (Storage)					

	Dimensional Requirements	Required by Ordinance	Existing	Proposed
	Street	0	9.5	8
Setbacks	Interior (neighboring property lines)	0	0	0
(minimum)	Solar (northern property line)	0 (TC-2), 11 (R-3), 8 (R-6)	10	0 (TC-2), 5 (R-3, R-6)
Height	Primary	44	34	73
(maximum)	Secondary	90	40	73
Streets	Frontages	12	191/165	356
Streets	Widths	15	191/165	356

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# PROJECT FACT SHEET TOWN OF CHAPEL HILL Planning and Development Services

#### **Section F: Adjoining or Connecting Streets and Sidewalks**

Note: For approval	of proposed	street names	contact the En	naineerina De	nartment
riote. For approvar	of proposed	Juice mannes,	CONTRACT THE EN	igniceling be	partificati.

Street Name	Right-of-Way Width	Pavement Width	Number of Lanes	Existing Sidewalk*	Existing Curb/Gutter
Rosemary St	60	39	3		
				Yes	Yes

#### **List Proposed Points of Access** (Ex: Number, Street Name):

\*If existing sidewalks do not exist and the applicant is adding sidewalks, please provide the following information:

Sidewalk Information							
Street Names	Dimensions	Surface	Handicapped Ramps				
			Yes No N/A				
			Yes No N/A				

#### **Section G: Parking Information**

Parking Spaces	Minimum	Maximum	Proposed
Regular Spaces			1,076
Handicap Spaces			28
Total Spaces			1,104
Loading Spaces			
Bicycle Spaces			40
Surface Type	conc parking deck	<u>.</u>	

#### **Section H: Landscape Buffers**

Location (North, South, Street, Etc.)	Minimum Width	Proposed Width	Alternate Buffer	Modify Buffer
North 1	15 & 20	6		☐ Yes
North 2	15	varies		☐ Yes
south, east, west	0	0	☐ Yes	☐ Yes
			☐ Yes	☐ Yes

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# PROJECT FACT SHEET TOWN OF CHAPEL HILL Planning and Development Services

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Section		Lallu	USE	шеп	ISILV

Existing Zoning District:
Proposed Zoning Change (if any):

Zoning – Area – Ratio			Impervious Surface Thresholds			Minimum and Maximum Limitations	
Zoning District(s)	Floor Area Ratio (FAR)	Recreation Space Ratio (RSR)	Low Density Residential (0.24)	High Density Residential (0.50)	Non- Residential (0.70)	Maximum Floor Area (MFA) = FAR x GLA	Minimum Recreation Space (MSR) = RSR x GLA
TC-2 CZ	1.97	n/a			n/a	158,402	n/a
TOTAL							
RCD Streamside		0.01					
RCD Managed		0.019					
RCD Upland							

### **Section J: Utility Service**

Check all that apply:				
Water		☐ Individual Well	Community Well	Other
Sewer		☐ Individual Septic Tank	Community Package Plant	Other
Electrical	□ Underground	Above Ground		
Telephone	□ Underground	Above Ground		
Solid Waste	Town	Private		

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TOWN OF CHAPEL HILL Planning and Development Services

The following must accompany your application. Failure to do so will result in your application being considered incomplete. For assistance with this application, please contact the Chapel Hill Planning Department (Planning) at (919) 969-5066 or at planning@townofchapelhill.org.

Х	Application fee (including Engineering Review fee)       (refer to fee schedule)       Amount Paid \$ 8,585							
Χ	Pre-application meeting –with appropriate staff							
Х	Digital Files – provide digital files of all plans and documents							
Х	Recorded Plat or Deed of Property							
Х	Project Fact Sheet							
Pend	Traffic Impact Statement – completed by Town's consultant (or exemption)							
n/a	Description of Public Art Proposal, if applicable							
Х	Statement of Justification							
n/a	Response to Community Design Commission and Town Council Concept Plan comments							
n/a	Affordable Housing Proposal, if applicable							
Х	Statement of Consistency with Comprehensive Plan or request to amend Comprehensive Plan							
Х	Mailing list of owners of property within 1,000 feet perimeter of subject property (see GIS notification tool)							
Х	Mailing fee for above mailing list (mailing fee is double due to 2 mailings)  Amount Paid \$							
Х	Written Narrative describing the proposal, including proposed land uses							
n/a	Resource Conservation District, Floodplain, & Jordan Buffers Determination – necessary for all submittals							
n/a	Jurisdictional Wetland Determination – if applicable							
n/a	Resource Conservation District Encroachment Exemption or Variance (determined by Planning)							
n/a	Jordan Buffer Authorization Certificate or Mitigation Plan Approval (determined by Planning)							
Χ	Reduced Site Plan Set (reduced to 8.5" x 11")							

#### Stormwater Impact Statement (1 copy to be submitted)

- a) Written narrative describing existing & proposed conditions, anticipated stormwater impacts and management structures and strategies to mitigate impacts
- b) Description of land uses and area (in square footage)
- c) Existing and proposed impervious surface area in square feet for all subareas and project area
- d) Ground cover and uses information
- e) Soil information (classification, infiltration rates, depth to groundwater and bedrock)
- f) Time of concentration calculations and assumptions
- g) Topography (2-foot contours)
- h) Pertinent on-site and off-site drainage conditions
- i) Upstream and/or downstream volumes
- j) Discharges and velocities
- k) Backwater elevations and effects on existing drainage conveyance facilities
- I) Location of jurisdictional wetlands and regulatory FEMA Special Flood Hazard Areas
- m) Water quality volume calculations
- n) Drainage areas and sub-areas delineated
- o) Peak discharge calculations and rates (1, 2, and 25-year storms)
- p) Hydrographs for pre- & post-development without mitigation, post-development with mitigation
- q) Volume calculations and documentation of retention for 2-year storm

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**TOWN OF CHAPEL HILL** 

**Planning and Development Services** 

- r) 85% TSS removal for post-development stormwater runoff
- s) Nutrient loading calculations
- t) BMP sizing calculations
- u) Pipe sizing calculations and schedule (include HGL & EGL calculations and profiles)

#### Plan Sets (10 copies to be submitted no larger than 24" x 36")

Plans should be legible and clearly drawn. All plan set sheets should include the following:

- Project Name
- Legend
- Labels
- North Arrow (North oriented toward top of page)
- Property boundaries with bearing and distances
- Scale (Engineering), denoted graphically and numerically
- Setbacks
- Streams, RCD Boundary, Jordan Riparian Buffer Boundary, Floodplain, and Wetlands Boundary, where applicable
- Revision dates and professional seals and signatures, as applicable

#### **Cover Sheet**

a) Include Project Name, Project fact information, PIN, and Design Team

#### Area Map

- a) Project name, applicant, contact information, location, PIN, & legend
- b) Dedicated open space, parks, greenways
- c) Overlay Districts, if applicable
- d) Property lines, zoning district boundaries, land uses, project names of site and surrounding properties, significant buildings, corporate limit lines
- e) Existing roads (public & private), rights-of-way, sidewalks, driveways, vehicular parking areas, bicycle parking, handicapped parking, street names
- f) 1,000' notification boundary

#### **Existing Conditions Plan**

- a) Slopes, soils, environmental constraints, existing vegetation, and any existing land features
- b) Location of all existing structures and uses
- c) Existing property line and right-of-way lines
- d) Existing utilities & easements including location & sizes of water, sewer, electrical, & drainage lines
- e) Nearest fire hydrants
- f) Nearest bus shelters and transit facilities
- g) Existing topography at minimum 2-foot intervals and finished grade
- h) Natural drainage features & water bodies, floodways, floodplain, RCD, Jordan Buffers & Watershed boundaries

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**TOWN OF CHAPEL HILL** 

**Planning and Development Services** 

#### **Detailed Site Plan**

- a) Existing and proposed building locations
- b) Description & analysis of adjacent land uses, roads, topography, soils, drainage patterns, environmental constraints, features, existing vegetation, vistas (on and off-site)
- c) Location, arrangement, & dimension of vehicular parking, width of aisles and bays, angle of parking, number of spaces, handicapped parking, bicycle parking. Typical pavement sections & surface type.
- d) Location of existing and proposed fire hydrants
- e) Location and dimension of all vehicle entrances, exits, and drives
- f) Dimensioned street cross-sections and rights-of-way widths
- g) Pavement and curb & gutter construction details
- h) Dimensioned sidewalk and tree lawn cross sections
- i) Proposed transit improvements including bus pull-off and/or bus shelter
- j) Required landscape buffers (or proposed alternate/modified buffers)
- k) Required recreation area/space (including written statement of recreation plans)
- Refuse collection facilities (existing and proposed) or shared dumpster agreement
- m) Construction parking, staging, storage area, and construction trailer location
- n) Sight distance triangles at intersections
- o) Proposed location of street lights and underground utility lines and/or conduit lines to be installed
- p) Easements
- q) Clearing and construction limits
- r) Traffic Calming Plan detailed construction designs of devices proposed & associated sign & marking plan

#### **Stormwater Management Plan**

- a) Topography (2-foot contours)
- b) Existing drainage conditions
- c) RCD and Jordan Riparian Buffer delineation and boundary (perennial & intermittent streams; note ephemeral streams on site)
- d) Proposed drainage and stormwater conditions
- e) Drainage conveyance system (piping)
- f) Roof drains
- g) Easements
- h) BMP plans, dimensions, details, and cross-sections
- i) Planting and stabilization plans and specifications

#### **Landscape Protection Plan**

- a) Rare, specimen, and significant tree survey within 50 feet of construction area
- b) Rare and specimen tree critical root zones
- c) Rare and specimen trees proposed to be removed
- d) Certified arborist tree evaluation, if applicable
- e) Significant tree stand survey
- f) Clearing limit line
- g) Proposed tree protection/silt fence location
- h) Pre-construction/demolition conference note
- i) Landscape protection supervisor note
- j) Existing and proposed tree canopy calculations, if applicable

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TOWN OF CHAPEL HILL Planning and Development Services

#### **Planting Plan**

- a) Dimensioned and labeled perimeter buffers
- b) Off-site buffer easement, if applicable
- c) Landscape buffer and parking lot planting plan (including planting strip between parking and building, entryway planting, and 35% shading requirement

#### **Steep Slope Plan**

- a) Classify and quantify slopes 0-10%, 10-15%, 15-25%, and 25% and greater
- b) Show and quantify areas of disturbance in each slope category
- c) Provide/show specialized site design and construction techniques

#### **Grading and Erosion Control Plan**

- a) Topography (2-foot contours)
- b) Limits of Disturbance
- c) Pertinent off-site drainage features
- d) Existing and proposed impervious surface tallies

#### Streetscape Plan, if applicable

- a) Public right-of-way existing conditions plan
- b) Streetscape demolition plan
- c) Streetscape proposed improvement plan
- d) Streetscape proposed utility plan and details
- e) Streetscape proposed pavement/sidewalk details
- f) Streetscape proposed furnishing details
- g) Streetscape proposed lighting detail

#### **Solid Waste Plan**

- a) Preliminary Solid Waste Management Plan
- b) Existing and proposed dumpster pads
- c) Proposed dumpster pad layout design
- d) Proposed heavy duty pavement locations and pavement construction detail
- e) Preliminary shared dumpster agreement, if applicable



TOWN OF CHAPEL HILL Planning and Development Services

#### **Construction Management Plan**

- a) Construction trailer location
- b) Location of construction personnel parking and construction equipment parking
- c) Location and size of staging and materials storage area
- d) Description of emergency vehicle access to and around project site during construction
- e) Delivery truck routes shown or noted on plan sheets

#### **Energy Management Plan**

- a) Description of how project will be 20% more energy efficient than ASHRAE standards
- b) Description of utilization of sustainable forms of energy (Solar, Wind, Hydroelectric, and Biofuels)
- c) Participation in NC GreenPower program
- d) Description of how project will ensure indoor air quality, adequate access to natural lighting, and allow for proposed utilization of sustainable energy
- e) Description of how project will maintain commitment to energy efficiency and reduced carbon footprint over time
- f) Description of how the project's Transportation Management Plan will support efforts to reduce energy consumption as it affects the community

#### **Exterior Elevations**

a) An outline of each elevation of the building, including the finished grade line along the foundation (height of building measured from mean natural grade)

#### Rosemary Street Parking Deck - Conditional Zoning

#### **Project Narrative**

The Rosemary Street Parking Deck will create much needed parking for visitors, businesses and workers in downtown Chapel Hill and will be an integral component of the revitalization of East Rosemary Street. This redevelopment strategy for East Rosemary Street will create space for hundreds of new technology workers and researchers in the heart of downtown. The new deck will also create an attractive new arrival experience for visitors to downtown and will improve the streetscape on the southern frontage of Rosemary Street.

The new parking deck will be located on the site of the existing 'CVS' parking deck combined with the surface parking lot immediately to the east. Combining these parcels will create a combined parcel of approximately 1.6 acres. Grubb Properties controls these properties and is proposing to exchange these parcels with the Town of Chapel Hill for the land currently occupied by the Wallace Parking deck, a parcel of 1.49 acres which would be developed into a new research facility with labs and office space for business and institutional tenants.

The existing parking deck is a three-level structure and parks 276 cars. It was built over 40 years ago and has reached the end of its service life. The new parking deck will be a seven-level structure and will park approximately 1,100 cars.

In addition to new parking spaces the Rosemary Street frontage will be improved by widening the sidewalks to incorporate a 'retail porch' that will provide space for small business, artisans and food vendors to operate on an economical, short term basis.

#### Statement of Justification - Conditional Zoning

This is a statement of justification to support the request for Conditional Zoning for 125 East Rosemary Street and the parcel immediately to the east. Both parcels are currently within the TC-2 zoning district. The Conditional Zoning is being requested to facilitate an open dialogue with the public and negotiations between the applicant and the Town of Chapel Hill.

In order to establish and maintain sound, stable, and desirable development within the planning jurisdiction of the Town, it is intended that the Land Use Management Ordinance (as stated in Section 4.4) shall not be amended except:

- 1) To correct a manifest error in the chapter; or
- 2) Because of changed or changing conditions in a particular area or in the jurisdiction generally; or
- **3)** To achieve the purposes of the Comprehensive Plan.

Below is the applicant's evaluation of this application based on these three findings.

1) Finding #1: The proposed zoning amendment is necessary to correct a manifest error.

Response: We do not believe there is error in the Town's Zoning Atlas Amendment related to the project site.

2) Finding #2: The proposed zoning amendment is necessary because of changed or changing conditions in a particular area or in the jurisdiction generally.

Response: We believe that the conditions have changed in the following respect: In recent years downtown Chapel Hill has undergone a loss of jobs and businesses which has adversely affected the economic vitality of Chapel Hill. One component of this problem is the lack of centralized public parking to support business and visitors, which this project addresses.

3) Finding #3: The proposed zoning amendment is necessary to achieve the purposes of the comprehensive plan.

Response: The proposed rezoning would contribute to the following elements of the Comprehensive Plan:

#### Theme 2: Community Prosperity and Engagement

- Balance and sustain finances by increasing revenues and decreasing expenses (CPE.1).
- Foster success of local businesses (CPE.2).

#### Theme 3: Getting Around

 A connected community that links neighborhoods, businesses and schools through the provision of greenways, sidewalks, bike facilities and public transportation (GA.2).

#### Theme 4: Good Places, New Spaces

- A vibrant, diverse, pedestrian-friendly, and accessible downtown with opportunities for growing office, retail, residential and cultural development and activity (GPNS.2).
- A community that welcomes and supports change and creativity (GPNS.6).

#### Theme 6: Town and Gown Collaboration

• Take full advantage of ideas and resources to create a thriving economy and incorporate the utilize the intellectual capital that the University and Town create (TGC.1).

#### **Modifications of Regulations:**

**Building Height, Setback** - LUMO Table 3.8-1 Dimensional Matrix limits the maximum building height at the setback line in the TC-2 zoning district to 44 feet. In order to provide the desired number of parking spaces, the deck will need to be 7 levels and will exceed the 44 feet maximum allowed. The applicant therefore requests that Council approve a modification approving a building height at the setback line of 73 feet.

LUMO section 3.8.4 requires a minimum solar setback for the land adjacent to the residential districts R-3 and R-6 of 11 feet and 8 feet, respectively. In order to provide the desired number of parking stalls and drive aisles, the deck will need to be within the minimum solar setback. The applicant therefore requests that Council approve a modification reducing the minimum solar setback to 5 feet for the land adjacent to the residential districts at the north end of the property.

# CONDITIONAL ZONING DRAWINGS **FOR** ROSEMARY STREET PARKING DECK

CHAPEL HILL, ORANGE COUNTY, NORTH CAROLINA





VICINITY MAP

SCALE: 1"=500"

# **DRAWING LIST**

SHEET	DRAWING TITLE	<u>LATEST</u> ISSUE DAT
G0001	COVER	22 MAY 20
C0001	AREA MAP	22 MAY 20
C0101	EXISTING CONDITIONS, LANDSCAPE PROTECTION & DEMOLITION PLAN	22 MAY 20
C1001	SITE PLAN	22 MAY 20
C1200	GRADING & UTILITY PLAN	22 MAY 20
C1301	PRELIMINARY EROSION CONTROL PLAN	22 MAY 20
L01-01	LANDSCAPE PLANS	22 MAY 20
L01-02	LANDSCAPE DETAILS	22 MAY 20
A10-01	OVERALL FLOOR PLAN - P1	22 MAY 20
A10-02	OVERALL FLOOR PLAN - P2	22 MAY 20
A10-03	OVERALL FLOOR PLAN - P3	22 MAY 20
A10-04	OVERALL FLOOR PLAN - P4	22 MAY 20
A10-05	OVERALL FLOOR PLAN - P5	22 MAY 20
A10-06	OVERALL FLOOR PLAN - P6	22 MAY 20
A10-07	OVERALL FLOOR PLAN - P7	22 MAY 20
A10-08	OVERALL FLOOR PLAN - ROOF	22 MAY 20
A20-01	EXTERIOR ELEVATIONS	22 MAY 20

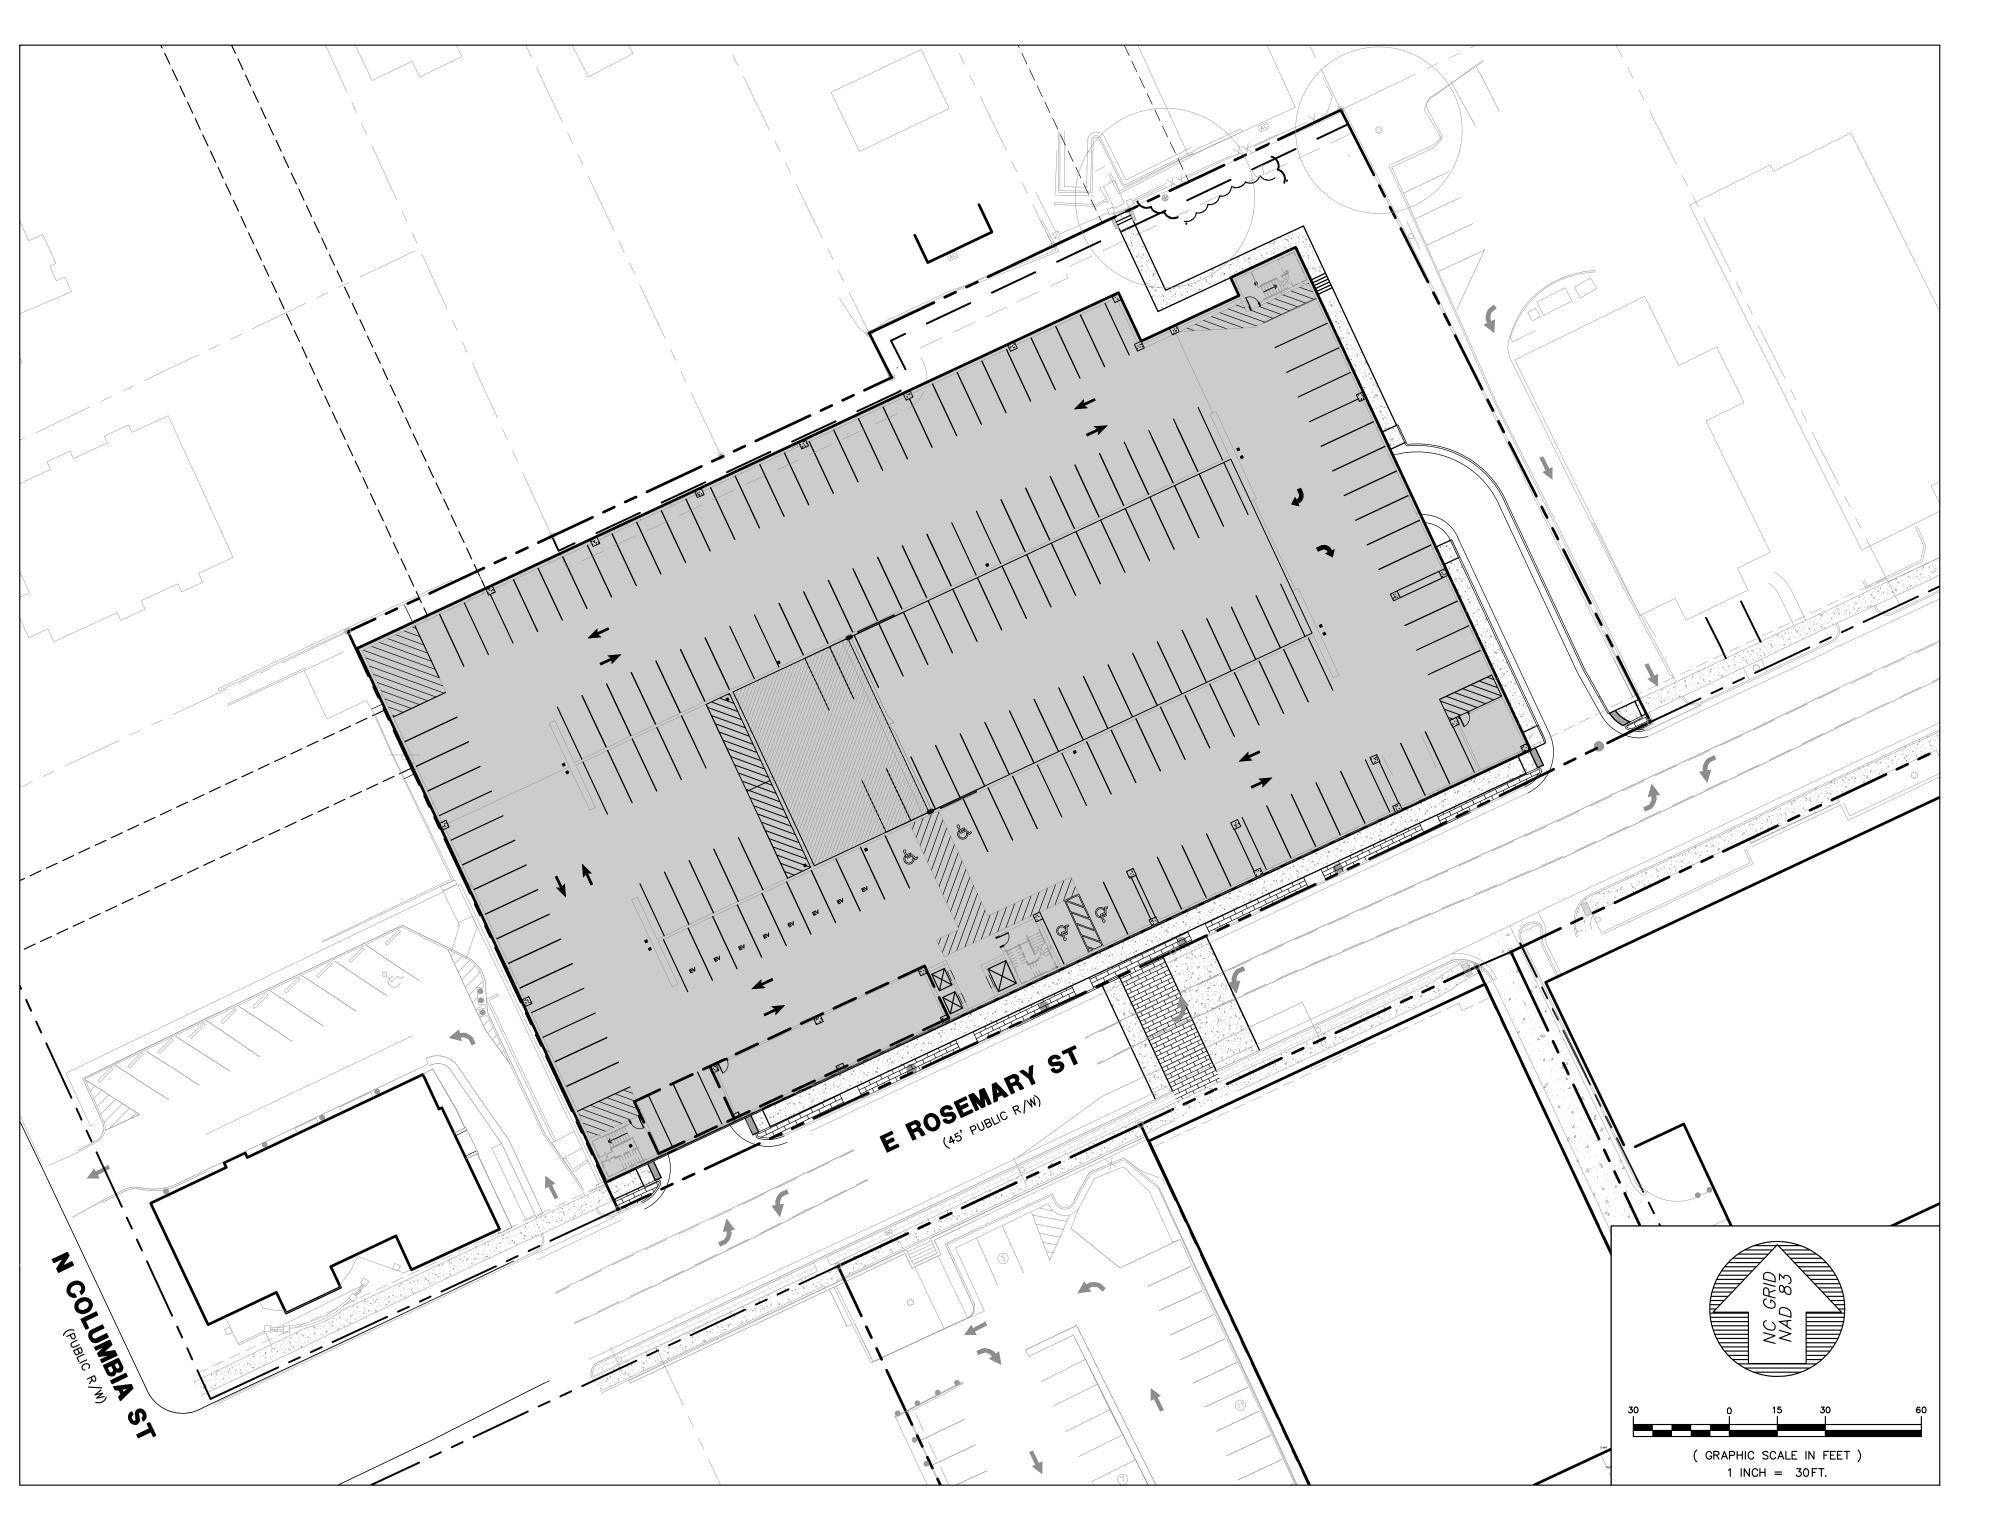

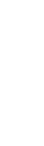

ARCHITECTURE:


Perkins&Will


411 W CHAPEL HILL STREET, SUITE 200 DURHAM, NC 27701 (919) 433-5300


SITE PLANNING / CIVIL ENGINEERING:

113 EDINBURGH SOUTH DR. SUITE 120 CARY, NC 27511 (919) 388-5772

DEVELOPER:

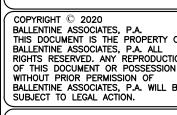

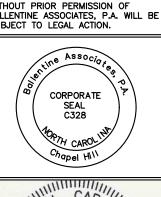

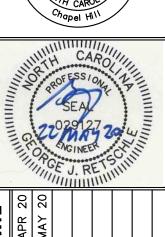

William Co. Republic									
08 APR 20	22 MAY 20								
OWN OF CHAPEL HILL REVIEW COMMENTS	OWN OF CHAPEL HILL REVIEW COMMENTS								

JOB #: 118038.01 DATE: 02 MAR 20 SCALE: AS NOTED

DRAWN BY: J.B.M. REVIEWED BY: G.J.R.



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William.	GRIII	2000	ON SACRETHIN	EAL 912 INE	72 EIII	III CAN	MILITALIA
DATE	08 APR 20	22 MAY 20					


PER TOWN OF CHAPEL HILL REVIEW COMMENTS PER TOWN OF CHAPEL HILL REVIEW COMMENTS						
	REVISIONS	PER TOWN OF CHAPEL HILL REVIEW COMMENTS	PER TOWN OF CHAPEL HILL REVIEW COMMENTS			

OWNER INFORMATION
GRUBB PROPERTIES, INC
4500 CAMERON VALLEY PKWY.
SUITE 350
CHARLOTTE, NC 28211
OWNERS REPRESENTATIVE:
JOE DYE
(919) 388-5774
FAX (919) 461-3939
EMAIL jdye@grubbproperties.com

JOB #: 118038.01 DATE: 02 MAR 20 SCALE: AS NOTED

DRAWN BY: J.B.M. SHEET

REVIEWED BY: G.J.R. REVIEW DRAWING NOT FOR CONSTRUCTION C0001

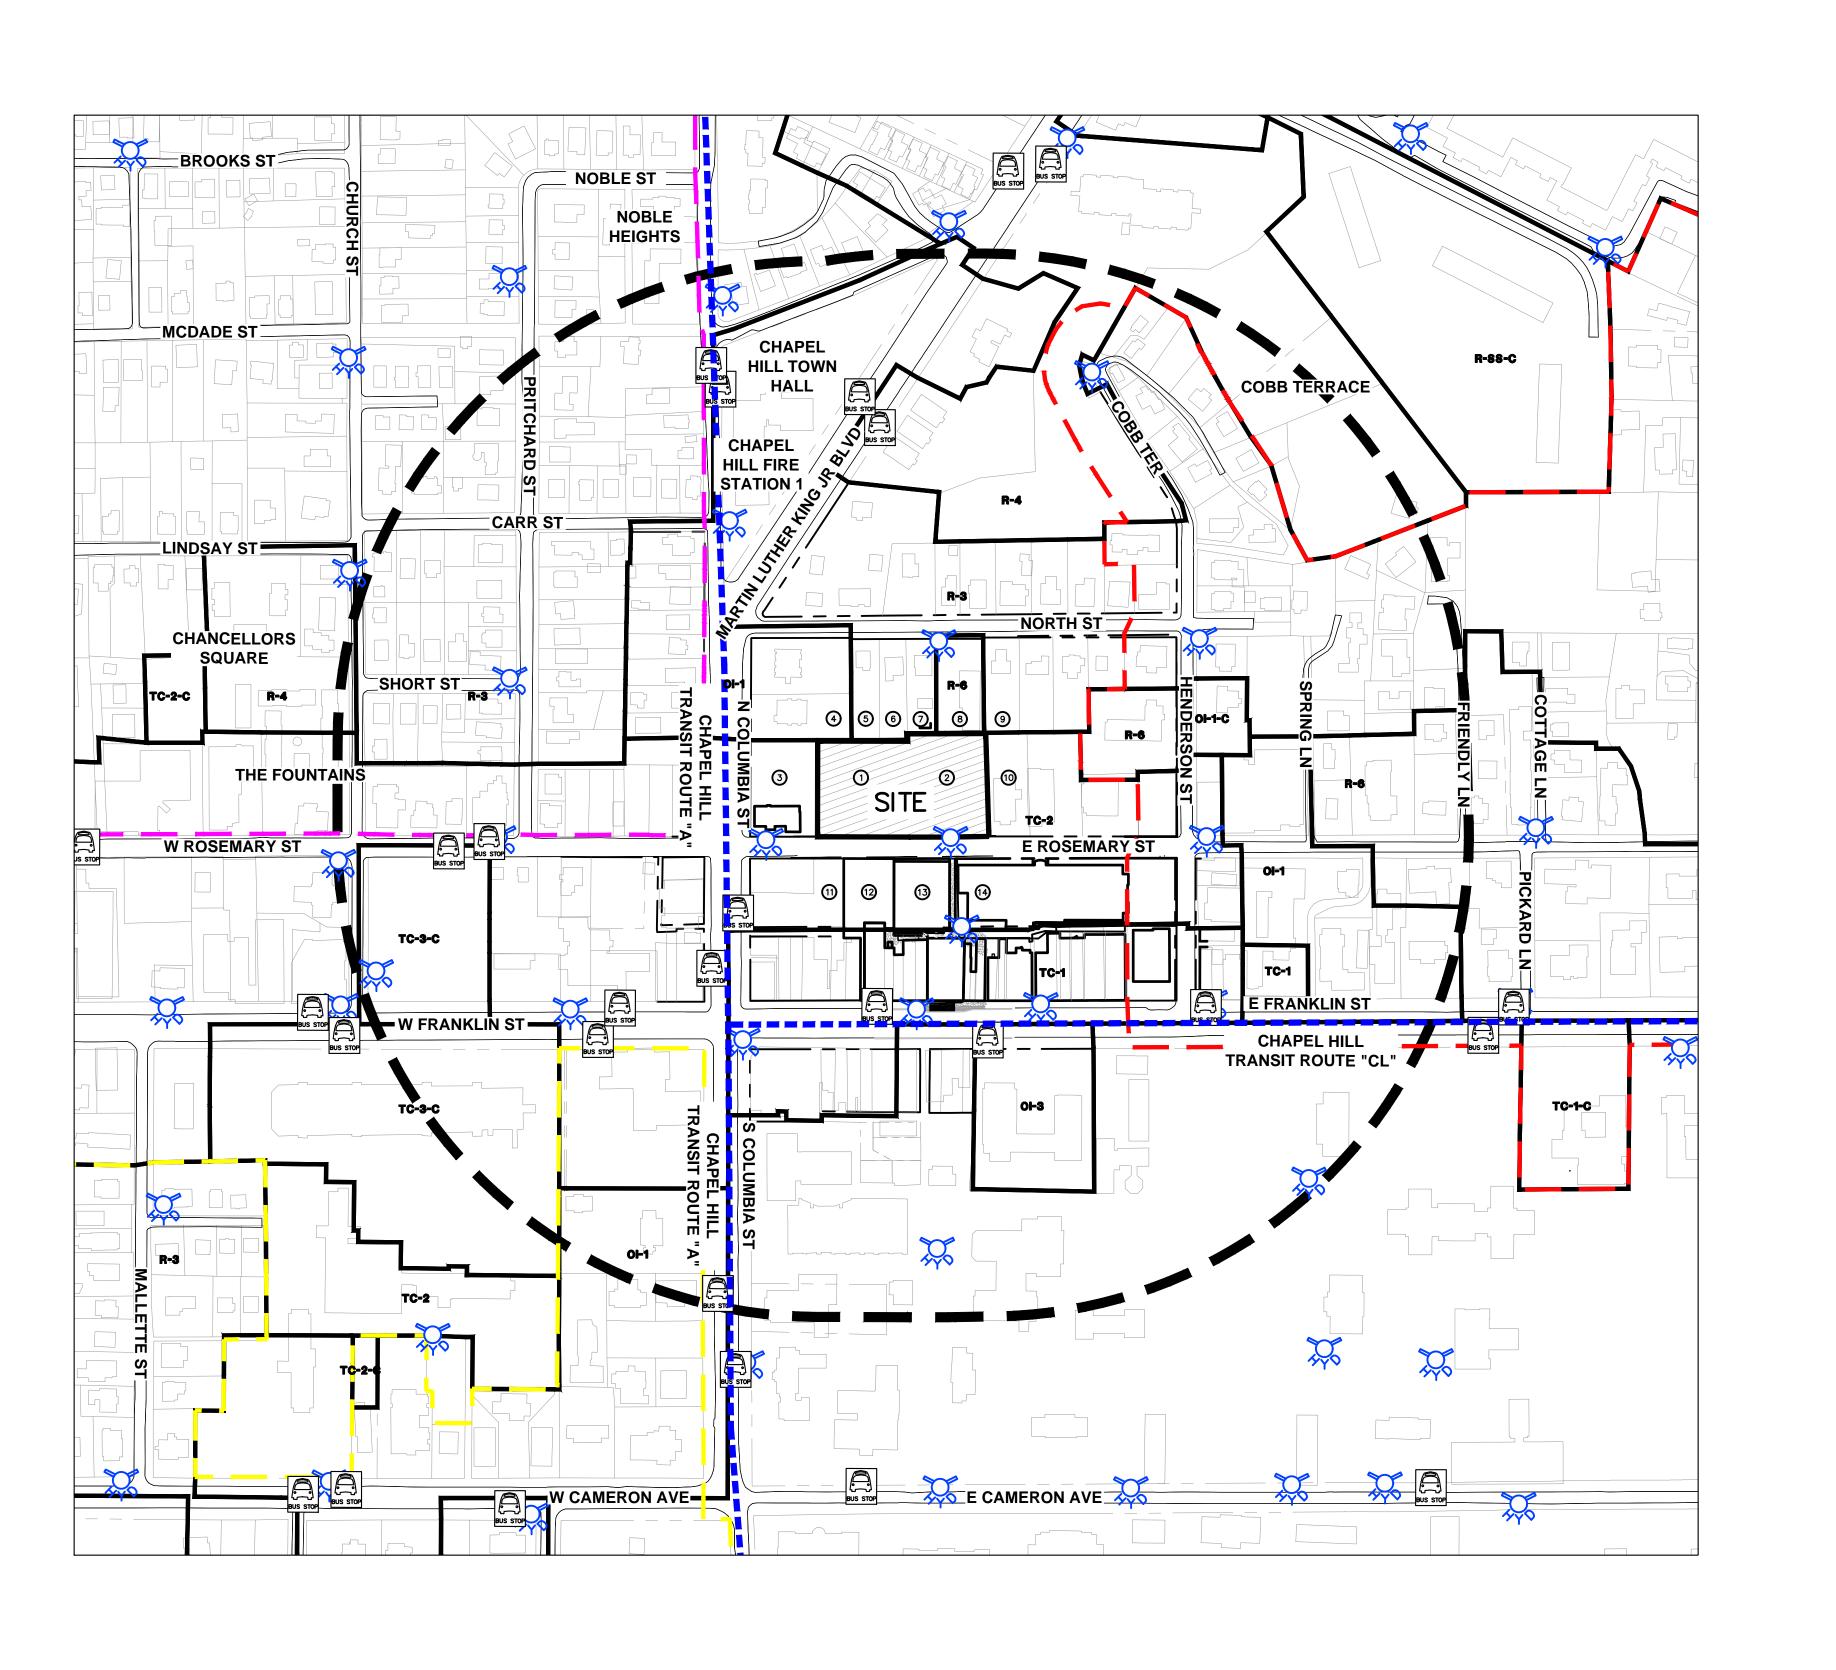

LABEL #	OWNER(S)	PIN #	ZONING	CURRENT LAND USE
3	CENTURA BANK	9788-37-2791	TC-2	BANK
4	BELL FAMILY PROPERTIES LLC	9788-37-2875	OI-1	OFFICE
5	SHARON M KIRK & WILLIAM E KIRK	9788-37-3947	R-3	RESIDENTIAL
6	SHARON M KIRK & WILLIAM E KIRK	9788-37-4909	R-3	RESIDENTIAL
7	CIDER 5 LLC	9788-38-4062	R-3	RESIDENTIAL
8	ZETA TAU ALPHA FRATERNITY HOUSING CORPORATION	9788-38-5035	R-6	FRATERNITY DWELLING
9	126 NORTH ST UNIT B & 126 NORTH ST UNIT A	9788-38-6019	R-3	RESIDENTIAL
10	BRANCH BANKING AND TRUST CO	9788-37-7911	TC-2	COLLEGE
11	TOWN OF CHAPEL HILL	9788-37-4469	TC-2	PARKING LOT
12	TOWN OF CHAPEL HILL	9788-37-5557	TC-2	PARKING LOT
13	FRANKLIN OFFICE CHAPEL HILL LLC	9788-37-7517	TC-2	OFFICE
14	MKELL PROPERTIES LLC	9788-37-5461	TC-1	PARKING LOT

SITE PARCEL DATA

FRANKLIN OFFICE CHAPEL HILL LLC

INVESTORS TITLE COMPANY 9788-37-6817

ZONING DB./PG. PARCEL CURRENT LAND USE

PARKING LOT

PARKING LOT

TC-2 6603/282 0.87


778/87

### DRAWING LEGEND

SYMBOL	DESCRIPTION
	1000' NOTIFICATION LINE
	ZONING BOUNDARY
	FRANKLIN-ROSEMARY HISTORIC DISTRICT
	CAMERON-MCCAULEY HISTORIC DISTRICT
	NORTHSIDE NEIGHBORHOOD CONSERVATION DISTRICT
	CHAPEL HILL TRANSIT ROUTE
R-1	ZONING CLASSIFICATION
	EXISTING FIRE HYDRANT
BUS STOP	EXISTING BUS STOP
	PROJECT SITE

**AREA MAP** 

( GRAPHIC SCALE IN FEET ) 1 inch = 200 ft.

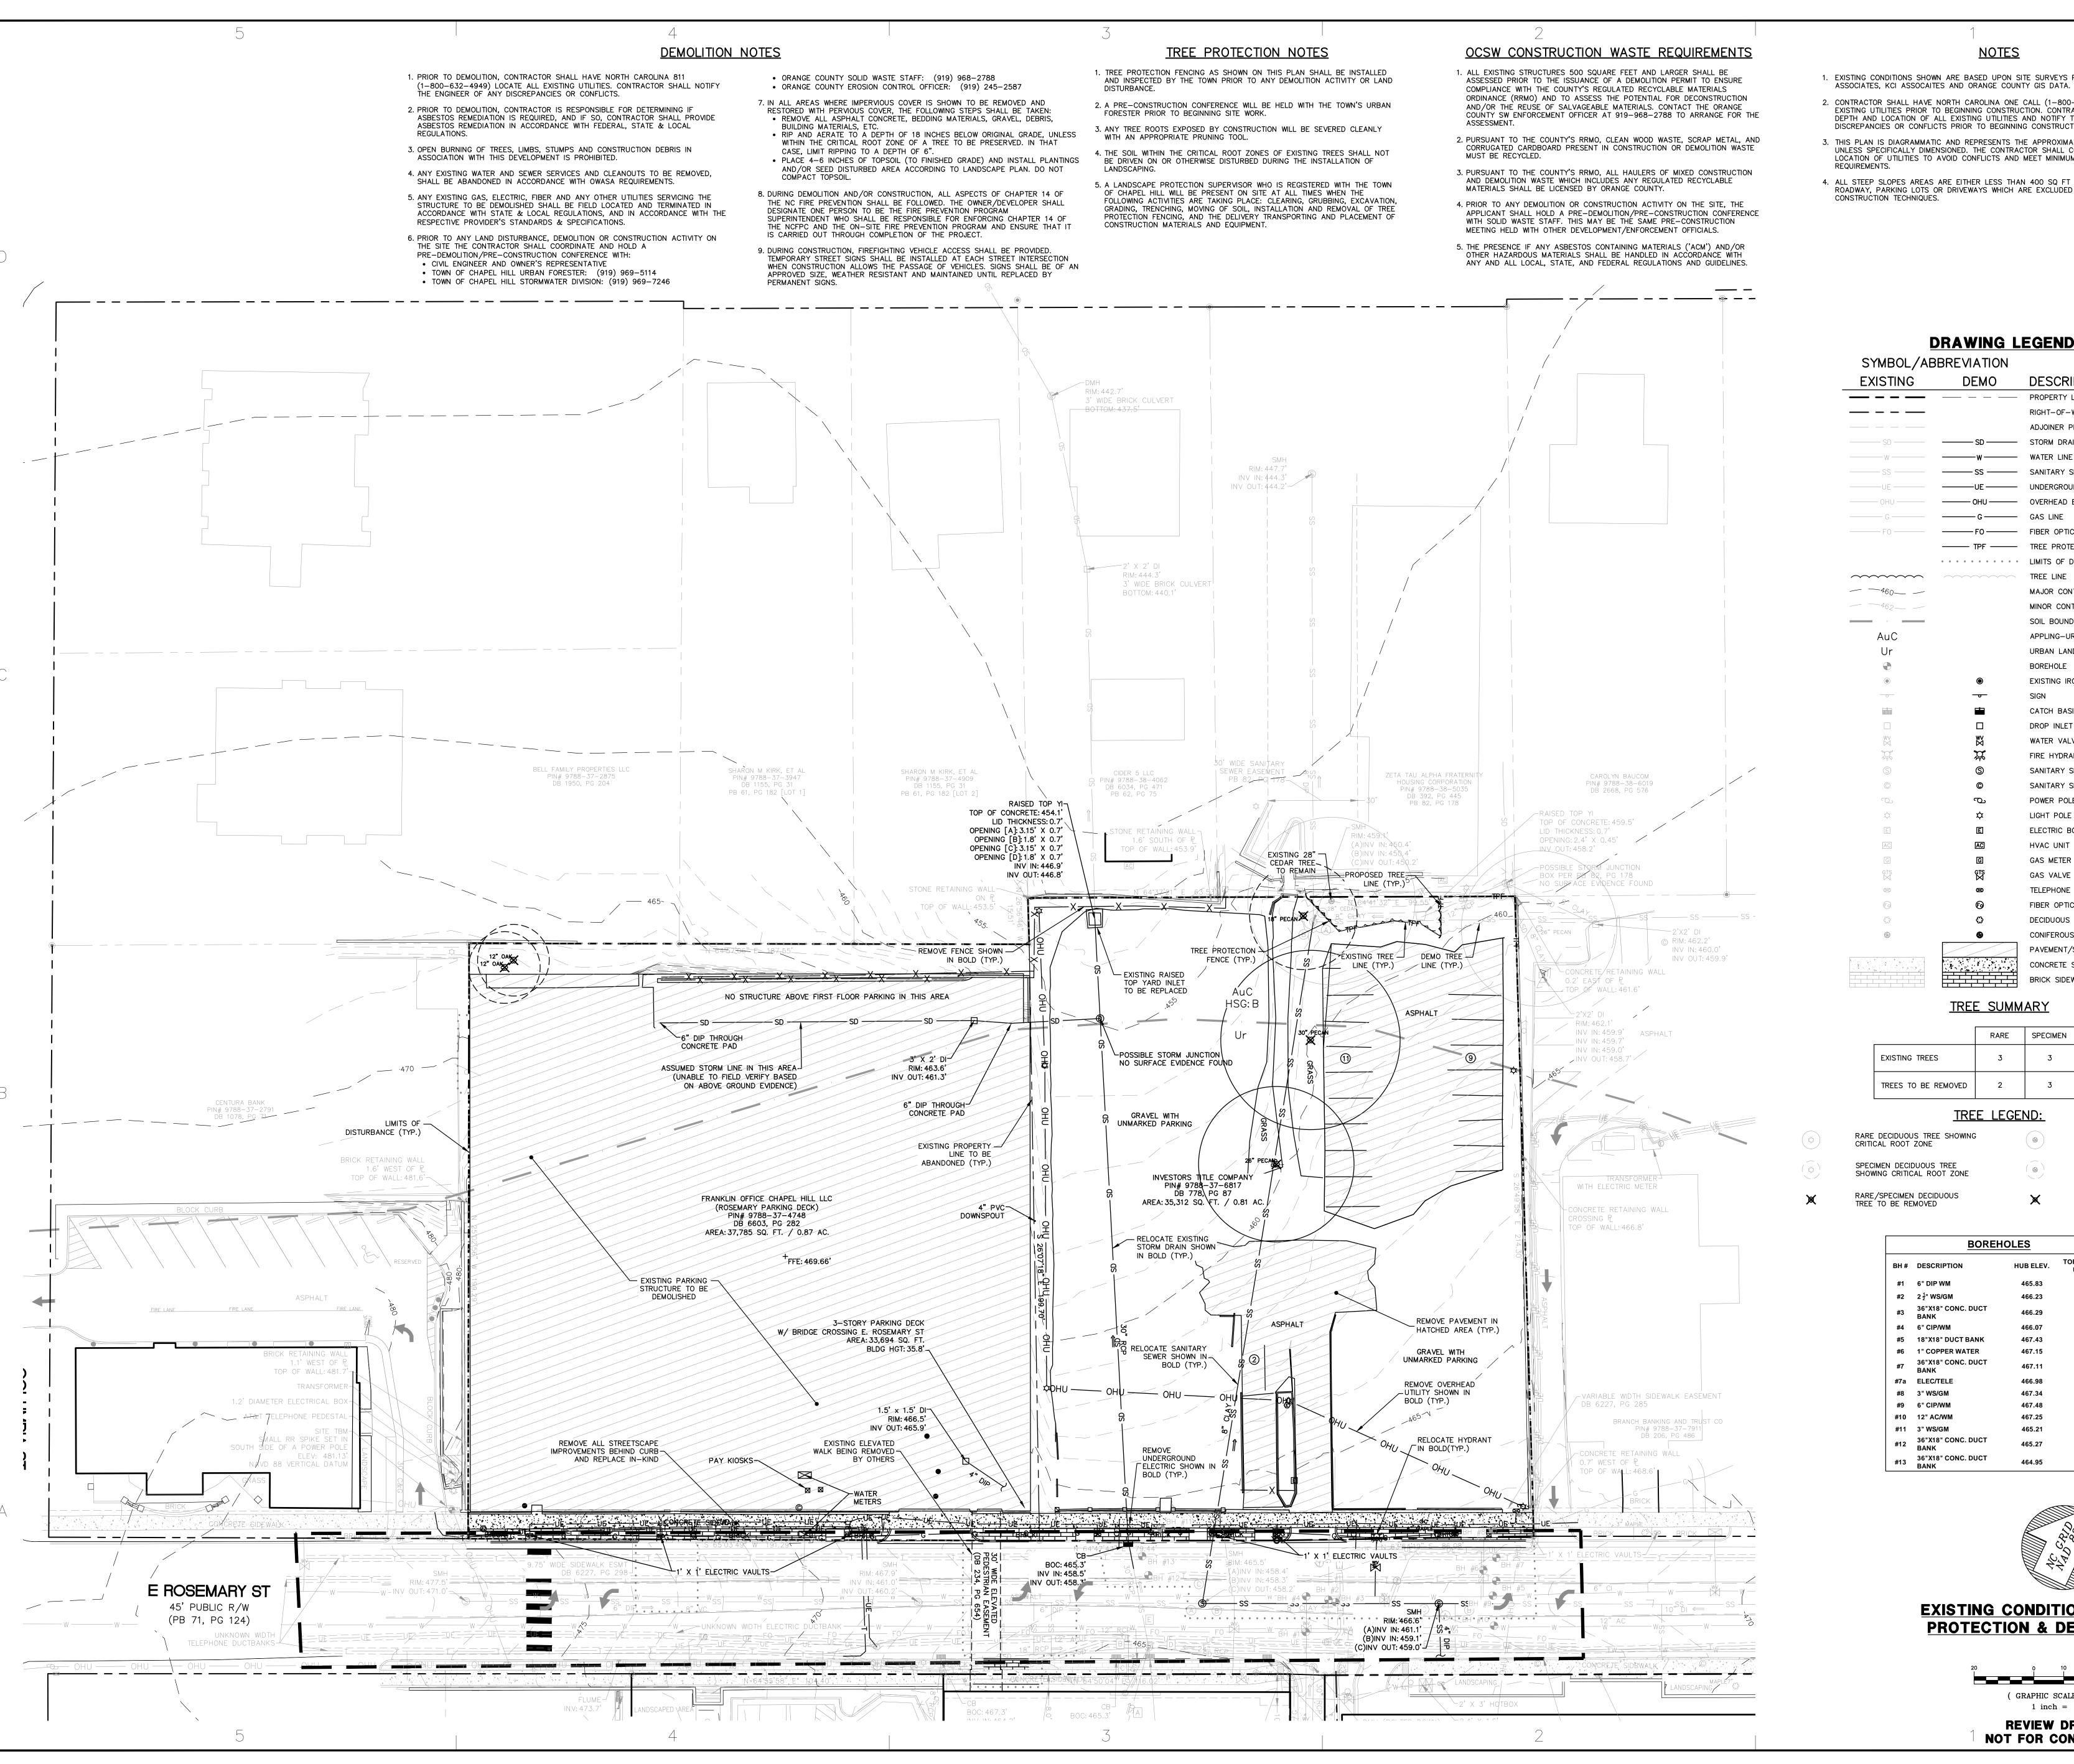

- 1. EXISTING CONDITIONS SHOWN ARE BASED UPON SITE SURVEYS PERFORMED BY BALLENTINE
- 2. CONTRACTOR SHALL HAVE NORTH CAROLINA ONE CALL (1-800-632-4949). LOCATE ALL EXISTING UTILITIES PRIOR TO BEGINNING CONSTRUCTION. CONTRACTOR SHALL VERIFY THE DEPTH AND LOCATION OF ALL EXISTING UTILITIES AND NOTIFY THE ENGINEER OF ANY DISCREPANCIES OR CONFLICTS PRIOR TO BEGINNING CONSTRUCTION.
- 3. THIS PLAN IS DIAGRAMMATIC AND REPRESENTS THE APPROXIMATE LOCATION OF UTILITIES UNLESS SPECIFICALLY DIMENSIONED. THE CONTRACTOR SHALL COORDINATE THE ACTUAL LOCATION OF UTILITIES TO AVOID CONFLICTS AND MEET MINIMUM SIZE, SLOPE, AND CODE
- 4. ALL STEEP SLOPES AREAS ARE EITHER LESS THAN 400 SQ FT OR ARE ASSOCIATED WITH ROADWAY, PARKING LOTS OR DRIVEWAYS WHICH ARE EXCLUDED FROM ANY SPECIAL CONSTRUCTION TECHNIQUES.

### DRAWING LEGEND

ע	<u> </u>	A	W	<u>IG</u>	LE	<u>U</u>

<b>EXISTING</b>	DEMO	DESCRIPTION
		PROPERTY LINE
		RIGHT-OF-WAY LINE
		ADJOINER PROPERTY LINE
SD	SD	STORM DRAIN LINE
W	———w——	WATER LINE
SS	—— ss ——	SANITARY SEWER LINE
———UE ———	———UE ———	UNDERGROUND ELECTRIC LINE
——— OHU ———	—— они ——	OVERHEAD ELECTRIC LINE
G	G	GAS LINE
——— FO ———	——— F0 ———	FIBER OPTIC LINE
	TPF	TREE PROTECTION FENCE
		LIMITS OF DISTURBANCE
~~~~~	~~~~~	TREE LINE
——460— —		MAJOR CONTOUR
——462— —		MINOR CONTOUR
		SOIL BOUNDARY
AuC		APPLING-URBAN LAND COMPLE
Ur		URBAN LAND
•		BOREHOLE
•	•	EXISTING IRON PIPE
	<del>- o -</del>	SIGN
		CATCH BASIN
		DROP INLET
₩V	₩	WATER VALVE
<b>~</b>	"	FIRE HYDRANT
(\$)	<b>S</b>	SANITARY SEWER MANHOLE
©	©	SANITARY SEWER CLEANOUT
	G	POWER POLE
<b>\$</b>	<b>\$</b>	LIGHT POLE
E	E	ELECTRIC BOX
AC	AC	HVAC UNIT
G	G	GAS METER
GTS ⋈	GTS ⊠	GAS VALVE
$\boxtimes$	8	TELEPHONE VAULT
Fo	<b>©</b>	FIBER OPTIC MARKER
	<b>©</b>	DECIDUOUS TREE
*	<b>&amp;</b>	CONIFEROUS TREE
		PAVEMENT/STRUCTURES
		CONCRETE SIDEWALK
		BRICK SIDEWALK


### TREE SUMMARY

	RARE	SPECIMEN	TOTAL
EXISTING TREES	3	3	6
TREES TO BE REMOVED	2	3	5

# TREE LEGEND:


<i>)</i>	RARE/SPECIMEN DECIDUOUS	•	SHOWING CRITICAL ROOT ZONE  RARE/SPECIMEN CONIFEROUS
3 \	SPECIMEN DECIDUOUS TREE SHOWING CRITICAL ROOT ZONE	( 🛞 )	SPECIMEN CONIFEROUS TREE
3	RARE DECIDUOUS TREE SHOWING CRITICAL ROOT ZONE		RARE CONIFEROUS TREE SHOWING CRITICAL ROOT ZONE

BOREHOLES					
3H #	DESCRIPTION	HUB ELEV.	TOP ELEV. OF UTILITY		
#1	6" DIP WM	465.83	459.87		
#2	2 ½" WS/GM	466.23	464.28		
#3	36"X18" CONC. DUCT BANK	466.29	465.22		
#4	6" CIP/WM	466.07	462.73		
#5	18"X18" DUCT BANK	467.43	463.44		
#6	1" COPPER WATER	467.15	464.34		
#7	36"X18" CONC. DUCT BANK	467.11	464.91		
#7a	ELEC/TELE	466.98	464.78		
#8	3" WS/GM	467.34	465.16		
#9	6" CIP/WM	467.48	463.67		
#10	12" AC/WM	467.25	461.79		
#11	3" WS/GM	465.21	463.09		
#12	36"X18" CONC. DUCT BANK	465.27	463.93		
#13	36"X18" CONC. DUCT	464.95	462.96		

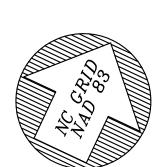

TREE TO BE REMOVED

**EXISTING CONDITIONS, LANDSCAPE** PROTECTION & DEMOLITION PLAN

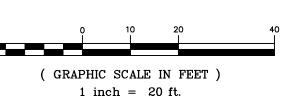

**REVIEW DRAWING** NOT FOR CONSTRUCTION

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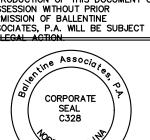
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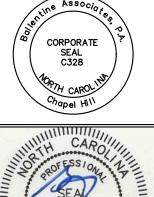
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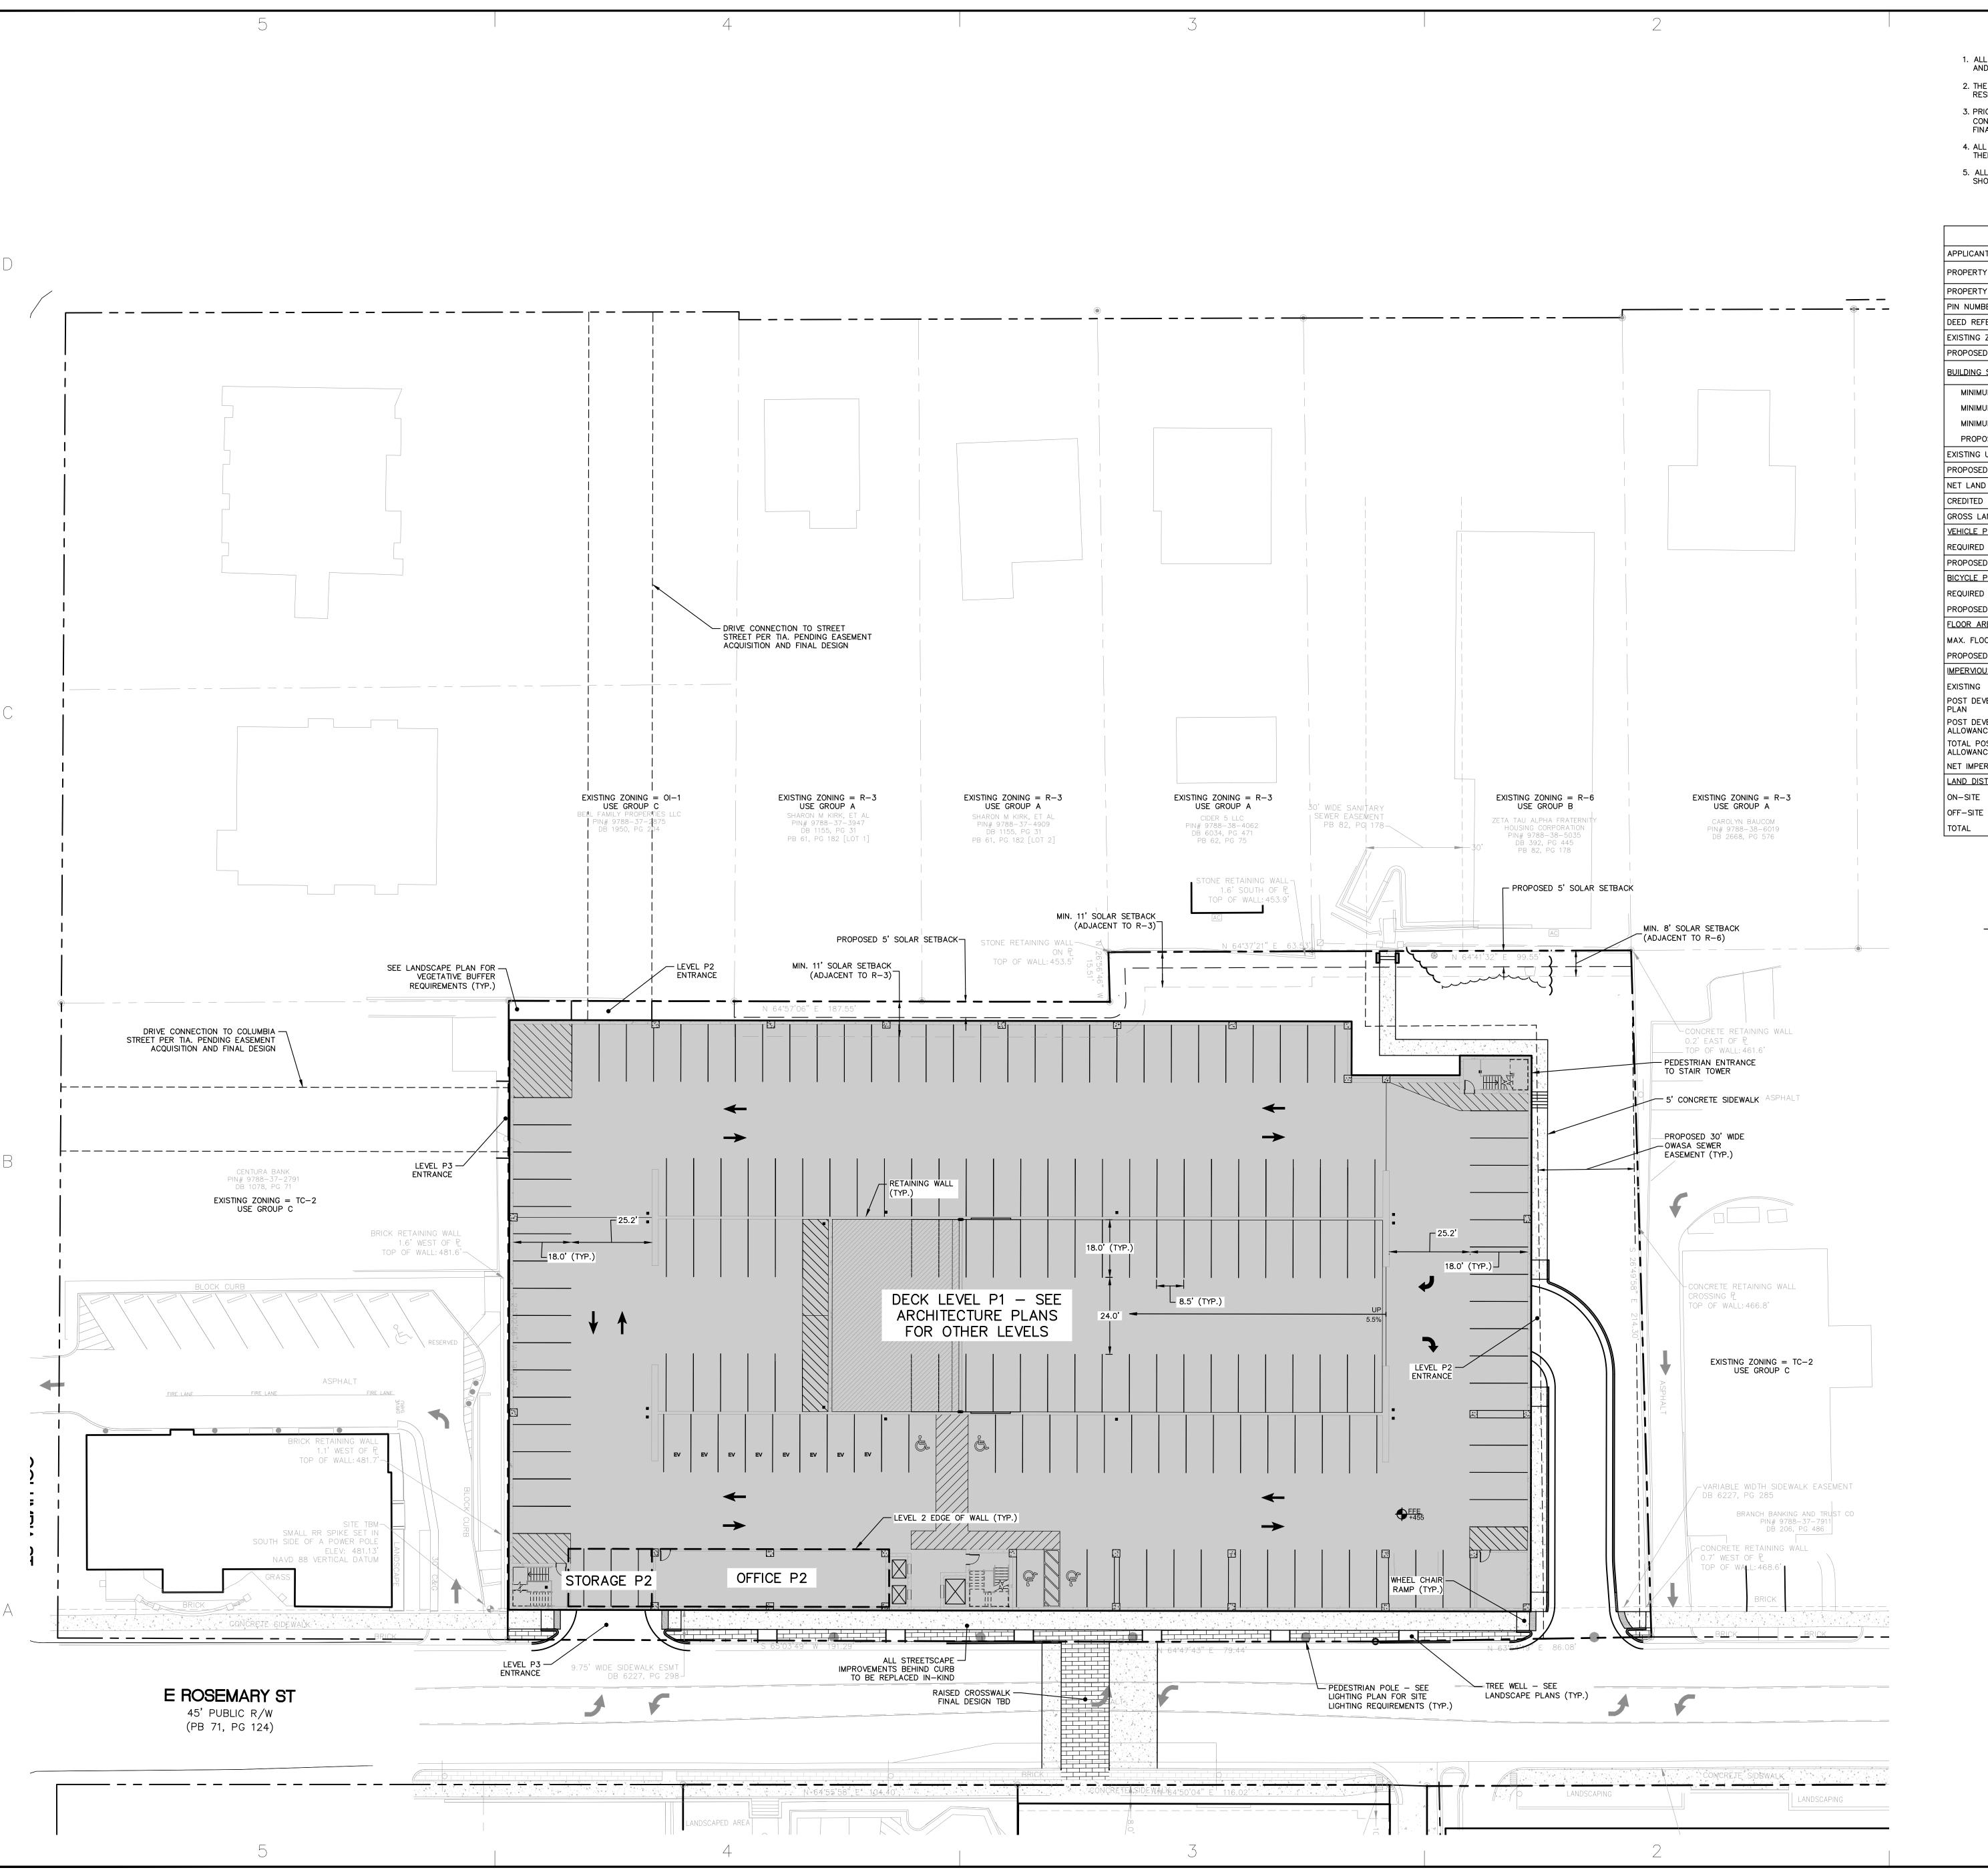


GRUBB PROPERTIES, INC

4500 CAMERON VALLEY PKWY. SUITE 350 CHARLOTTE, NC 28211 OWNERS REPRESENTATIVE: (919) 388-5774 FAX (919) 461-3939

JOB #: 118038.01 DATE: 02 MAR 20 SCALE: AS NOTED DRAWN BY: J.B.M.

REVIEWED BY: G.J.R. SHEET C0101




- 1. ALL CONSTRUCTION SHALL COMPLY WITH APPLICABLE TOWN OF CHAPEL HILL STANDARDS AND SPECIFICATION.
- 2. THE TOWN OF CHAPEL HILL, ITS' ASSIGNS OR ORANGE COUNTY SHALL NOT BE RESPONSIBLE FOR ANY PAVEMENT DAMAGE THAT MAY RESULT FROM SERVICE VEHICLES.
- 3. PRIOR TO INSTALLATION OF ANY STREET SIGNS OR MARKINGS, THE DEVELOPER WILL CONTACT THE TOWN'S PUBLIC WORKS DEPARTMENT FOR AN ON-SITE APPROVAL OF THE FINAL DESIGN AND PLACEMENT.
- 4. ALL PAVEMENT MARKINGS WITHIN THE PUBLIC RIGHT—OF—WAY WILL BE INSTALLED USING A THERMAL PLASTIC MATERIAL WITH A MINIMUM THICKNESS OF 125 MILS.
- 5. ALL WALKWAYS SHALL BE CONSTRUCTED WITH A 2% CROSS SLOPE IN THE DIRECTION SHOWN ON THE GRADING PLAN.

	SITE DATA			
APPLICANT:	GRUBB PROPERTIES, INC			
PROPERTY OWNER:	FRANKLIN OFFICE CHAPEL HILL, LLC & INVESTORS TITLE COMPANY			
PROPERTY ADDRESS:	125 EAST ROSEMARY STREET, CHAPEL HILL, NC			
PIN NUMBERS:	9788	3-37-4748 & 9788-37	7–6817	
DEED REFERENCES:	D	B/PG: 6603/282 & 77	8/87	
EXISTING ZONING:		TC-2		
PROPOSED ZONING:		TC-2-CZ		
BUILDING SETBACK SUMMARY:	TC-2-CZ	ADJACENT RESIDENTIAL (R-3)	ADJACENT RESIDENTIAL (F	
MINIMUM STREET SETBACK	0 FT.	N/A	N/A	
MINIMUM INTERIOR SETBACK	O FT.	N/A	N/A	
MINIMUM SOLAR SETBACK	O FT.	11 FT.	8 FT.	
PROPOSED SOLAR SETBACK	O FT.	5 FT.	5 FT.	
EXISTING USE:	PAR	KING DECK/SURFACE PA	ARKING	
PROPOSED USE:		PARKING DECK/OFFICE	E	
NET LAND AREA:		73,097 SF (1.68 AC)	1	
CREDITED STREET AREA:		7,310 SF (0.17 AC)		
GROSS LAND AREA:		80,407 SF (1.85 AC)		
VEHICLE PARKING SUMMARY:	REGULAR	<u>ACCESSIBLE</u>	<u>TOTAL</u>	
REQUIRED	N/A	22 (INCL. 4 VAN)	N/A	
PROPOSED	1,076	28 (INCL. 4 VAN)	1,104	
BICYCLE PARKING SUMMARY:				
REQUIRED		6 SPACES		
PROPOSED		40 SPACES		
FLOOR AREA SUMMARY:				
MAX. FLOOR AREA	1.97 (FAR)	) X 80,407 SF (GLA) =	: 158,402 SF	
PROPOSED FLOOR AREA	6,000 SF (	OFFICE & MECHANICAL	SPACE, MAX.)	
IMPERVIOUS SUMMARY:				
EXISTING		66,548 SF (1.528 AC	)	
POST DEVELOPED — CURRENT SITE PLAN		64,496 SF (1.481 AC	)	
POST DEVELOPED — ADDITIONAL ALLOWANCE		1,004 SF (0.023 AC)		
TOTAL POST-DEVELOPED INCLUDING ALLOWANCE	65,500 SF (1.504 AC)			
NET IMPERVIOUS REDUCTION	-1,048 SF (0.024 AC)			
LAND DISTURBANCE SUMMARY:				
ON-SITE	73,000 SF			
OFF-SITE	6,000 SF			
TOTAL	79,000 SF			


### **DRAWING LEGEND**

SYMBOL/ABBREVIATION

STWDOL/AD	DIVENIATION	
<b>EXISTING</b>	PROPOSED	DESCRIPTION
		PROPERTY LINE
		RIGHT-OF-WAY LINE
		ADJOINER PROPERTY LI
		EASEMENT LINE
		SETBACK LINE
X	X	FENCE LINE
~~~~~	~~~~~	TREE LINE
•		EXISTING IRON PIPE
		IRON PIPE SET
<b>A</b>		CALCULATED POINT
		SIGN
M		MAIL BOX
•		BOLLARD

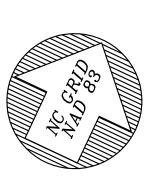

SITE PLAN

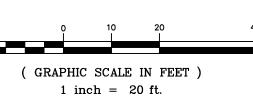

REVIEW DRAWING NOT FOR CONSTRUCTION


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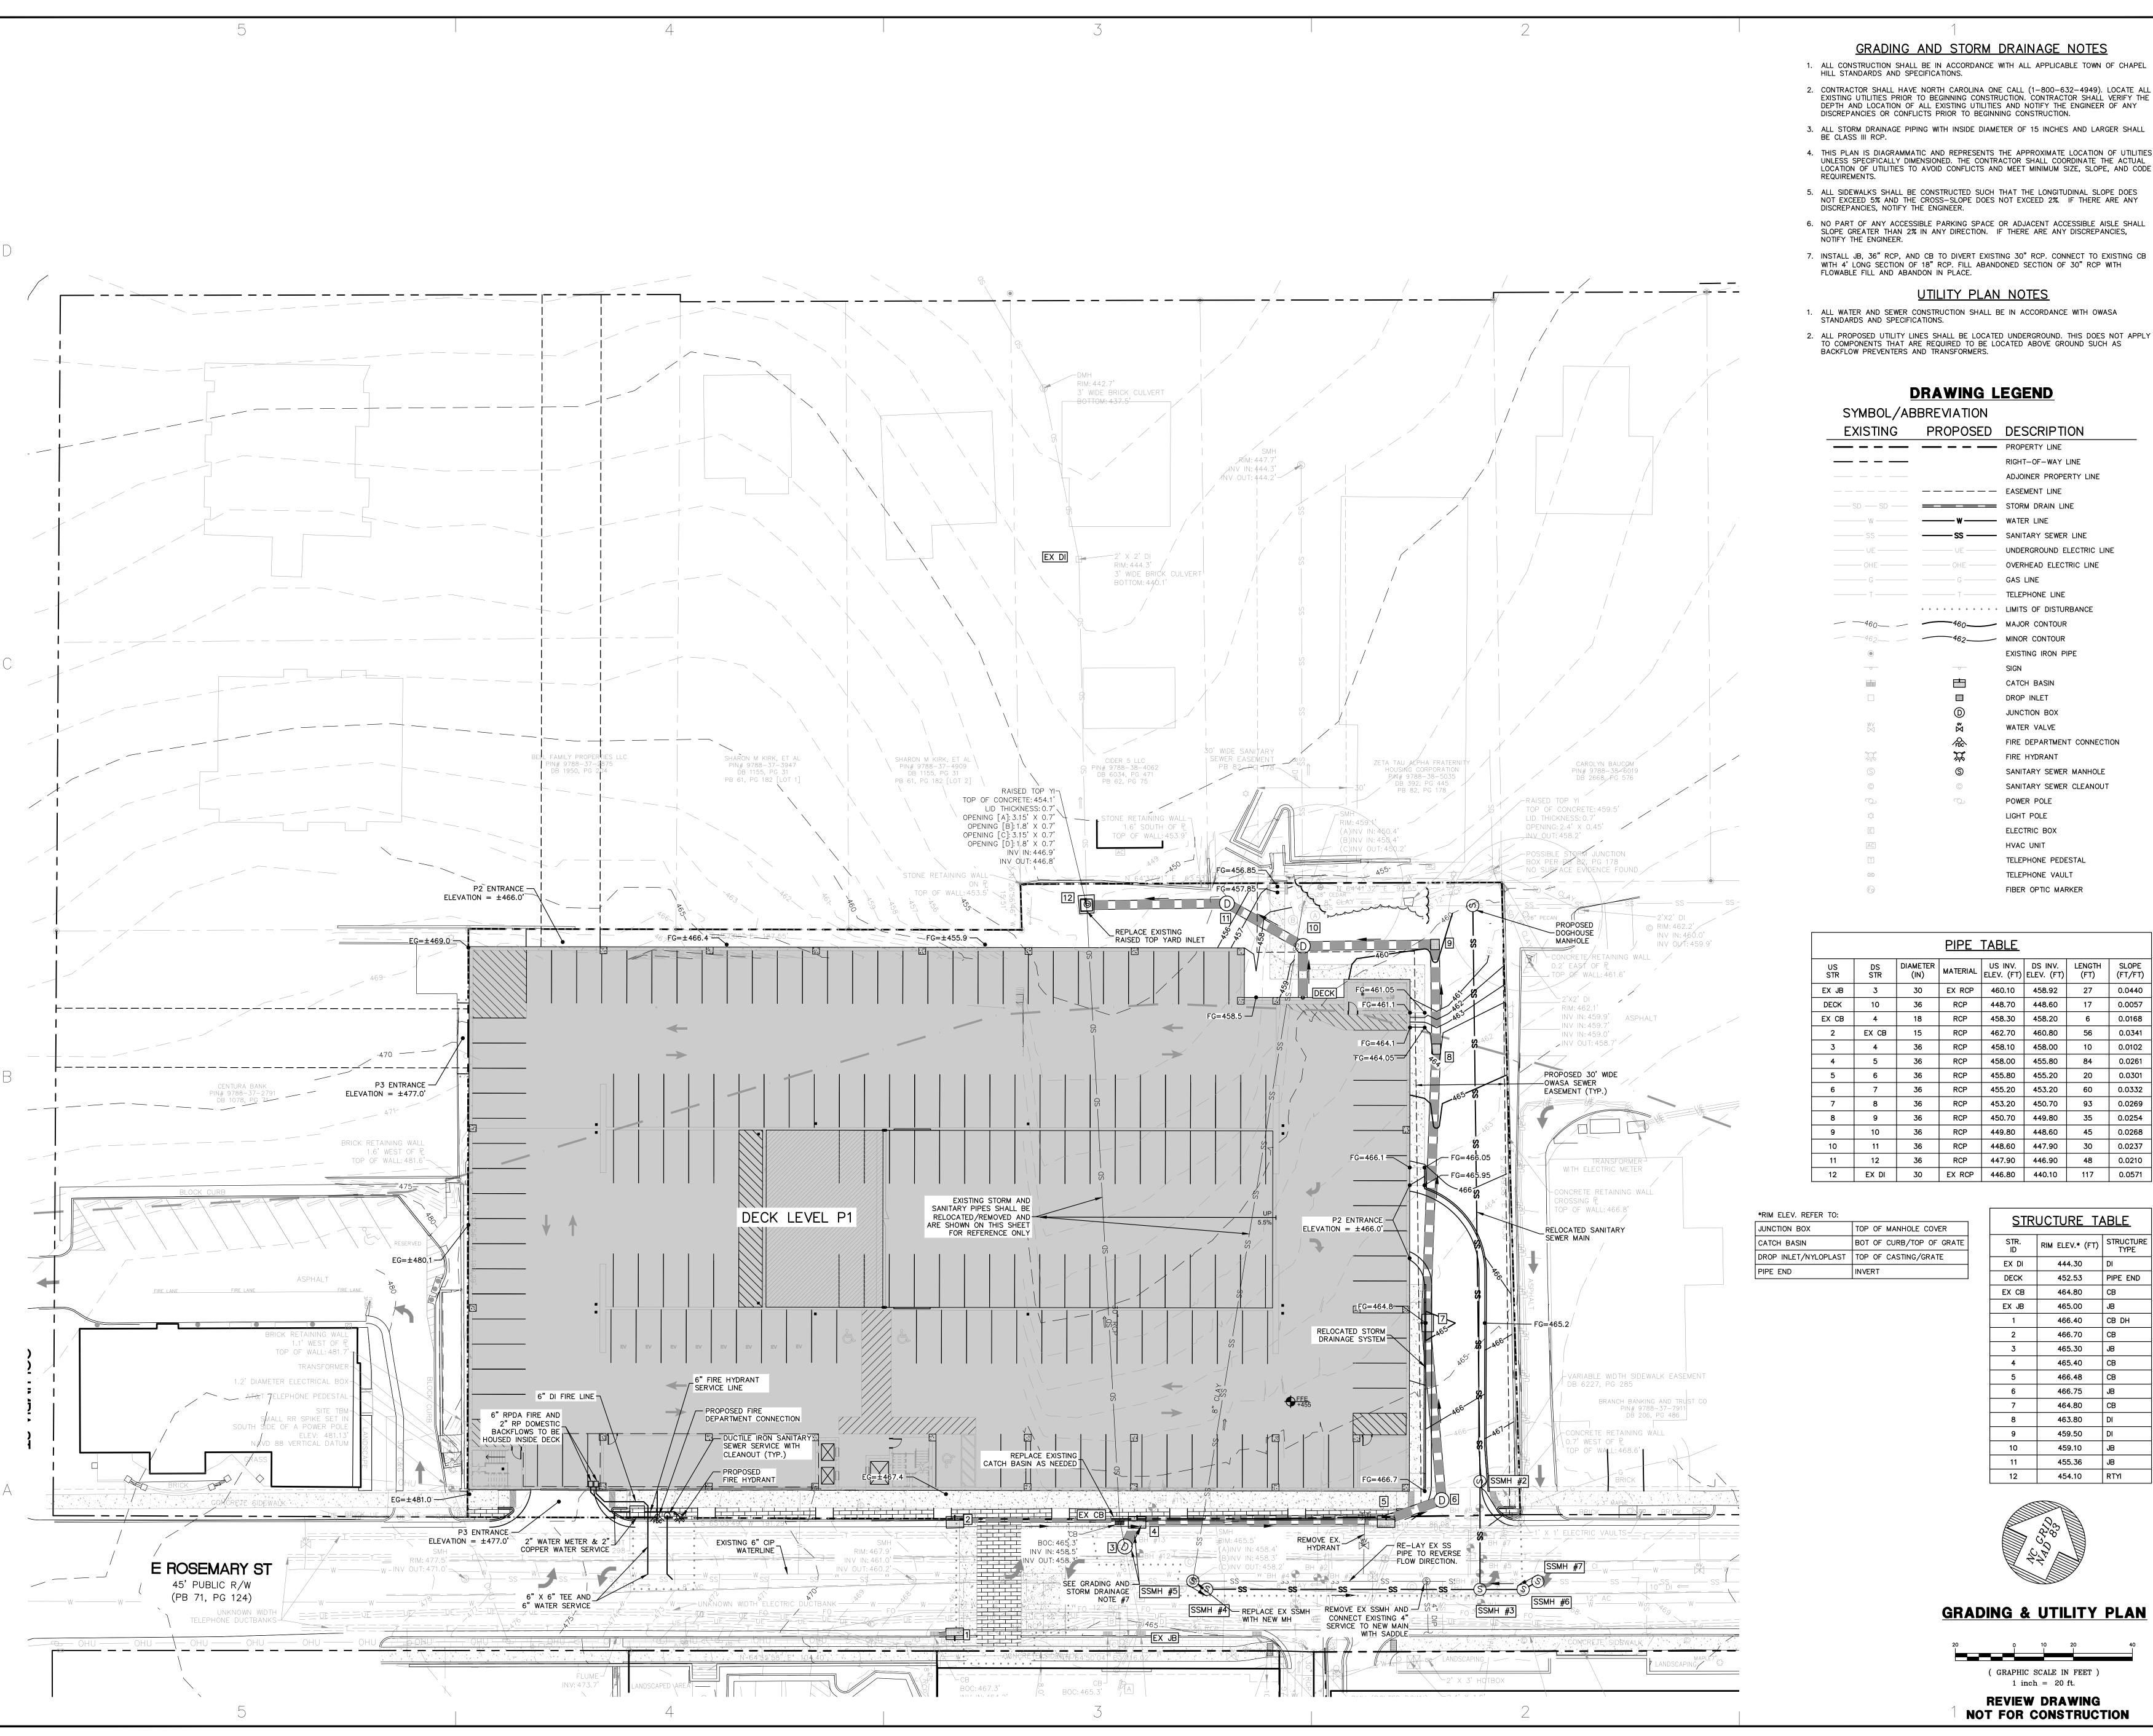
OWNER INFORMATION GRUBB PROPERTIES, INC
4500 CAMERON VALLEY PKWY.
SUITE 350
CHARLOTTE, NC 28211 OWNERS REPRESENTATIVE:

(919) 388-5774 FAX (919) 461-3939 EMAIL jdye@grubbproperties.com

0

JOB #: 118038.01 DATE: 02 MAR 20 SCALE: AS NOTED DRAWN BY: J.B.M.

C1001

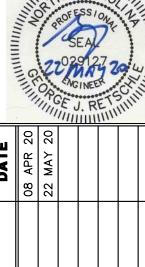

### GRADING AND STORM DRAINAGE NOTES

- 2. CONTRACTOR SHALL HAVE NORTH CAROLINA ONE CALL (1-800-632-4949). LOCATE ALL EXISTING UTILITIES PRIOR TO BEGINNING CONSTRUCTION. CONTRACTOR SHALL VERIFY THE DEPTH AND LOCATION OF ALL EXISTING UTILITIES AND NOTIFY THE ENGINEER OF ANY DISCREPANCIES OR CONFLICTS PRIOR TO BEGINNING CONSTRUCTION.
- 3. ALL STORM DRAINAGE PIPING WITH INSIDE DIAMETER OF 15 INCHES AND LARGER SHALL
- 4. THIS PLAN IS DIAGRAMMATIC AND REPRESENTS THE APPROXIMATE LOCATION OF UTILITIES UNLESS SPECIFICALLY DIMENSIONED. THE CONTRACTOR SHALL COORDINATE THE ACTUAL LOCATION OF UTILITIES TO AVOID CONFLICTS AND MEET MINIMUM SIZE, SLOPE, AND CODE
- 6. NO PART OF ANY ACCESSIBLE PARKING SPACE OR ADJACENT ACCESSIBLE AISLE SHALL SLOPE GREATER THAN 2% IN ANY DIRECTION. IF THERE ARE ANY DISCREPANCIES,
- 7. INSTALL JB, 36" RCP, AND CB TO DIVERT EXISTING 30" RCP. CONNECT TO EXISTING CB WITH 4' LONG SECTION OF 18" RCP. FILL ABANDONED SECTION OF 30" RCP WITH

### UTILITY PLAN NOTES

- 1. ALL WATER AND SEWER CONSTRUCTION SHALL BE IN ACCORDANCE WITH OWASA
- 2. ALL PROPOSED UTILITY LINES SHALL BE LOCATED UNDERGROUND. THIS DOES NOT APPLY TO COMPONENTS THAT ARE REQUIRED TO BE LOCATED ABOVE GROUND SUCH AS


# **DRAWING LEGEND**

EXISTING	PROPOSED	DESCRIPTION
,		


EXISTING	PROPOSED	DESCRIP HON
		PROPERTY LINE
		RIGHT-OF-WAY LINE
		ADJOINER PROPERTY LINE
		EASEMENT LINE
—— SD —— SD ——		STORM DRAIN LINE
——— W ———	——w—	WATER LINE
———— SS ————	—— ss ——	SANITARY SEWER LINE
——— UE ———	——— UE ———	UNDERGROUND ELECTRIC LINE
OHE	OHE	OVERHEAD ELECTRIC LINE
G	G	GAS LINE
T	Т —	TELEPHONE LINE
		LIMITS OF DISTURBANCE
——460— —	460	MAJOR CONTOUR
——462— —	462	MINOR CONTOUR
•		EXISTING IRON PIPE
		SIGN
		CATCH BASIN
		DROP INLET
	<b>(D)</b>	JUNCTION BOX
WV 	<b>ÖV</b>	WATER VALVE
	FDC	FIRE DEPARTMENT CONNECTION
	$\not\cong$	FIRE HYDRANT
(\$)	<b>S</b>	SANITARY SEWER MANHOLE
©	©	SANITARY SEWER CLEANOUT
		POWER POLE
ф		LIGHT POLE
E		ELECTRIC BOX
AC		HVAC UNIT
T		TELEPHONE PEDESTAL
$\bowtie$		TELEPHONE VAULT

	<u>PIPE_TABLE</u>						
US STR	DS STR	DIAMETER (IN)	MATERIAL	US INV. ELEV. (FT)	DS INV. ELEV. (FT)	LENGTH (FT)	SLOPE (FT/FT)
EX JB	3	30	EX RCP	460.10	458.92	27	0.0440
DECK	10	36	RCP	448.70	448.60	17	0.0057
EX CB	4	18	RCP	458.30	458.20	6	0.0168
2	EX CB	15	RCP	462.70	460.80	56	0.0341
3	4	36	RCP	458.10	458.00	10	0.0102
4	5	36	RCP	458.00	455.80	84	0.0261
5	6	36	RCP	455.80	455.20	20	0.0301
6	7	36	RCP	455.20	453.20	60	0.0332
7	8	36	RCP	453.20	450.70	93	0.0269
8	9	36	RCP	450.70	449.80	35	0.0254
9	10	36	RCP	449.80	448.60	45	0.0268
10	11	36	RCP	448.60	447.90	30	0.0237
11	12	36	RCP	447.90	446.90	48	0.0210
12	EX DI	30	EX RCP	446.80	440.10	117	0.0571

STRUCTURE TABLE			
STR. ID	RIM ELEV.* (FT)	STRUCTURE TYPE	
EX DI	444.30	DI	
DECK	452.53	PIPE END	
EX CB	464.80	СВ	
EX JB	465.00	JB	
1	466.40	CB DH	
2	466.70	СВ	
3	465.30	JB	
4	465.40	СВ	
5	466.48	СВ	
6	466.75	JB	
7	464.80	СВ	
8	463.80	DI	
9	459.50	DI	
10	459.10	JB	
11	455.36	JB	
12	454.10	RTYI	
	STR. ID  EX DI  DECK  EX CB  EX JB  1  2  3  4  5  6  7  8  9  10  11	STR. ID RIM ELEV.* (FT)  EX DI 444.30  DECK 452.53  EX CB 464.80  EX JB 465.00  1 466.40  2 466.70  3 465.30  4 465.40  5 466.48  6 466.75  7 464.80  8 463.80  9 459.50  10 459.10  11 455.36	

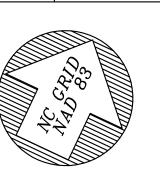

**GRADING & UTILITY PLAN** 

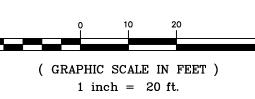


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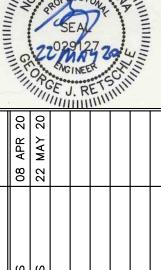
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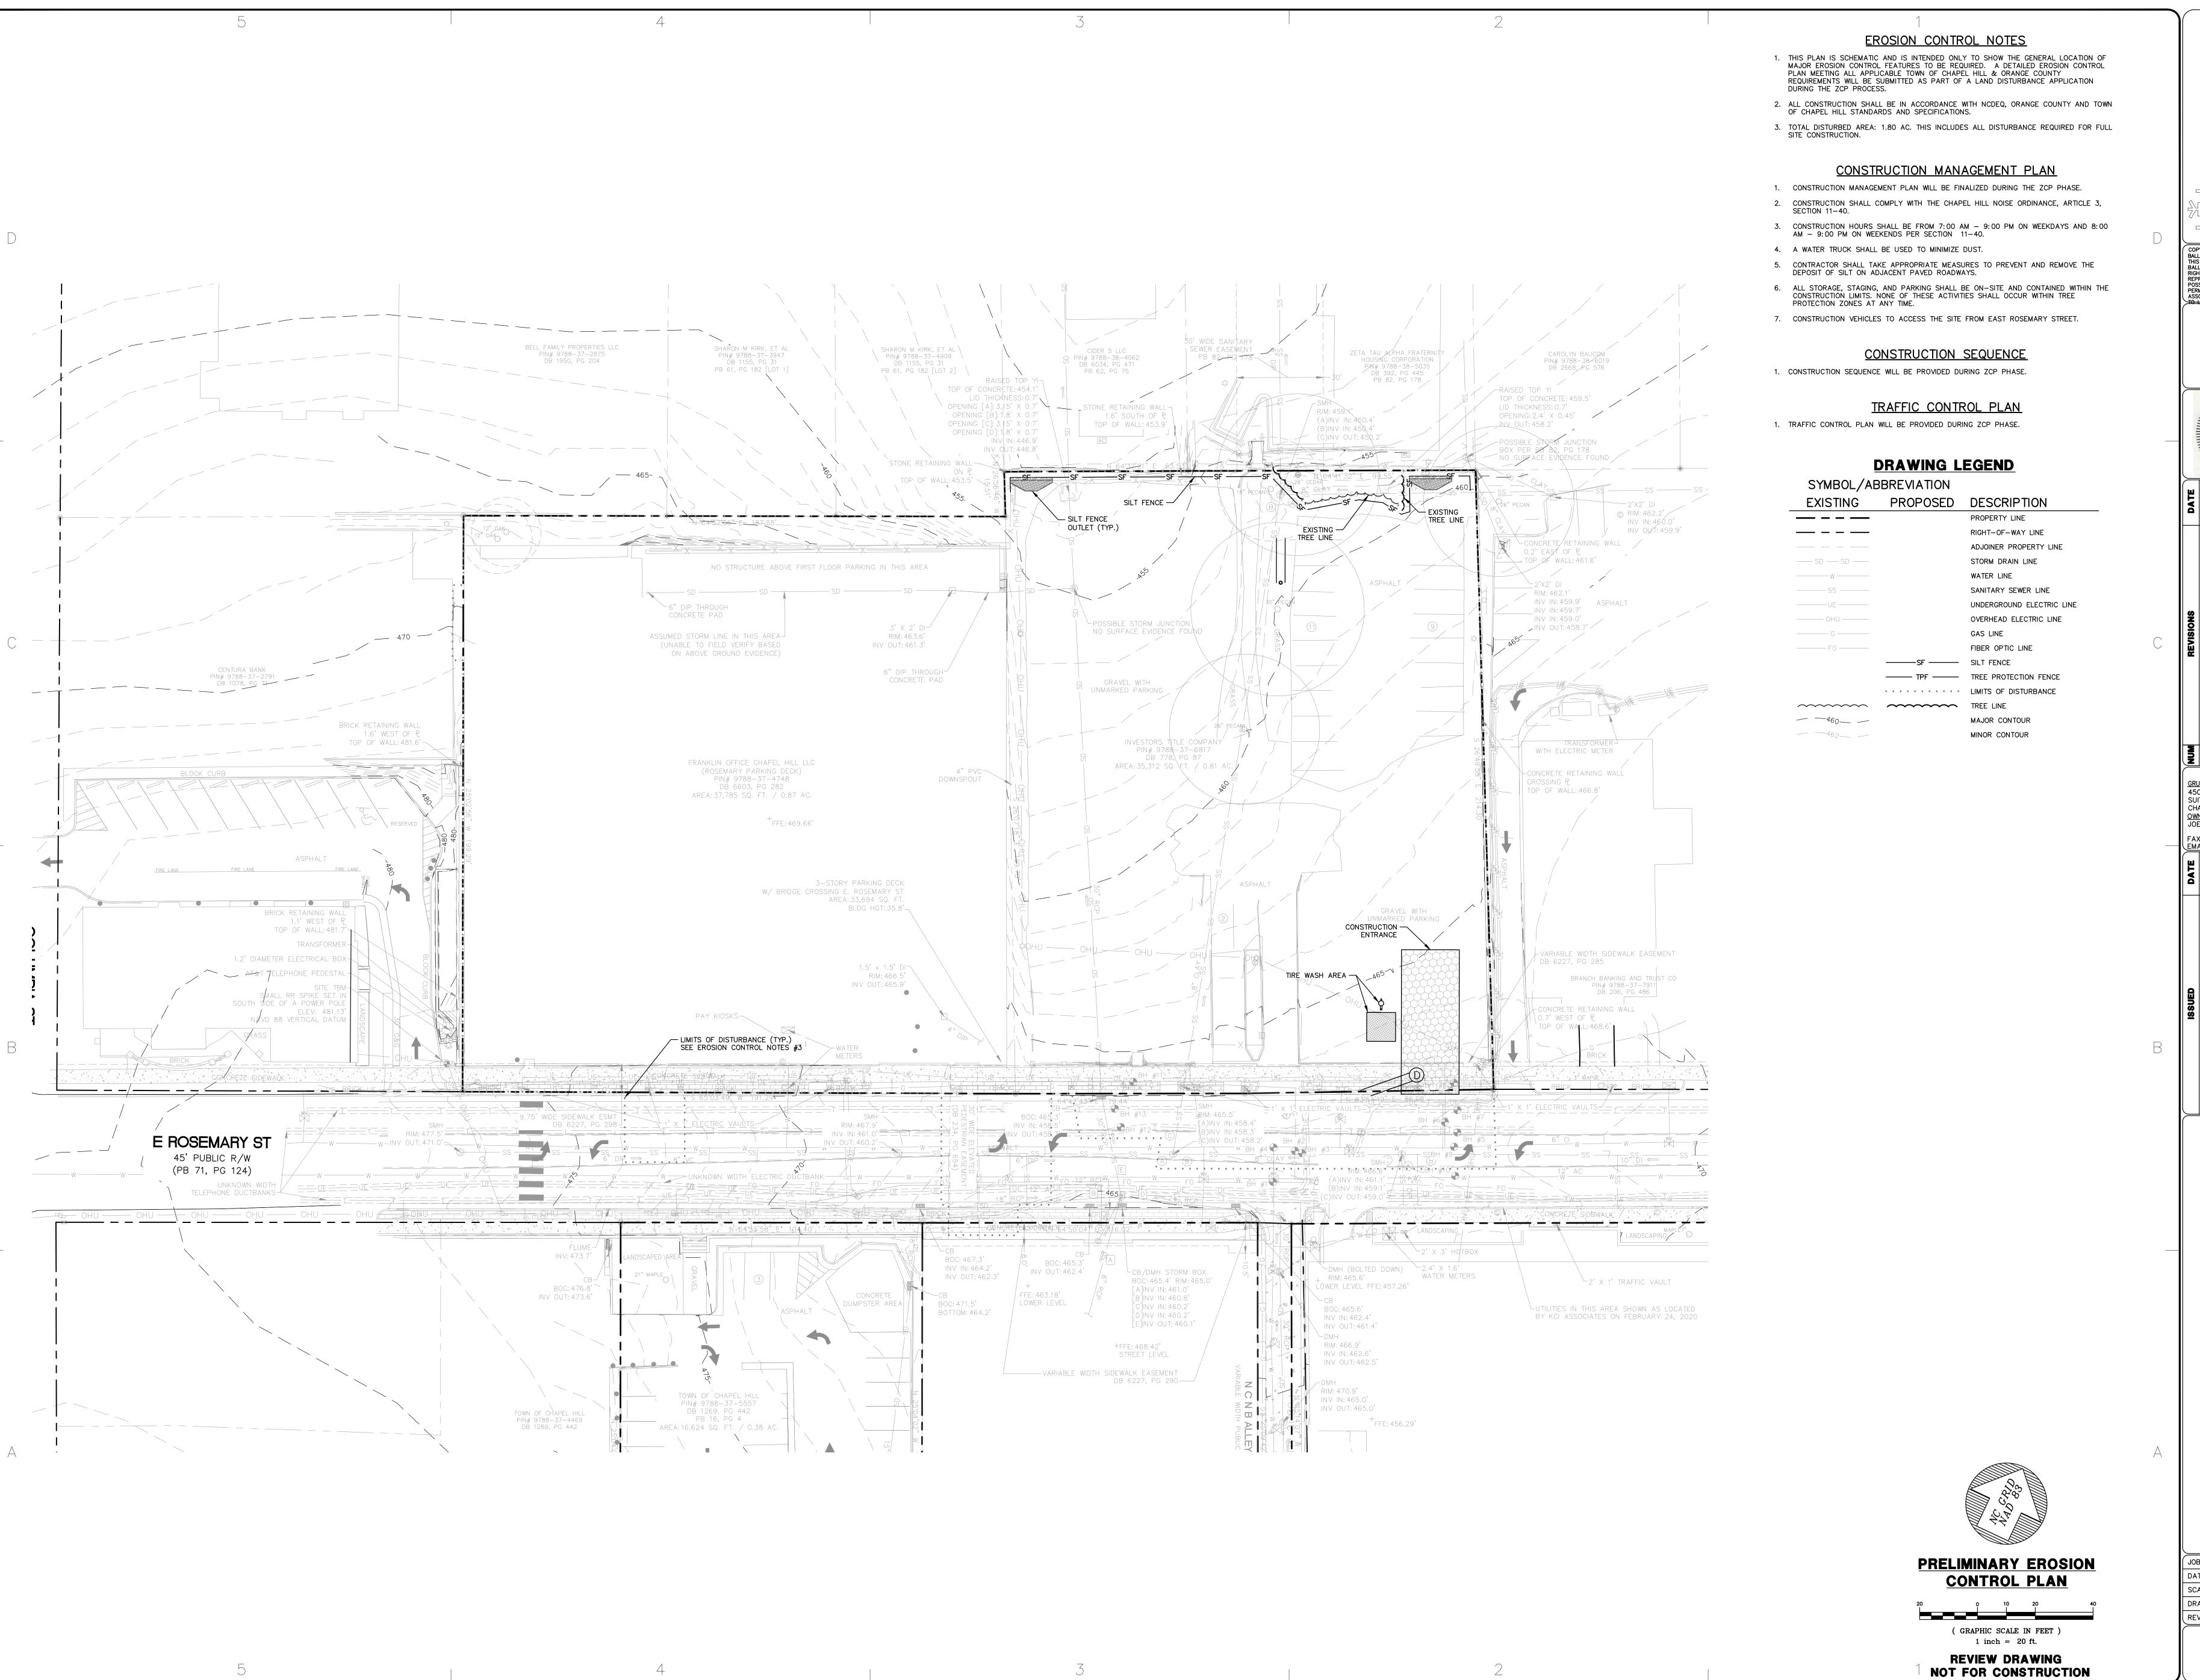




4500 CAMERON VALLEY PKWY. CHARLOTTE, NC 28211 OWNERS REPRESENTATIVE:

JOB #: 118038.01 DATE: 02 MAR 20 SCALE: AS NOTED

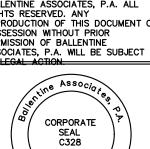DRAWN BY: J.B.M. REVIEWED BY: G.J.R. SHEET



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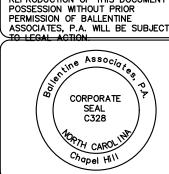
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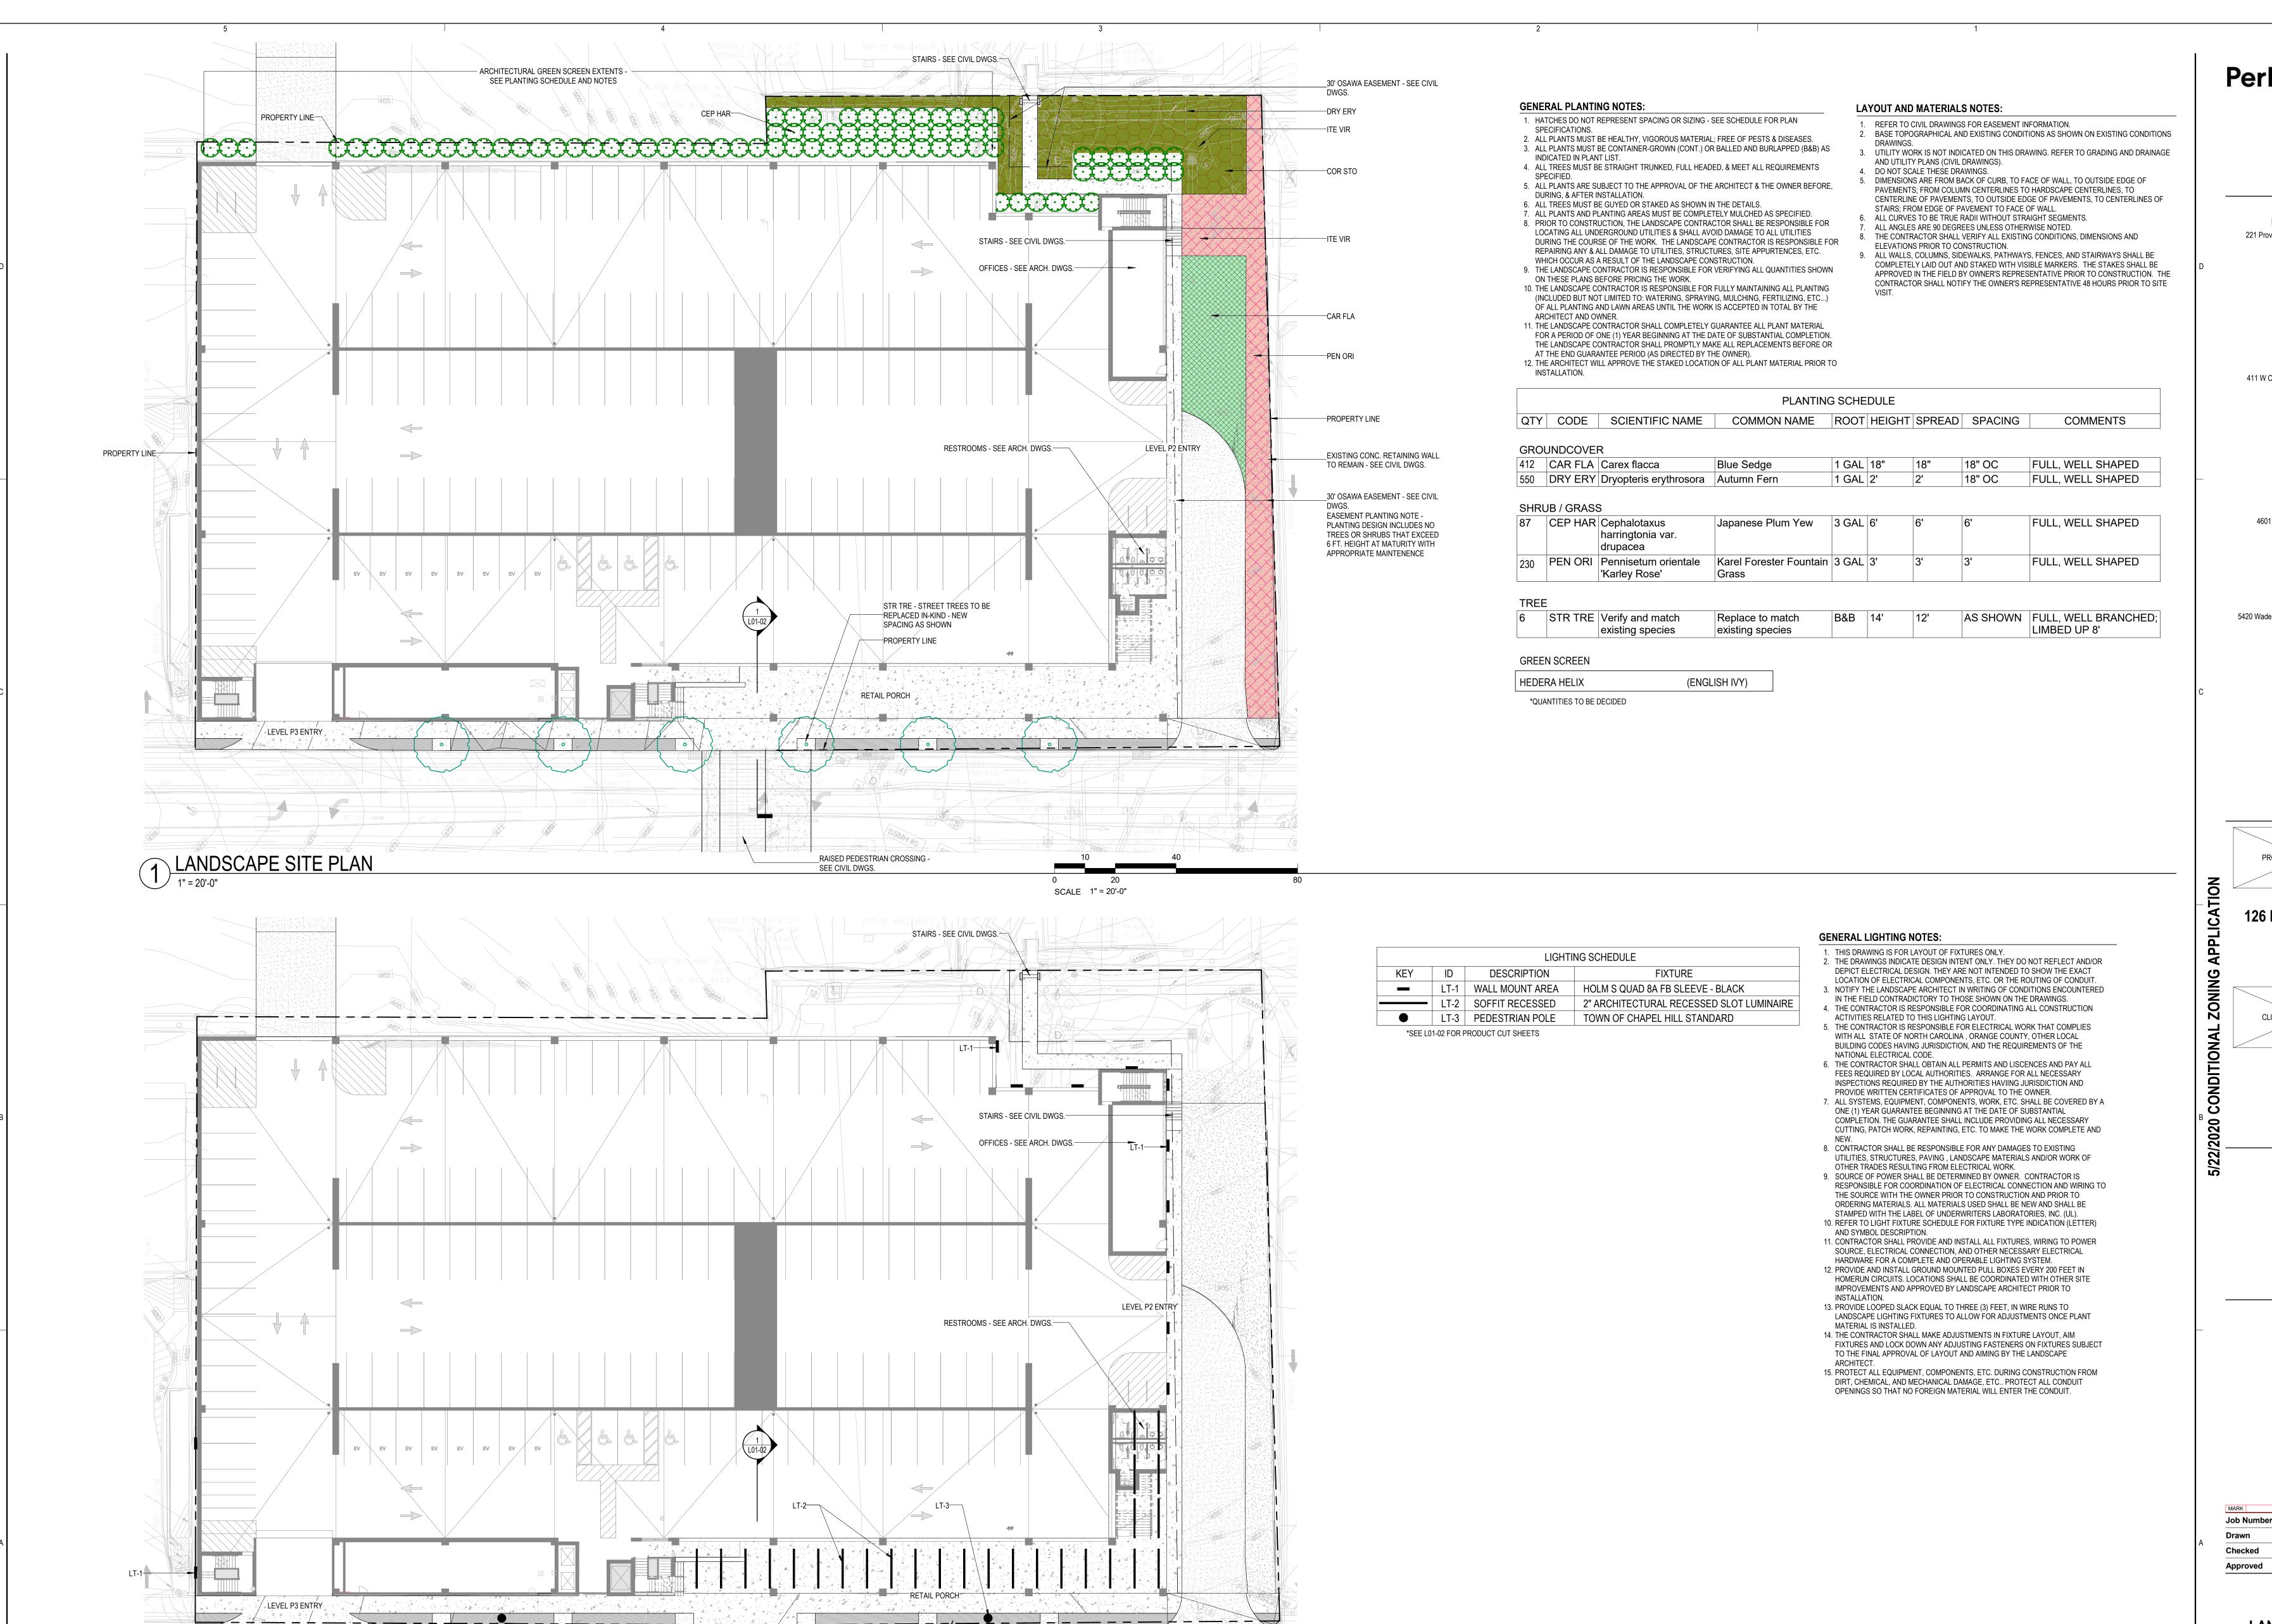


GRUBB PROPERTIES, INC 4500 CAMERON VALLEY PKWY. CHARLOTTE, NC 28211 OWNERS REPRESENTATIVE:

JOB #: 118038.01 DATE: 02 MAR 20 SCALE: AS NOTED

DRAWN BY: J.B.M. REVIEWED BY: G.J.R.

SHEET C1301



RAISED PEDESTRIAN CROSSING

SCALE 1" = 20'-0"

SEE CIVIL DWGS.

2 SITE LIGHTING PLAN

1" = 20'-0"

Perkins&Will

Legacy Tower 411 W Chapel Hill Street, Suite 200 Durham, North Carolina 27701 t 919.433.5300 f 919.433.5301

perkinswill.com CONSULTANTS

BALLENTINE ASSOCIATES, P.A. 221 Providence Road, Chapel Hill, NC 27514

> STRUCTURAL 6750 Tryon Road, Cary, NC 27526

6750 Tryon Road, Cary, NC 27526 LANDSCAPING PERKINS & WILL

411 W Chapel Hill St Suite 200, Durham, NC

**GRUBB PROPERTIES** 4601 Park Road Suite 450, Charlotte, NC 28209 **FACILITY** 

CONTRACTOR **SAMET Corporation** 5420 Wade Park Boulevard, Suite 104, Raleigh,

**PROJECT** 

PROJECT LOGO IF AVAILABLE

**126 E ROSEMARY ST PARKING DECK** 

CLIENT LÒGO IF ÁVAILABLE

**KEYPLAN** 

**ISSUE CHART** 

Author Checker

> Approver TITLE


LANDSCAPE PLANS

SHEET NUMBER

L01-01



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Perkins&Will

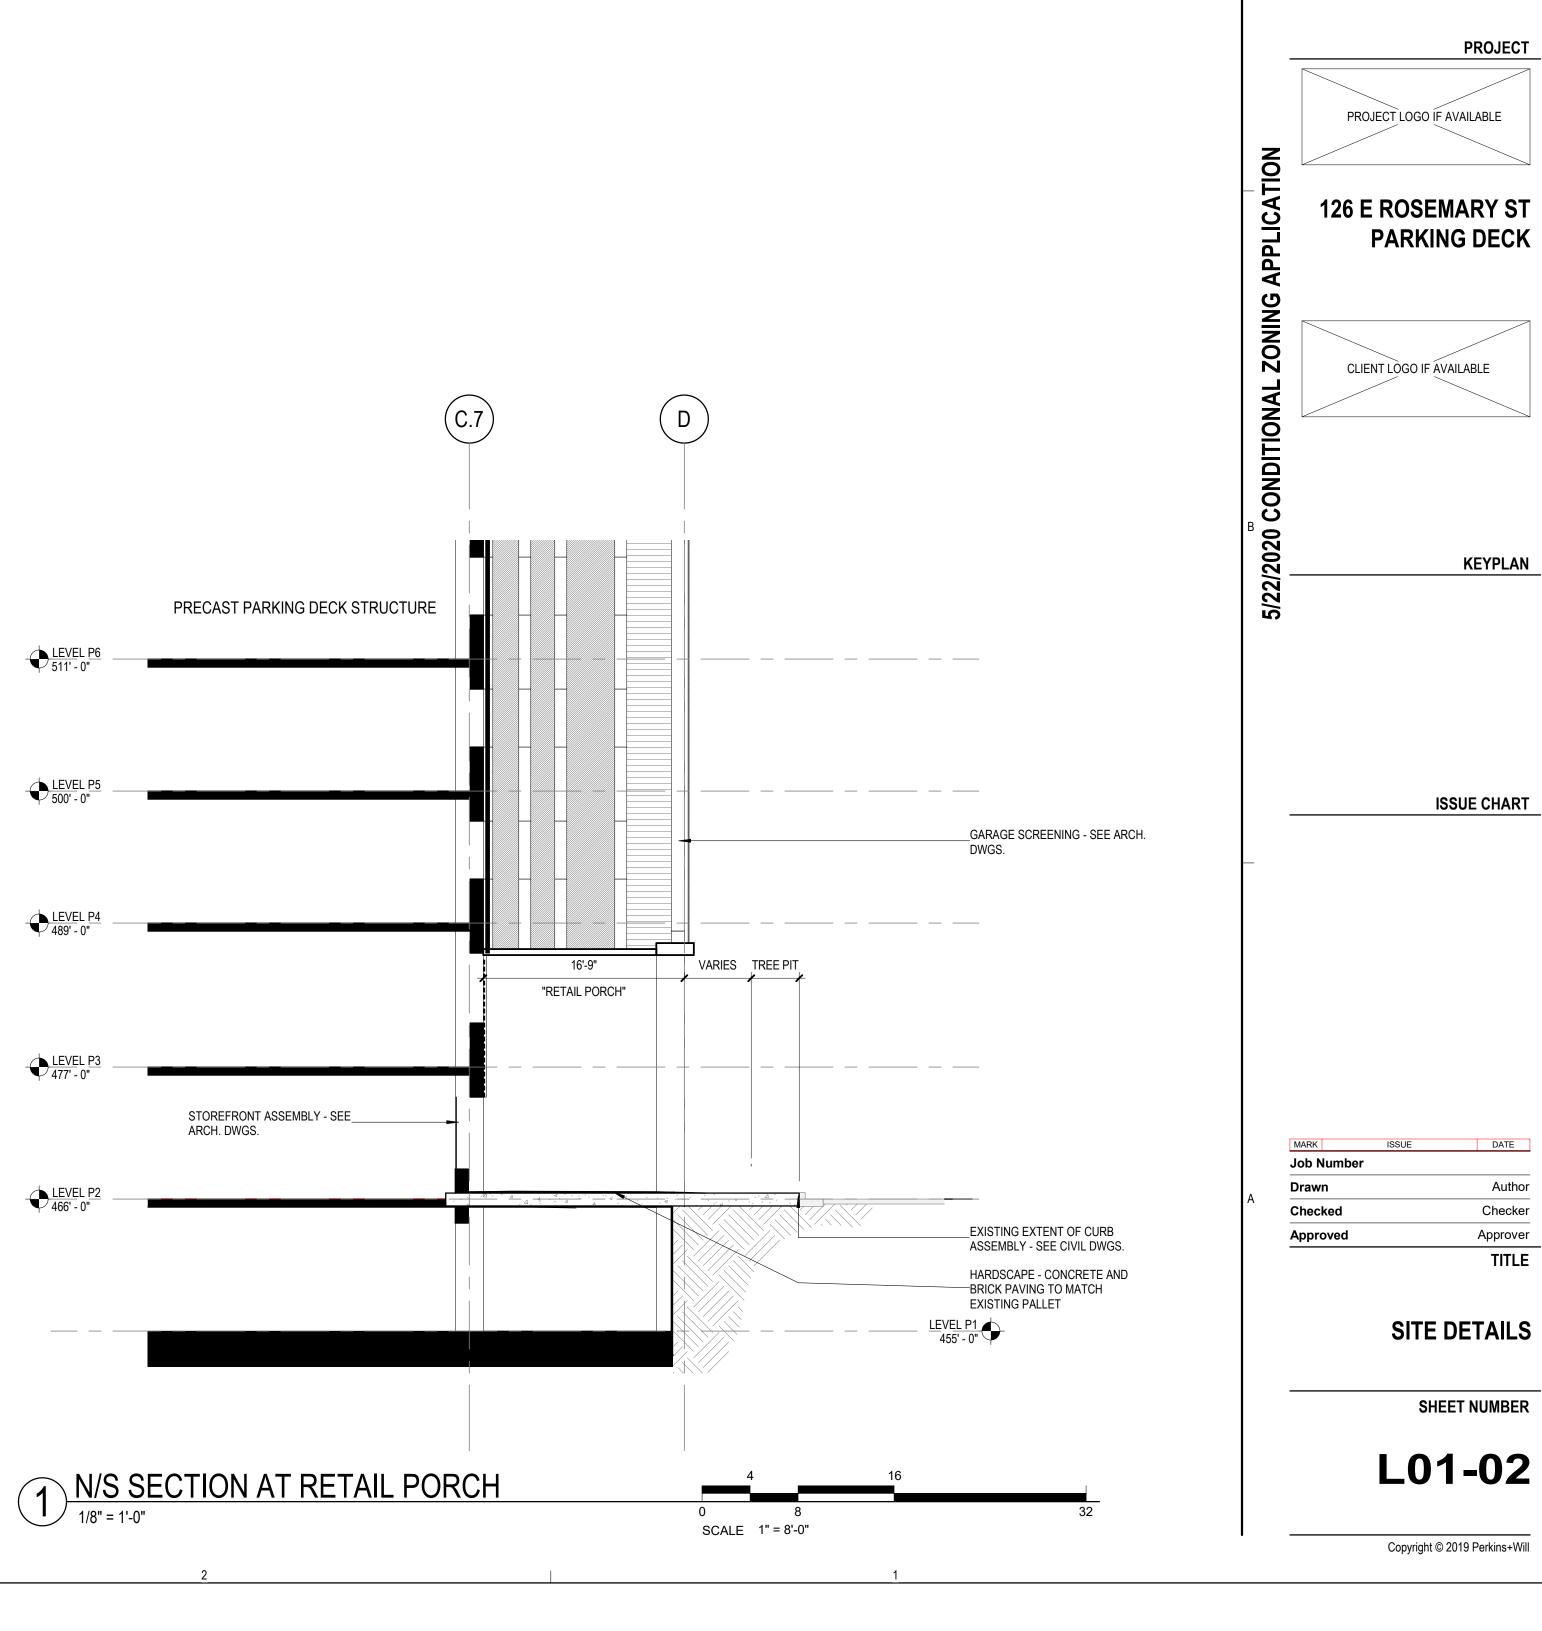411 W Chapel Hill Street, Suite 200

BALLENTINE ASSOCIATES, P.A.

6750 Tryon Road, Cary, NC 27526

6750 Tryon Road, Cary, NC 27526

**GRUBB PROPERTIES** 

**FACILITY** 

CONTRACTOR

Author Checker

Approver

TITLE

SAMET Corporation

4601 Park Road Suite 450, Charlotte, NC

5420 Wade Park Boulevard, Suite 104, Raleigh,

411 W Chapel Hill St Suite 200, Durham, NC

221 Providence Road, Chapel Hill, NC 27514

Durham, North Carolina 27701

t 919.433.5300

f 919.433.5301

perkinswill.com

STRUCTURAL

LANDSCAPING PERKINS & WILL

CONSULTANTS

<u>LT-3</u>

ONLY - REPLACE LIGHT FIXTURES

ALONG ROSEMARY STREET IN-KIND

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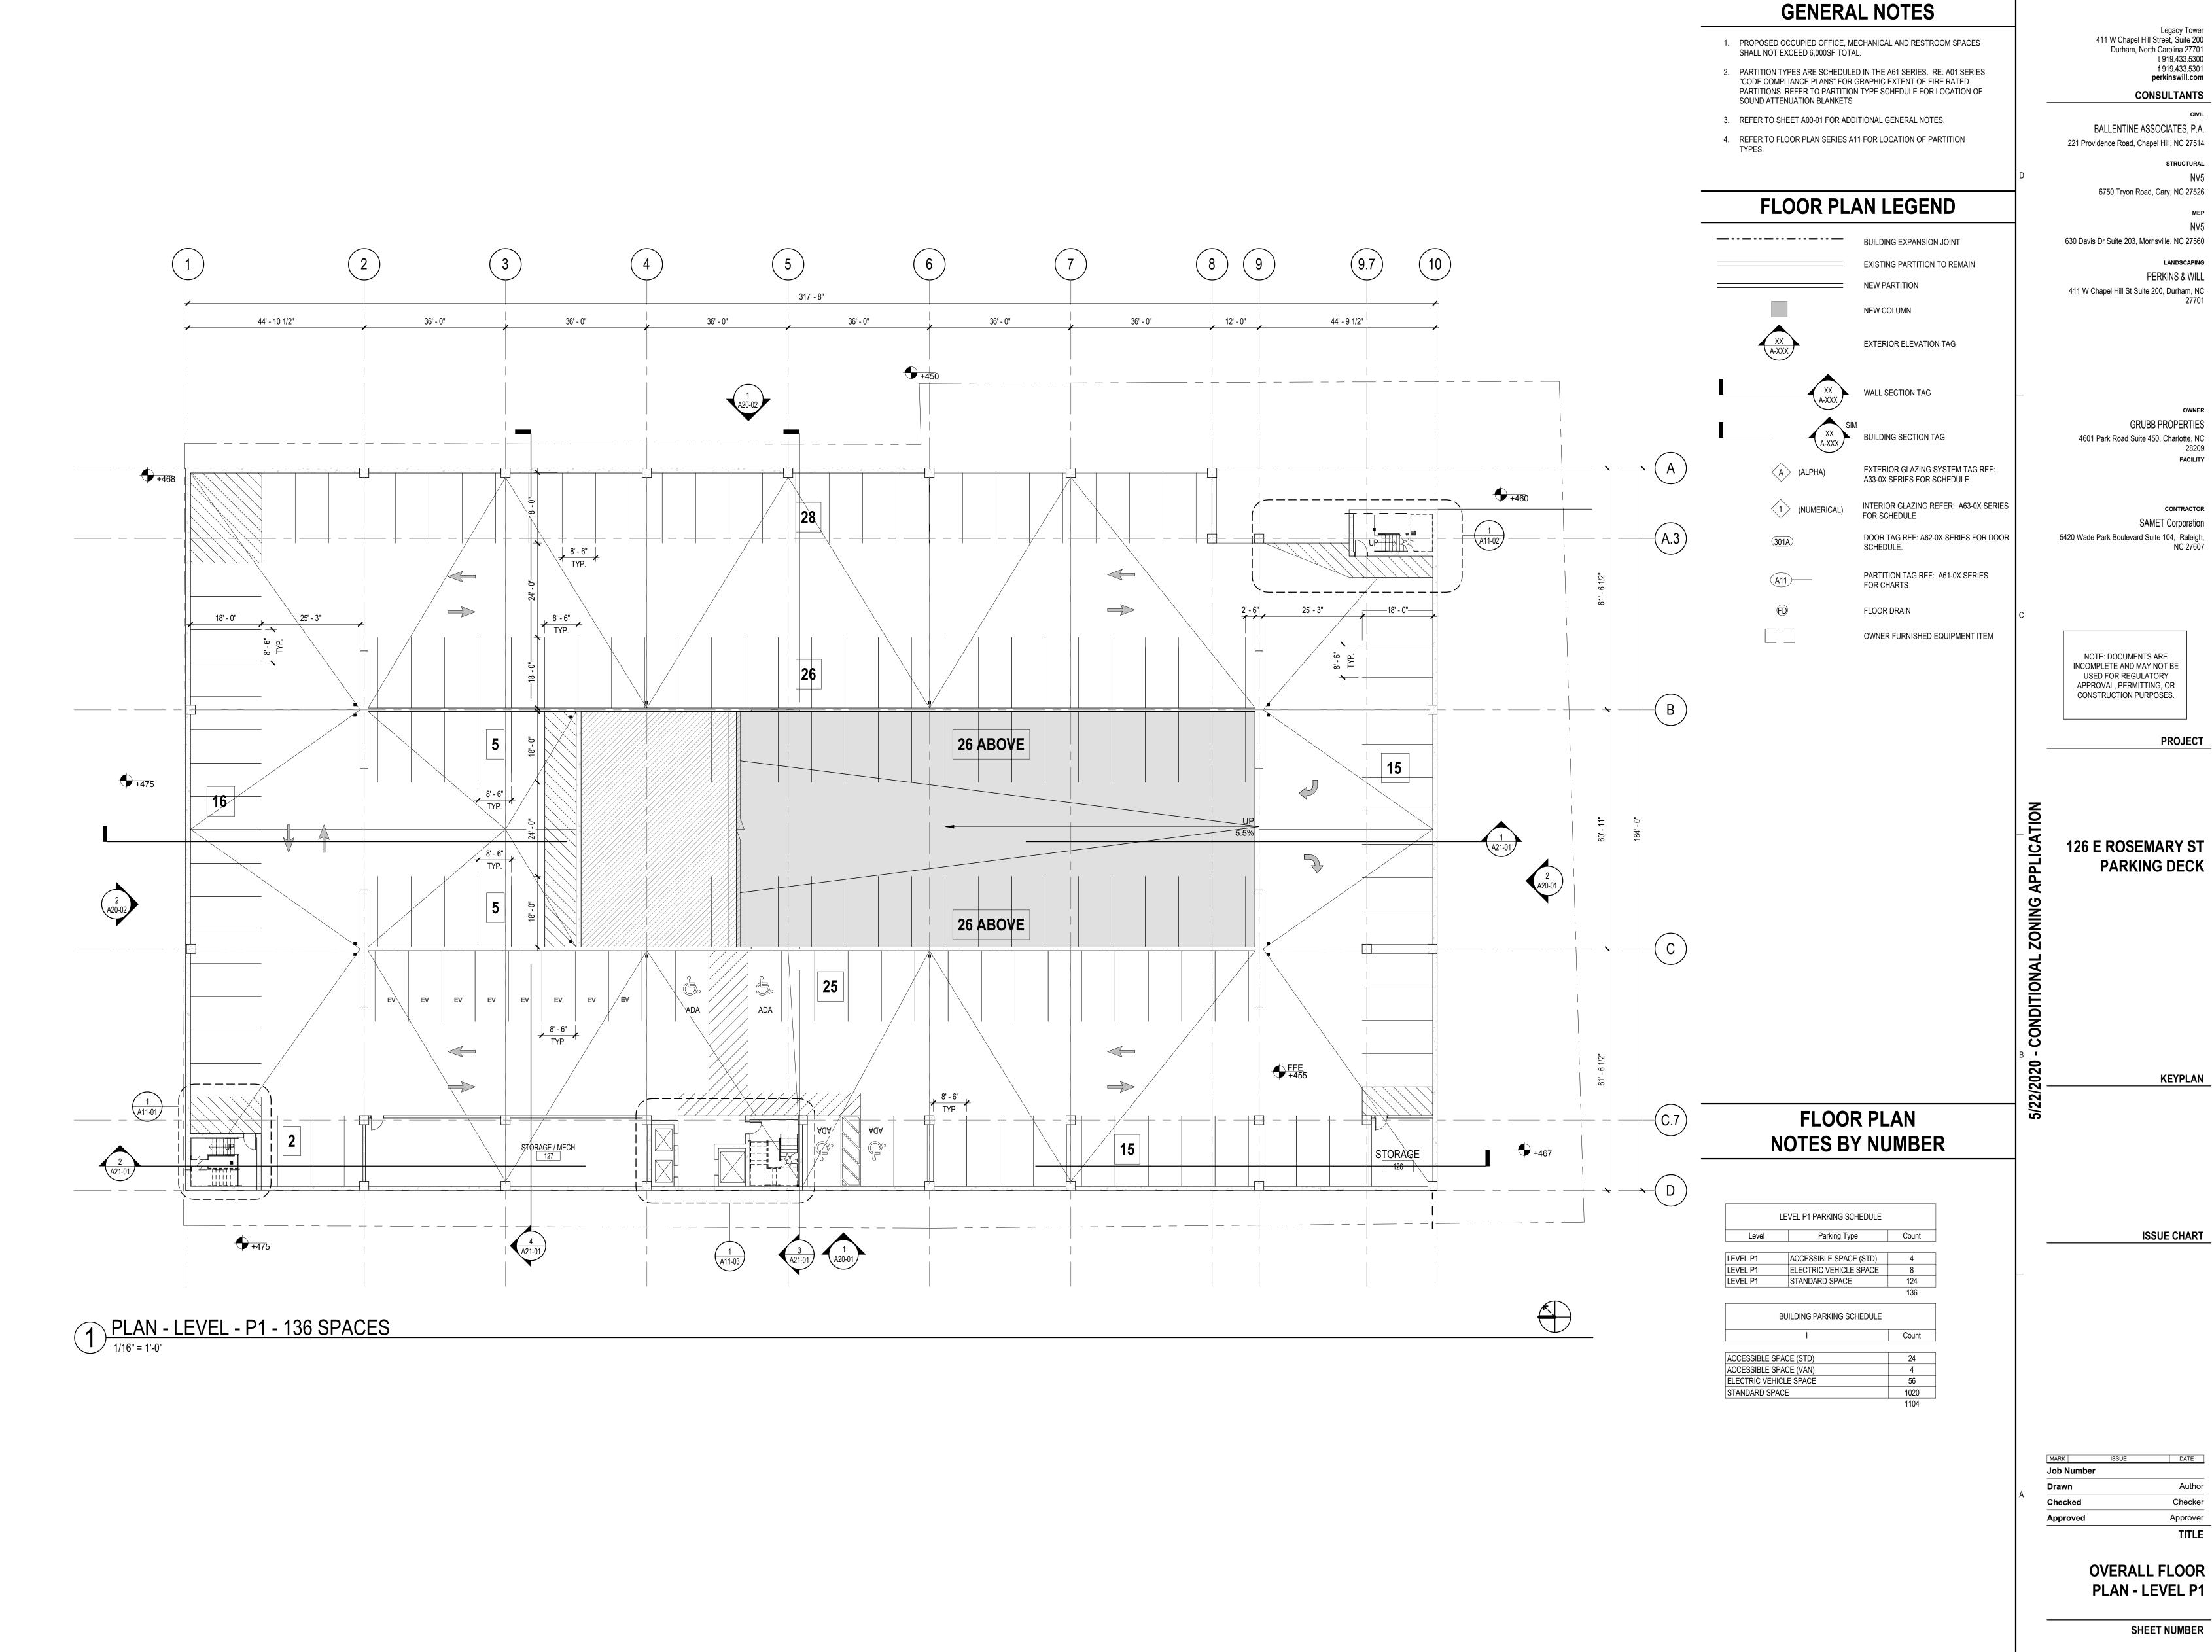
WARRANTY 5 Year warranty

visit electrixillumination.com for details

· Average rated LED life of 50,000 hours @ 70% lumen output

**EXTRA HIGH** 1000 Lm/ft 12 W/ft 83 Lm/w

Consult factory for custom outputs



**FLOOR PLAN** 

t 919.433.5300 f 919.433.5301 perkinswill.com


6750 Tryon Road, Cary, NC 27526

LANDSCAPING PERKINS & WILL

**GRUBB PROPERTIES** 

**PARKING DECK** 


A10-01 FOR REFERENCE ONLY

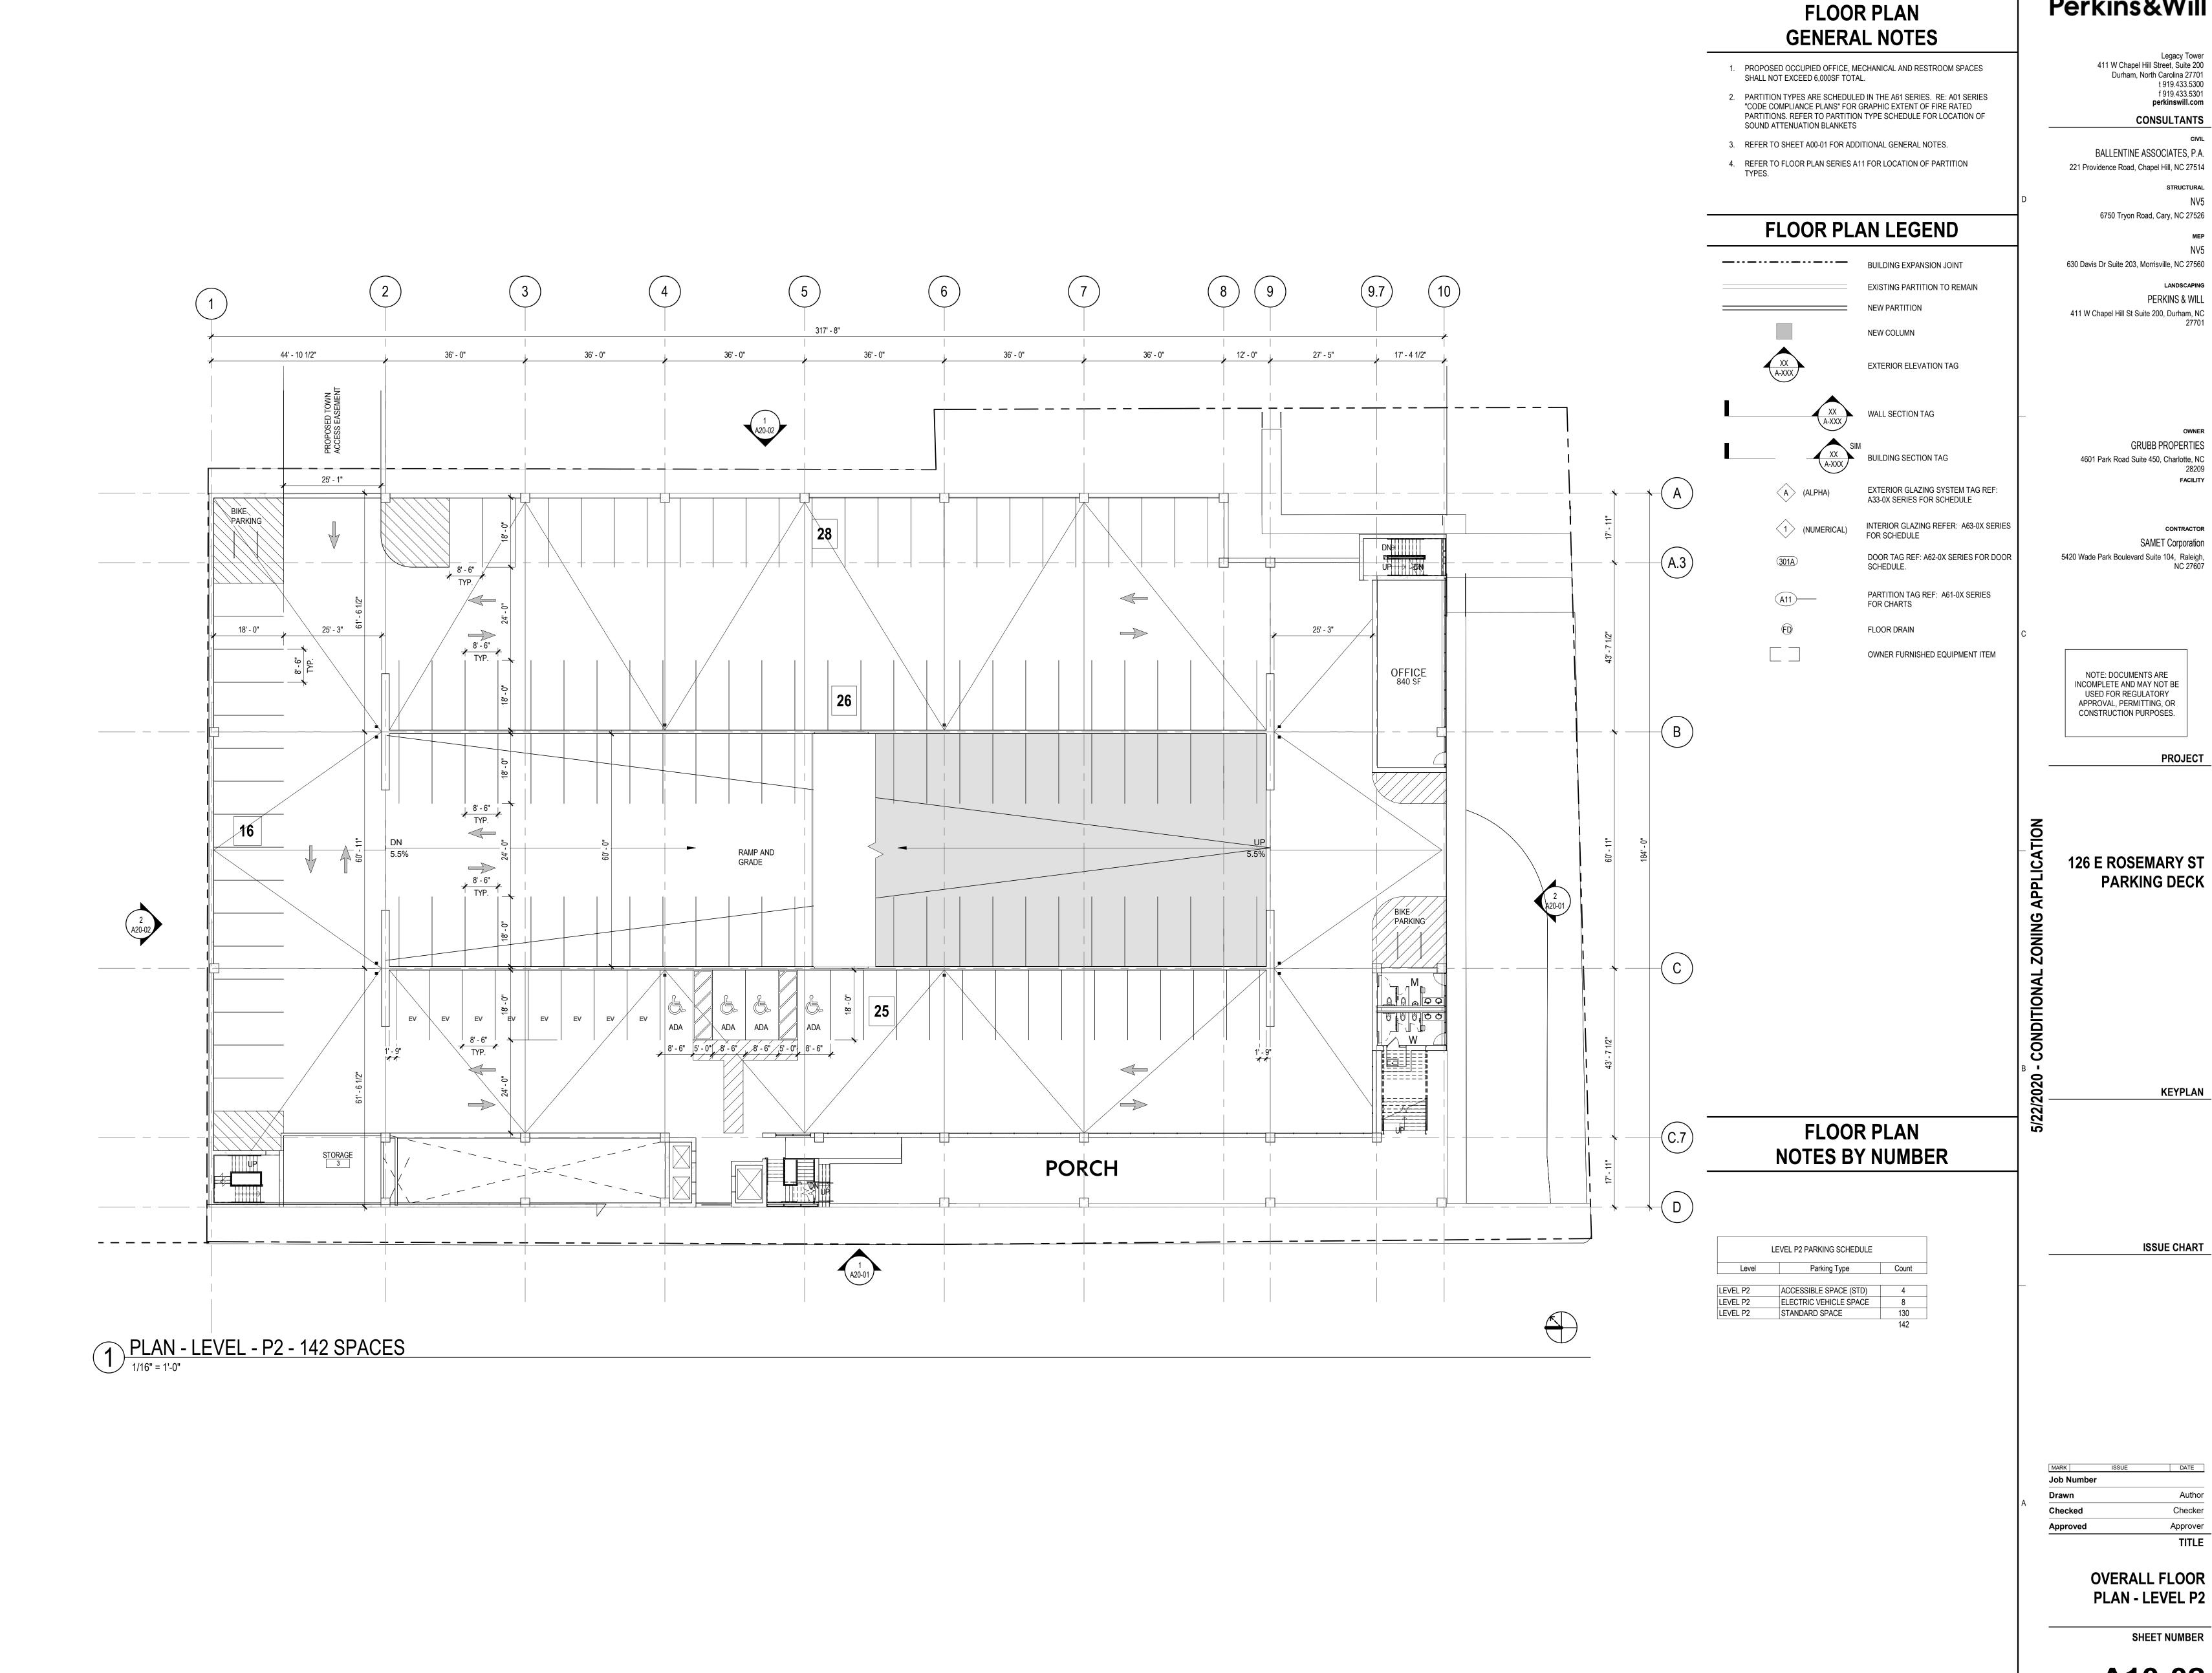


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**GRUBB PROPERTIES** 

A10-02 FOR REFERENCE ONLY

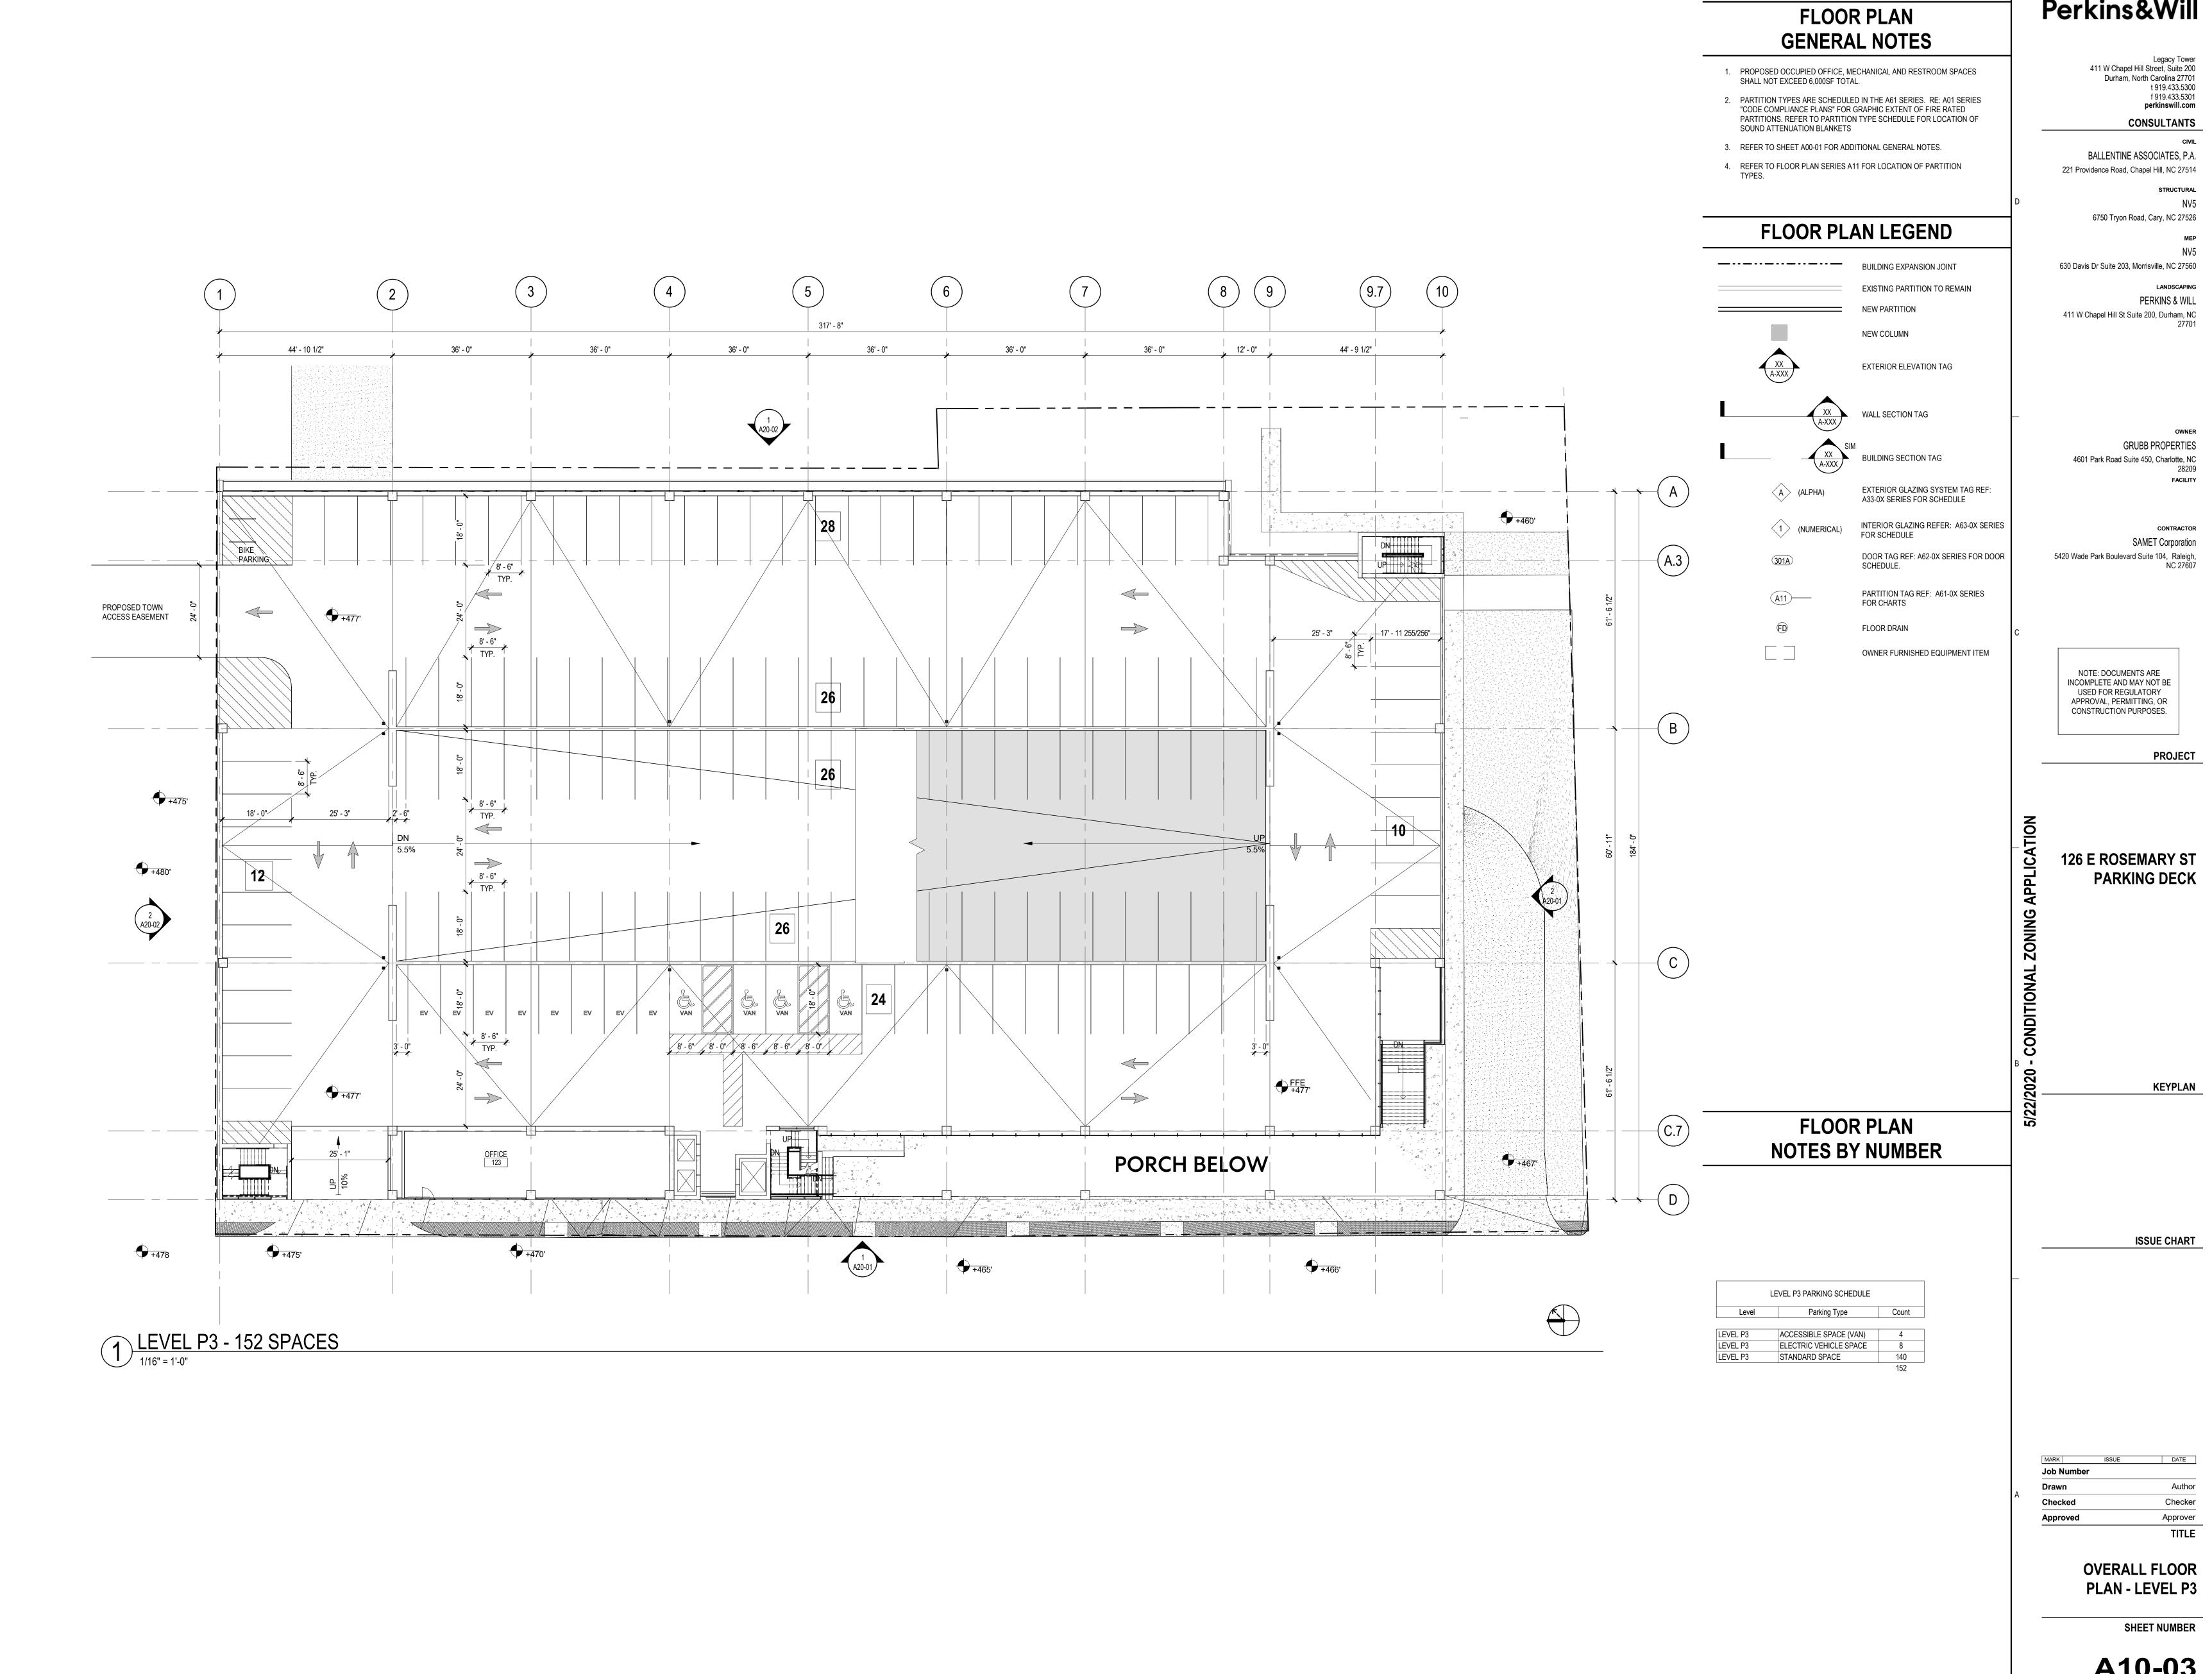


A10-03 FOR REFERENCE ONLY

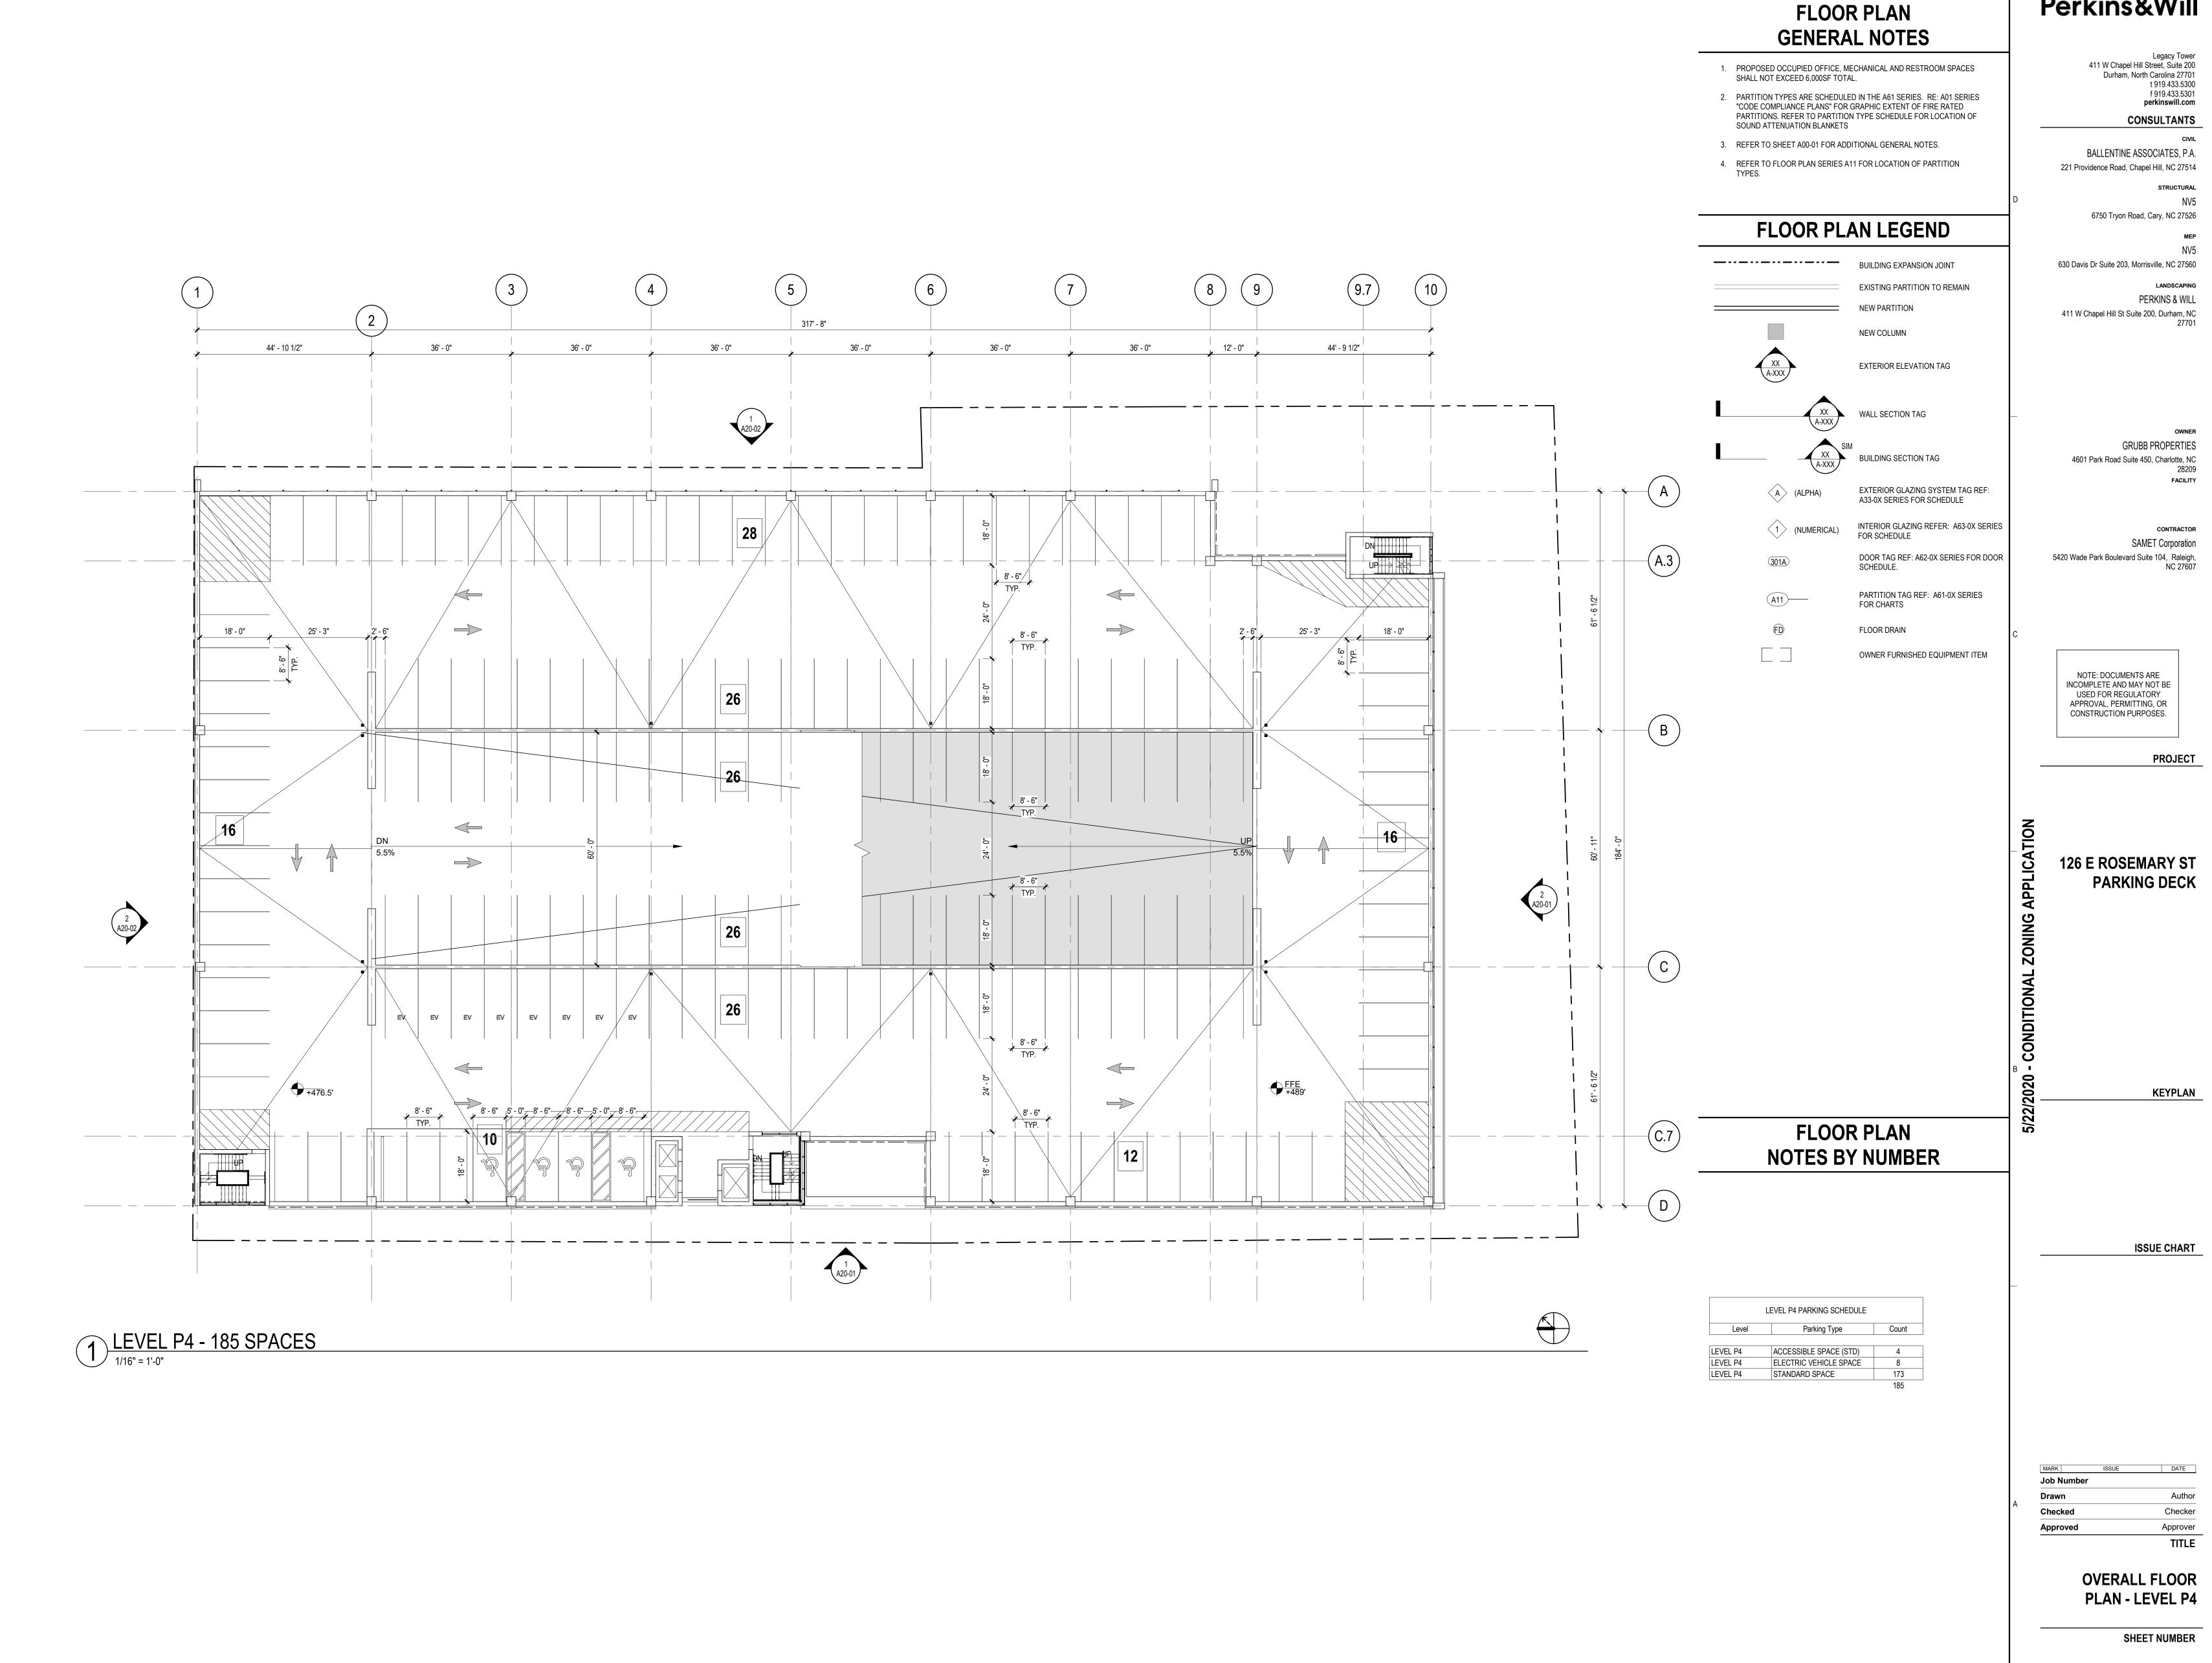


A10-04

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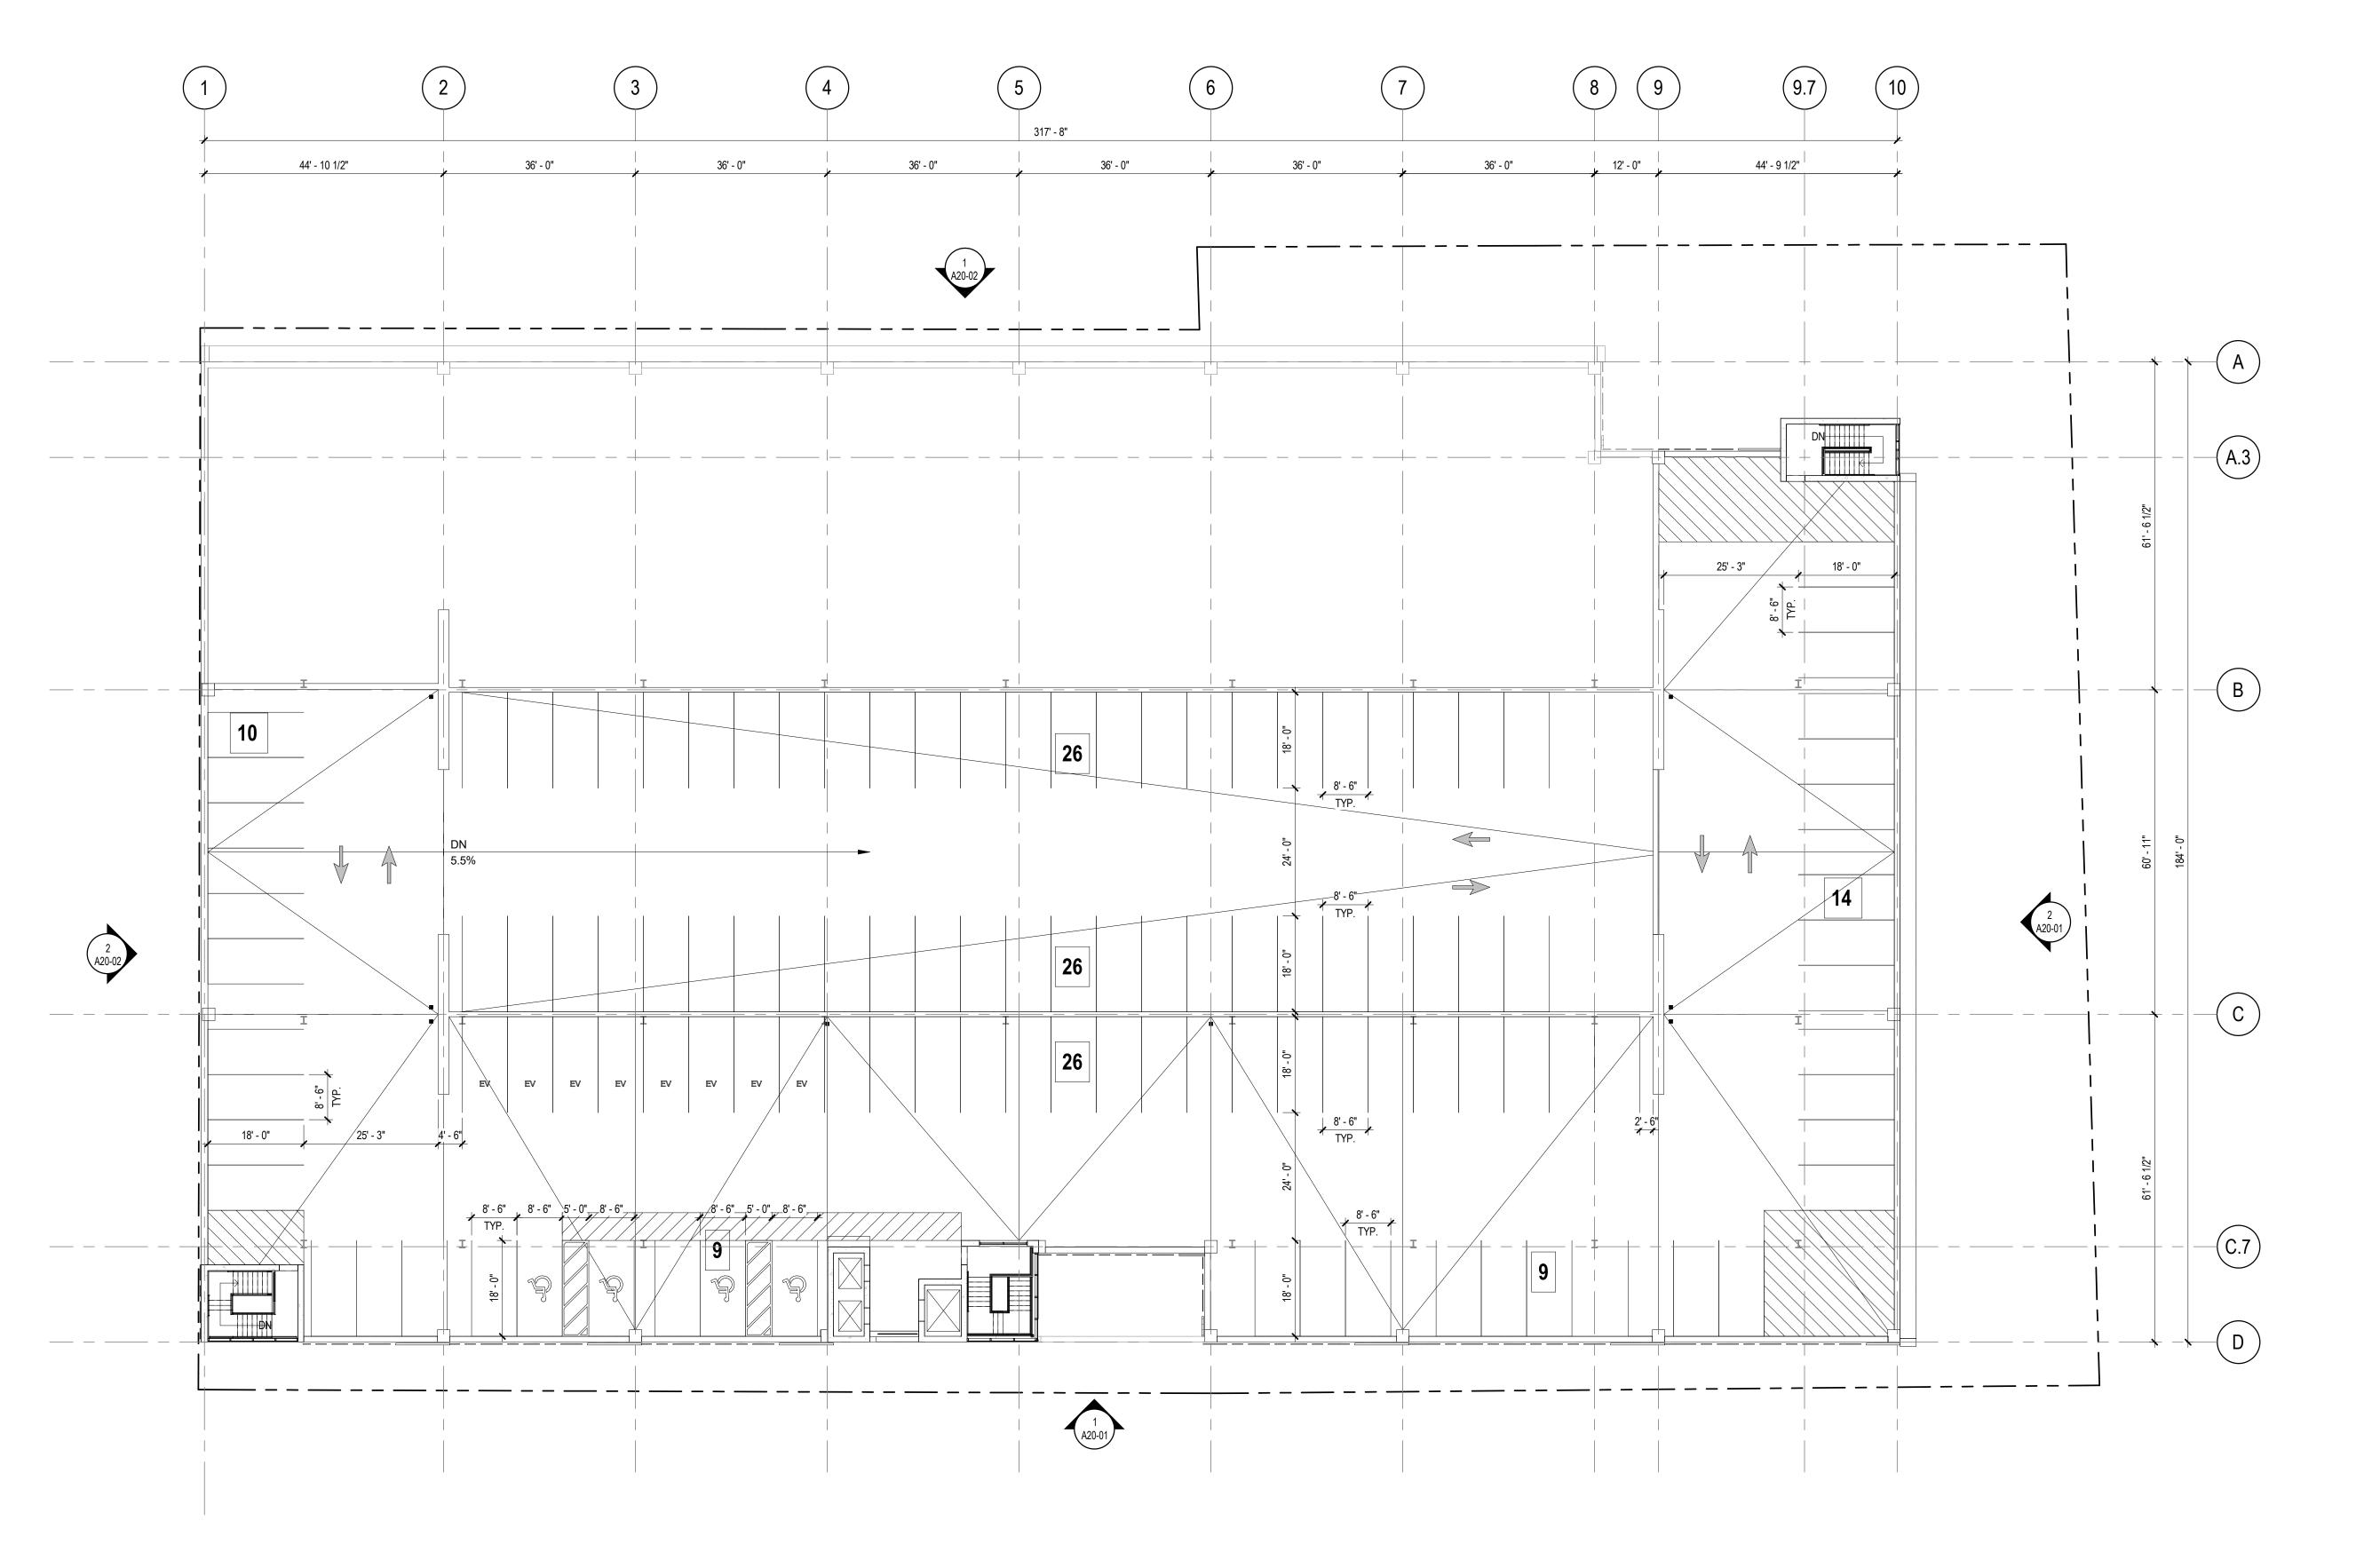


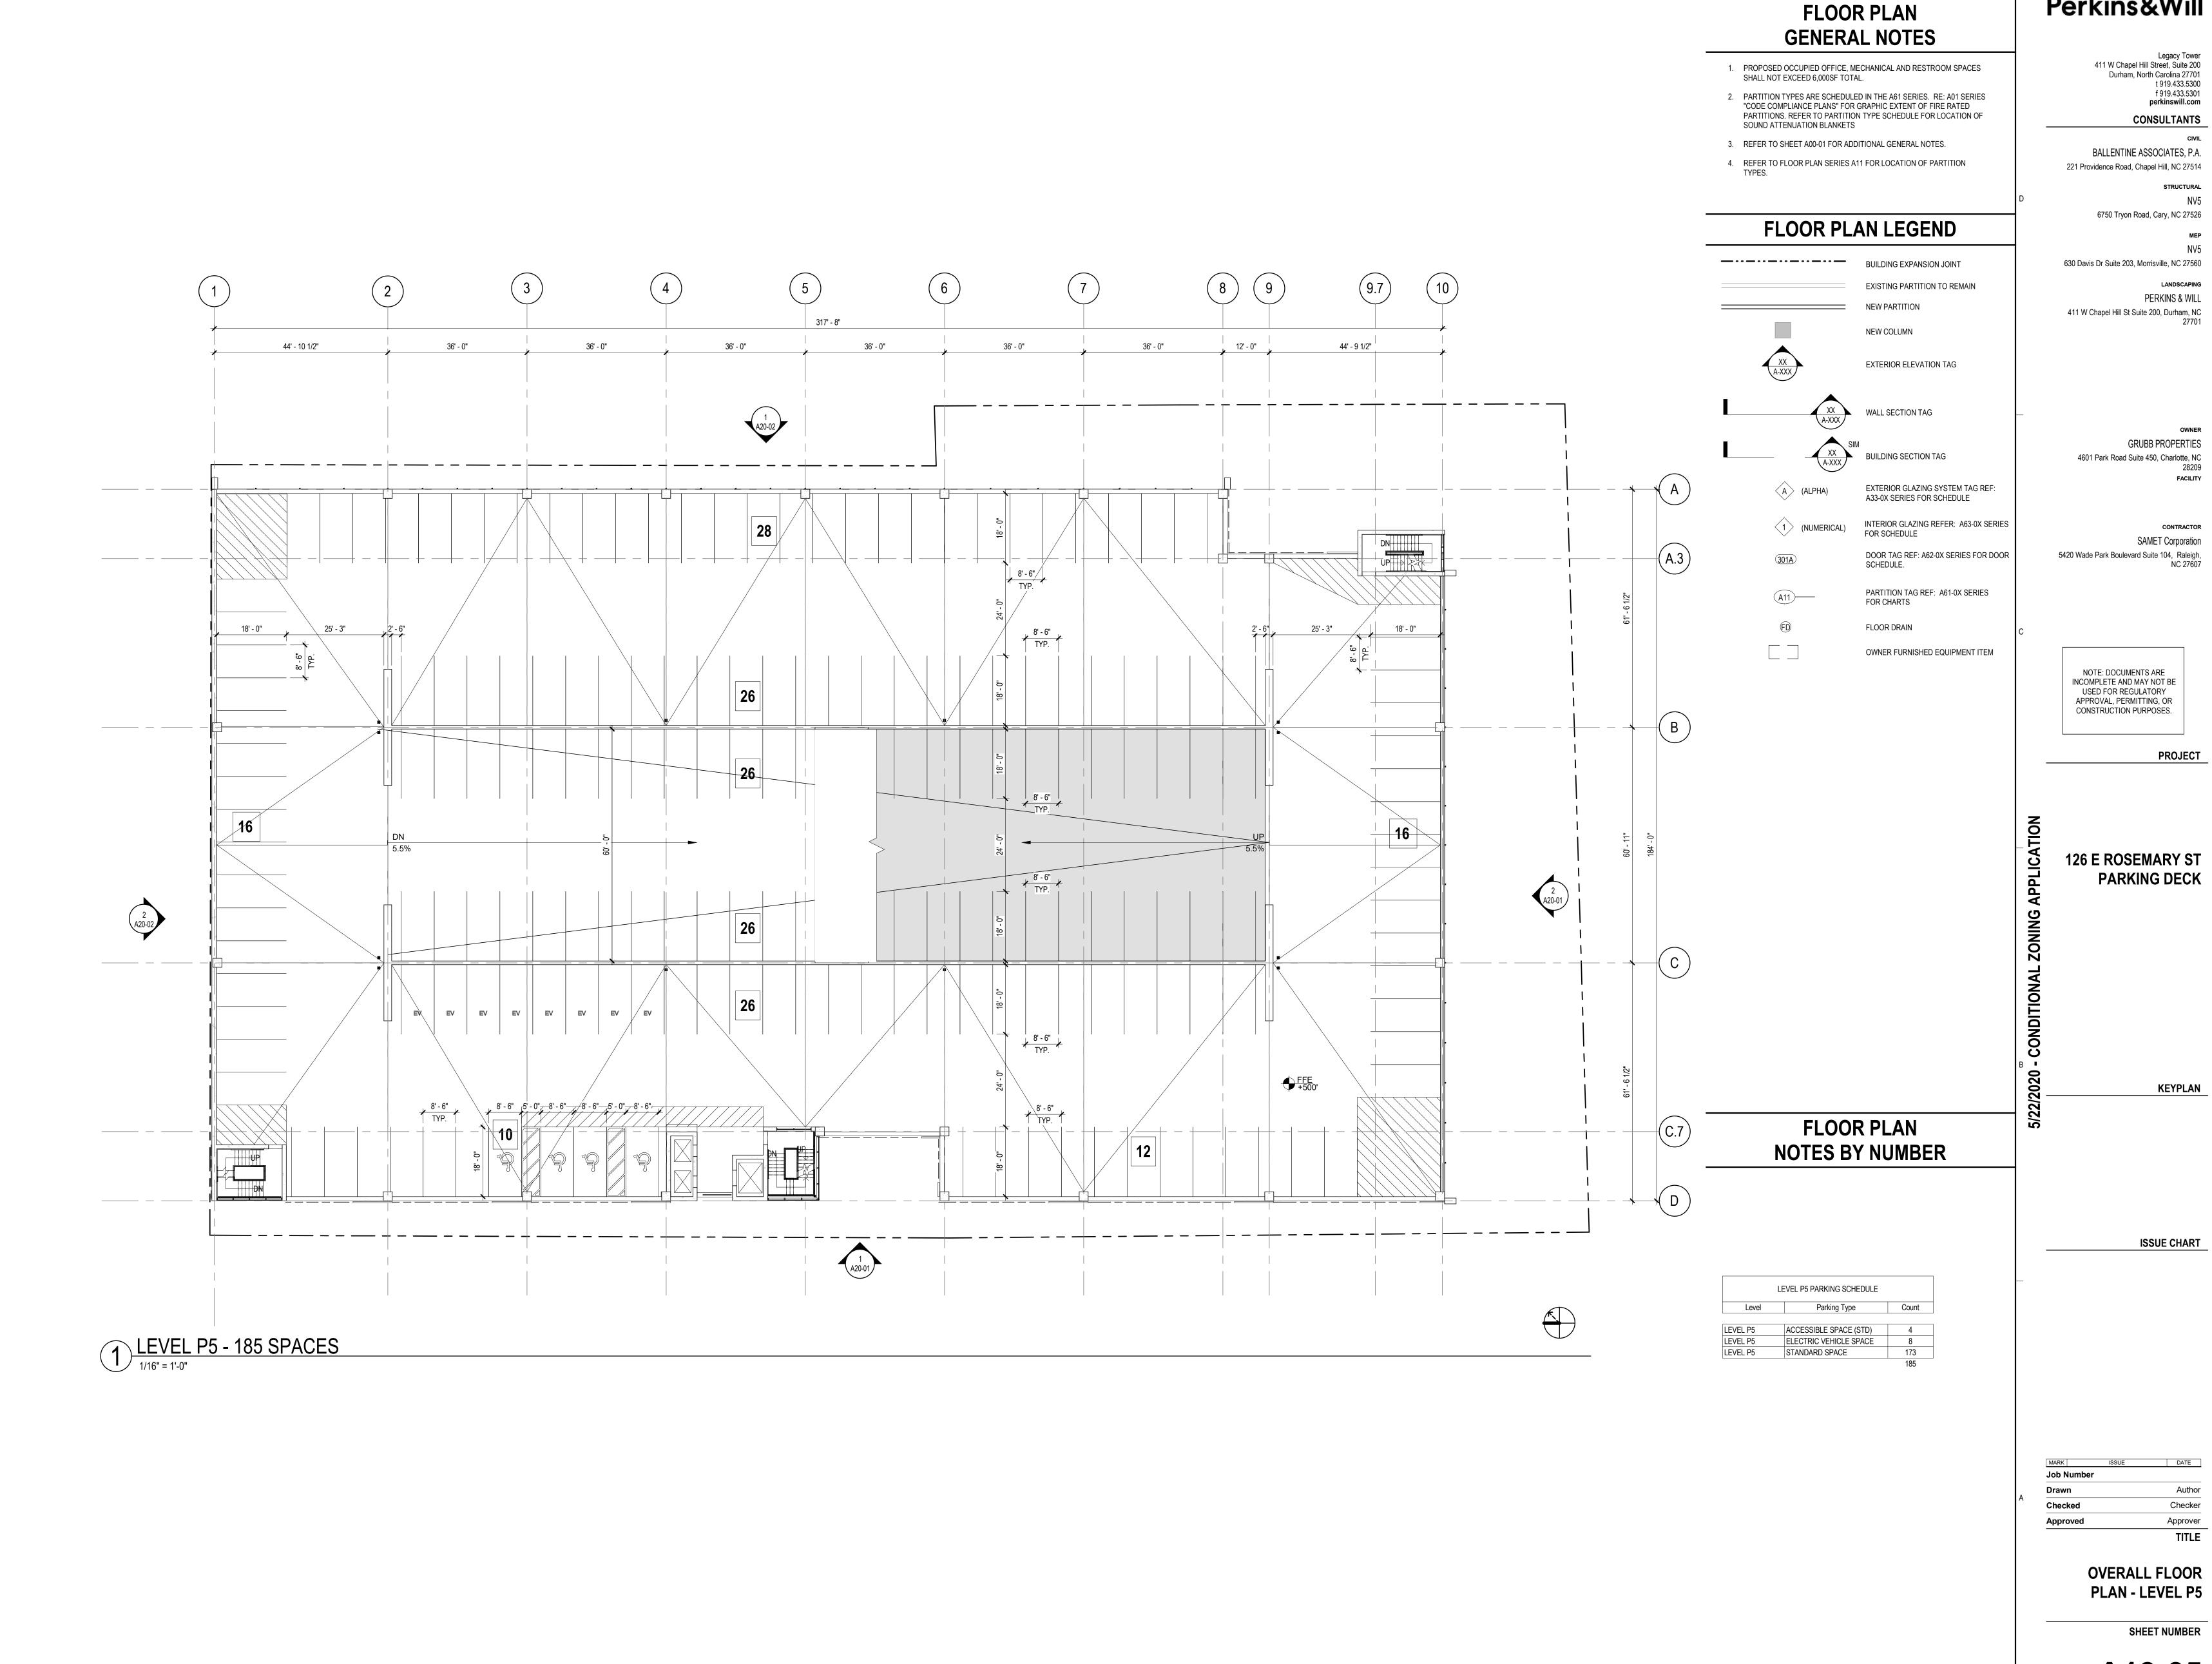A10-05

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**FLOOR PLAN GENERAL NOTES** 

1. PROPOSED OCCUPIED OFFICE, MECHANICAL AND RESTROOM SPACES SHALL NOT EXCEED 6,000SF TOTAL.

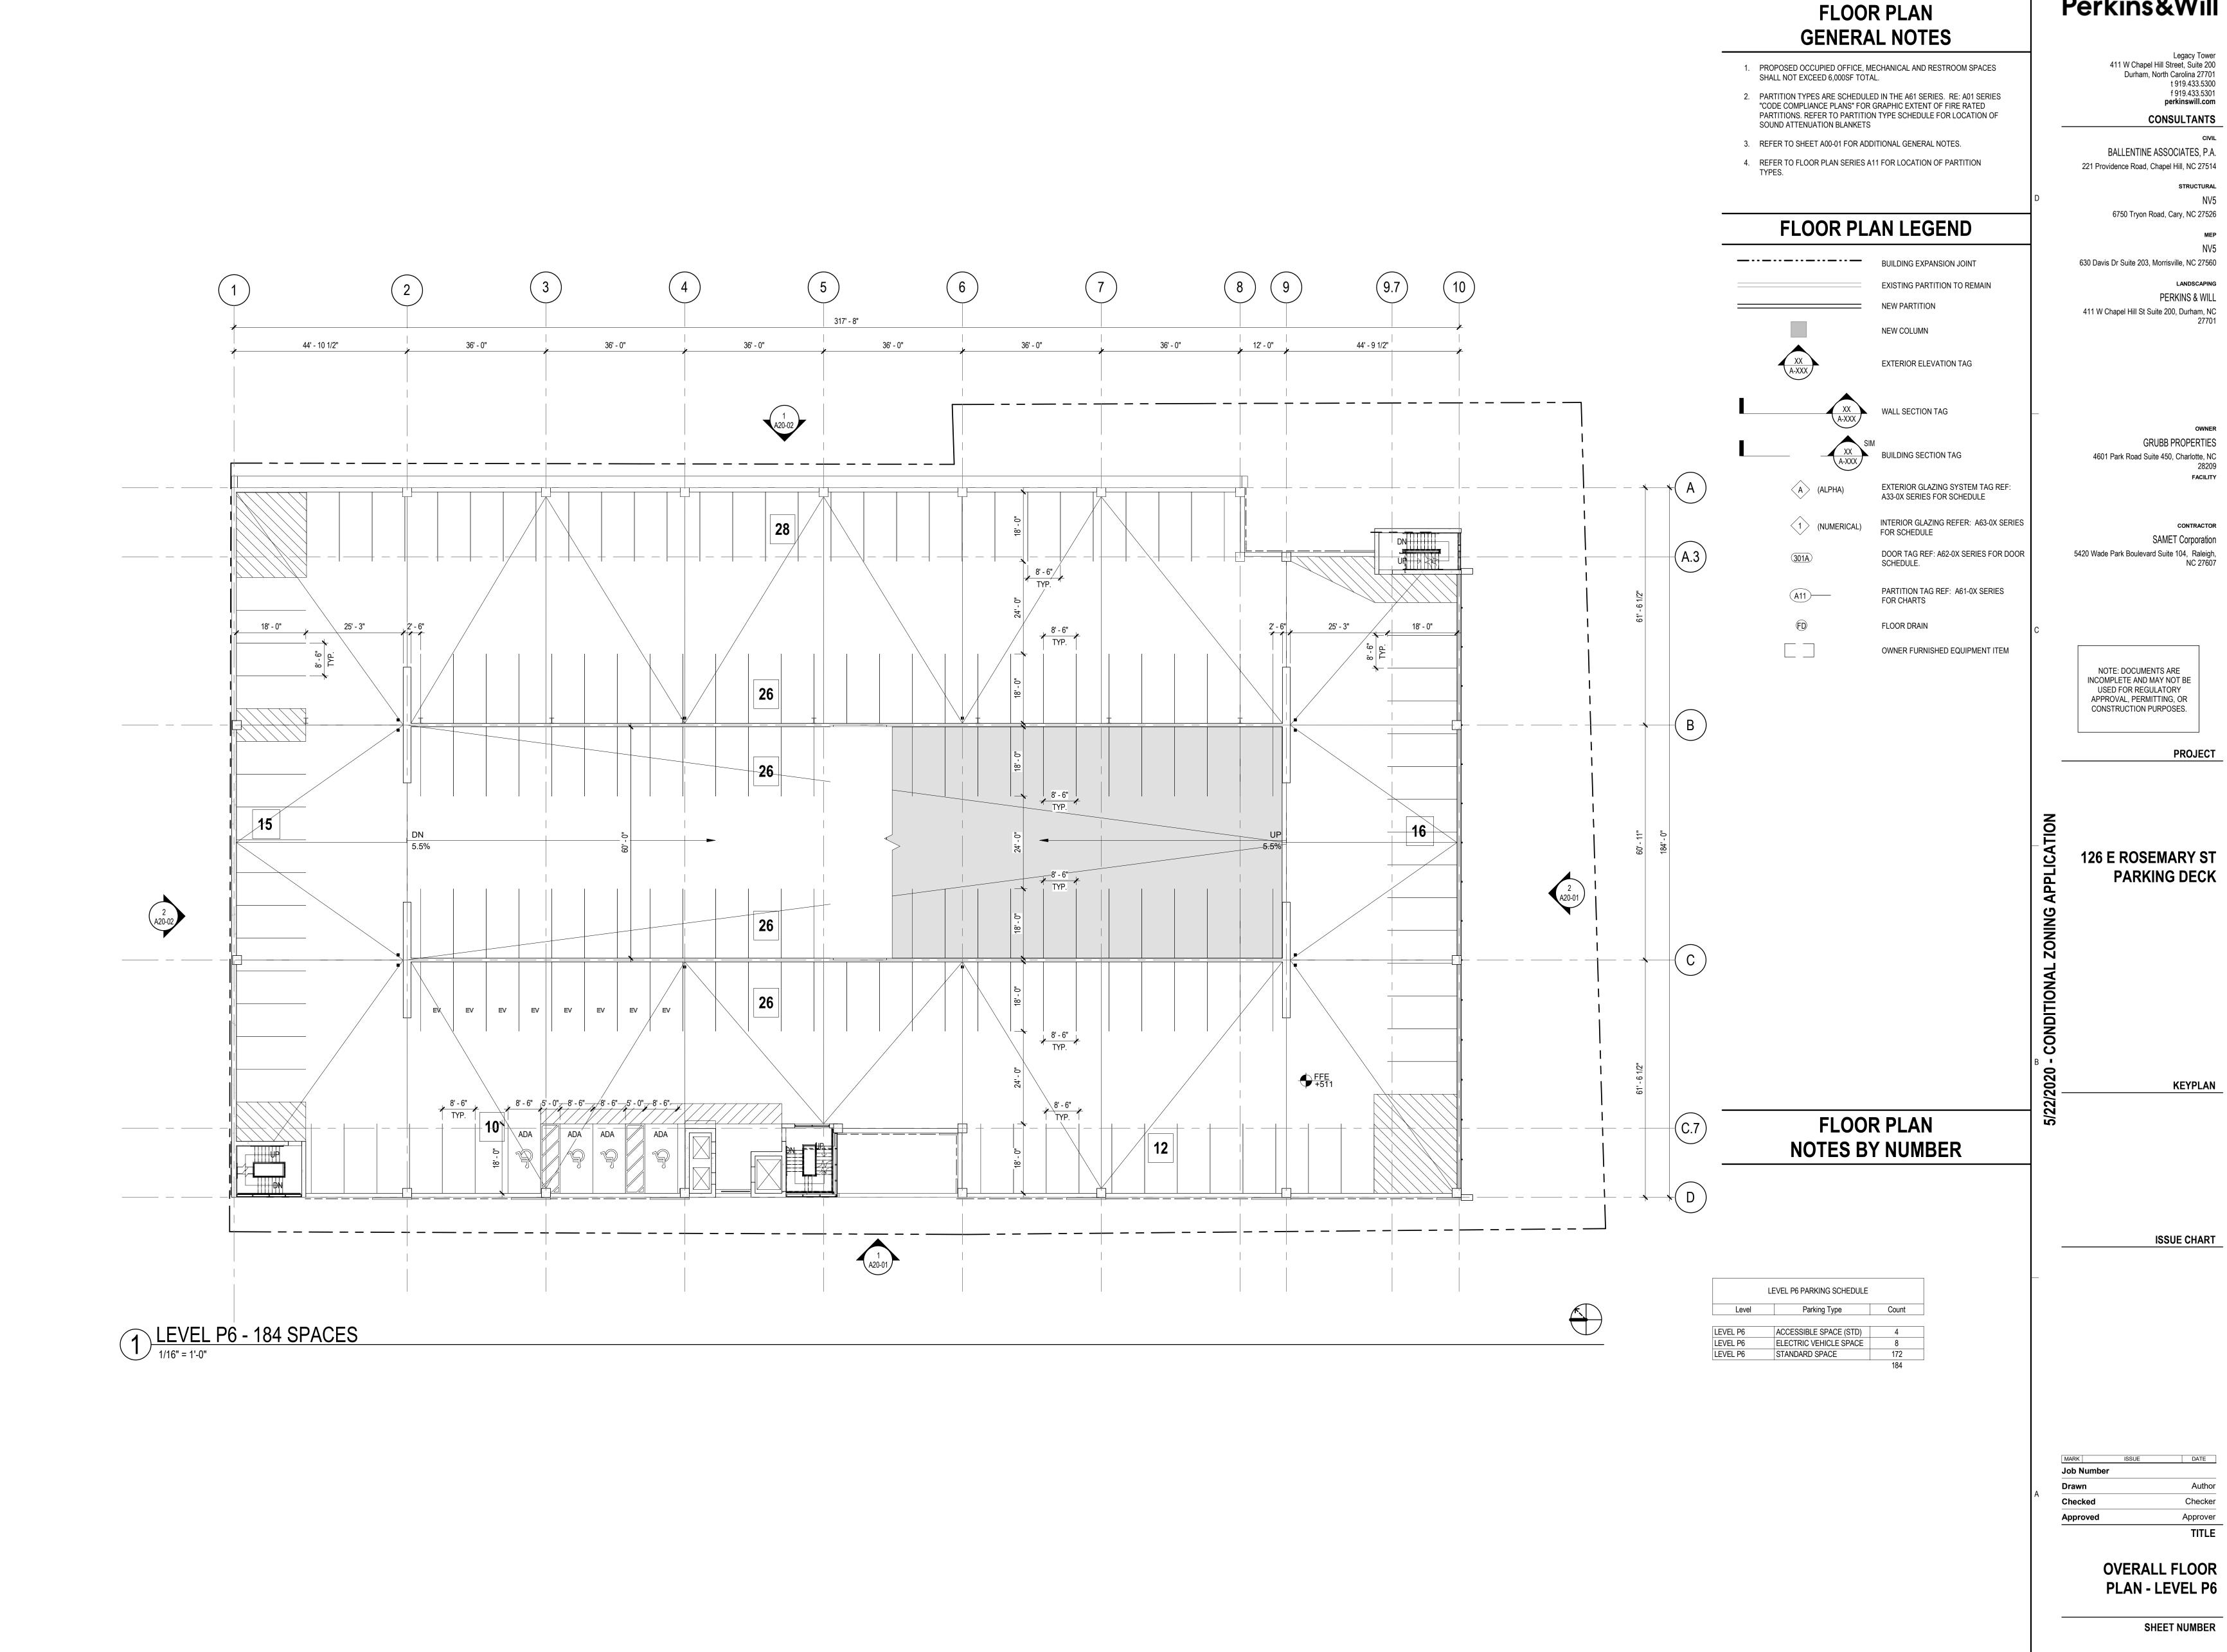2. PARTITION TYPES ARE SCHEDULED IN THE A61 SERIES. RE: A01 SERIES "CODE COMPLIANCE PLANS" FOR GRAPHIC EXTENT OF FIRE RATED PARTITIONS. REFER TO PARTITION TYPE SCHEDULE FOR LOCATION OF SOUND ATTENUATION BLANKETS

3. REFER TO SHEET A00-01 FOR ADDITIONAL GENERAL NOTES.

4. REFER TO FLOOR PLAN SERIES A11 FOR LOCATION OF PARTITION

## FLOOR PLAN LEGEND

BUILDING EXPANSION JOINT EXISTING PARTITION TO REMAIN NEW PARTITION **NEW COLUMN** EXTERIOR ELEVATION TAG

WALL SECTION TAG **BUILDING SECTION TAG** 

(NUMERICAL) (301A)

INTERIOR GLAZING REFER: A63-0X SERIES FOR SCHEDULE DOOR TAG REF: A62-0X SERIES FOR DOOR SCHEDULE.

EXTERIOR GLAZING SYSTEM TAG REF: A33-0X SERIES FOR SCHEDULE

PARTITION TAG REF: A61-0X SERIES FOR CHARTS

FLOOR DRAIN OWNER FURNISHED EQUIPMENT ITEM

NOTE: DOCUMENTS ARE INCOMPLETE AND MAY NOT BE USED FOR REGULATORY
APPROVAL, PERMITTING, OR
CONSTRUCTION PURPOSES.

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STRUCTURAL

LANDSCAPING

PERKINS & WILL

**GRUBB PROPERTIES** 

FACILITY

CONTRACTOR

SAMET Corporation

4601 Park Road Suite 450, Charlotte, NC

5420 Wade Park Boulevard Suite 104, Raleigh,

CONSULTANTS

PROJECT

126 E ROSEMARY ST **PARKING DECK** 

**KEYPLAN** 

**ISSUE CHART** 

**FLOOR PLAN** 

**NOTES BY NUMBER** 

LEVEL P7 PARKING SCHEDULE LEVEL P7 ACCESSIBLE SPACE (STD)
LEVEL P7 ELECTRIC VEHICLE SPACE
LEVEL P7 STANDARD SPACE

Author Checker Approver TITLE


> **OVERALL FLOOR** PLAN - LEVEL P7

> > SHEET NUMBER

A10-07

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1 LEVEL P7 - 120 SPACES

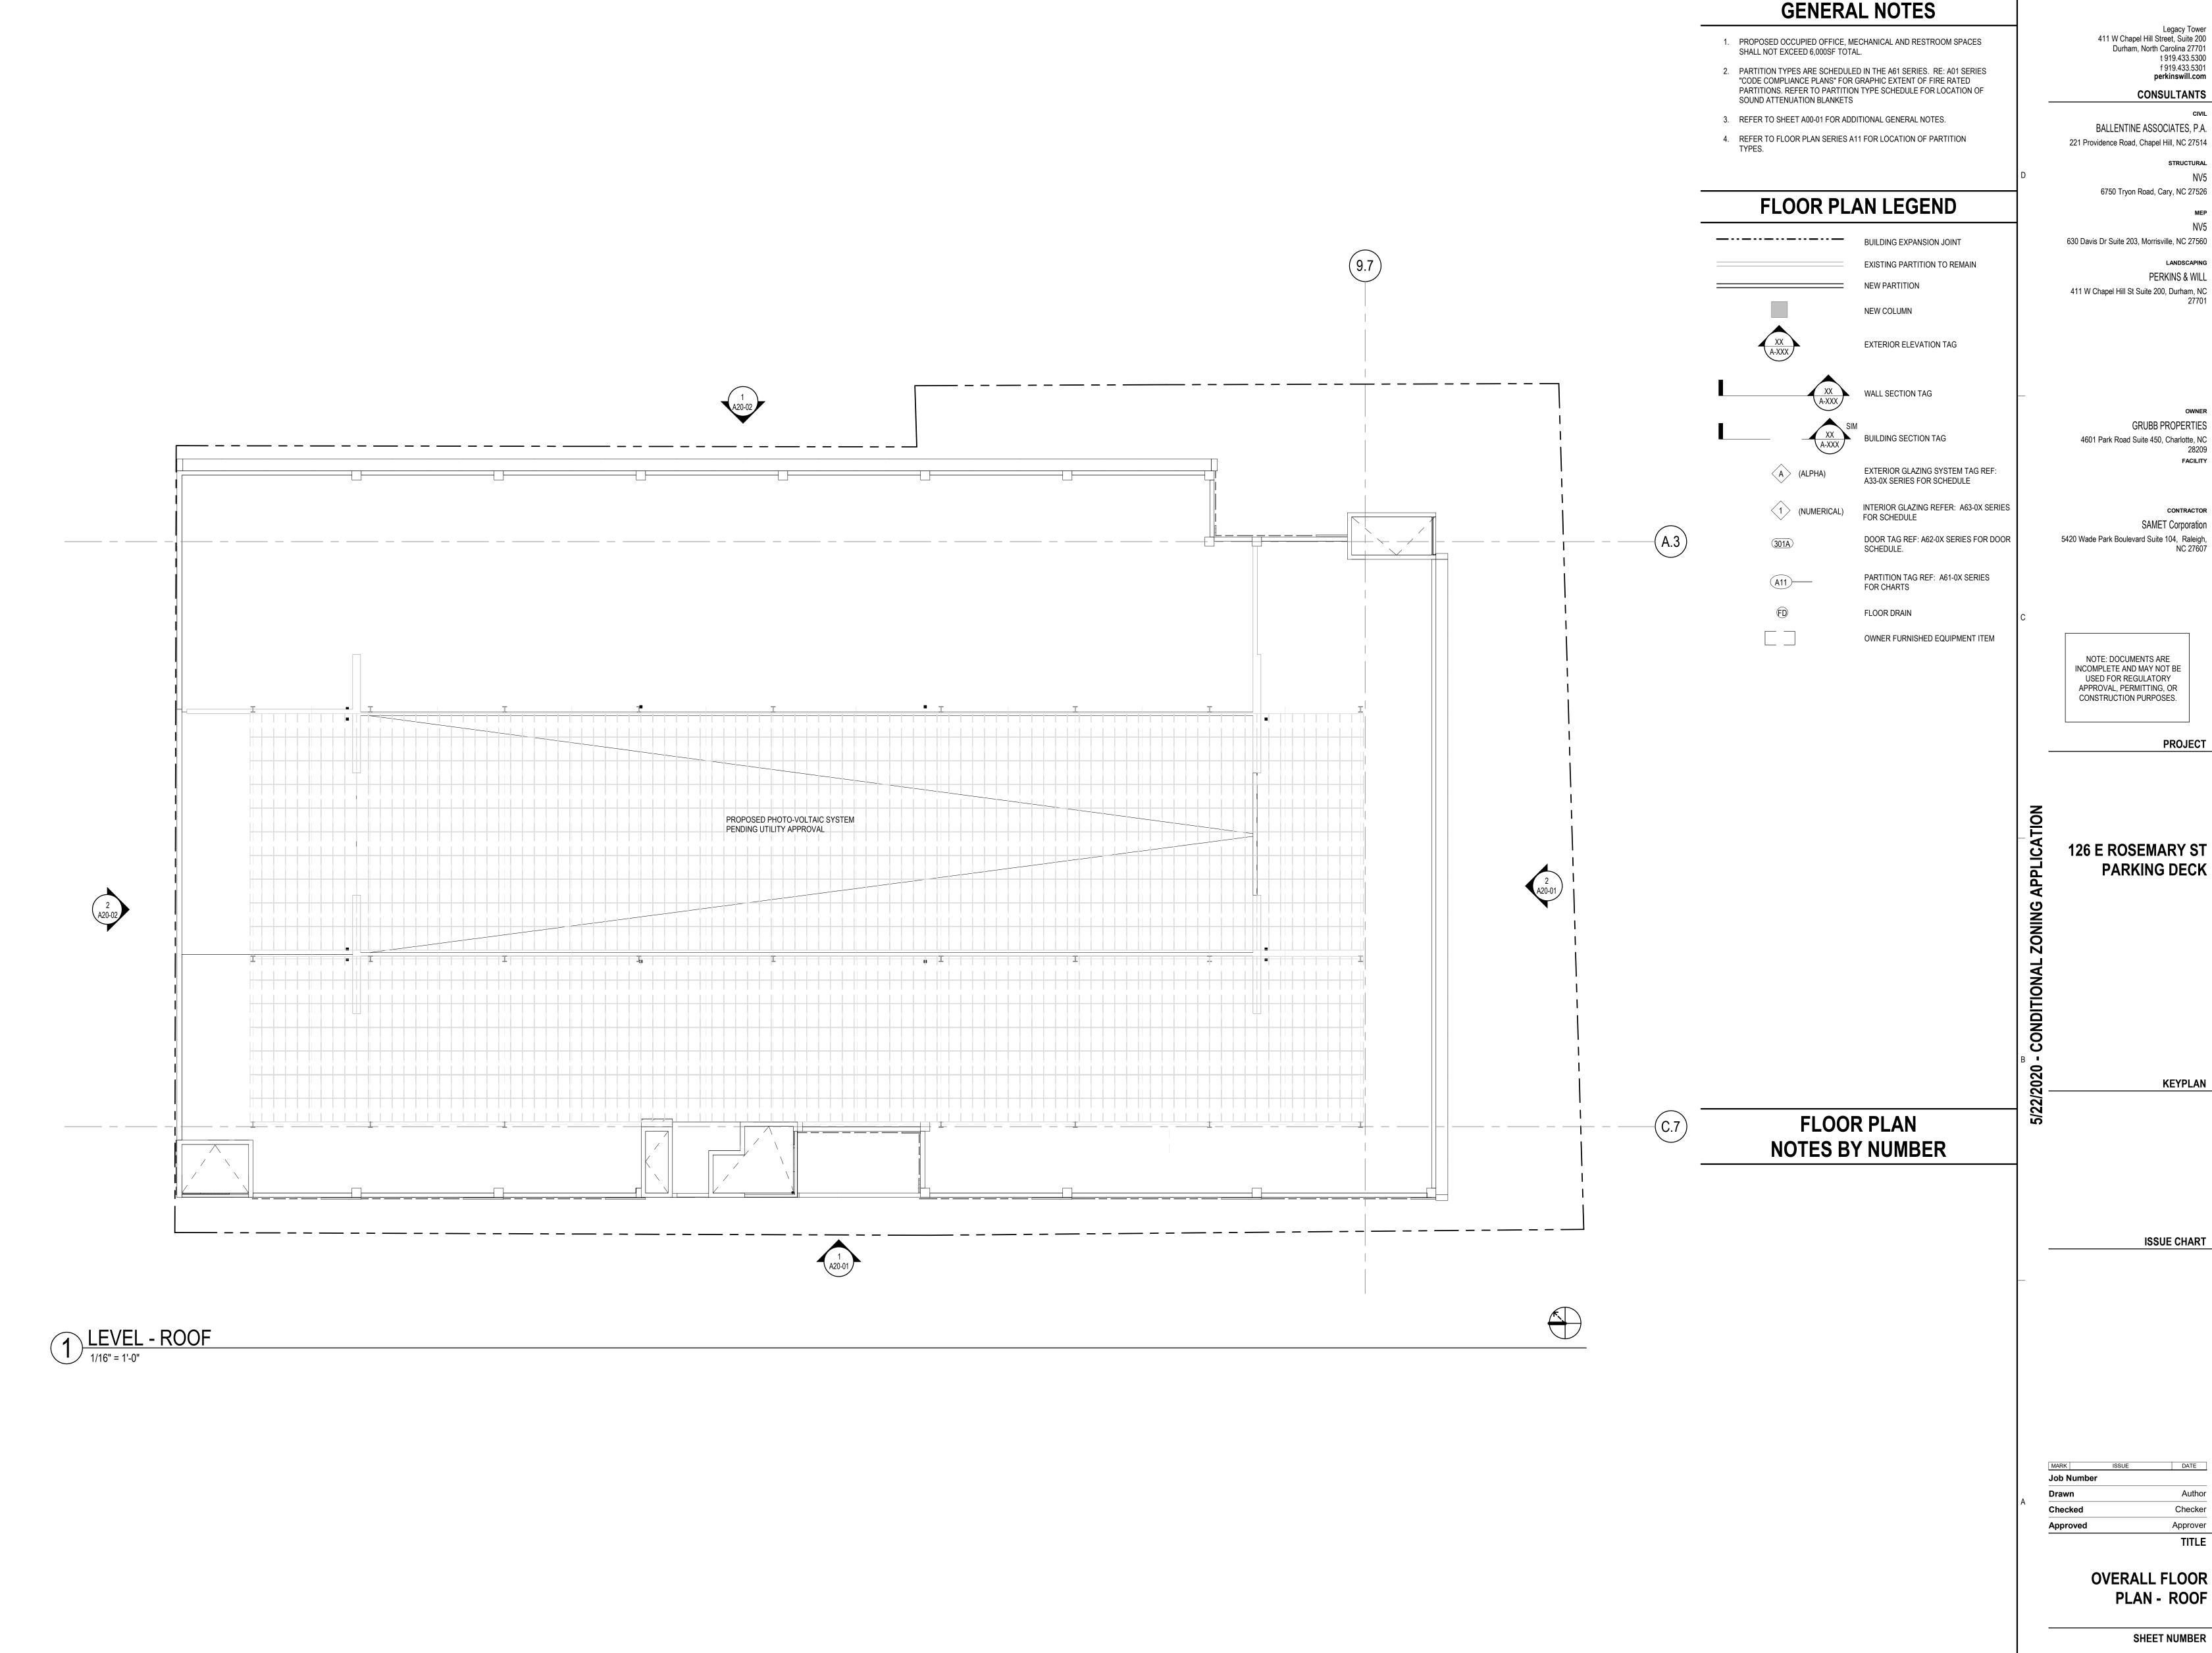

Perkins&Will **FLOOR PLAN** 

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> GRUBB PROPERTIES 28209

CONTRACTOR SAMET Corporation

**PROJECT** 

**PARKING DECK** 

Author Checker Approver

PLAN - ROOF

A10-08 FOR REFERENCE ONLY

