

2510 Meridian Parkway, Suite 100 Durham, NC 27713 | 919-682-0368 www.thomasandhutton.com

February 13, 2025

Town of Chapel Hill Planning Department 405 Martin Luther King Jr. Blvd Chapel Hill, NC 27514

### **RE: Conditional Zoning Application for 701 MLK**

701 Martin Luther King Jr Blvd on the northwest corner at E Longview Street

On behalf of the land developer LCD Acquisitions, LLC, enclosed is a conditional zoning application for the 701 Martin Luther King Jr Blvd project.

The proposed 701 Martin Luther King Jr Blvd Residential project aims to deliver 175 - 200 new residential units at the intersection of E Longview Street and Martin Luther King Jr Blvd. The proposed development will help address the Town's need for housing as noted in Chapel Hill's Projected Housing Needs for 2020-2040, as the report calls for Chapel Hill to increase average annual household production by 35% over that of the 2010s, which will require completing about 485 units per year.

This development will feature up to six stories of residential units built over three levels of structured parking, of which one level is entirely below grade. The project will include a spacious interior courtyard equipped with recreational amenities for residents, alongside a public plaza at the corner of E Longview and Martin Luther King Jr Blvd. This plaza is intended to be a community asset that will complement the planned Bus Rapid Transit stop and feature ground level retail to help activate the public outdoor amenity area.

Spanning just under two acres, the project site currently houses a vacated automotive repair facility and two dilapidated residential structures, all of which will be redeveloped. The concept plan, reviewed by the Council in November 2024, garnered support for its proposed density, public plaza, and residential use. Feedback from the review included requests for upper floor step backs, retail/coffee service space to activate the plaza, and a reduction in on-site parking, all of which have been incorporated into the design development. The project's affordable housing component will align with Chapel Hill's goal of fostering a more inclusive community by offering accessible housing options for a diverse population. The development of this affordable housing offering is progressing but will involve on-site affordable housing units.

This project will offer a varying unit mix that will attract a diversity of tenants. The location of this development will encourage use of alternative transportation modes and will support the existing and proposed public transit in town. The project adds to the overall variety of uses in the neighborhood, thereby adding to the complete community elements.

The applicant is seeking MU-V-CZD zoning, as advised by Planning staff, with a modification request to significantly reduce the non-residential component. This zoning choice is justified by the project's location along an arterial street near downtown Chapel Hill, with the predominantly residential use serving as a buffer between the busy Martin Luther King Jr Blvd and the interior residential neighborhoods.

Lastly, the proposed project is being designed to comply with the Chapel Hill Comprehensive Plan. The proposed multi-family use is consistent with the primary uses encouraged by the Town of Chapel Hill in the subject's South MLK Focus Area, Sub-Area C per the Future Land Use Map and the Town's land use initiative.

Sincerely,

Wendi Ramsden

Wash Jame

Project Manager

## Conditional Zoning Application - Developer's Program

## **Project Location and Layout**

This project is situated on the northwest corner of Martin Luther King Jr Blvd and E Longview Street, just north of the Town Hall. Covering just under two acres, the development will primarily consist of multi-family residential units with a small retail space on the ground floor. The intended design includes an interior courtyard featuring a pool and various amenities, as well as a fitness center for tenant use. Additionally, there will be a public plaza that serves both residents and the general public.

The project comprises 175 - 200 apartment rental units within a single, eight-story building and an additional parking level entirely underground. Approximately 250 parking spaces will be provided within the urban-style structure. The main pedestrian lobby will be located at the corner of E Longview and Martin Luther King, Jr. Blvd., directly accessible from the community plaza. The building's design leverages the 30-foot elevation difference across the site to conceal the lowest three levels (parking), thereby minimizing the building's visual impact on the neighboring properties to the west.

The layout emphasizes multi-modal transportation, reducing the need for on-site parking while ensuring excellent pedestrian connections to the adjacent sidewalk network and bus stops. The project is conveniently located within 100 feet of a bus stop on the proposed NS BRT route.

## **Transportation and Services**

The site fronts two rights of way: E Longview Street and Martin Luther King Jr Blvd. A bus stop located just south of E Longview is served by four Chapel Hill Transit routes. All tenant vehicular access to the garage will be from E Longview Street, while the service area on the north side of the building will be accessed via the emergency drive off Martin Luther King Jr Blvd. There will not be any vehicular connectivity between tenant parking and the service drive.

Fire and emergency access to the building will be available from Martin Luther King Jr Blvd, with the fire lane accessed from that frontage. Trash service will be managed internally at the ground level on the north side of the building, accessible from the emergency lane. This service will include recycling collection facilities. The project plans to use a private hauler for trash removal and County Solid Waste for recycling pickup.

## Streams and Impervious Surface Mitigation

There are no jurisdictional streams on site. Currently, 16% of the site is impervious and lacks stormwater treatment. The project will introduce a new underground mitigation facility designed to control peak flow during a 100-year storm event and improve water quality through treatment.

## Tree Coverage and Landscape Buffers

The developer will request a reduction in the minimum tree coverage requirements and landscape buffers along the E Longview Street and Martin Luther King Jr Blvd frontages. However, the buffers between the project and the adjacent residential neighborhood will be fully planted to comply with ordinance requirements.

# CONDITIONAL ZONING OF 701 MLK

701 MARTIN LUTHER KING JR BOULEVARD
CHAPEL HILL, NC 27516

PREPARED FOR:
LCD ACQUISITIONS, LLC
3060 PEACHTREE ROAD NW
SUITE 500
ATLANTA, GA 30305

PIN# 9789-30-2139


MAY 30, 2025


J-32417.0000





PREPARED BY:

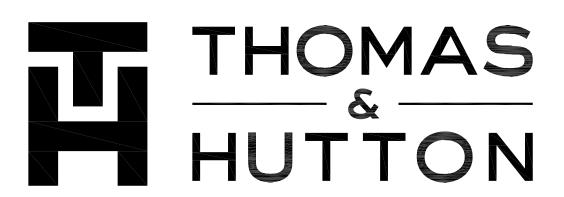

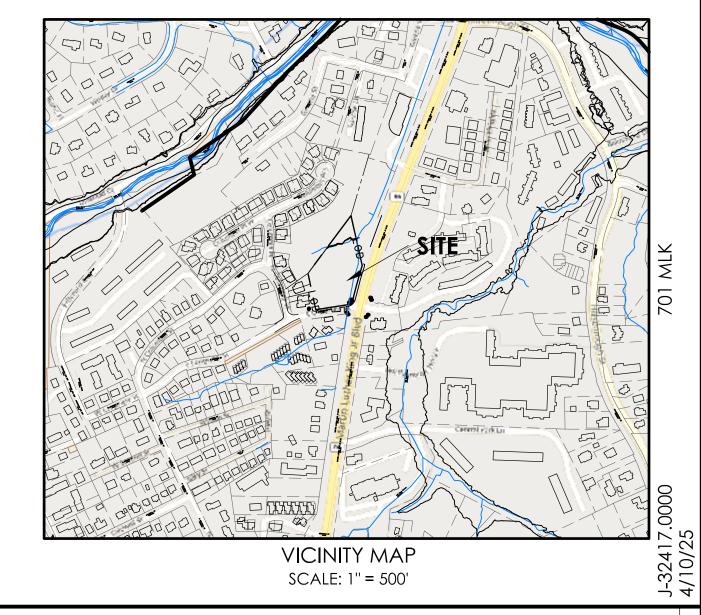

| Sheet List Table                      |              |
|---------------------------------------|--------------|
| Sheet Title                           | Sheet Number |
| COVER SHEET                           | C0.0         |
| GENERAL NOTES AND INDEX               | C0.1         |
| AREA MAP                              | A1.1         |
| EXISTING CONDITIONS & DEMOLITION PLAN | D1.1         |
| SLOPE ANALYSIS AND IMPACTS            | D1.2         |
| SITE PLAN                             | C1.1         |
| FIRE SAFETY PLAN                      | C1.2         |
| FIRE SAFETY EXHIBIT                   | C1.2a        |
| SITE DETAILS                          | C1.3         |
| UTILITY PLAN                          | C2.1         |
| PAVING GRADING AND DRAINAGE PLAN      | C3.1         |
| PLANTING PLAN                         | L1.1         |
| PLANTING DETAILS                      | L1.2         |
| LANDSCAPE PROTECTION PLAN             | L1.3         |

|          | REVISION HISTORY                |    |         |
|----------|---------------------------------|----|---------|
|          |                                 |    |         |
|          |                                 |    |         |
|          |                                 |    |         |
|          |                                 |    |         |
|          |                                 |    |         |
|          |                                 |    |         |
|          |                                 |    |         |
| 1        | COMMENT REVISIONS - RESUBMITTAL |    | 5-30-25 |
| REV. NO. | REVISION                        | ВҮ | DATE    |

|                      | SUBMITTAL HISTORY |           |
|----------------------|-------------------|-----------|
|                      |                   |           |
|                      |                   |           |
|                      |                   |           |
|                      |                   |           |
|                      |                   |           |
|                      |                   |           |
|                      |                   |           |
| CZ RESUBMITTAL       |                   | 5.30.2025 |
| CZ RESUBMITTAL       |                   | 4.10.2025 |
| CZ INITIAL SUBMITTAL |                   | 2.13.2025 |
|                      | SUBMITTED TO      | DATE      |





DRAINAGE LEGEND

| <u>ABBREVIATIONS</u> |                         |      |                             |      |                          |     |                  |
|----------------------|-------------------------|------|-----------------------------|------|--------------------------|-----|------------------|
| DBL                  | DOUBLE                  | FM   | FORCE MAIN (SANITARY SEWER) | ОС   | ON CENTER                | SS  | SANITARY SEWER   |
| ВОТ                  | BOTTOM                  | FP   | FINISH PAD                  | PC   | POINT OF CURVE           | TC  | TOP OF CURB      |
| СВ                   | CATCH BASIN             | FPW  | FIRE PROTECTION             | PH   | POST HYDRANT             | TH  | THROAT ELEVATION |
| CI                   | CURB INLET              | FR   | FRAME                       | PT   | POINT OF TANGENT         | TG  | TOP OF GUTTER    |
| СО                   | CLEAN OUT               | GI   | GRATE INLET                 | PVC  | POLYVINYL CHLORIDE       | TP  | TOP OF PAVEMENT  |
| CPP                  | CORRUGATED PLASTIC PIPE | GV   | GATE VALVE                  | RCP  | REINFORCED CONCRETE PIPE | TW  | TOP OF WALK      |
| DBL                  | DOUBLE                  | HDPE | HIGH DENSITY POLYETHYLENE   | RC   | ROLL CURB INLET          | TYP | TYPICAL          |
| DI                   | DITCH INLET             | HI   | HOODED INLET                | RCP  | REINFORCED CONCRETE PIPE | VI  | VALLEY INLET     |
| DIP                  | DUCTILE IRON PIPE       | INV  | INVERT ELEVATION            | RI   | ROOF INLET               | W   | WATER            |
| EL                   | ELEVATION               | JB   | JUNCTION BOX                | RJP  | RESTRAINED JOINT PIPE    | W/  | WITH             |
| ES                   | END SECTION             | LF   | LINEAR FEET                 | R/W  | RIGHT-OF-WAY             | WV  | WATER VALVE      |
| FES                  | FLARED END SECTION      | MAX  | MAXIMUM                     | SD   | STORM DRAINAGE           | YI  | YARD INLET       |
| FG                   | FINISH GRADE            | MIN  | MINIMUM                     | SDMH | STORM DRAINAGE MANHOLE   |     |                  |
| FH                   | FIRE HYDRANT            | MH   | MANHOLE                     | SF   | SQUARE FEET              |     |                  |

WATER LEGEND

**EXISTING** 

— 10"FPW —

— 10''W —

**>----**

 $\otimes$  $\square$  $\otimes$ 

PROTECTION

WATER MAIN

SINGLE SERVICE

DOUBLE SERVICE

LATERAL

BUTTERFLY

VALVE (BV)

DOUBLE CHECK

DETECTOR

GATE VALVE

INDICATOR

VALVE (PIV)

SLEEVE AND

VALVE (TSV)

REDUCED

BACKFLOW

PRESSURE ZONE

AND BOX (GV)

ASSEMBLY

(DCDA)

— 10"FPW—

— 10"W—

-----

| SEWER LEGEND                        |                 |                 |  |
|-------------------------------------|-----------------|-----------------|--|
|                                     | <u>EXISTING</u> | <u>PROPOSED</u> |  |
| GRAVITY PIPE                        | —— ss ——        |                 |  |
| SINGLE SERVICE<br>LATERAL           |                 |                 |  |
| DOUBLE<br>SERVICE<br>LATERAL        | <u> </u>        | <b>—</b>        |  |
| DROP<br>MANHOLE<br>(DMH)            |                 | •               |  |
| MANHOLE (MH)                        |                 | •               |  |
| CLEANOUT<br>(CO)                    | O <sub>4</sub>  | <b>•</b> +      |  |
| FORCEMAIN                           | —— 10"FM ——     | —— 10"FM ——     |  |
| AIR RELEASE<br>VALVE (ARV)          |                 | <b>(</b>        |  |
| CHECK VALVE<br>(CV)                 |                 | 0               |  |
| PLUG VALVE<br>AND BOX (PV)          |                 | •               |  |
| FLUSH HYDRANT                       | X               | <b>)</b>        |  |
| PUMP<br>CONNECTION<br>(PC)          | ○ <sub>1</sub>  | •               |  |
| REDUCER                             |                 | •               |  |
| TRACER WIRE<br>ACCESS BOX<br>(TWAB) |                 |                 |  |
| CROSS                               | 1_1             | _<br>  _        |  |
| TEE                                 |                 |                 |  |
| TAPPING<br>SLEEVE (TS)              |                 | -               |  |
| 90° BEND<br>HORIZONTAL              |                 | -,              |  |
| 45° BEND<br>HORIZONTAL              | /               | /               |  |
| 22-½° BEND<br>HORIZONTAL            | /               | /               |  |
| 11-¼° BEND<br>HORIZONTAL            | 1               | 1               |  |
| BEND<br>VERTICAL                    |                 | 11              |  |
| PLUG \ CAP                          |                 |                 |  |

|                                             | EVICTIVIO                                                                                                               | DDODOGE        |
|---------------------------------------------|-------------------------------------------------------------------------------------------------------------------------|----------------|
|                                             | <u>EXISTING</u>                                                                                                         | <u>PROPOSE</u> |
| WATER METER<br>(WM)                         | $\boxtimes$                                                                                                             | $\boxtimes$    |
| TRACER WIRE<br>ACCESS BOX<br>(TWAB)         |                                                                                                                         |                |
| FIRE HYDRANT<br>W/TEE, VALVE &<br>BOX (FHA) | $- \hspace{-0.1cm} \begin{array}{c} \hspace{-0.1cm} + \hspace{-0.1cm} \\ \hspace{-0.1cm} - \hspace{-0.1cm} \end{array}$ |                |
| POST HYDRANT<br>(PH)                        | Ā                                                                                                                       |                |
| REDUCER                                     | D                                                                                                                       | •              |
| CROSS                                       | 1_1                                                                                                                     | 1_1            |
| TEE                                         | <u>-</u>                                                                                                                | -              |
| 90° BEND -<br>HORIZONTAL                    | _                                                                                                                       |                |
| 45° BEND -<br>HORIZONTAL                    | /                                                                                                                       | /              |
| 22-½° BEND -<br>HORIZONTAL                  | / I                                                                                                                     | / 1            |
| 11-¼° BEND -<br>HORIZONTAL                  | 1-1                                                                                                                     | 1 1            |
| BEND -<br>VERTICAL                          | 1.1                                                                                                                     | 11             |
| CAP                                         |                                                                                                                         |                |

| OTHER UTILITIES LEGEND  |                 |  |  |
|-------------------------|-----------------|--|--|
|                         |                 |  |  |
|                         | <u>EXISTING</u> |  |  |
| NATURAL GAS             | UGG             |  |  |
| TELEPHONE               | —— ОНТ ——       |  |  |
| UNDERGROUND TELEPHONE   | UTL             |  |  |
| ELECTRICITY             | —— OHP ——       |  |  |
| UNDERGROUND ELECTRICITY | —— UGP ——       |  |  |

|                                             | TER LEG         |                 |
|---------------------------------------------|-----------------|-----------------|
|                                             | <u>EXISTING</u> | <u>PROPOSED</u> |
| WATER METER<br>(WM)                         | $\boxtimes$     | $\boxtimes$     |
| TRACER WIRE<br>ACCESS BOX<br>(TWAB)         |                 |                 |
| FIRE HYDRANT<br>W/TEE, VALVE &<br>BOX (FHA) | F&              |                 |
| POST HYDRANT<br>(PH)                        | Ÿ               |                 |
| REDUCER                                     | Δ               | •               |
| CROSS                                       |                 | I_I             |
| TEE                                         | <u>-</u>        |                 |
| 90° BEND -<br>HORIZONTAL                    | _               | Γ               |
| 45° BEND -<br>HORIZONTAL                    | <b>/</b> I      | \               |
| 22-½° BEND -<br>HORIZONTAL                  | /               | /               |
| 11-¼° BEND -<br>HORIZONTAL                  | 1               | 11              |
| BEND -<br>VERTICAL                          | 11              | 1.1             |
| CAP                                         |                 |                 |

# GENERAL INFORMATION

ORANGE COUNTY COUNTY

TOWN CHAPEL HILL CAPKOV VENTURES INC

MAILING ADDRESS: PO BOX 16815 CHAPEL HILL, NC 27516-6815

ZONING R-3/NC

> LOT 2: JOHNSON FAYE A (LUKRI INVESTMENTS LLC)

1187 MARTIN LUTHER KING JR BLVD UNIT A CHAPEL HILL, NC 27514

# SITE DATA

9789-30-2349/9789-30-2139

OWNER: CAPKOV VENTURES INC (NORTH PARCEL)/

JOHNSON FAYE A (LUKRI INVESTMENTS LLC) (SOUTH PARCEL)

WATERSHED: JORDAN LAKE

RIVER BASIN: CAPE FEAR

FLOOD PLAIN DATA: MAP NO. 12011C0556J (EFFECTIVE DATE 7/31/2024)

TOTAL PARCEL AREA: 83,272 SF / 1.911 AC (NET)

FRONTAGE: 190 LF LONGVIEW, 208 LF MLK

GROSS LAND AREA: 91,599 SF/2.102 AC NET (SURVEYED)

EXISTING ZONING: R-3/NC

PROPOSED ZONING: MU-V-CZD ARTERIAL

EXISTING LAND USE: VACANT CAR REPAIR AND OCCUPIED RESIDENTIAL

PROPOSED LAND USE: MULTI-FAMILY RESIDENTIAL WITH SMALL AMOUNT OF GROUND FLOOR RETAIL SPACE

83,272 SF/1.911 AC

TOTAL LIMITS OF DISTURBANCE: 83,272 SF/ 1.911 AC ON SITE

TREE CONSERVATION SEE SHEET L1.3 AREA:

PROPOSED LAND

DISTURBANCE:

LAND AREA:

83,272 SF / 1.911 AC ON SITE

EXISTING IMPERVIOUS ON-SITE:

15,424 SF /0.35 AC/16.8% GLA

PROPOSED IMPERVIOUS

69,884 SF/1.6 AC/76.3% GLA ON-SITE:

EXISTING BUILDINGS ON SITE: 4,670 SF APPROXIMATELY ALL TO BE REMOVED

THOMAS & HUTTON

DURHAM, NC 27719

919.682.0368

2510 MERIDIAN PARKWAY, SUITE 100

PROPOSED BUILDING SQUARE FOOTAGE: 245,000 SF INCLUDING1,225 SF RETAIL ON THE PLAZA FRONTAGE

**ENGINEER:** 

919.682.0368

**SURVEYOR:** 

THOMAS & HUTTON

DURHAM, NC 27719

2510 MERIDIAN PARKWAY, SUITE 100

STUDIO, 1-BED, 2-BED, 3-BED, 4-BED TOTAL UNIT COUNT 175-200 UNITS

UNIT COUNT IS APPROXIMATE. PARKING REQUIREMENT BASED ON:

STUDIO X 1.00-1.25 SPACES/UNIT 1-BED X 1.00-1.25 SPACES/UNIT 2-BED X 1.4-1.75 SPACES/UNIT 3-BED X 1.75-2.25 SPACES/UNIT 4-BED X 2-2.5 SPACES/UNIT

MINIMUM REQUIRED: APPROX 260 SPACES MAXIMUM ALLOWED: APPROX 360 SPACES

PARKING PROPOSED:

63 STANDARD SPACES + 3 ADA BASEMENT LEVEL: GROUND LEVEL: 100 STANDARD SPACES + 5 ADA SECOND FLOOR: 57 STANDARD SPACES + 4 ADA INCL 2 VAN ACCESSIBLE SPACES

TOTAL PARKING PROPOSED: 232 SPACES

# BICYCLE PARKING

REQUIRED: 175-200 RESIDENTIAL UNITS X .25/UNIT = 44-50PROVIDED:

6 SPACES (3 LOOPS) IN PLAZA AREA 44 INTERIOR BIKE ROOM SPACES TOTAL: 50 BIKE PARKING SPACES

HUTTON

COMMENT REVISIONS - RESUBMITTAL

**REVISIONS** 

5-30-25

BY DATE

2510 Meridian Parkway • Suite 100 Durham, NC 27713 • 919.682.0368 www.thomasandhutton.com

GENERAL NOTES AND INDEX

701 MLK

PROJECT LOCATION: 701 Martin Luther King Jr Boulevard Chapel Hill, NC 27516

CLIENT/OWNER: LCD ACQUISITIONS, LLC 3060 Peachtree Road NW


Suite 500


REVIEWED: APPROVED:

Atlanta, GA 30305


DATUM: HORIZ.: NAD83 VERT.: NAVD88

4/10/25 DRAWN: ACL DESIGNED:

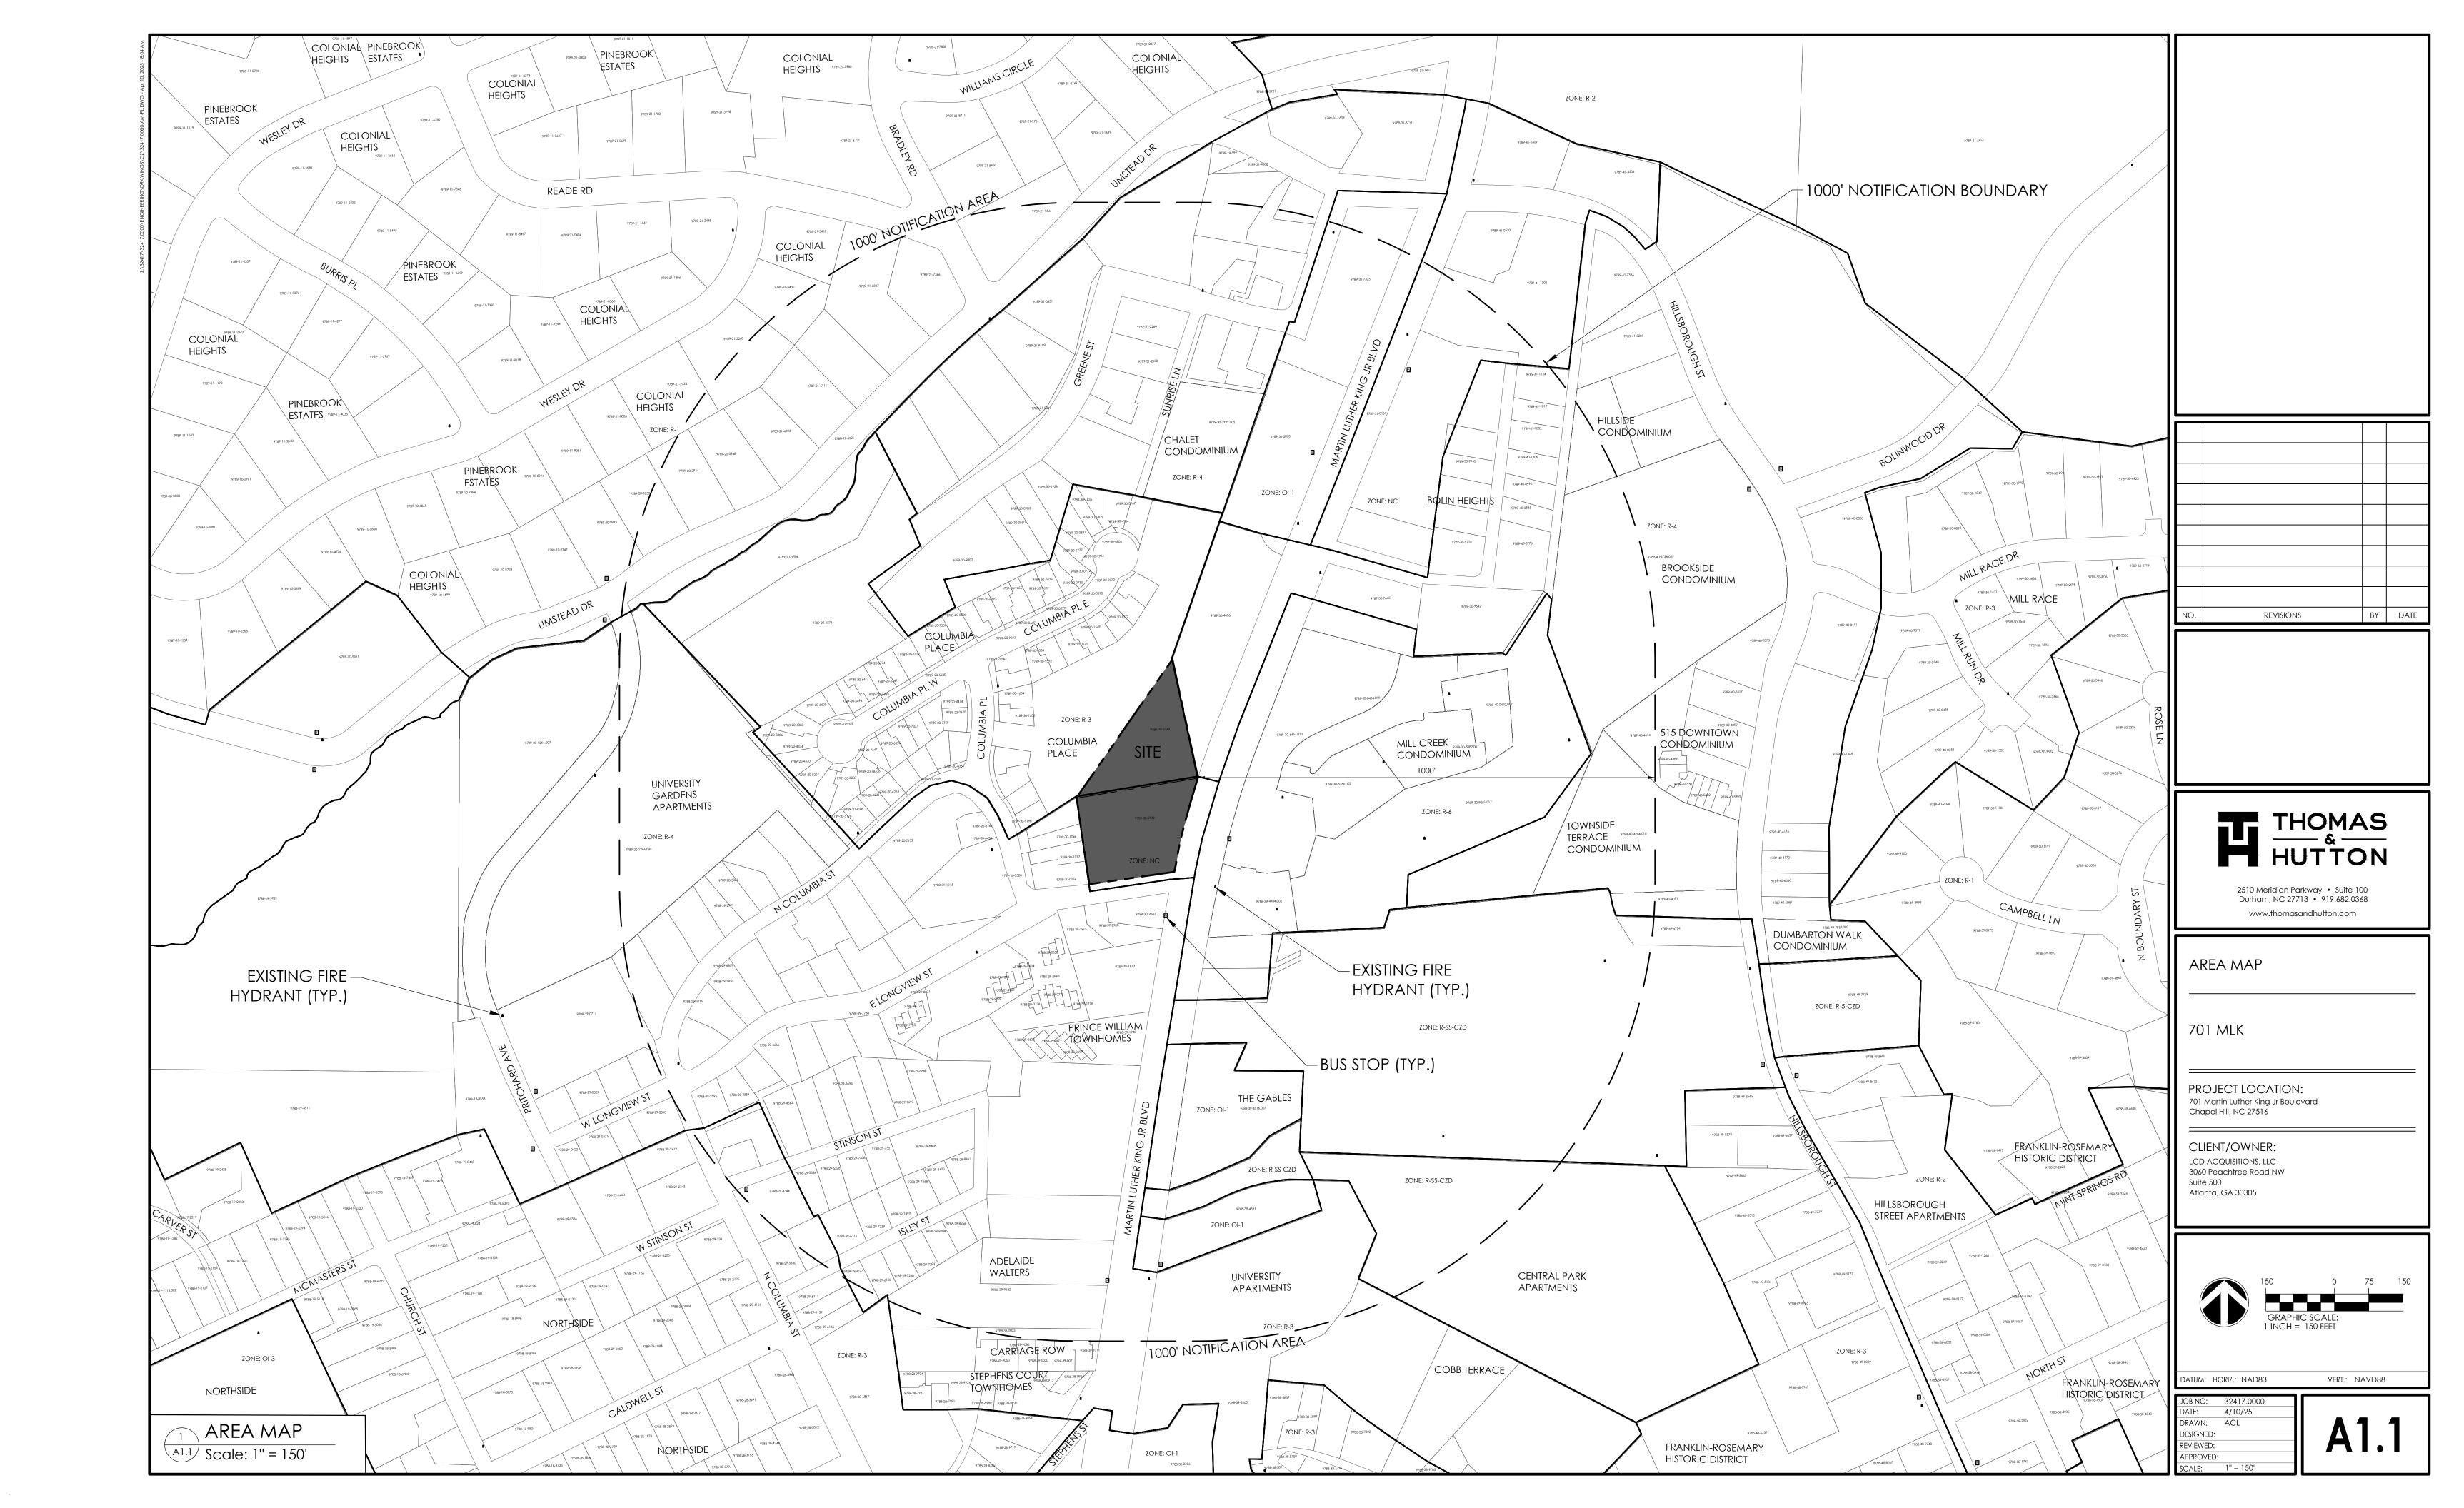

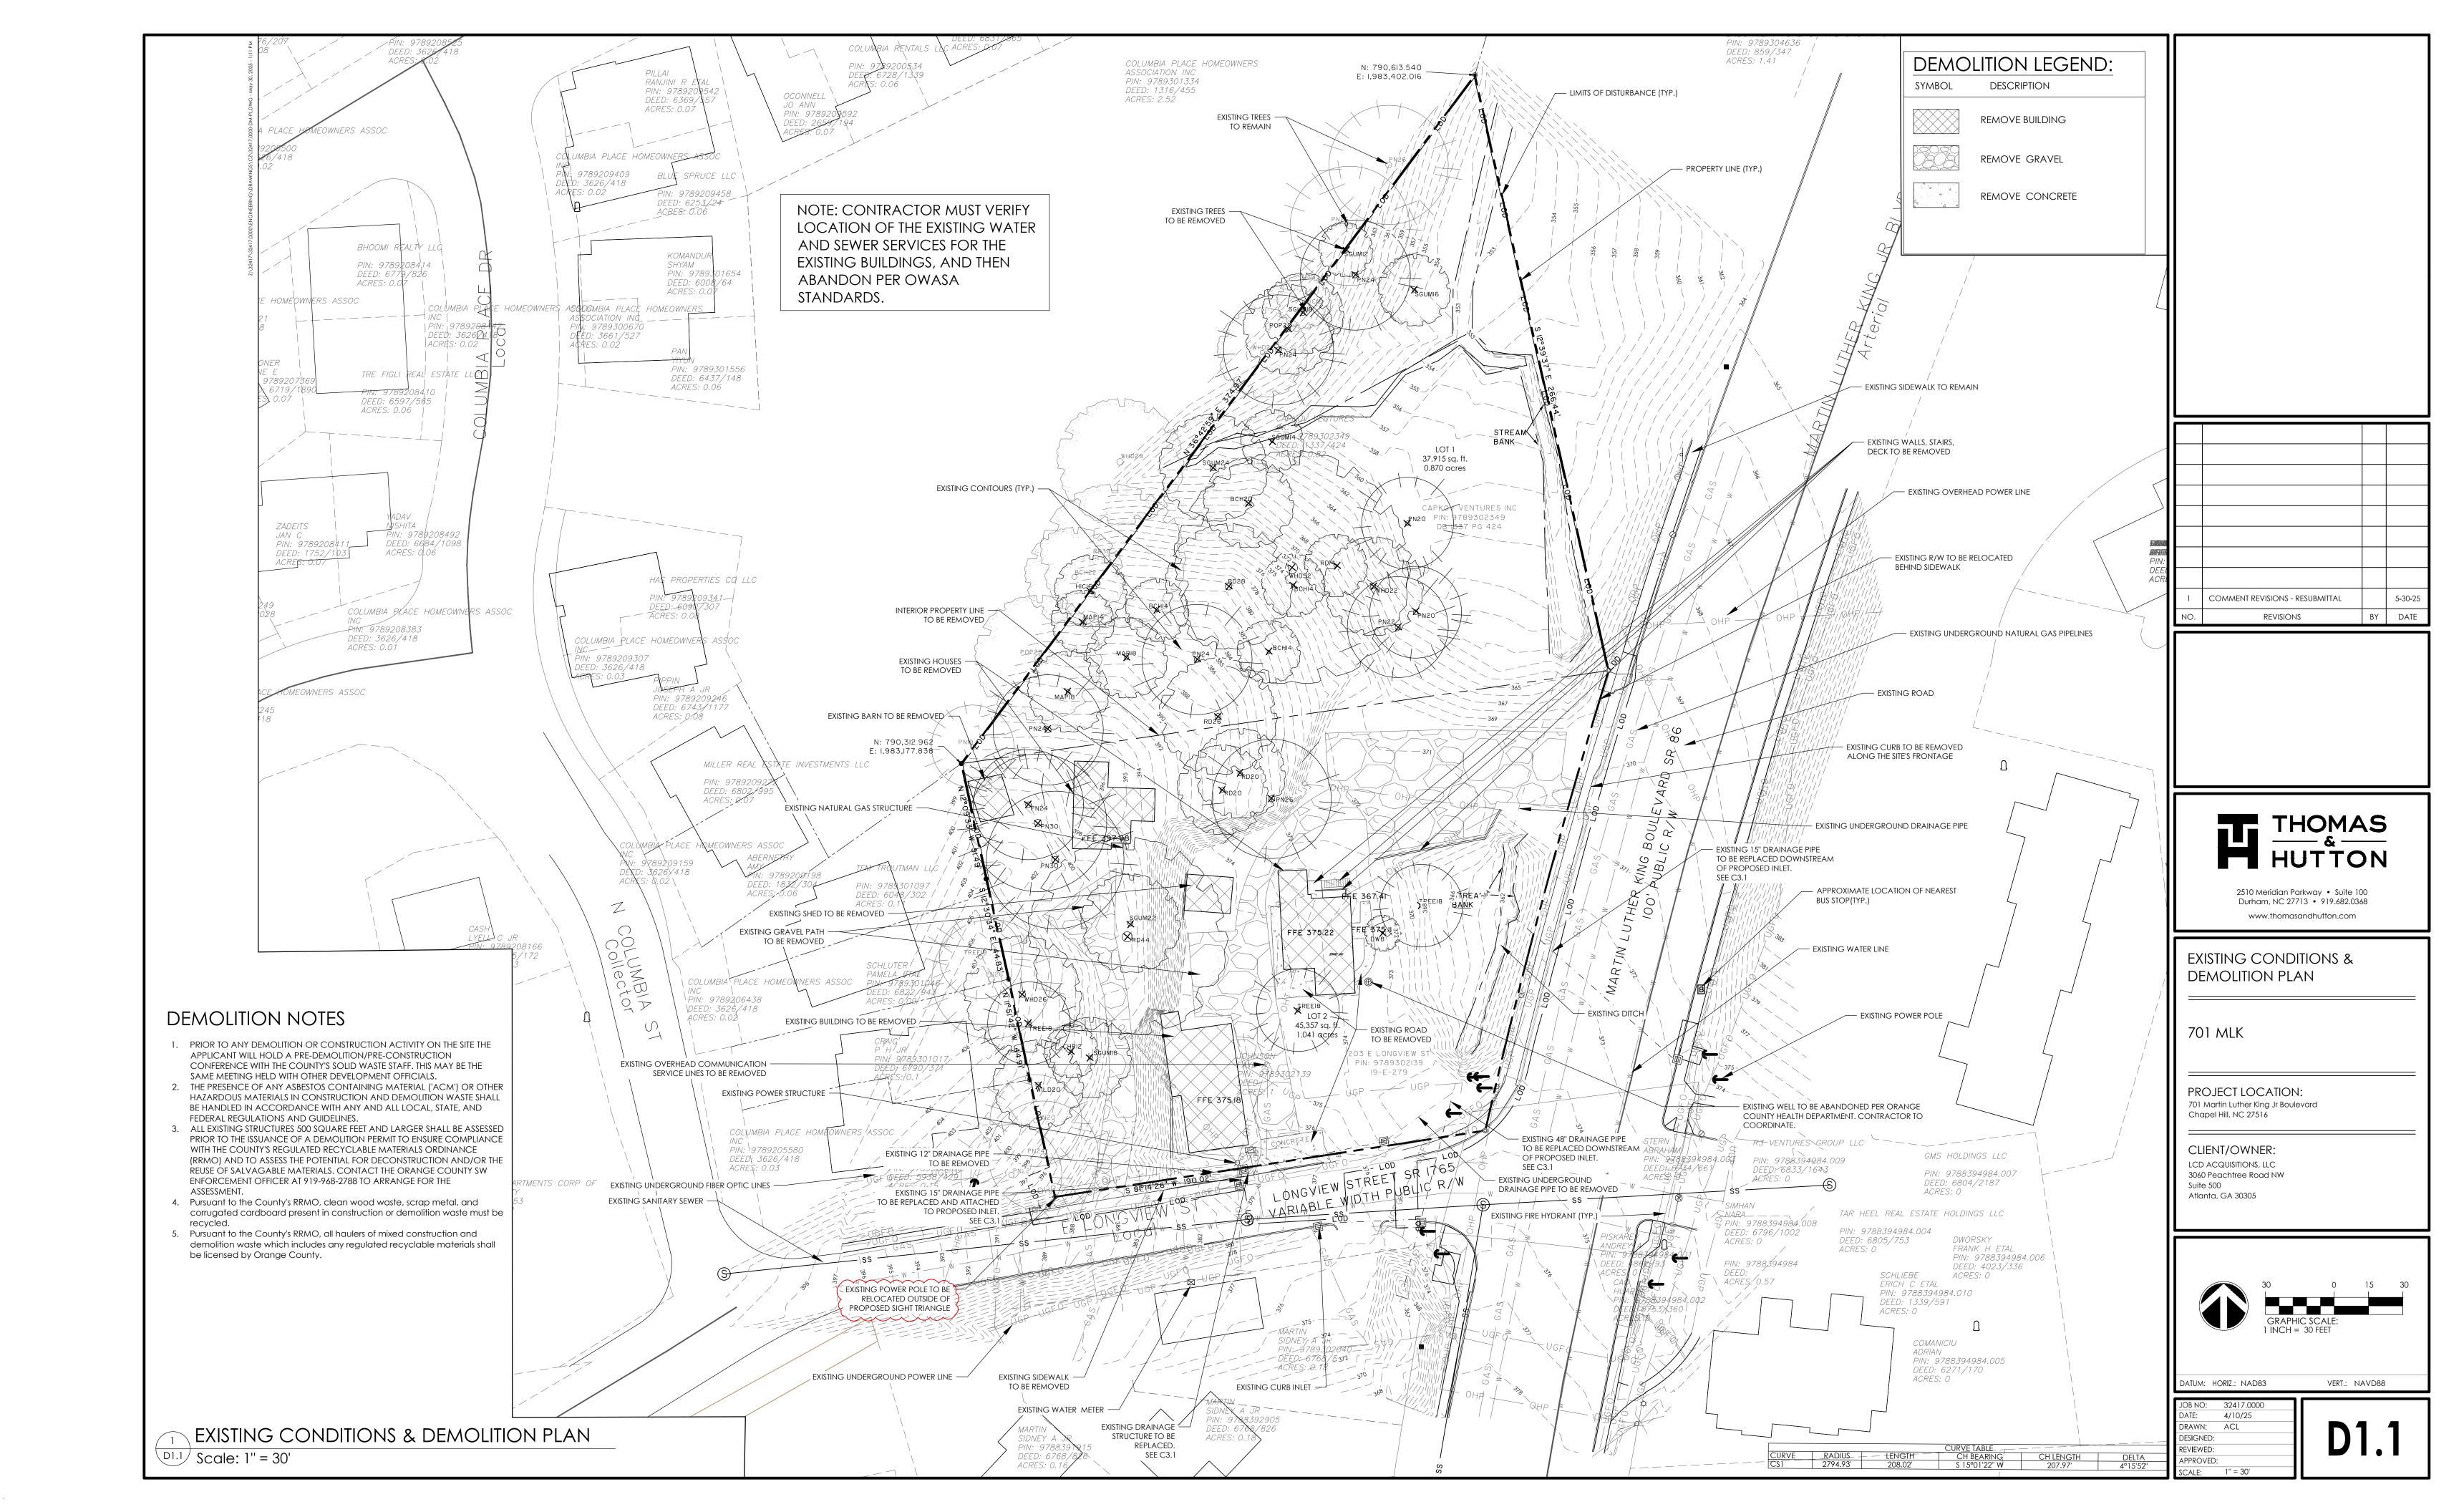




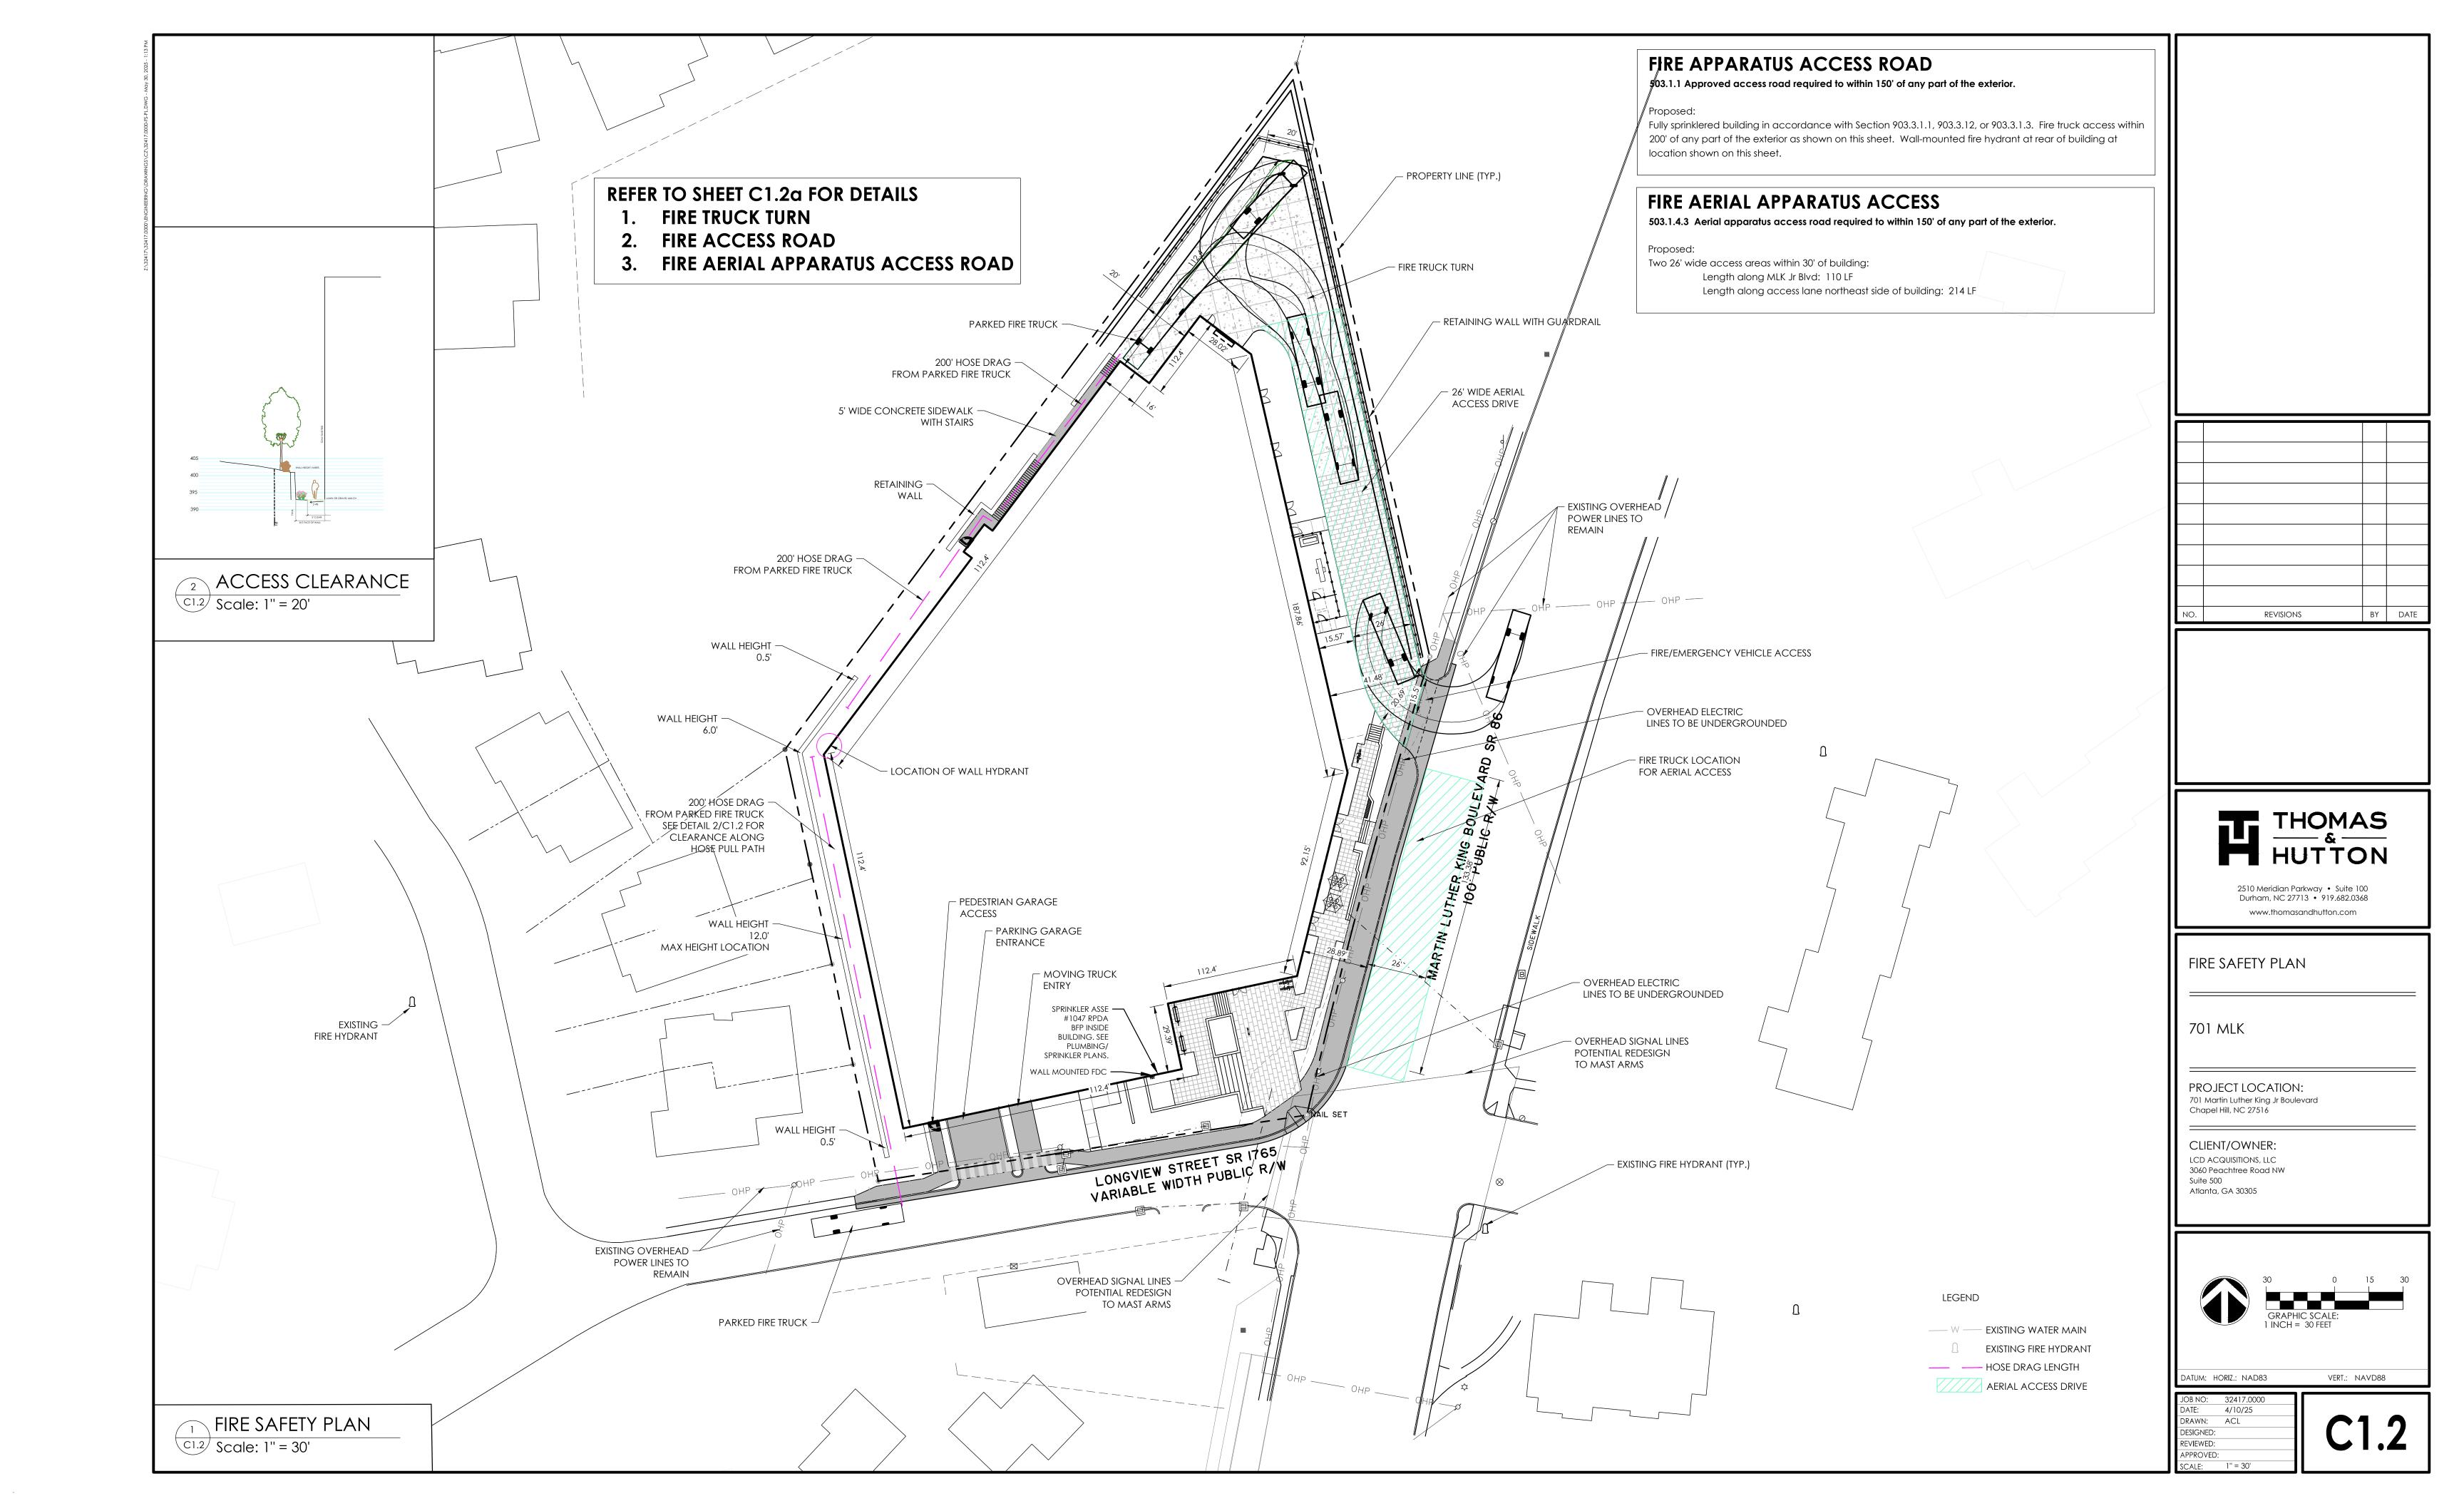




CURB & GUTTER DETAIL


C1.3 NTS

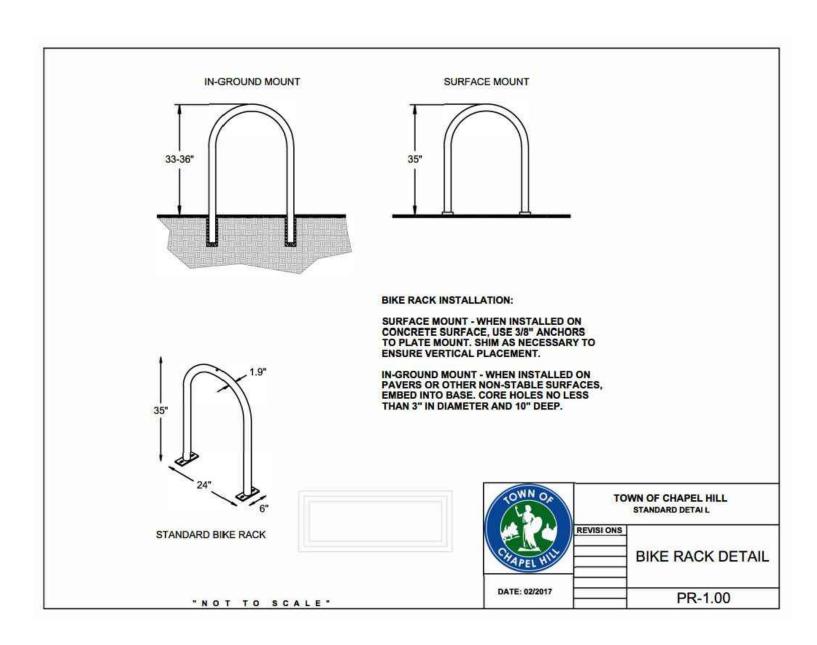


OUTDOOR BIKE RACK DETAIL

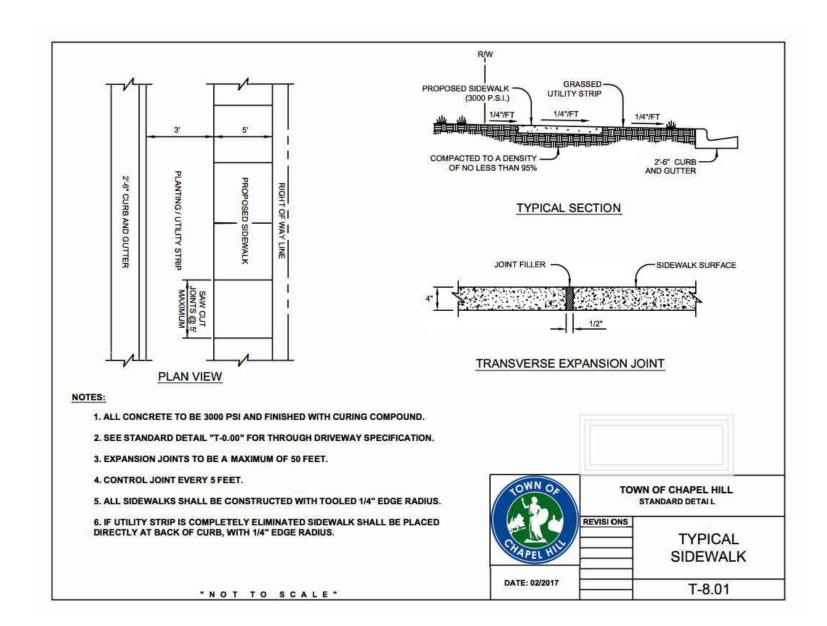

TYPICAL SIDEWALK DETAIL

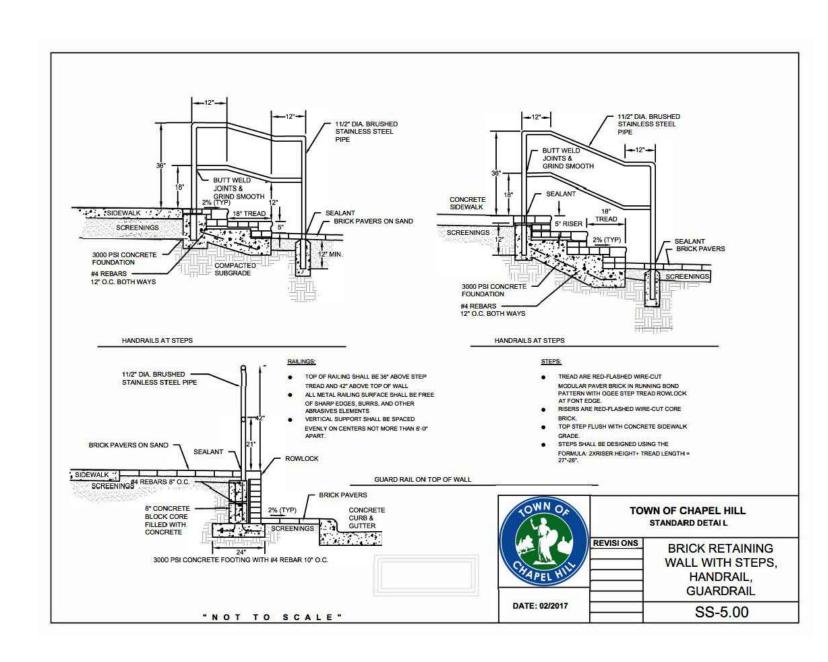

BRICK RETAINING WALL WITH STEPS, HANDRAIL, GUARDRAIL C1.3 NTS

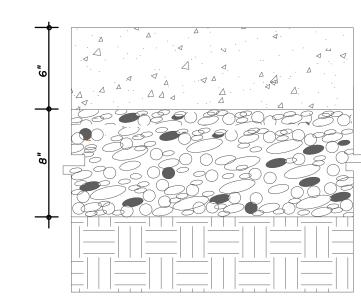

# NOTES:


I. ALL CONCRETE TO 4000 PSI, PROPERLY AIR ENTRAINED FOR EXTERIOR GRADE CONCRETE MIXES.

2. CABC BASE AND SOIL SUBGRADE TO BE COMPACTED TO 98% OF THE ASTM D-698 STD. PROCTOR MDD IN ACCORDANCE WITH THE REPORT BY THE GEOTECHNICAL ENGINEER AND PROOFROLLED AND APPROVED BY

3. CONTRACTOR SHALL INSTALL CONTRACTION AND EXPANSION JOINTS AS NECESSARY TO MINIMIZE CRACKING. CONTRACTION JOINTS SHALL BE SPACED AT 10' MAXIMUM EACH WAY WITH ACTUAL PATTERN BASED ON FIELD CONDITIONS. JOINTS SHALL BE TOOLED OR SAW CUT TO A MINIMUM DEPTH OF 2". EXPANSION JOINTS SHALL BE INSTALLED BETWEEN PAVEMENT AND ANY RIGID OBJECTS AND SPACED AS SPECIFIED IN LATEST VERSION OF ACI STANDARDS.

4. ALL PAVEMENT CONSTRUCTION SHALL BE IN ACCORDANCE WITH LATEST VERSION OF ACI STANDARDS AND THE REPORT BY THE GEOTECHNICAL ENGINEER.

(3) HEAVY DUTY CONCRETE PAVING DETAIL

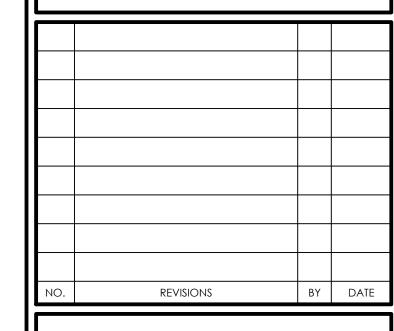




2510 Meridian Parkway • Suite 100 Durham, NC 27713 • 919.682.0368 www.thomasandhutton.com

SITE DETAILS

701 MLK


PROJECT LOCATION: 701 Martin Luther King Jr Boulevard Chapel Hill, NC 27516

CLIENT/OWNER: LCD ACQUISITIONS, LLC 3060 Peachtree Road NW Suite 500 Atlanta, GA 30305

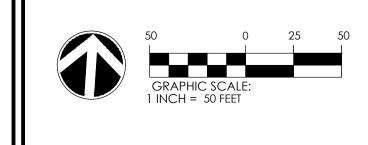


DATUM: HORIZ.: NAD83 VERT.: NAVD88

DATE: 4/10/2 DRAWN: ACL 4/10/25 DESIGNED: REVIEWED: APPROVED:

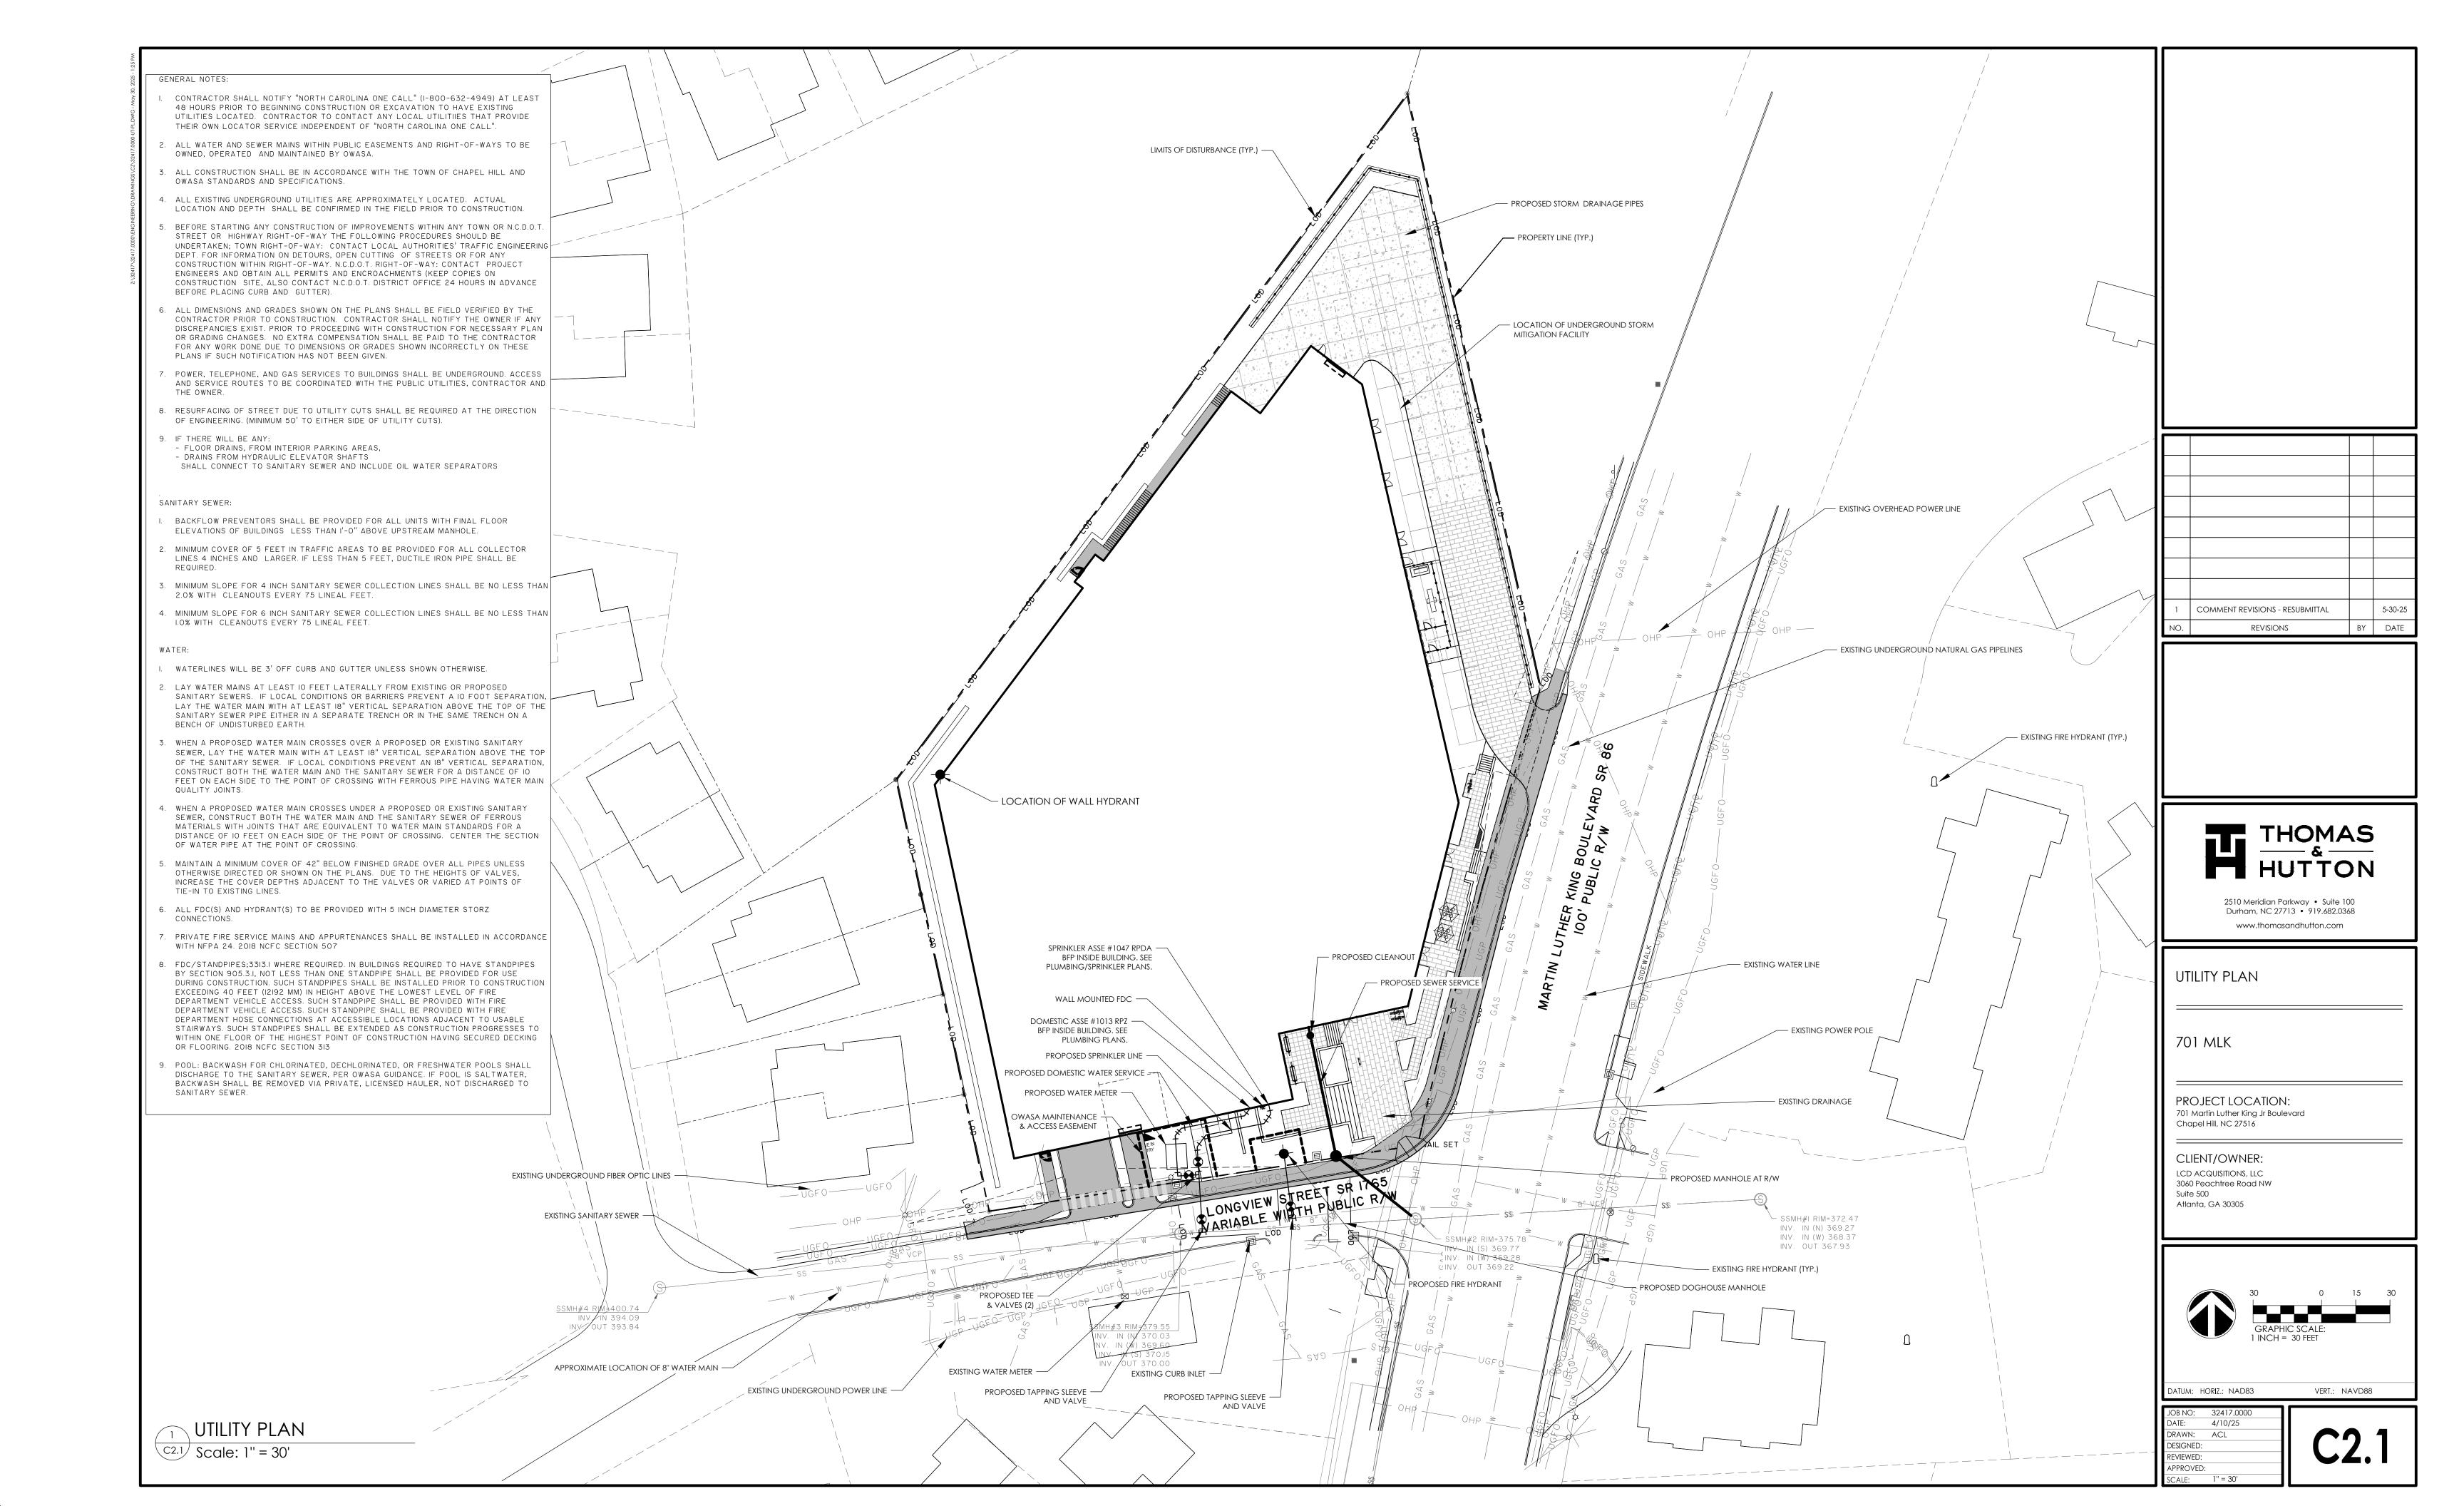


# GRADING AND STORM DRAINAGE NOTES **GRADING NOTES:** I. ALL DIMENSIONS AND GRADES SHOWN ON THE PLANS SHALL BE FIELD VERIFIED BY THE CONTRACTOR PRIOR TO CONSTRUCTION. CONTRACTOR SHALL NOTIFY THE OWNER IF ANY DISCREPANCIES EXIST PRIOR TO PROCEEDING WITH CONSTRUCTION FOR NECESSARY PLAN OR GRADE CHANGES. NO EXTRA COMPENSATION SHALL BE PAID TO THE CONTRACTOR FOR ANY WORK DONE DUE TO DIMENSIONS OR GRADES SHOWN INCORRECTLY ON THESE PLANS IF SUCH NOTIFICATION HAS NOT BEEN GIVEN. 2. ALL CONSTRUCTION SHALL BE IN ACCORDANCE WITH TOWN OF CHAPEL HILL STANDARDS AND 3. CONTRACTOR SHALL NOTIFY "NORTH CAROLINA ONE CALL" (I-800-632-4949) AT LEAST 48 HOURS PRIOR TO BEGINNING CONSTRUCTION OR EXCAVATION TO HAVE EXISTING UTILITIES LOCATED. CONTRACTOR TO CONTACT ANY LOCAL UTILITIES THAT PROVIDE THEIR OWN LOCATOR SERVICES INDEPENDENT OF "NORTH PROPOSED SCM MAINTENANCE — AND ACCESS EASEMENT 4. CONSTRUCTION, MAINTENANCE AND REMOVAL OF ALL EROSION CONTROL DEVICES ARE THE RESPONSIBILITY OF THE GENERAL CONTRACTOR. 5. EXISTING UTILITIES AND STRUCTURES SHOWN, BOTH UNDERGROUND AND ABOVE GROUND, ARE BASED ON A FIELD SURVEY AND THE BEST AVAILABLE RECORD DRAWINGS. THE CONTRACTOR SHALL VERIFY FIELD CONDITIONS PRIOR TO BEGINNING RELATED CONSTRUCTION. ANY DISCREPANCIES SHALL BE REPORTED TO THE OWNER'S REPRESENTATIVE IMMEDIATELY. 6. SOIL UNDER BUILDING PAD, PAVED AREAS AND WITHIN SLOPES GREATER THAN 3:1 (H:V) SHALL BE APPROVED, PLACED AND COMPACTED AS RECOMMENDED BY THE GEOTECHNICAL ENGINEER. THESE SOILS SHALL BE COMPACTED AS SPECIFIED UNLESS OTHERWISE RECOMMENDED BY THE GEOTECHNICAL ENGINEER. PROPOSED STORM ANY UNDERCUT OF SOILS IN THESE AREAS SHALL BE APPROVED BY THE GEOTECHNICAL ENGINEER & OWNER. THE UNDERCUT SOILS SHALL ALSO QUANTIFIED BY THE GEOTECHNICAL ENGINEER. DRAIN PIPE (TYP.) 7. ALL GRADING MUST PRODUCE SURFACE DRAINAGE ADEQUATE TO PREVENT STANDING WATER OR WET LAWN - UNDERGROUND DETENTION AREAS, AND TO ENSURE THAT ALL STORM WATER FLOWS TO INLETS OR OTHER POINTS OF DISCHARGE. AND SAND FILTER 8. ALL SIDEWALKS SHALL BE CONSTRUCTED WITH A MAXIMUM 1.8% CROSS SLOPE IN THE DIRECTION SHOWN ON PROPOSED OPEN -9. CONNECT ALL ROOF LEADERS AND DOWNSPOUTS TO STORM DRAINAGE SYSTEM WITH PVC PIPE. SEE THROAT INLET ARCHITECTURAL PLANS FOR LOCATIONS. 10. STORM STRUCTURES: PROVIDE PRE-CAST CURB INLET HOODS AND COVERS STATING, "DUMP NO WASTE! DRAINS TO JORDAN LAKE", IN ACCORDANCE WITH THE SPECIFICATIONS OF THE TOWN OF CHAPEL HILL STANDARD DETAILS, FOR ALL NEW CURB INLETS FOR PRIVATE, TOWN AND STATE EXISTING CONTOURS (TYP.) -RIGHTS-OF-WAY. GUARDRAII STORM DRAINAGE NOTES: RE: 5/C1.3 1. ALL STORM DRAINAGE PIPES SHOWN ARE TO BE CLASS III REINFORCED CONCRETE (RCP) UNLESS 2. ALL STORM DRAINAGE CONSTRUCTION SHALL BE IN ACCORDANCE WITH THE TOWN OF CHAPEL HILL 3. ALL CONCRETE SHALL MEET A MINIMUM 3000 PSI COMPRESSIVE STRENGTH. 4. ALL PIPE IN STORM DRAIN STRUCTURES SHALL BE STRUCK EVEN WITH INSIDE WALL. COMMENT REVISIONS - RESUBMITTAL APPROXIMATE LOCATION · 5. ALL PIPE JOINTS SHALL BE MADE WITH PREFORMED JOINT SEALER, WHICH CONFORMS TO AASHTO OF ROOF DRAINS BY DATE SPECIFICATION M-198 FOR TYPE B FLEXIBLE PLASTIC GASKETS UNLESS OTHERWISE NOTED. REVISIONS 6. THE INTERIOR SURFACES OF ALL STORM DRAINAGE STRUCTURES SHALL BE POINTED AND SMOOTHED TO AN ACCEPTABLE STANDARD USING MORTAR MIXED TO MANUFACTURER'S SPECIFICATIONS. 7. ALL BACKFILL SHALL BE NON-PLASTIC IN NATURE, FREE FROM ROOTS, VEGETATION MATTER, WASTE CONSTRUCTION MATERIAL OR OTHER OBJECTIONABLE MATERIAL. SAID MATERIAL SHALL BE CAPABLE OF BEING COMPACTED BY MECHANICAL MEANS AND SHALL HAVE NO TENDENCY TO FLOW OR BEHAVE IN A PLASTIC MANNER UNDER THE TAMPING BLOWS OR PROOF ROLLING. RETAINING WALL — 8. MATERIALS DEEMED BY THE OWNER'S REPRESENTATIVE AS UNSUITABLE FOR BACKFILL PURPOSES SHALL BE REMOVED AND REPLACED WITH SUITABLE MATERIAL. LIMITS OF DISTURBANCE (TYP.) -9. BACKFILLING OF TRENCHES SHALL BE ACCOMPLISHED IMMEDIATELY AFTER PIPE IS LAID. THE FILL AROUND THE PIPE SHALL BE THOROUGHLY COMPACTED TO 95% OF THE MAXIMUM DRY DENSITY OBTAINABLE WITH THE STANDARD PROCTOR TEST. THE TOP EIGHT (8) INCHES SHALL BE COMPACTED TO 100% STANDARD PROCTOR. 10. UNDER NO CIRCUMSTANCES SHALL WATER BE ALLOWED TO RISE IN UNBACKFILLED TRENCHES AFTER PIPE HAS BEEN PLACED. Õ & 2510 Meridian Parkway • Suite 100 Durham, NC 27713 • 919.682.0368 www.thomasandhutton.com BW: 393.40 PAVING GRADING AND DRAINAGE PLAN TW: 405.35 — INSTALL CURB INLET ON EX. PIPE FG: 376.88 · 701 MLK EX HI #17 FG: 384.60 -PROJECT LOCATION: 701 Martin Luther King Jr Boulevard Chapel Hill, NC 27516 BW: 384.60 -PROPOSED 20' STORM DRAIN EASEMENT CLIENT/OWNER: CONNECT TO EXISTING STORM DRAIN PIPES LCD ACQUISITIONS, LLC FG: 380.19 EW FG: 377.17 UBUY R/ W 3060 Peachtree Road NW Suite 500 Atlanta, GA 30305 SSMH#I RIM=372.47 INV. ÏN (N) 369.27 INV. IN (W) 368.37 - SSMH#2 RIM=375.78 INV. OUT 367.93 INV. IN (S) 369.77 \_INV.\ IN (W) 369.28 INV. OUT 369.22 SSMH#4 RIM€400.74 \$SMH#3 RIM=379.55 INV. IN (N) 370.03 NV. IN (W) 369,60 INV. IN (S) 370.15 IŊ√. OUT 37⁄0.00 DATUM: HORIZ.: NAD83 VERT.: NAVD88 4/10/25 DRAWN: PAVING GRADING AND DRAINAGE PLAN DESIGNED: REVIEWED: C3.1 Scale: 1" = 30' APPROVED:

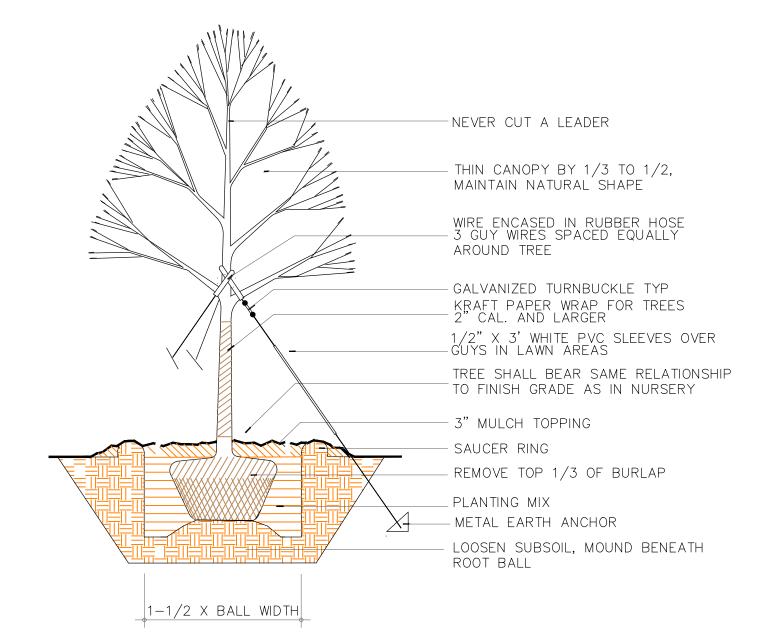


TREE PLANTING DETAIL

NTS

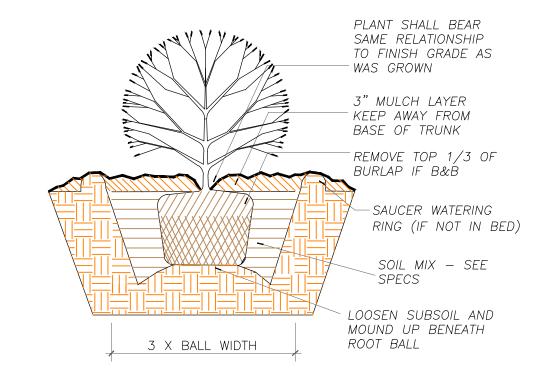



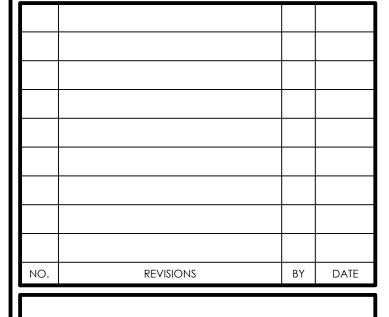

THOMAS HUTTON


> 2510 Meridian Parkway • Suite 100 Durham, NC 27713 • 919.682.0368 www.thomasandhutton.com

PLANTING DETAILS

701 MLK

PROJECT LOCATION:
701 Martin Luther King Jr Boulevard
Chapel Hill, NC 27516

CLIENT/OWNER:
LCD ACQUISITIONS, LLC
3060 Peachtree Road NW
Suite 500
Atlanta, GA 30305

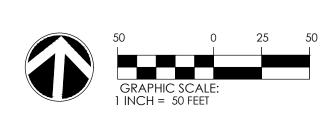

datum: horiz.: nad83

VERT.: NAVD88

JOB NO: 32417.0000

DATE: 4/10/25

DRAWN: ACL

DESIGNED:

REVIEWED:

APPROVED:

SCALE: 1" = 50'

L1.2