
# MONTESSORI COMMUNITY SCHOOL CAMPUS EXPANSION

# 4512 POPE ROAD, DURHAM, NC 27707

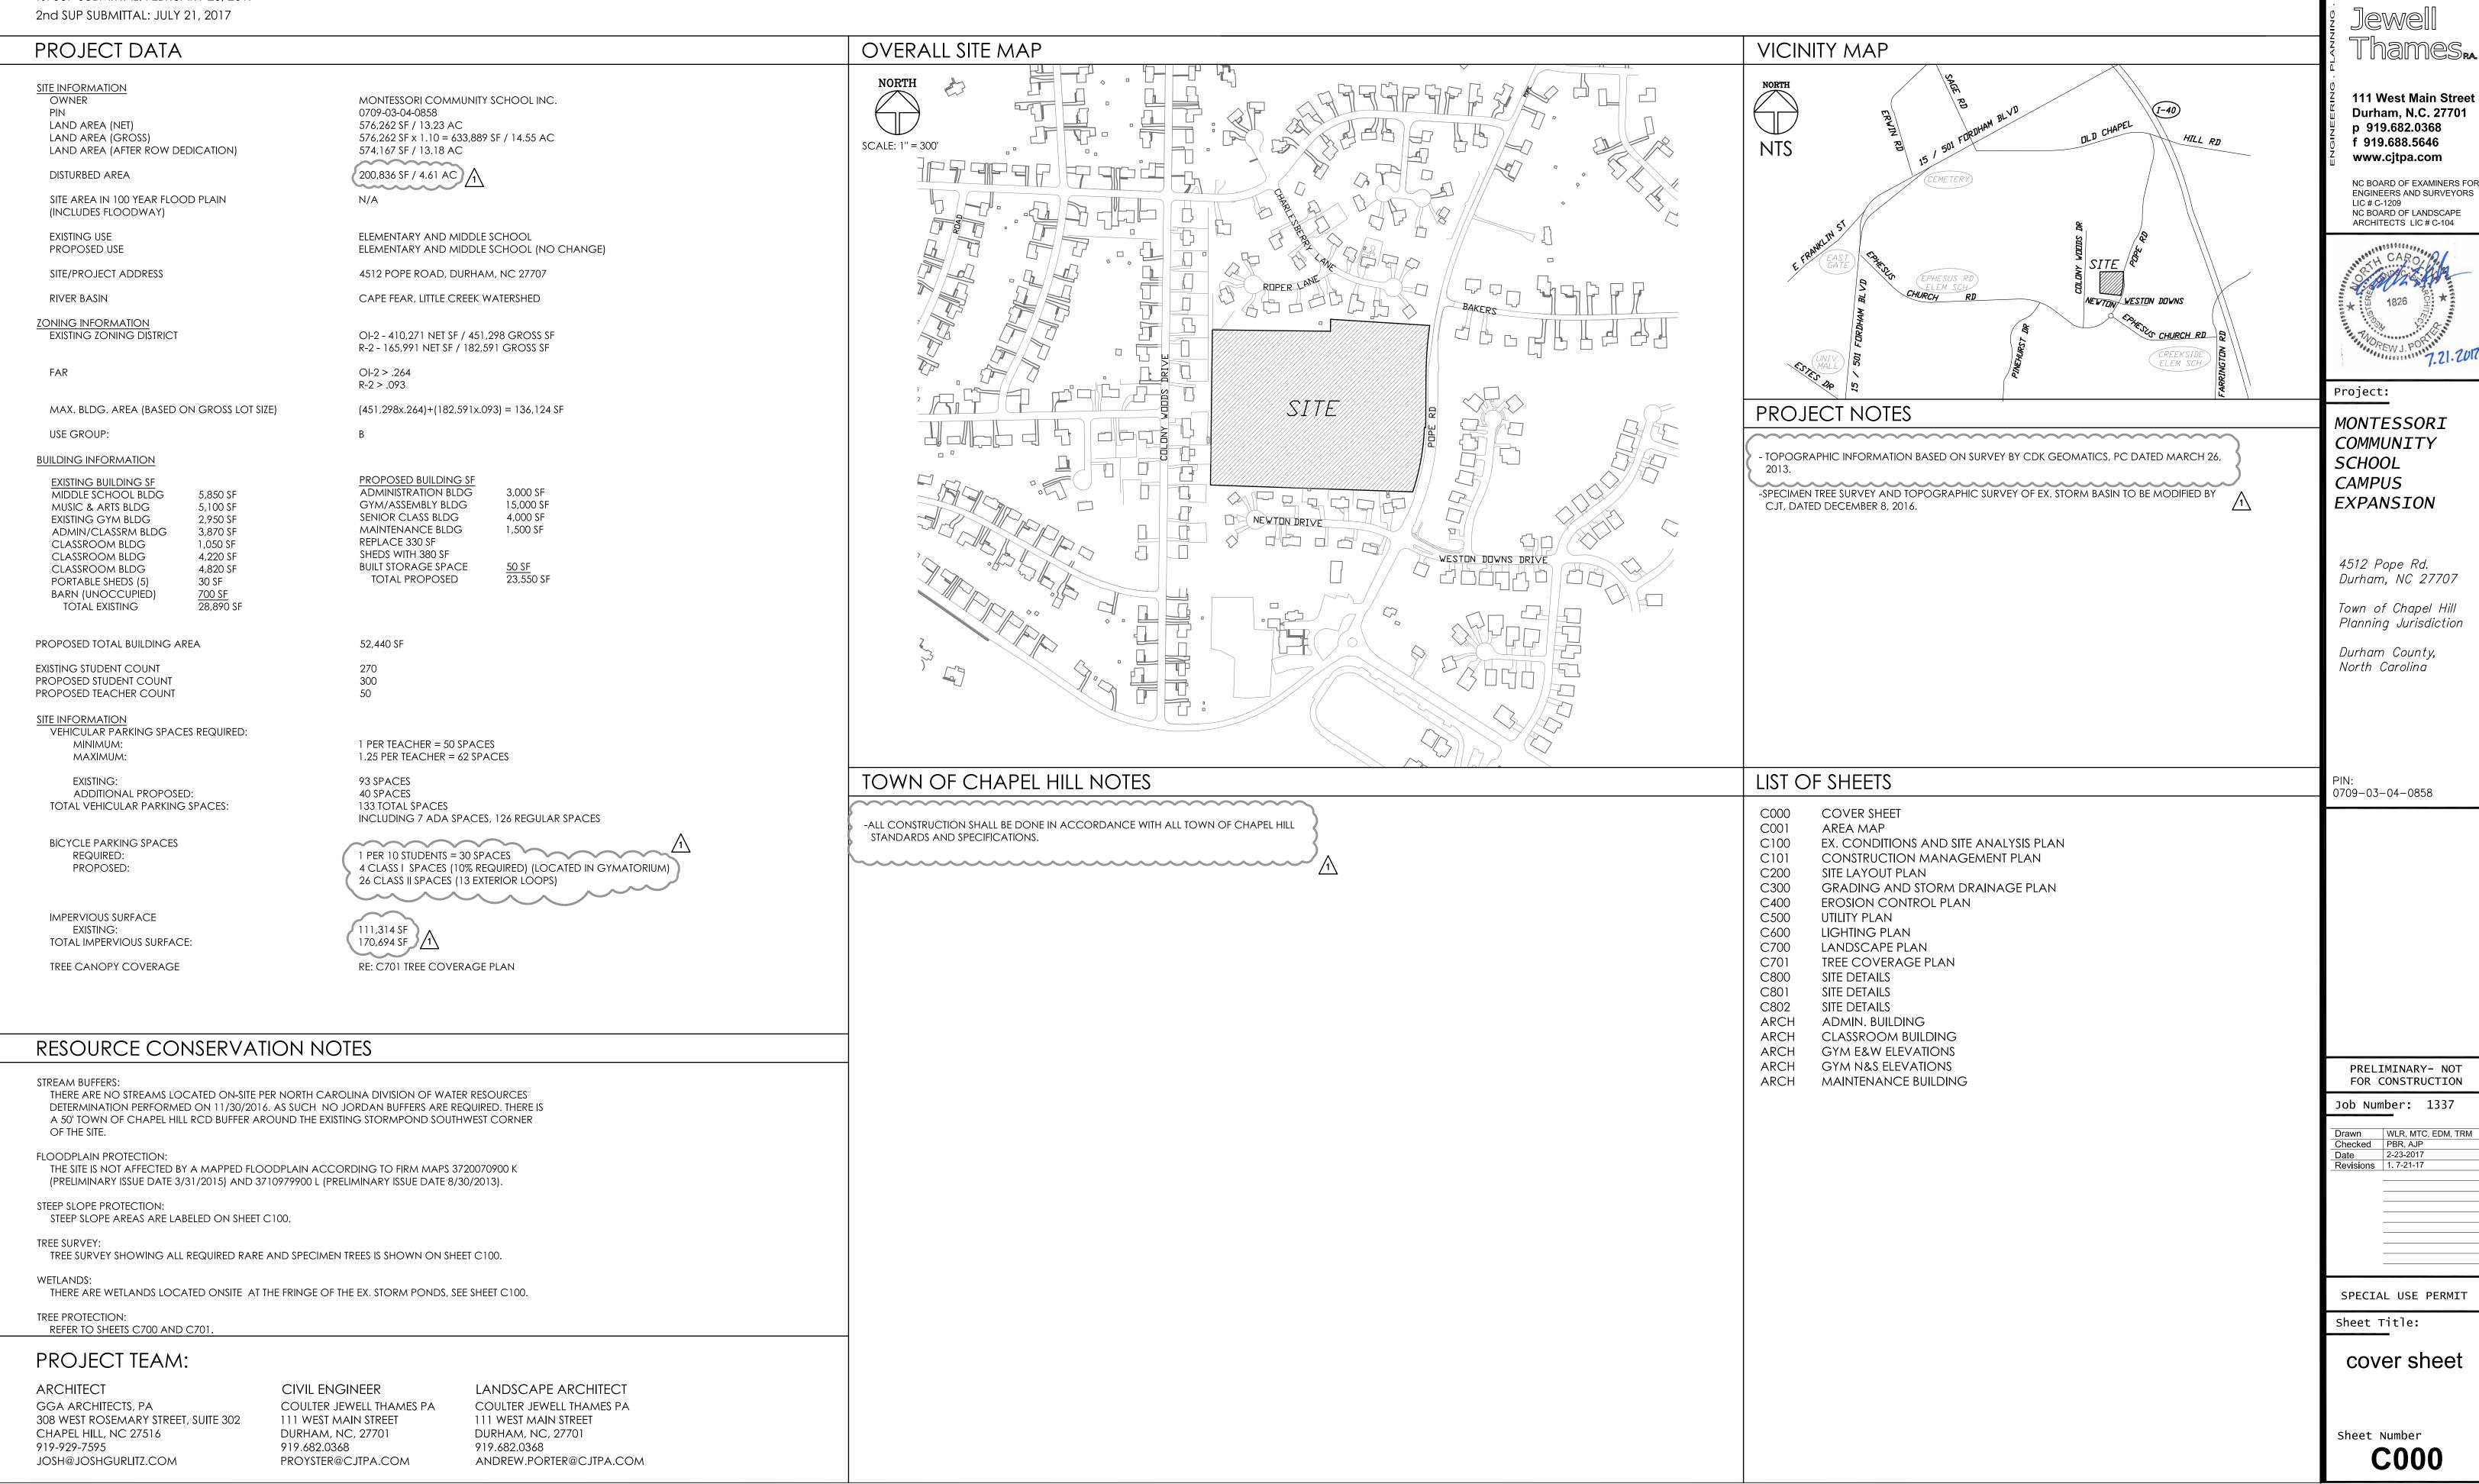





Thames

111 West Main Street Durham, N.C. 27701 p 919.682.0368 f 919.688.5646 www.cjtpa.com

NC BOARD OF EXAMINERS FOR ENGINEERS AND SURVEYORS LIC # C-1209 NC BOARD OF LANDSCAPE ARCHITECTS LIC # C-104



COMMUNITY EXPANSION

4512 Pope Rd. Durham, NC 27707

Town of Chapel Hill Planning Jurisdiction


Durham County, North Carolina

Job Number: 1337

DrawnWLR, MTC, EDM, TRMCheckedPBR, AJPDate2-23-2017Revisions1. 7-21-17

SPECIAL USE PERMIT

area map

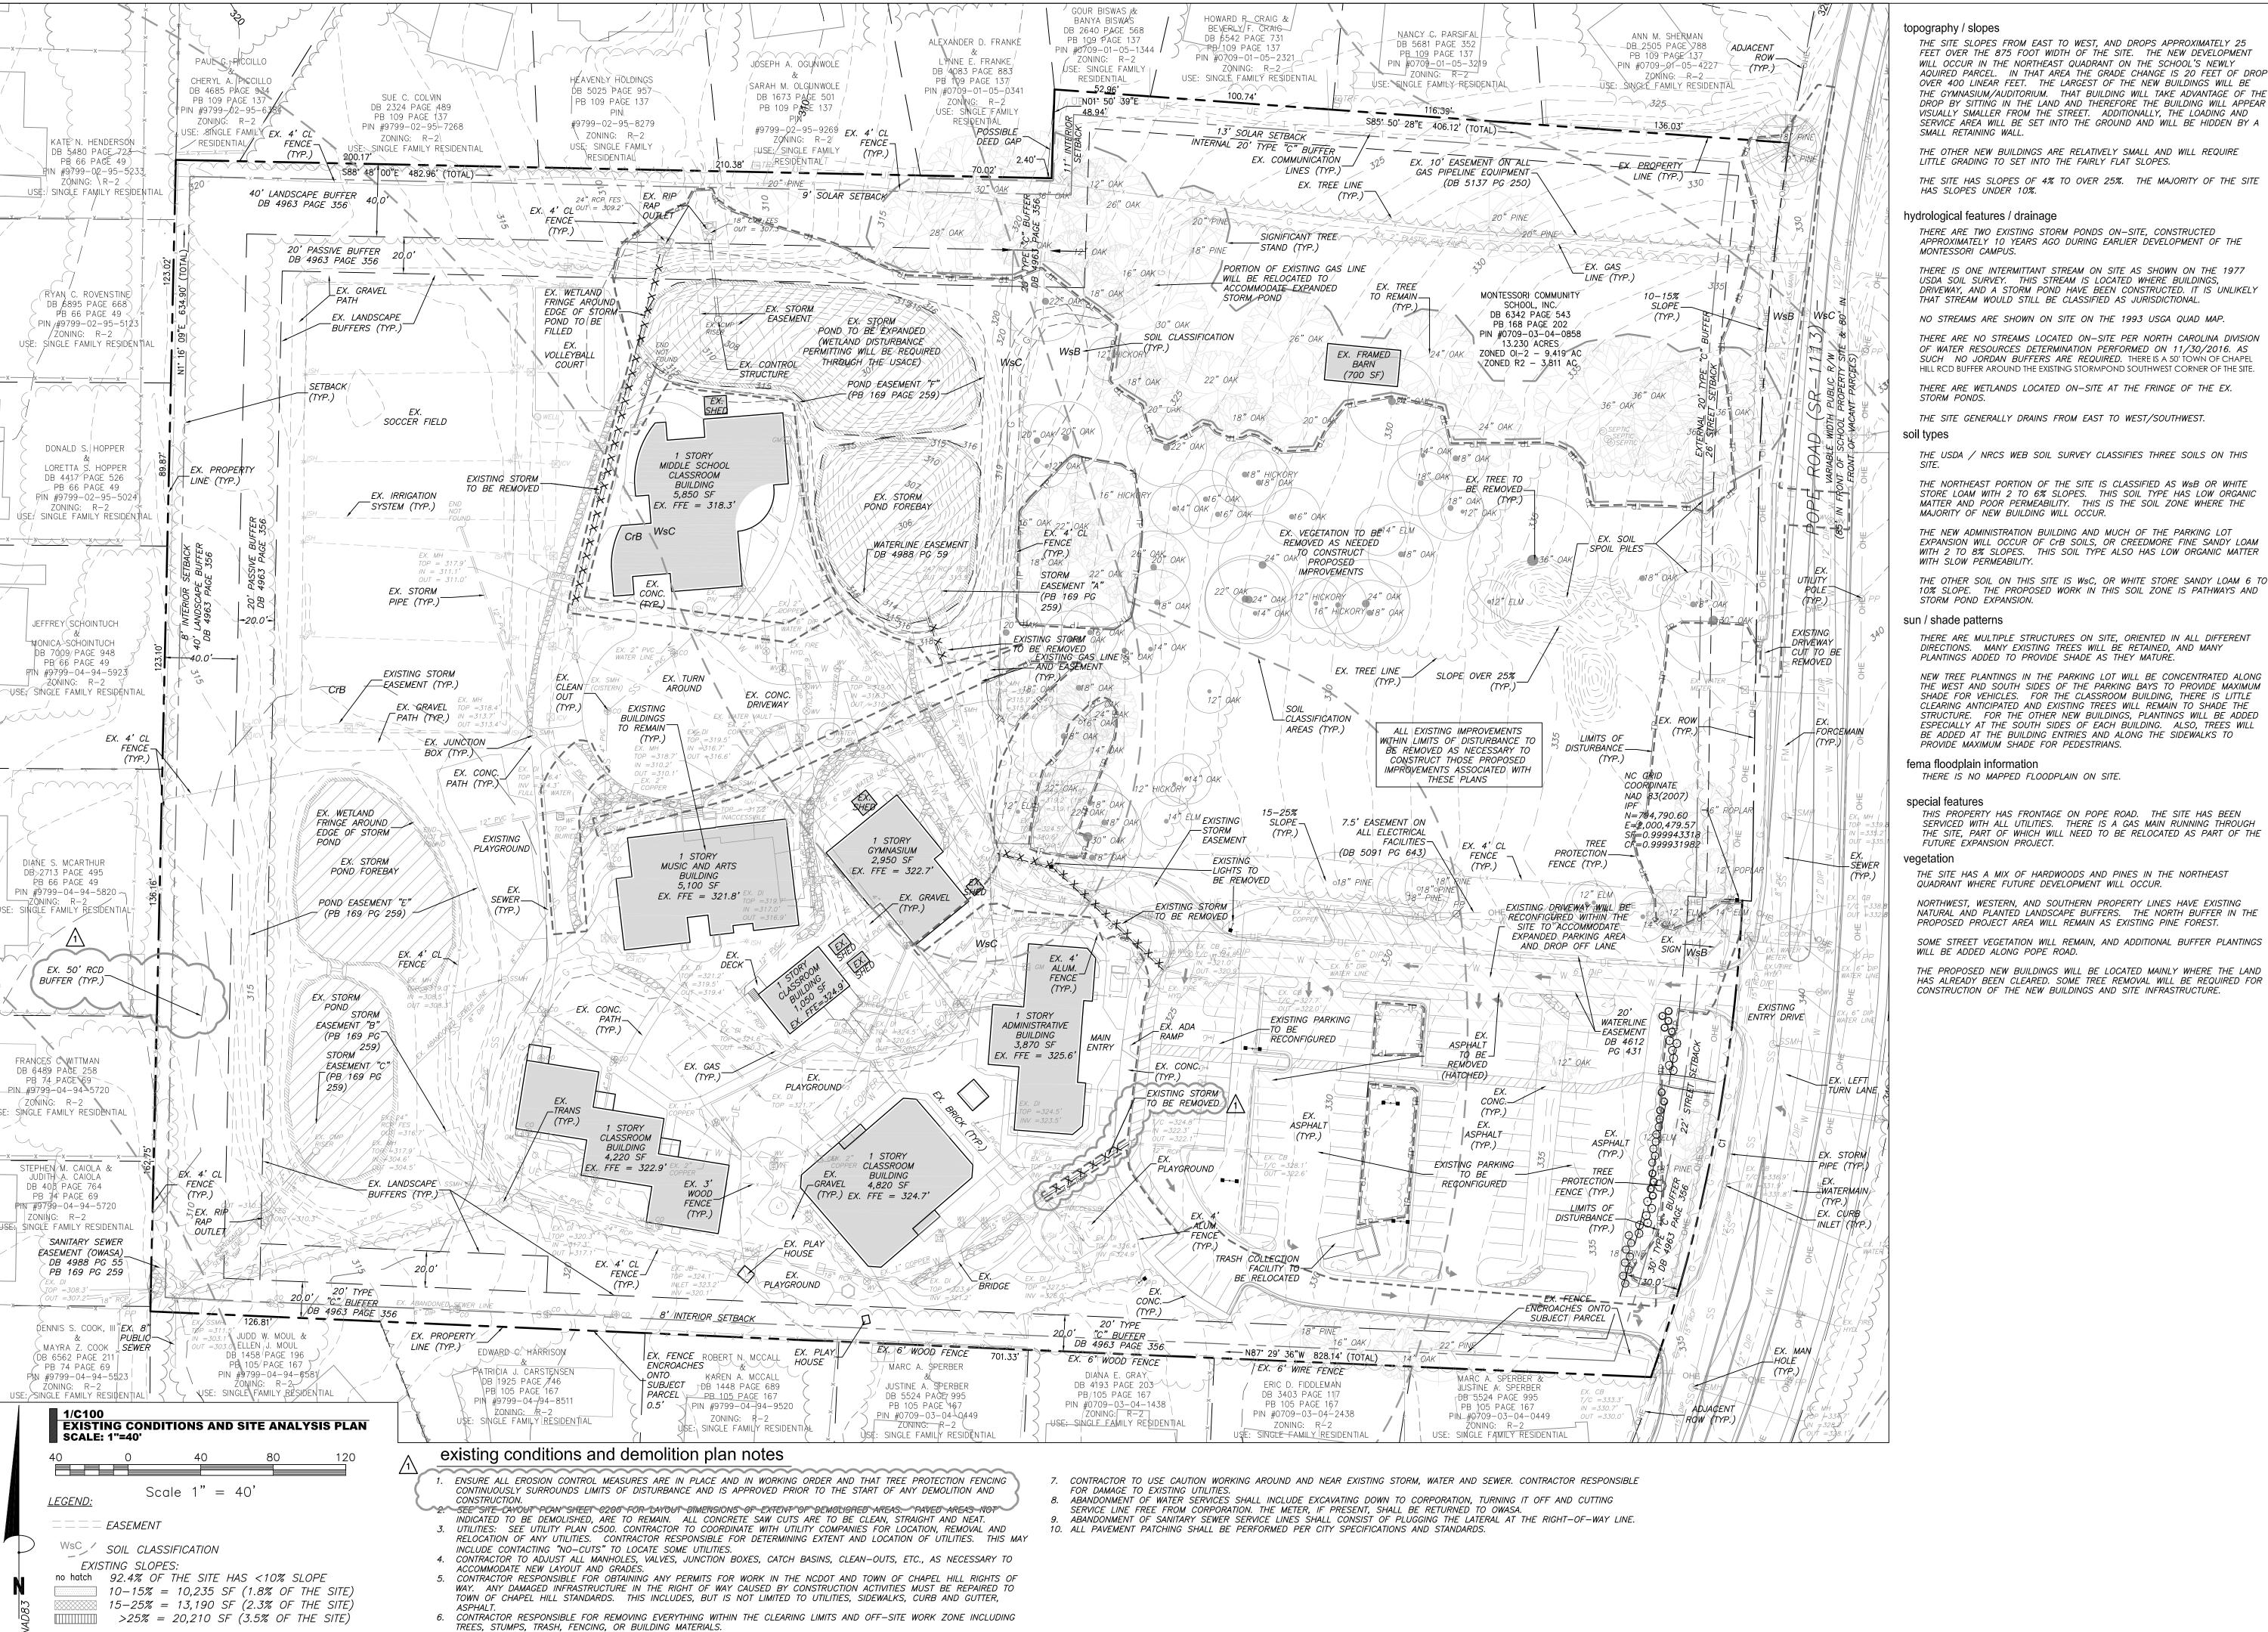

FEET OVER THE 875 FOOT WIDTH OF THE SITE. THE NEW DEVELOPMENT WILL OCCUR IN THE NORTHEAST QUADRANT ON THE SCHOOL'S NEWLY AQUIRED PARCEL. IN THAT AREA THE GRADE CHANGE IS 20 FEET OF DROP OVER 400 LINEAR FEET. THE LARGEST OF THE NEW BUILDINGS WILL BE THE GYMNASIUM/AUDITORIUM. THAT BUILDING WILL TAKE ADVANTAGE OF THE DROP BY SITTING IN THE LAND AND THEREFORE THE BUILDING WILL APPEAR VISUALLY SMALLER FROM THE STREET. ADDITIONALLY, THE LOADING AND SERVICE AREA WILL BE SET INTO THE GROUND AND WILL BE HIDDEN BY A

THE OTHER NEW BUILDINGS ARE RELATIVELY SMALL AND WILL REQUIRE LITTLE GRADING TO SET INTO THE FAIRLY FLAT SLOPES. THE SITE HAS SLOPES OF 4% TO OVER 25%. THE MAJORITY OF THE SITE

THERE ARE TWO EXISTING STORM PONDS ON-SITE, CONSTRUCTED APPROXIMATELY 10 YEARS AGO DURING EARLIER DEVELOPMENT OF THE

THERE IS ONE INTERMITTANT STREAM ON SITE AS SHOWN ON THE 1977 USDA SOIL SURVEY. THIS STREAM IS LOCATED WHERE BUILDINGS, DRIVEWAY. AND A STORM POND HAVE BEEN CONSTRUCTED. IT IS UNLIKELY

NO STREAMS ARE SHOWN ON SITE ON THE 1993 USGA QUAD MAP. THERE ARE NO STREAMS LOCATED ON-SITE PER NORTH CAROLINA DIVISION OF WATER RESOURCES DETERMINATION PERFORMED ON 11/30/2016. AS SUCH NO JORDAN BUFFERS ARE REQUIRED. THERE IS A 50' TOWN OF CHAPEL HILL RCD BUFFER AROUND THE EXISTING STORMPOND SOUTHWEST CORNER OF THE SITE

THE SITE GENERALLY DRAINS FROM EAST TO WEST/SOUTHWEST.

THE USDA / NRCS WEB SOIL SURVEY CLASSIFIES THREE SOILS ON THIS

THE NORTHEAST PORTION OF THE SITE IS CLASSIFIED AS WSB OR WHITE STORE LOAM WITH 2 TO 6% SLOPES. THIS SOIL TYPE HAS LOW ORGANIC MATTER AND POOR PERMEABILITY. THIS IS THE SOIL ZONE WHERE THE

THE NEW ADMINISTRATION BUILDING AND MUCH OF THE PARKING LOT EXPANSION WILL OCCUR OF CrB SOILS, OR CREEDMORE FINE SANDY LOAM WITH 2 TO 8% SLOPES. THIS SOIL TYPE ALSO HAS LOW ORGANIC MATTER

THE OTHER SOIL ON THIS SITE IS WSC, OR WHITE STORE SANDY LOAM 6 TO

THERE ARE MULTIPLE STRUCTURES ON SITE, ORIENTED IN ALL DIFFERENT DIRECTIONS. MANY EXISTING TREES WILL BE RETAINED, AND MANY PLANTINGS ADDED TO PROVIDE SHADE AS THEY MATURE.

THE WEST AND SOUTH SIDES OF THE PARKING BAYS TO PROVIDE MAXIMUM SHADE FOR VEHICLES. FOR THE CLASSROOM BUILDING, THERE IS LITTLE CLEARING ANTICIPATED AND EXISTING TREES WILL REMAIN TO SHADE THE STRUCTURE. FOR THE OTHER NEW BUILDINGS, PLANTINGS WILL BE ADDED ESPECIALLY AT THE SOUTH SIDES OF EACH BUILDING. ALSO, TREES WILL BE ADDED AT THE BUILDING ENTRIES AND ALONG THE SIDEWALKS TO

THIS PROPERTY HAS FRONTAGE ON POPE ROAD. THE SITE HAS BEEN SERVICED WITH ALL UTILITIES. THERE IS A GAS MAIN RUNNING THROUGH THE SITE, PART OF WHICH WILL NEED TO BE RELOCATED AS PART OF THE

THE SITE HAS A MIX OF HARDWOODS AND PINES IN THE NORTHEAST

NORTHWEST, WESTERN, AND SOUTHERN PROPERTY LINES HAVE EXISTING NATURAL AND PLANTED LANDSCAPE BUFFERS. THE NORTH BUFFER IN THE PROPOSED PROJECT AREA WILL REMAIN AS EXISTING PINE FOREST.

SOME STREET VEGETATION WILL REMAIN, AND ADDITIONAL BUFFER PLANTINGS



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Project:

**MONTESSORI** COMMUNITY **SCHOOL CAMPUS EXPANSION** 

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Town of Chapel Hill Planning Jurisdiction

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0709-03-04-0858

PRELIMINARY- NOT

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FOR CONSTRUCTION

WLR, MTC, EDM, TRM Checked PBR, AJP 
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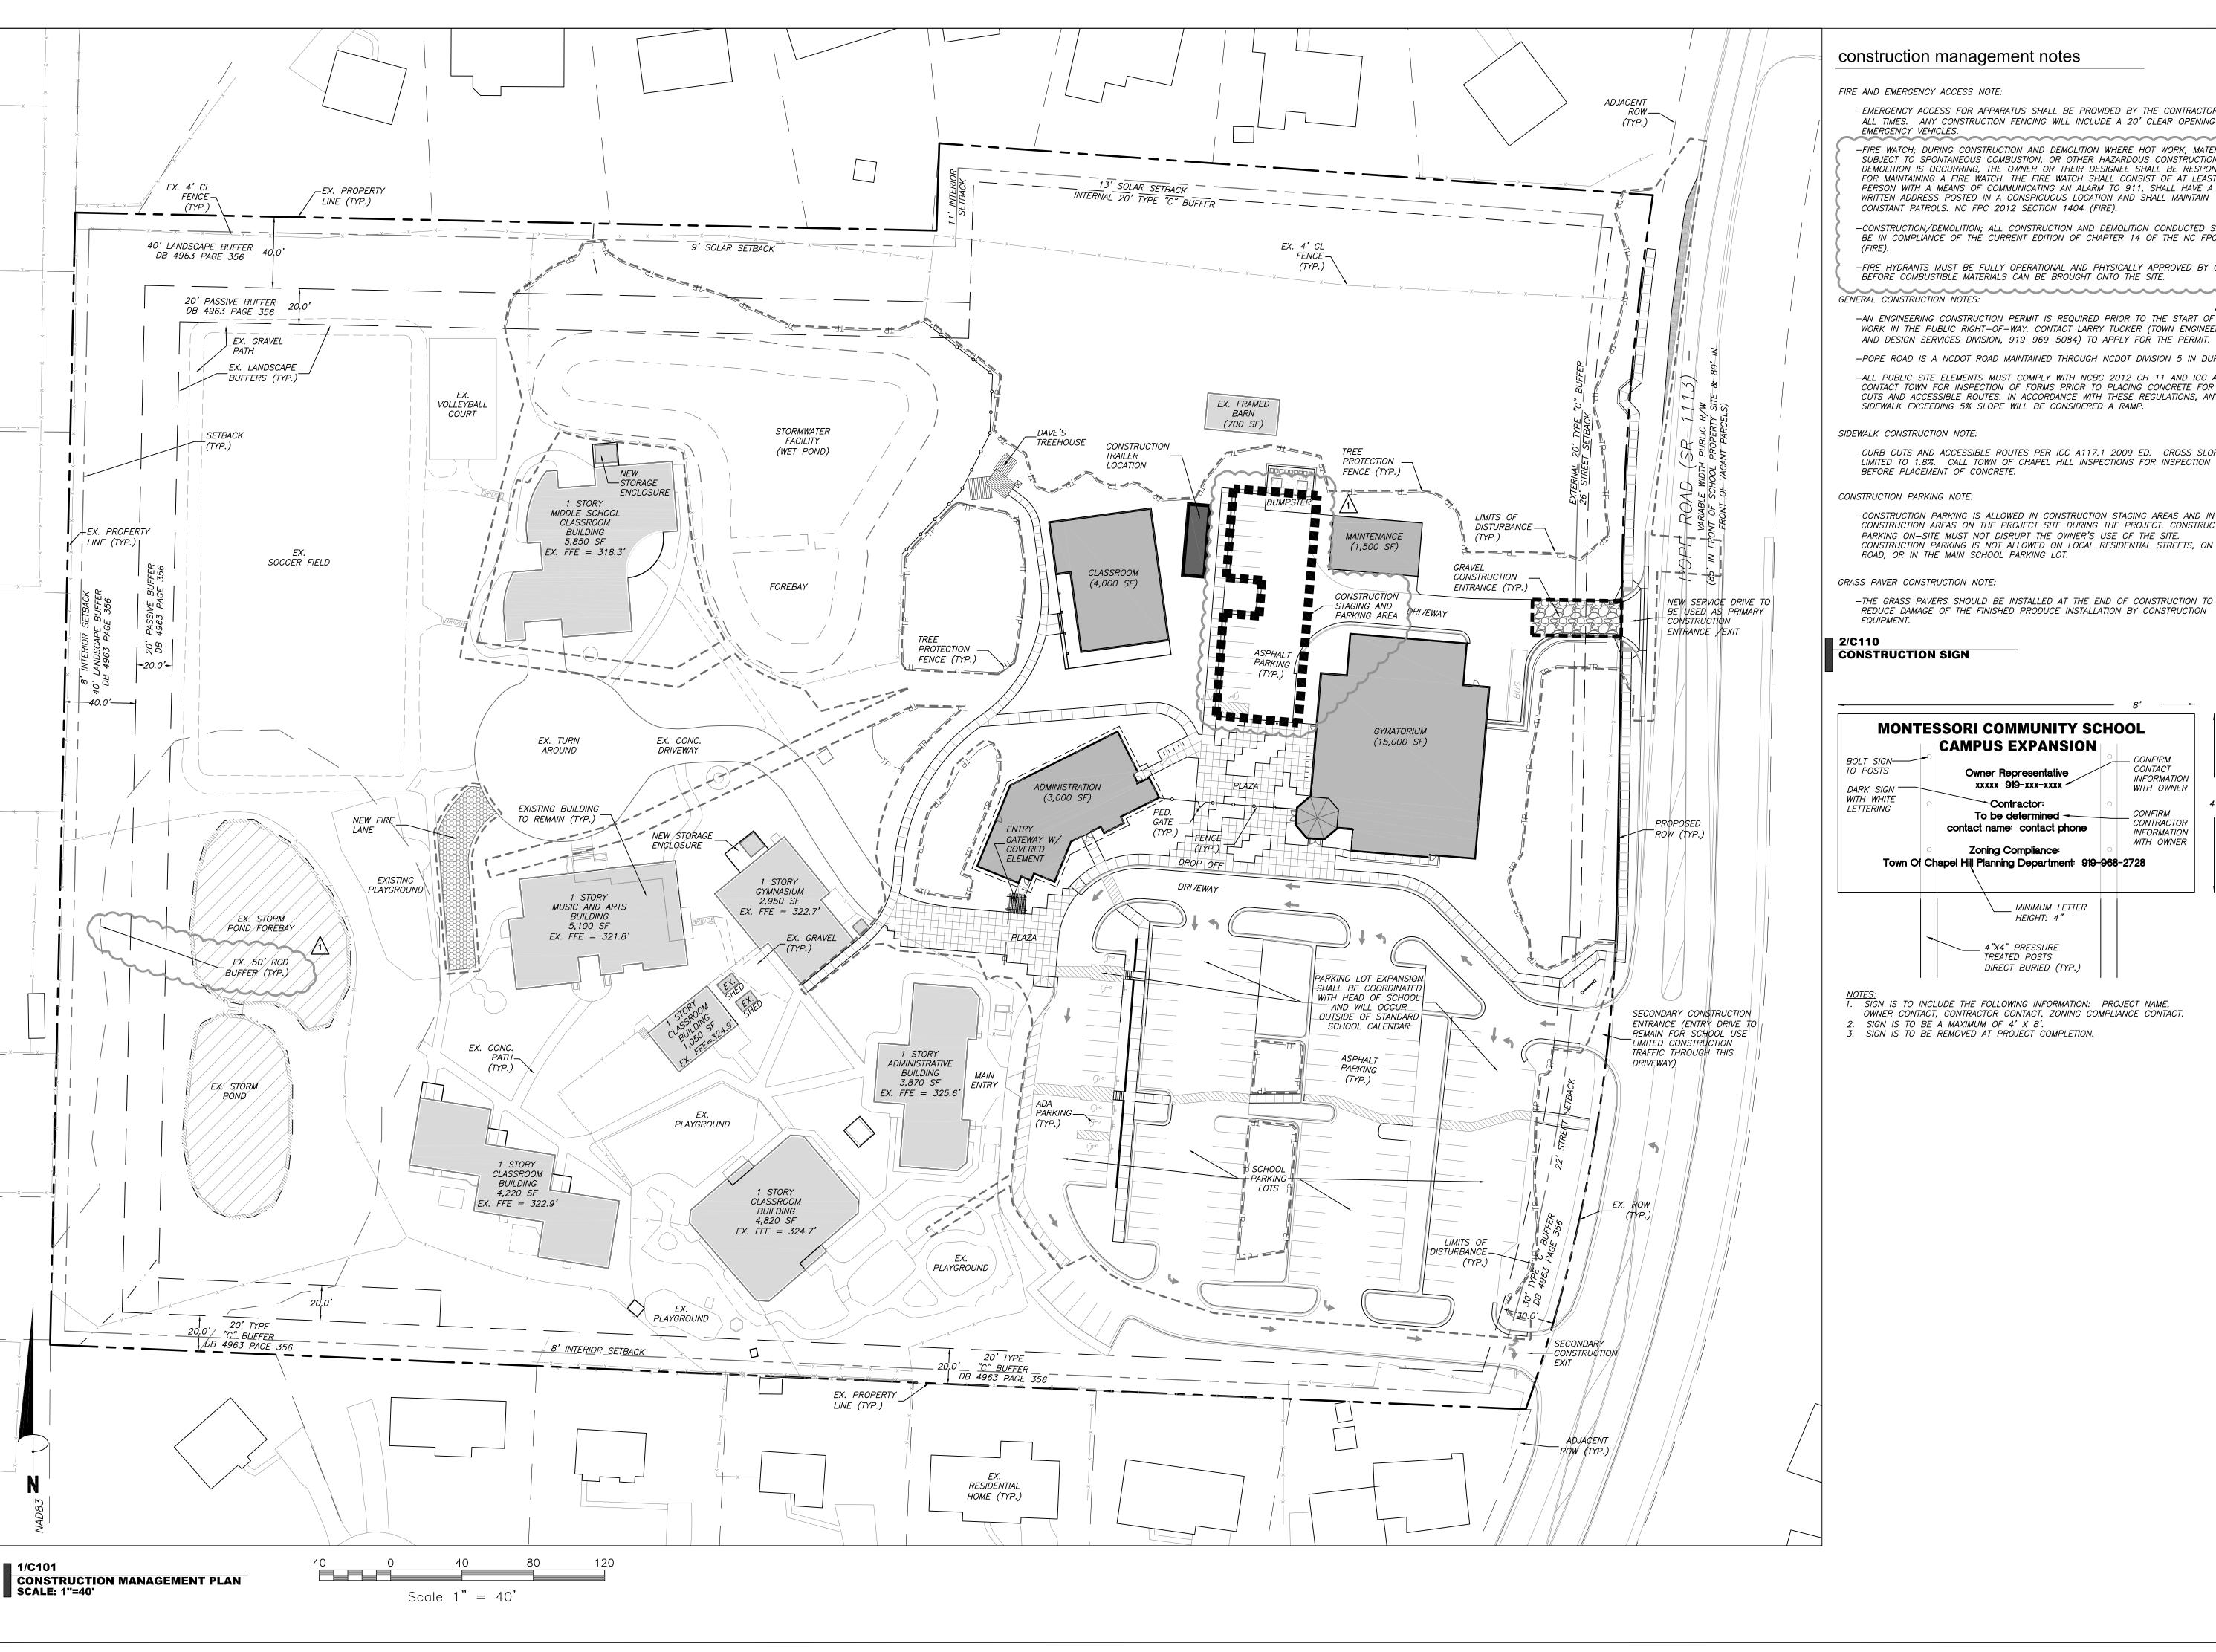
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 2-23-2017

SPECIAL USE PERMIT

Sheet Title:

ex. conditions and site analysis plan

Sheet Number



#### construction management notes

FIRE AND EMERGENCY ACCESS NOTE:

-EMERGENCY ACCESS FOR APPARATUS SHALL BE PROVIDED BY THE CONTRACTOR AT ALL TIMES. ANY CONSTRUCTION FENCING WILL INCLUDE A 20' CLEAR OPENING FOR EMERGENCY VEHICLES.

-FIRE WATCH; DURING CONSTRUCTION AND DEMOLITION WHERE HOT WORK, MATERIALS SUBJECT TO SPONTANEOUS COMBUSTION, OR OTHER HAZARDOUS CONSTRUCTION OR DEMOLITION IS OCCURRING, THE OWNER OR THEIR DESIGNEE SHALL BE RESPONSIBLE FOR MAINTAINING A FIRE WATCH. THE FIRE WATCH SHALL CONSIST OF AT LEAST ONE PERSON WITH A MEANS OF COMMUNICATING AN ALARM TO 911, SHALL HAVE A WRITTEN ADDRESS POSTED IN A CONSPICUOUS LOCATION AND SHALL MAINTAIN CONSTANT PATROLS. NC FPC 2012 SECTION 1404 (FIRE).

-CONSTRUCTION/DEMOLITION; ALL CONSTRUCTION AND DEMOLITION CONDUCTED SHALL BE IN COMPLIANCE OF THE CURRENT EDITION OF CHAPTER 14 OF THE NC FPC.

-FIRE HYDRANTS MUST BE FULLY OPERATIONAL AND PHYSICALLY APPROVED BY OWASA BEFORE COMBUSTIBLE MATERIALS CAN BE BROUGHT ONTO THE SITE.

GENERAL CONSTRUCTION NOTES:

-AN ENGINEERING CONSTRUCTION PERMIT IS REQUIRED PRIOR TO THE START OF ANY WORK IN THE PUBLIC RIGHT-OF-WAY. CONTACT LARRY TUCKER (TOWN ENGINEERING AND DESIGN SERVICES DIVISION, 919-969-5084) TO APPLY FOR THE PERMIT.

-POPE ROAD IS A NCDOT ROAD MAINTAINED THROUGH NCDOT DIVISION 5 IN DURHAM.

-ALL PUBLIC SITE ELEMENTS MUST COMPLY WITH NCBC 2012 CH 11 AND ICC A 117 CONTACT TOWN FOR INSPECTION OF FORMS PRIOR TO PLACING CONCRETE FOR CURB CUTS AND ACCESSIBLE ROUTES. IN ACCORDANCE WITH THESE REGULATIONS, ANY SIDEWALK EXCEEDING 5% SLOPE WILL BE CONSIDERED A RAMP.

SIDEWALK CONSTRUCTION NOTE:


-CURB CUTS AND ACCESSIBLE ROUTES PER ICC A117.1 2009 ED. CROSS SLOPE IS LIMITED TO 1.8%. CALL TOWN OF CHAPEL HILL INSPECTIONS FOR INSPECTION BEFORE PLACEMENT OF CONCRETE.

CONSTRUCTION PARKING NOTE:

-CONSTRUCTION PARKING IS ALLOWED IN CONSTRUCTION STAGING AREAS AND IN THE CONSTRUCTION AREAS ON THE PROJECT SITE DURING THE PROJECT. CONSTRUCTION PARKING ON-SITE MUST NOT DISRUPT THE OWNER'S USE OF THE SITE. CONSTRUCTION PARKING IS NOT ALLOWED ON LOCAL RESIDENTIAL STREETS, ON POPL ROAD, OR IN THE MAIN SCHOOL PARKING LOT.

GRASS PAVER CONSTRUCTION NOTE:

REDUCE DAMAGE OF THE FINISHED PRODUCE INSTALLATION BY CONSTRUCTION

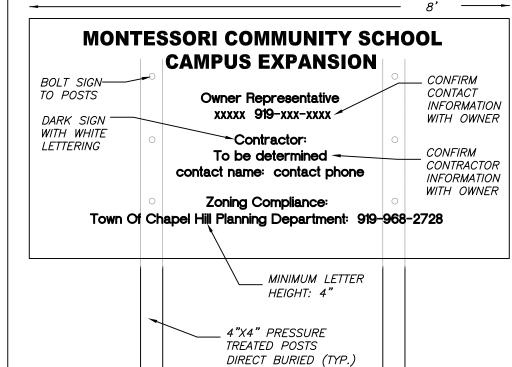

NOTES:

1. SIGN IS TO INCLUDE THE FOLLOWING INFORMATION: PROJECT NAME,
OWNER CONTACT, CONTRACTOR CONTACT, ZONING COMPLIANCE CONTACT.

- 2. SIGN IS TO BE A MAXIMUM OF 4' X 8'.
- 3. SIGN IS TO BE REMOVED AT PROJECT COMPLETION.



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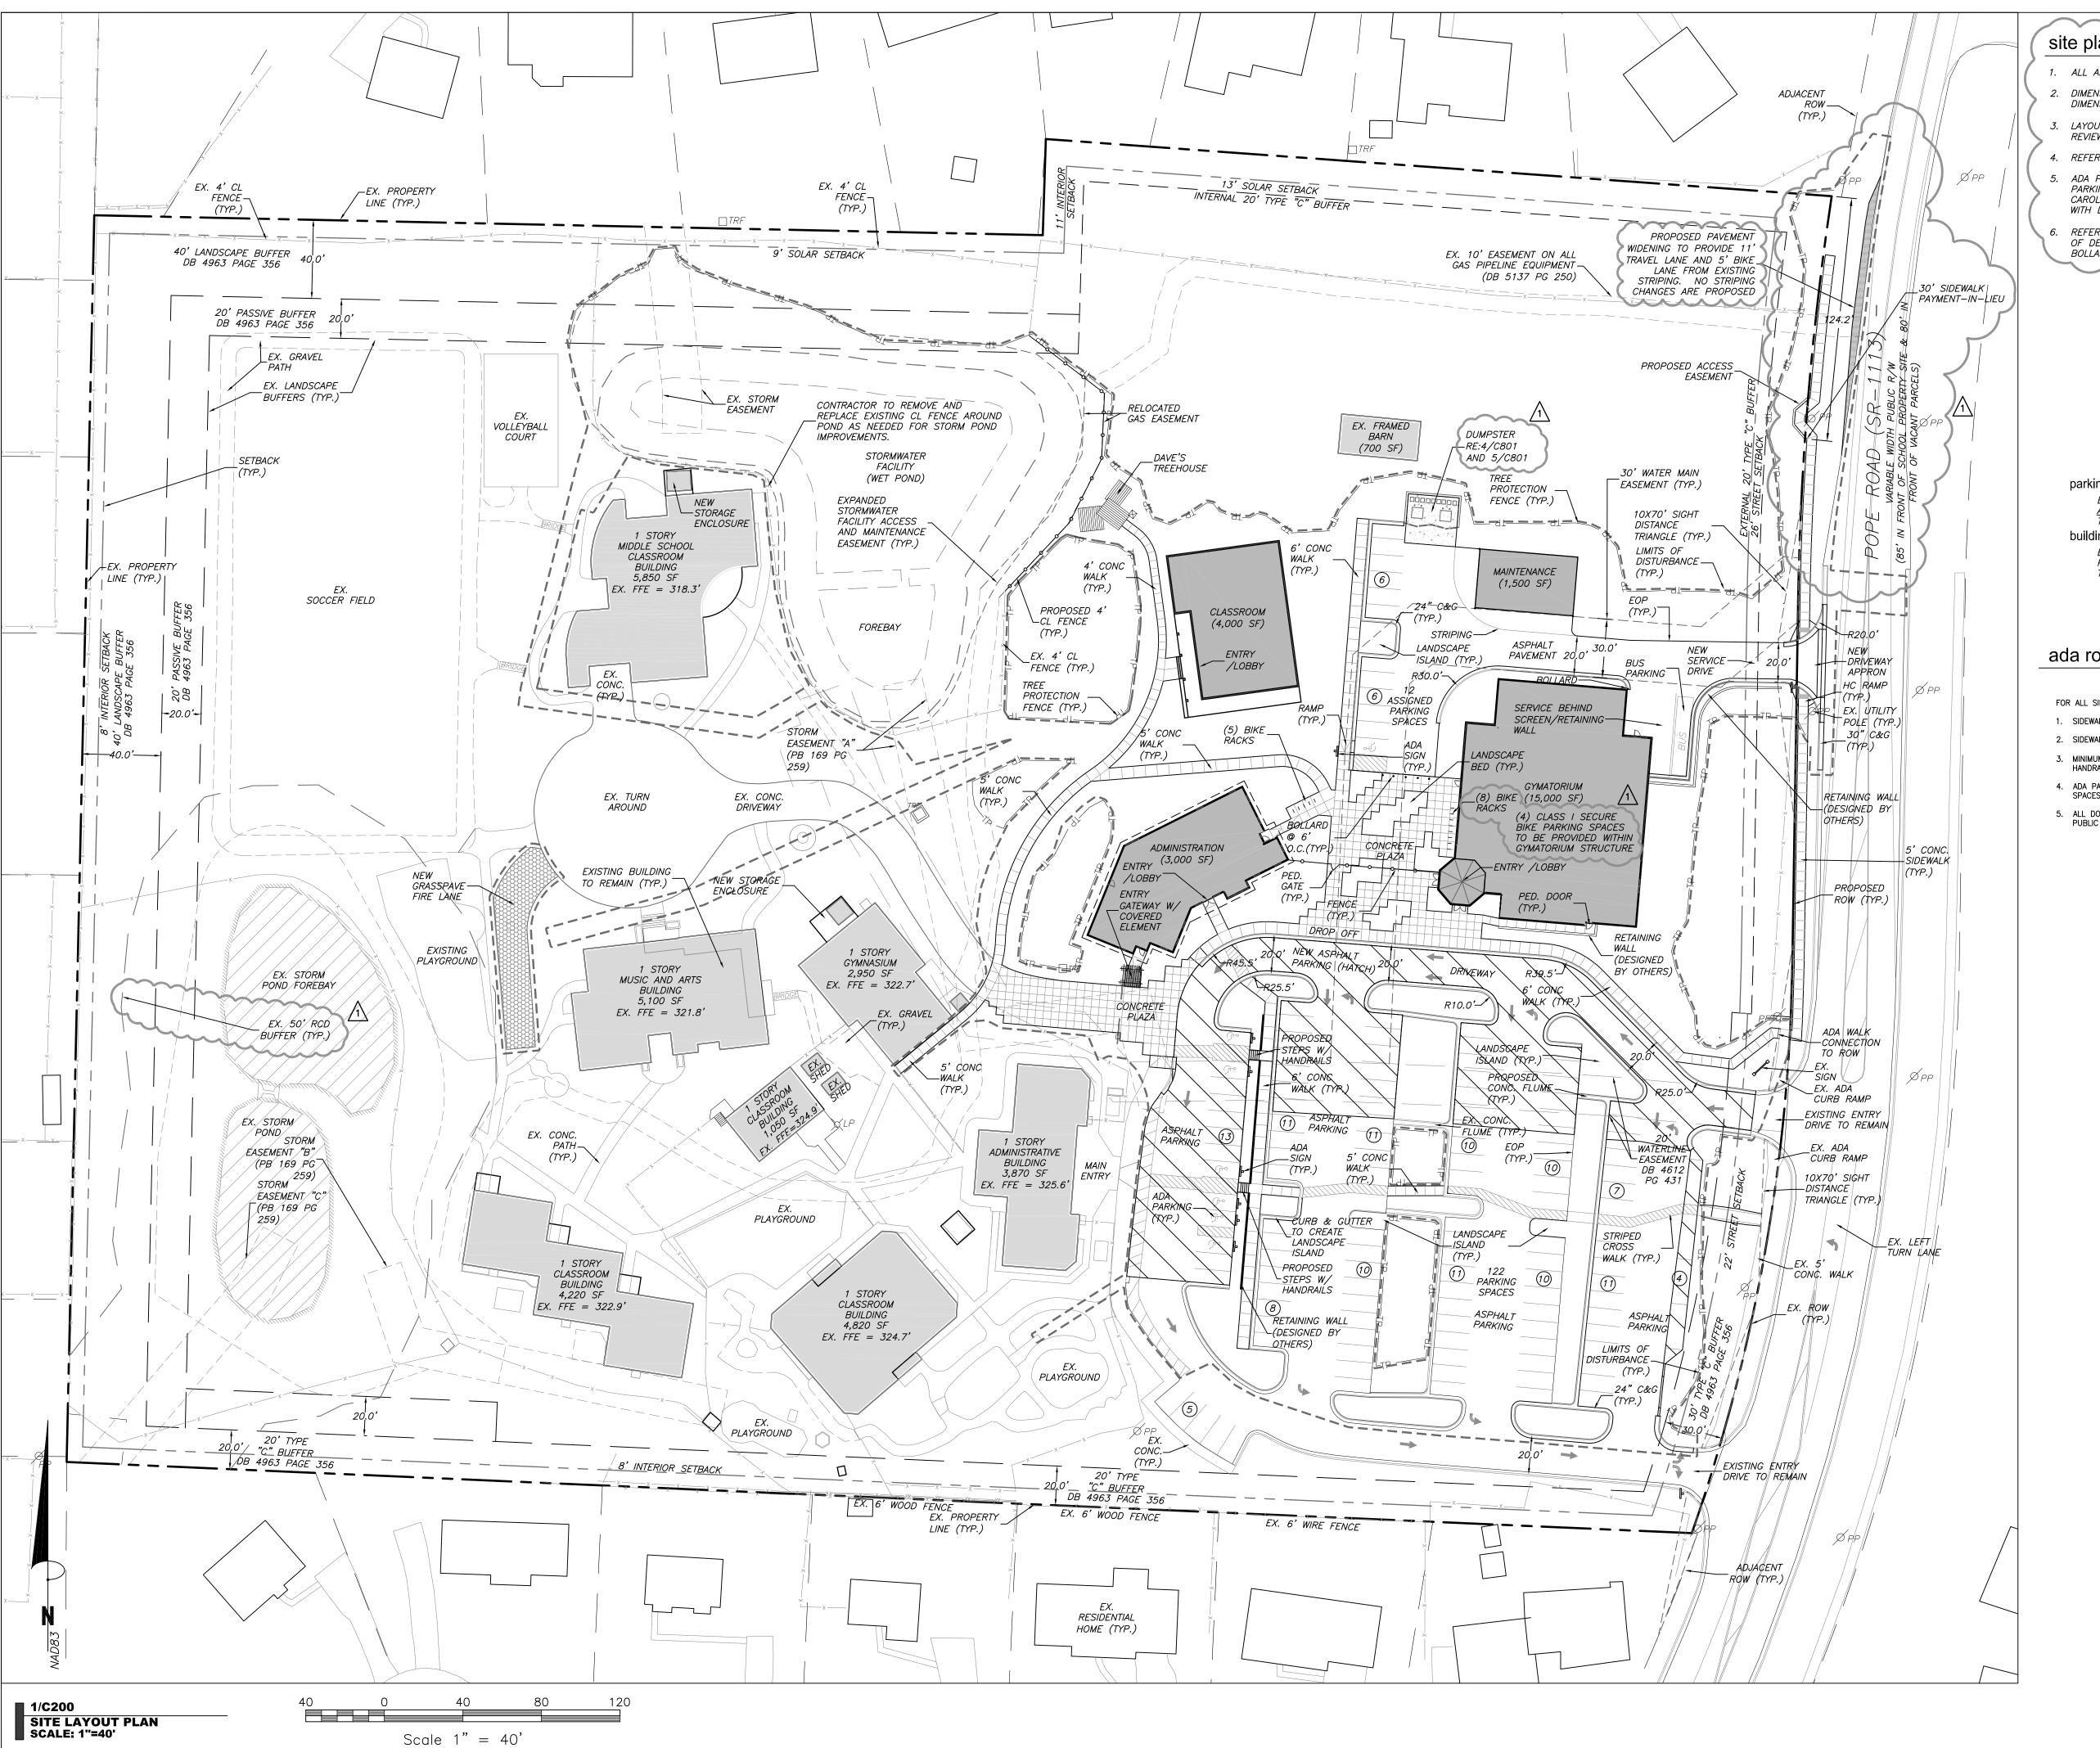
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SPECIAL USE PERMIT

Sheet Title

construction management

plan Sheet Number



#### site plan notes

- 1. ALL ANGLES ARE 90 DEGREES UNLESS OTHERWISE NOTED.
- 2. DIMENSIONS TO BUILDING WALL ARE TO FACE OF WALL AT FINISH GRADE. DIMENSIONS TO CURB ARE TO FACE OF CURB.
- 3. LAYOUT IMPROVEMENTS FOR THE CIVIL ENGINEER'S OR LANDSCAPE ARCHITECT'S REVIEW PRIOR TO BEGINNING CONSTRUCTION.
- 4. REFERENCE ARCHITECTURAL DRAWINGS FOR BUILDING LAYOUT INFORMATION.
- 5. ADA PARKING SPACES SHALL BE SIGNED WITH TYPE R7-8 OR R7-8A RESERVED PARKING SIGN AND R7-8D MAXIMUM FINE SIGN PER GS 20-37.6 OF THE NORTH CAROLINA HANDICAP CODE. ADA RAMPS SHALL HAVE RAMP SURFACES COVERED WITH DETECTABLE WARNING PATTERN PER ADA STANDARDS.
- REFERENCE EXISTING CONDITION / DEMOLITION PLAN SHEETS C100 FOR EXTENT OF DEMOLITION AND REMOVAL OF CURB AND GUTTER, DRIVEWAYS, PAVEMENT, BOLLARDS, WALKWAYS, UTILITIES, AND VEGETATION.

parking summary	
EXISTING PARKING: ADDITIONAL PARKING PROPOSED:	93 SPACES 40 SPACES
TOTAL PROPOSED PARKING: building summary	133 SPACES
EXISTING SQUARE FOOTAGE:	28.890 SF
PROPOSED ADDITIONAL BUILDING AREA: TOTAL BUILDING AREA POST CONSTRUCTION:	23,550 SF 52,440 SF

#### ada route notes apply to all sheets

#### FOR ALL SIDEWALKS THE FOLLOWING APPLIES:

- 1. SIDEWALK SLOPES TO BE A MAXIMUM 4.8%.
- 2. SIDEWALK CROSS SLOPES TO BE A MAXIMUM 1.8%.
- 3. MINIMUM 1' SHOULDER AT MAXIMUM 2% SLOPE ADJACENT TO ADA PAVED ROUTES UNLESS A HANDRAIL IS CALLED OUT.
- 4. ADA PARKING TO BE A MAXIMUM 1.8% SLOPE IN ANY DIRECTION FOR ENTIRE AREA PARKING
- 5. ALL DOORS EXITING THE BUILDING REQUIRE AN ADA ACCESSIBLE COMPLIANT ROUTE TO A



Thames<sub>ra</sub>

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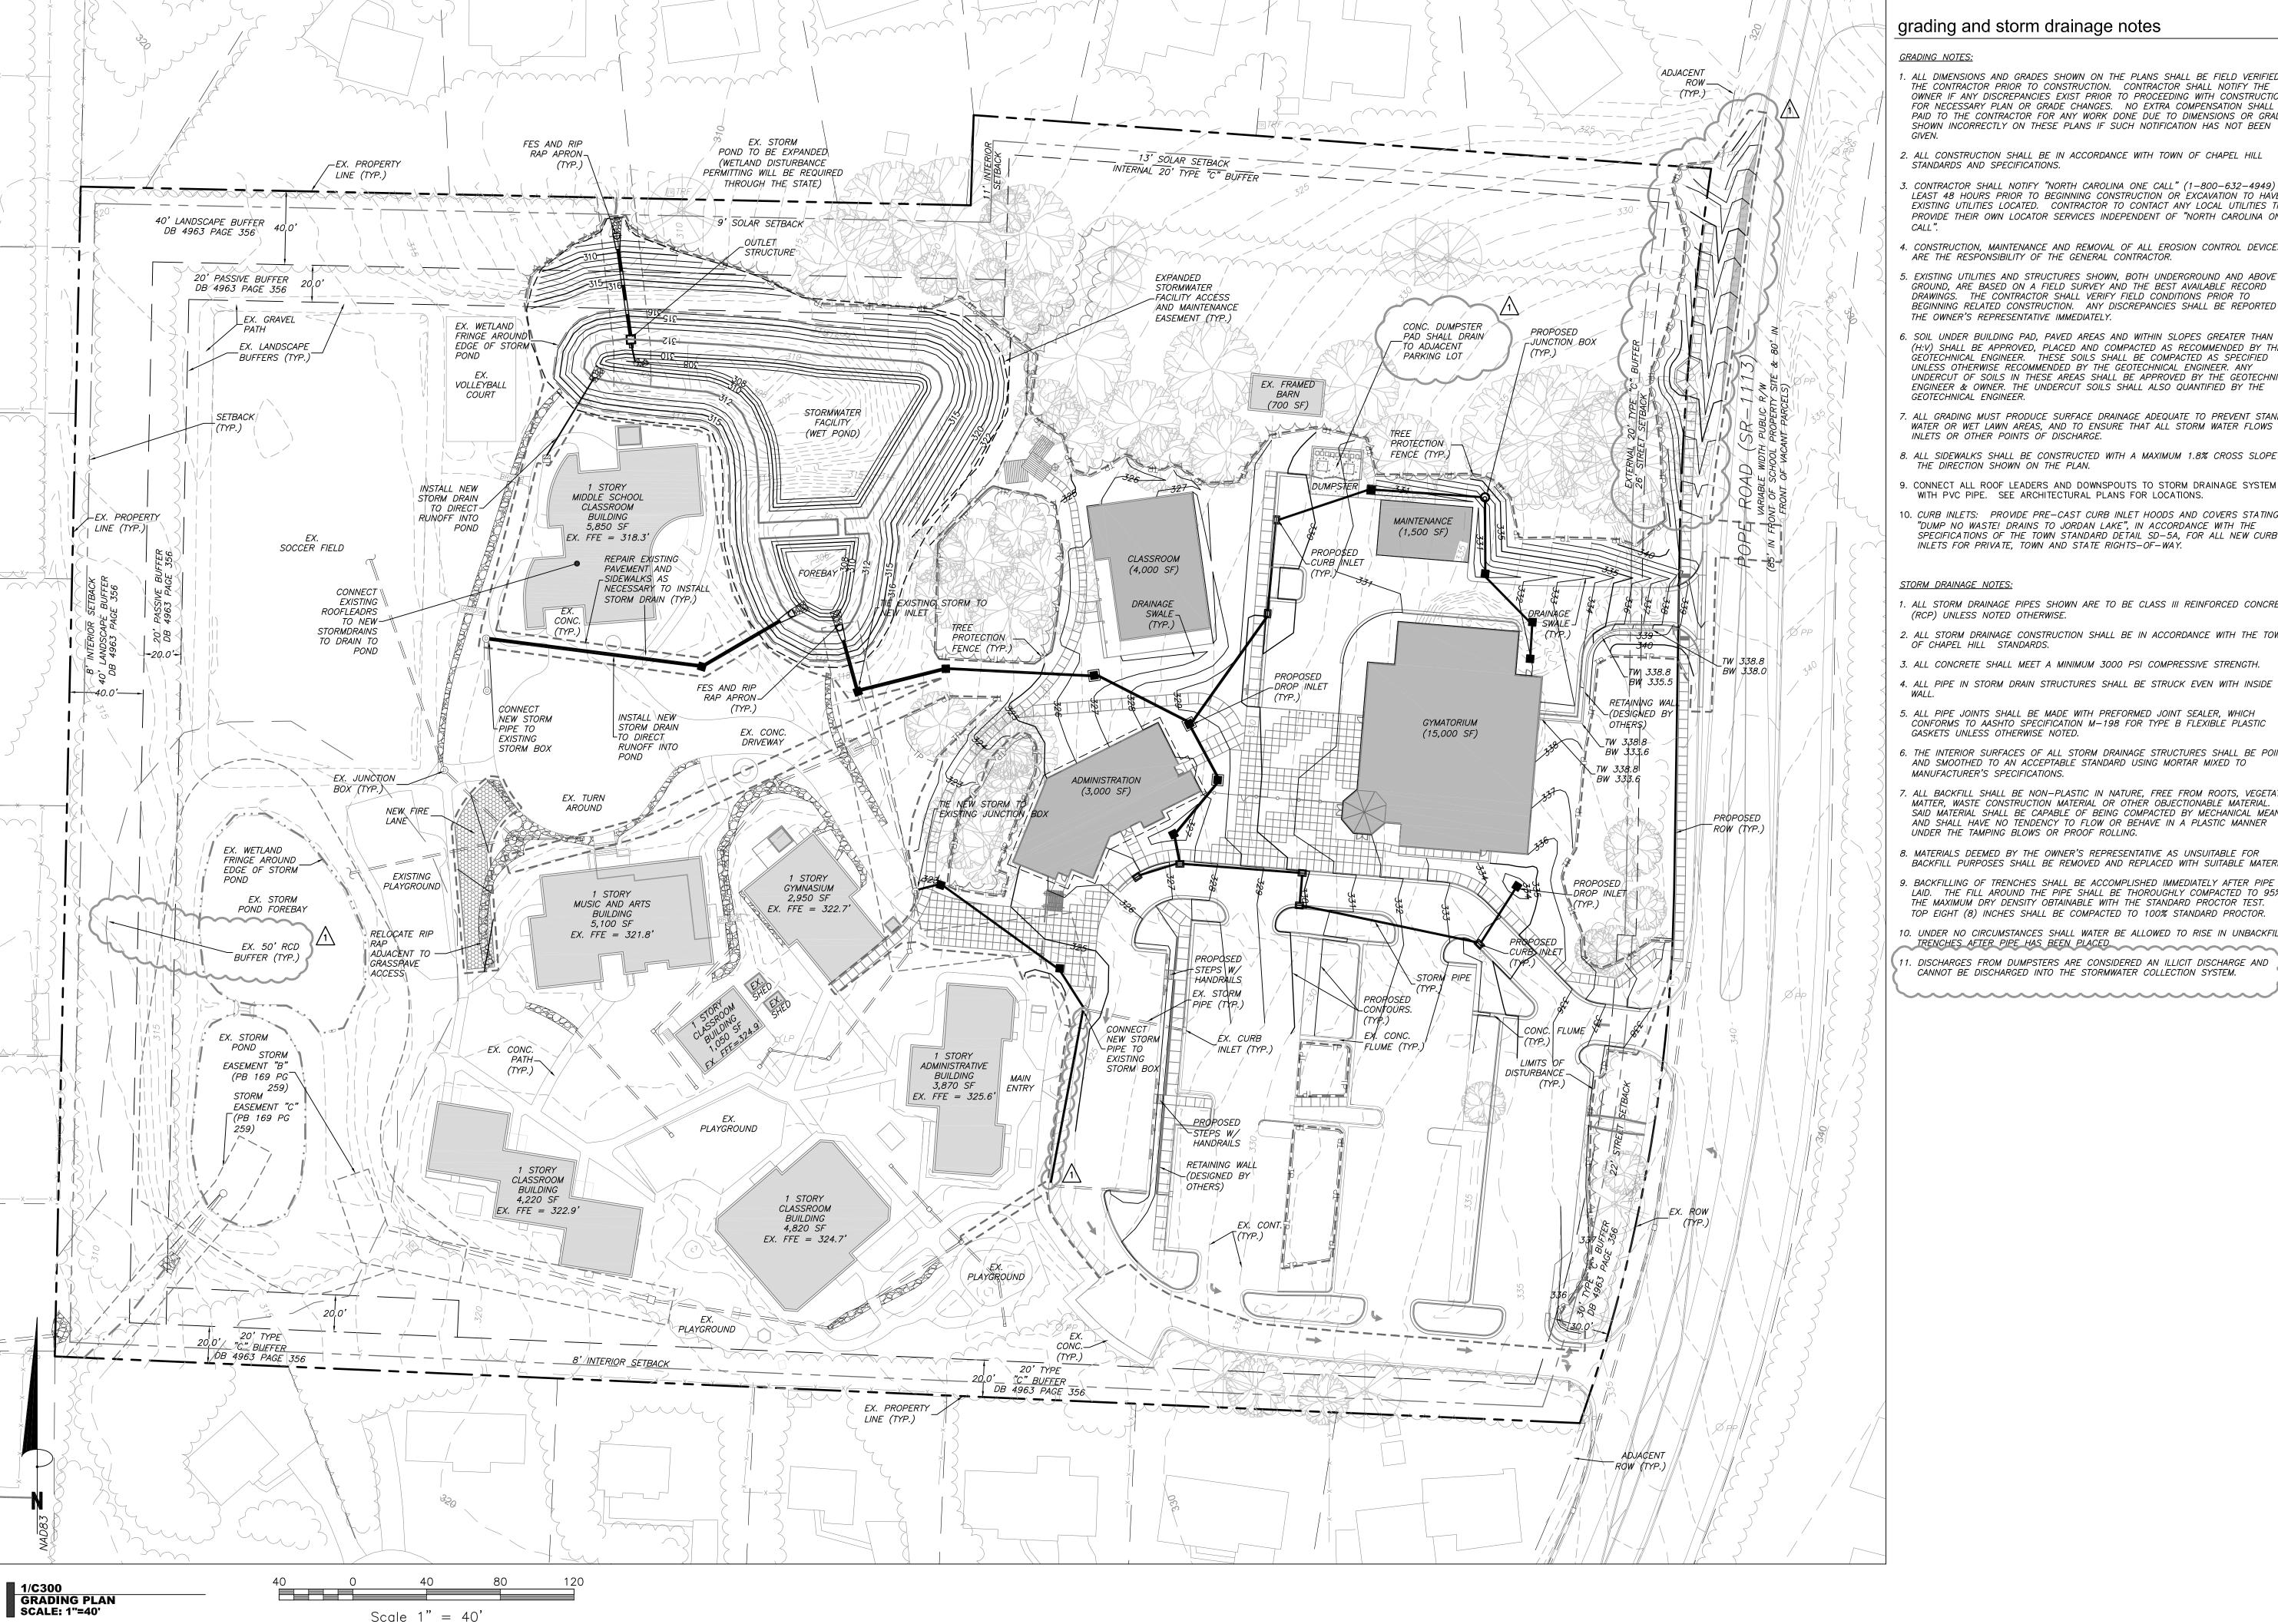
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SPECIAL USE PERMIT

Sheet Title:

site layout plan



## grading and storm drainage notes

- . ALL DIMENSIONS AND GRADES SHOWN ON THE PLANS SHALL BE FIELD VERIFIED BY THE CONTRACTOR PRIOR TO CONSTRUCTION. CONTRACTOR SHALL NOTIFY THE OWNER IF ANY DISCREPANCIES EXIST PRIOR TO PROCEEDING WITH CONSTRUCTION FOR NECESSARY PLAN OR GRADE CHANGES. NO EXTRA COMPENSATION SHALL BE PAID TO THE CONTRACTOR FOR ANY WORK DONE DUE TO DIMENSIONS OR GRADES SHOWN INCORRECTLY ON THESE PLANS IF SUCH NOTIFICATION HAS NOT BEEN
  - 2. ALL CONSTRUCTION SHALL BE IN ACCORDANCE WITH TOWN OF CHAPEL HILL STANDARDS AND SPECIFICATIONS.
  - 3. CONTRACTOR SHALL NOTIFY "NORTH CAROLINA ONE CALL" (1-800-632-4949) AT LEAST 48 HOURS PRIOR TO BEGINNING CONSTRUCTION OR EXCAVATION TO HAVE EXISTING UTILITIES LOCATED. CONTRACTOR TO CONTACT ANY LOCAL UTILITIES THAT PROVIDE THEIR OWN LOCATOR SERVICES INDEPENDENT OF "NORTH CAROLINA ONE
  - 4. CONSTRUCTION, MAINTENANCE AND REMOVAL OF ALL EROSION CONTROL DEVICES ARE THE RESPONSIBILITY OF THE GENERAL CONTRACTOR.
  - 5. EXISTING UTILITIES AND STRUCTURES SHOWN, BOTH UNDERGROUND AND ABOVE GROUND, ARE BASED ON A FIELD SURVEY AND THE BEST AVAILABLE RECORD DRAWINGS. THE CONTRACTOR SHALL VERIFY FIELD CONDITIONS PRIOR TO BEGINNING RELATED CONSTRUCTION. ANY DISCREPANCIES SHALL BE REPORTED TO THE OWNER'S REPRESENTATIVE IMMEDIATELY.
  - 6. SOIL UNDER BUILDING PAD, PAVED AREAS AND WITHIN SLOPES GREATER THAN 3:1 (H:V) SHALL BE APPROVED, PLACED AND COMPACTED AS RECOMMENDED BY THE GEÓTECHNICAL ENGINEER. THESE SOILS SHALL BE COMPACTED AS SPECIFIED UNLESS OTHERWISE RECOMMENDED BY THE GEOTECHNICAL ENGINEER. ANY UNDERCUT OF SOILS IN THESE AREAS SHALL BE APPROVED BY THE GEOTECHNICAL ENGINEER & OWNER. THE UNDERCUT SOILS SHALL ALSO QUANTIFIED BY THE GEOTECHNICAL ENGINEER.
  - 7. ALL GRADING MUST PRODUCE SURFACE DRAINAGE ADEQUATE TO PREVENT STANDING WATER OR WET LAWN AREAS, AND TO ENSURE THAT ALL STORM WATER FLOWS TO INLETS OR OTHER POINTS OF DISCHARGE.
  - 8. ALL SIDEWALKS SHALL BE CONSTRUCTED WITH A MAXIMUM 1.8% CROSS SLOPE IN THE DIRECTION SHOWN ON THE PLAN.
  - 9. CONNECT ALL ROOF LEADERS AND DOWNSPOUTS TO STORM DRAINAGE SYSTEM WITH PVC PIPE. SEE ARCHITECTURAL PLANS FOR LOCATIONS.
  - 10. CURB INLETS: PROVIDE PRE-CAST CURB INLET HOODS AND COVERS STATING, "DUMP NO WASTE! DRAINS TO JORDAN LAKE", IN ACCORDANCE WITH THE SPECIFICATIONS OF THE TOWN STANDARD DETAIL SD-5A, FOR ALL NEW CURB INLETS FOR PRIVATE, TOWN AND STATE RIGHTS-OF-WAY.

#### STORM DRAINAGE NOTES:

- . ALL STORM DRAINAGE PIPES SHOWN ARE TO BE CLASS III REINFORCED CONCRETE (RCP) UNLESS NOTED OTHERWISE.
- 2. ALL STORM DRAINAGE CONSTRUCTION SHALL BE IN ACCORDANCE WITH THE TOWN OF CHAPEL HILL STANDARDS.
- 3. ALL CONCRETE SHALL MEET A MINIMUM 3000 PSI COMPRESSIVE STRENGTH.
- 5. ALL PIPE JOINTS SHALL BE MADE WITH PREFORMED JOINT SEALER, WHICH CONFORMS TO AASHTO SPECIFICATION M-198 FOR TYPE B FLEXIBLE PLASTIC GASKETS UNLESS OTHERWISE NOTED.
- 6. THE INTERIOR SURFACES OF ALL STORM DRAINAGE STRUCTURES SHALL BE POINTED AND SMOOTHED TO AN ACCEPTABLE STANDARD USING MORTAR MIXED TO MANUFACTURER'S SPECIFICATIONS.
- 7. ALL BACKFILL SHALL BE NON-PLASTIC IN NATURE, FREE FROM ROOTS, VEGETATION MATTER, WASTE CONSTRUCTION MATERIAL OR OTHER OBJECTIONABLE MATERIAL. SAID MATERIAL SHALL BE CAPABLE OF BEING COMPACTED BY MECHANICAL MEANS AND SHALL HAVE NO TENDENCY TO FLOW OR BEHAVE IN A PLASTIC MANNER UNDER THE TAMPING BLOWS OR PROOF ROLLING.
- 8. MATERIALS DEEMED BY THE OWNER'S REPRESENTATIVE AS UNSUITABLE FOR BACKFILL PURPOSES SHALL BE REMOVED AND REPLACED WITH SUITABLE MATERIAL.
- 9. BACKFILLING OF TRENCHES SHALL BE ACCOMPLISHED IMMEDIATELY AFTER PIPE IS LAID. THE FILL AROUND THE PIPE SHALL BE THOROUGHLY COMPACTED TO 95% OF THE MAXIMUM DRY DENSITY OBTAINABLE WITH THE STANDARD PROCTOR TEST. THE TOP EIGHT (8) INCHES SHALL BE COMPACTED TO 100% STANDARD PROCTOR.
- 10. UNDER NO CIRCUMSTANCES SHALL WATER BE ALLOWED TO RISE IN UNBACKFILLED TRENCHES AFTER PIPE HAS BEEN PLACED.
- 11. DISCHARGES FROM DUMPSTERS ARE CONSIDERED AN ILLICIT DISCHARGE AND CANNOT BE DISCHARGED INTO THE STORMWATER COLLECTION SYSTEM.



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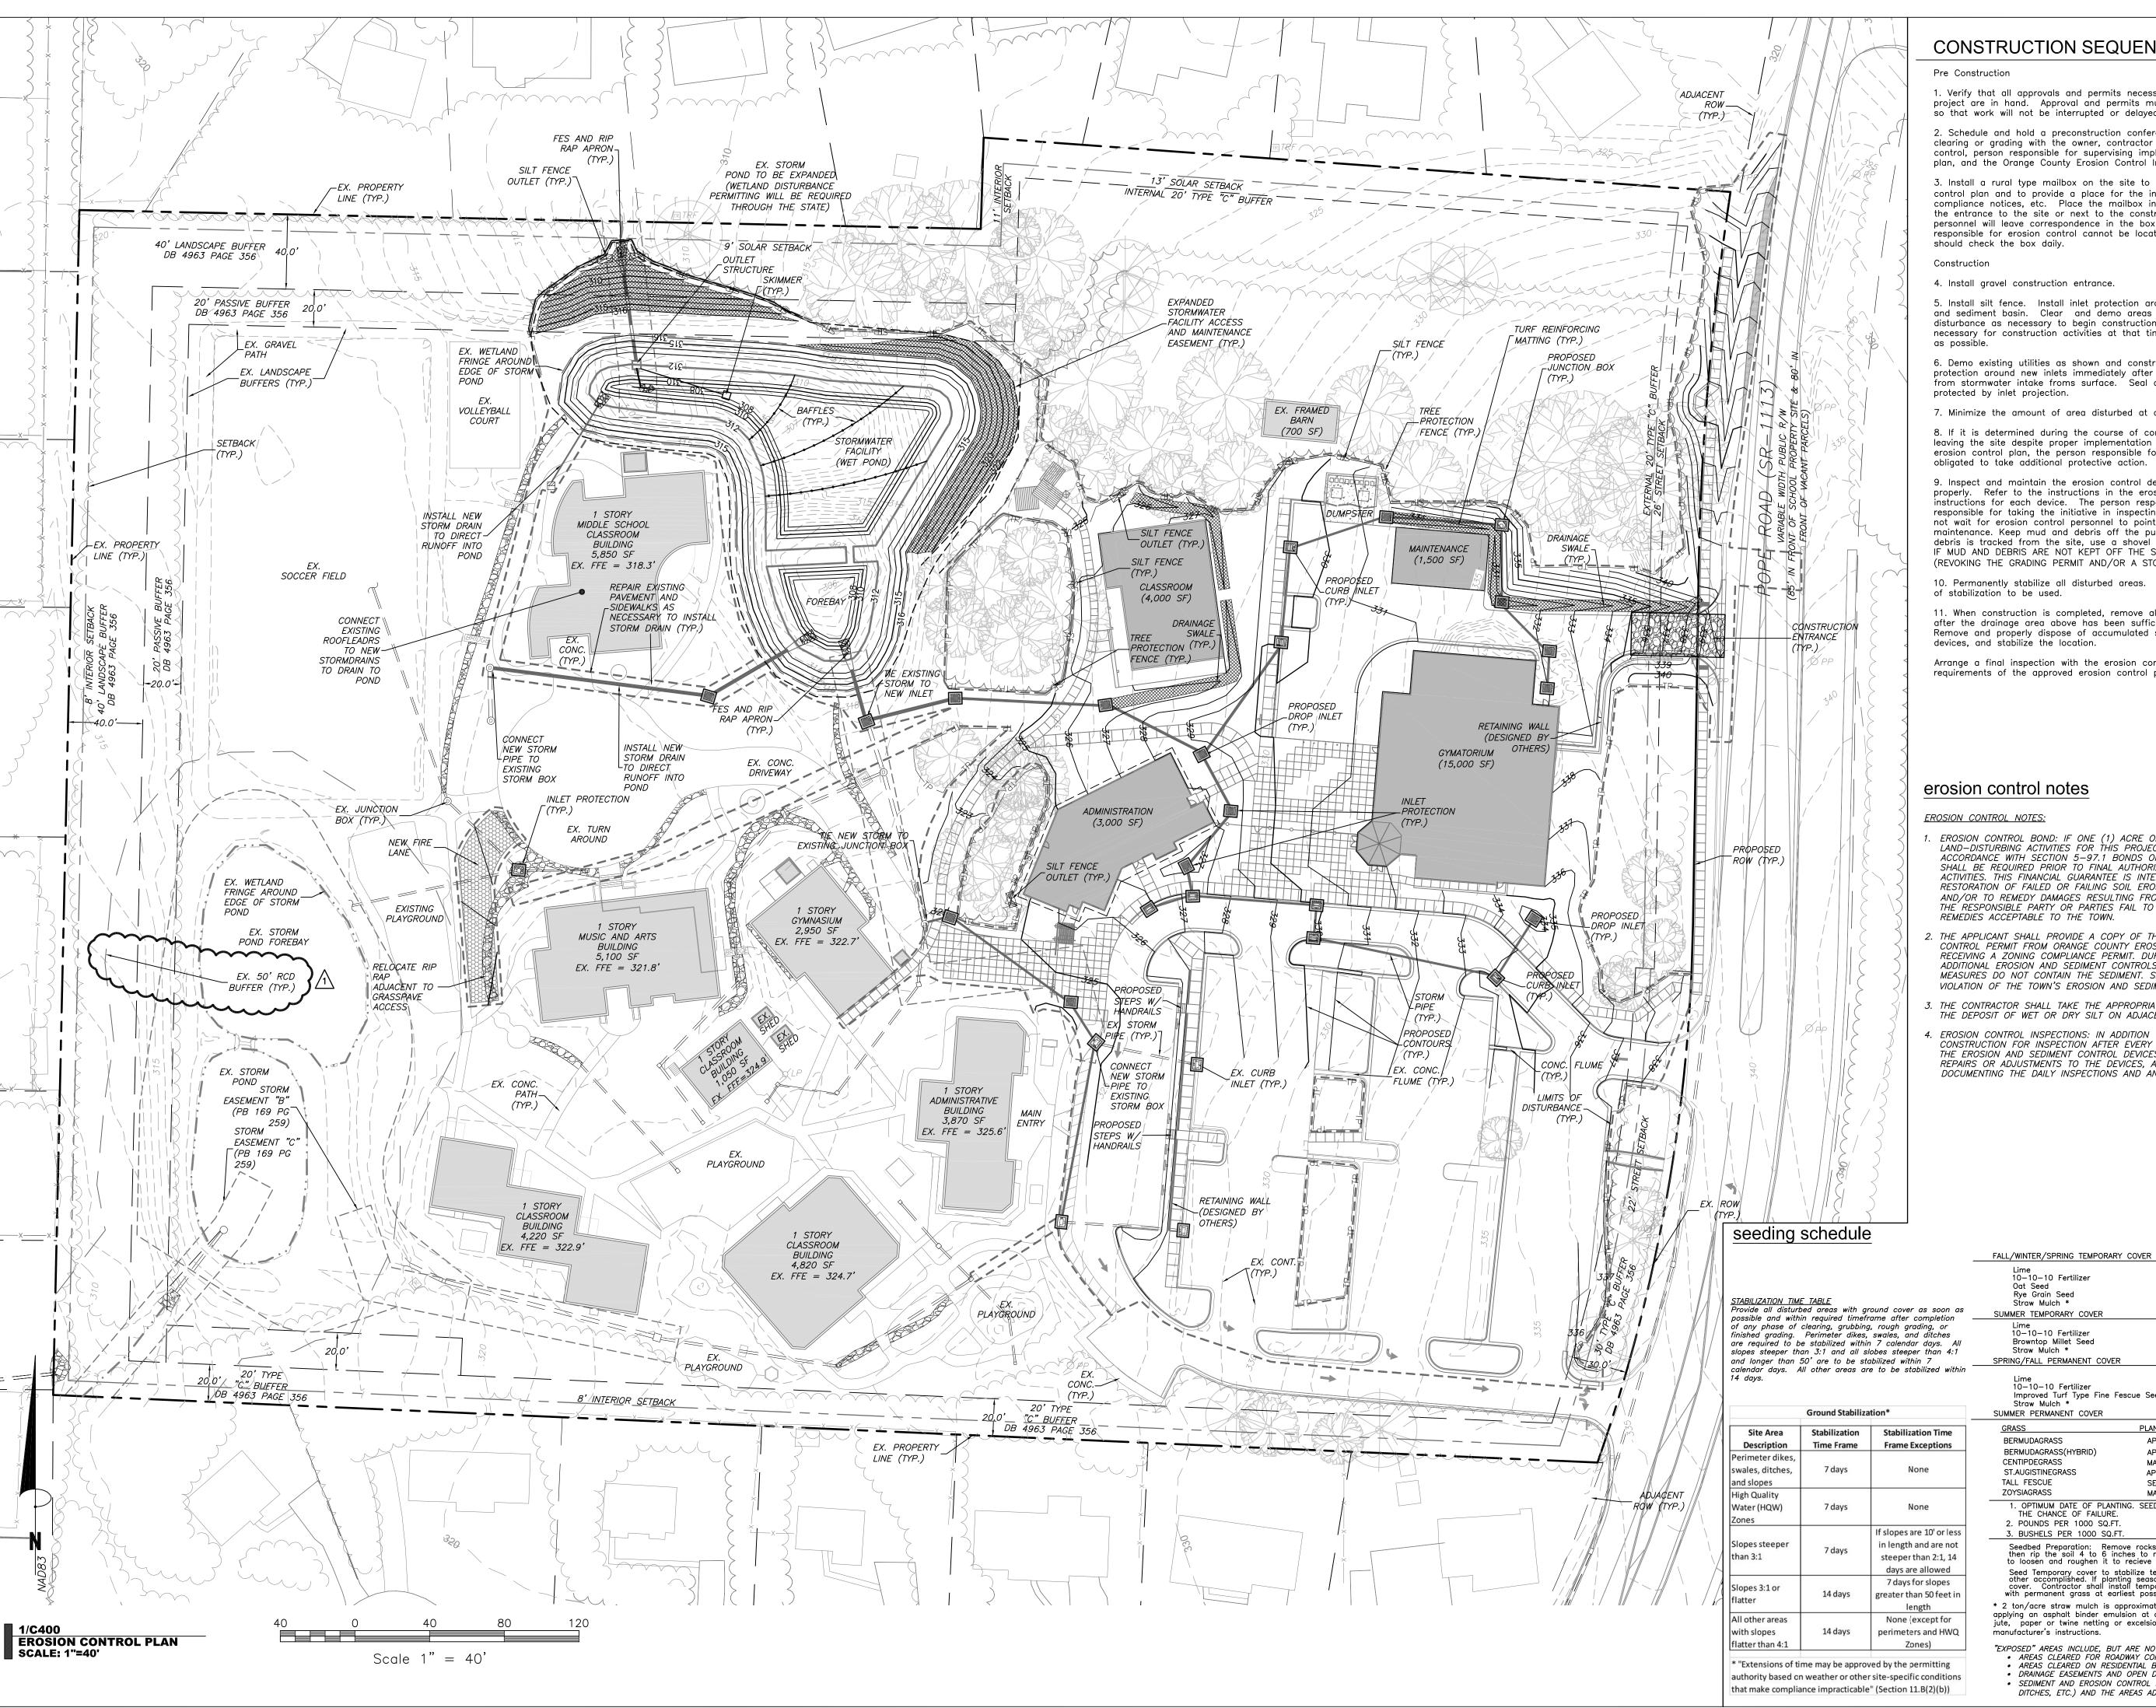
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SPECIAL USE PERMIT

Sheet Title:

grading and storm drainage plan

Sheet Number



#### **CONSTRUCTION SEQUENCE**

1. Verify that all approvals and permits necessary to begin and complete the project are in hand. Approval and permits must be obtained prior to disturbance so that work will not be interrupted or delayed due to the lack of approved plans.

2. Schedule and hold a preconstruction conference before starting demolition, clearing or grading with the owner, contractor responsible for grading and erosion control, person responsible for supervising implementation of the erosion control plan, and the Orange County Erosion Control Inspector.

3. Install a rural type mailbox on the site to hold a copy of the approved erosion control plan and to provide a place for the inspector(s) to leave inspection reports, compliance notices, etc. Place the mailbox in a convenient location, such as at the entrance to the site or next to the construction trailer. Erosion control personnel will leave correspondence in the box and raise the red flag if personnel responsible for erosion control cannot be located on the site. Site personnel

4. Install gravel construction entrance.

5. Install silt fence. Install inlet protection around existing inlets. Install swales and sediment basin. Clear and demo areas shown inside of the limits of disturbance as necessary to begin construction. Limit disturbance to areas necessary for construction activities at that time. Stabilize disturbed areas as soon

6. Demo existing utilities as shown and construct new storm drainage. Install inlet protection around new inlets immediately after construction. Seal all junction boxes from stormwater intake froms surface. Seal any inlets to stormwater structures not

- 7. Minimize the amount of area disturbed at any one time.
- 8. If it is determined during the course of construction that significant sediment is leaving the site despite proper implementation and maintenance of the approved erosion control plan, the person responsible for the land disturbing activity is obligated to take additional protective action.

9. Inspect and maintain the erosion control devices so they continue to function properly. Refer to the instructions in the erosion control plan for specific instructions for each device. The person responsible for erosion control is also responsible for taking the initiative in inspecting and maintaining these devices. Do not wait for erosion control personnel to point out the need for repairs and maintenance. Keep mud and debris off the public street at all times. If mud or debris is tracked from the site, use a shovel and broom to remove it immediately. IF MUD AND DEBRIS ARE NOT KEPT OFF THE STREET, ENFORCEMENT ACTION (REVOKING THE GRADING PERMIT AND/OR A STOP WORK ORDER) MAY BE TAKEN!!

- 10. Permanently stabilize all disturbed areas. Refer to seeding schedule for types of stabilization to be used.
- 11. When construction is completed, remove all temporary erosion control devices after the drainage area above has been sufficiently stabilized to restrain erosion. Remove and properly dispose of accumulated sediment and the debris from the devices, and stabilize the location.

Arrange a final inspection with the erosion control inspector to confirm that all requirements of the approved erosion control plan have been completed.

#### **EROSION CONTROL NOTES:**

- EROSION CONTROL BOND: IF ONE (1) ACRE OR MORE IS UNCOVERED BY LAND—DISTURBING ACTIVITIES FOR THIS PROJECT, THEN A PERFORMANCE GUARANTEE II ACCORDANCE WITH SECTION 5-97.1 BONDS OF THE TOWN CODE OF ORDINANCES SHALL BE REQUIRED PRIOR TO FINAL AUTHORIZATION TO BEGIN LAND-DISTURBING ACTIVITIES. THIS FINANCIAL GUARANTEE IS INTENDED TO COVER THE COSTS OF RESTORATION OF FAILED OR FAILING SOIL EROSION AND SEDIMENTATION CONTROLS, AND/OR TO REMEDY DAMAGES RESULTING FROM LAND-DISTURBING ACTIVITIES, SHOULD HE RESPONSIBLE PARTY OR PARTIES FAIL TO PROVIDE PROMPT AND EFFECTIVE
- THE APPLICANT SHALL PROVIDE A COPY OF THE APPROVED EROSION AND SEDIMENT CONTROL PERMIT FROM ORANGE COUNTY EROSION CONTROL DIVISION PRIOR TO RECEIVING A ZONING COMPLIANCE PERMIT. DURING THE CONSTRUCTION PHASE. ADDITIONAL EROSION AND SEDIMENT CONTROLS MAY BE REQUIRED IF THE PROPOSED MEASURES DO NOT CONTAIN THE SEDIMENT. SEDIMENT LEAVING THE PROPERTY IS A VIOLATION OF THE TOWN'S EROSION AND SEDIMENT CONTROL ORDINANCE.
- THE CONTRACTOR SHALL TAKE THE APPROPRIATE MEASURES TO PREVENT AND REMOVE THE DEPOSIT OF WET OR DRY SILT ON ADJACENT PAVED ROADWAYS.
- 4. EROSION CONTROL INSPECTIONS: IN ADDITION TO THE REQUIREMENT DURING CONSTRUCTION FOR INSPECTION AFTER EVERY RAINFALL, THE APPLICANT SHALL INSPEC THE EROSION AND SEDIMENT CONTROL DEVICES WEEKLY, MAKE ANY NECESSARY REPAIRS OR ADJUSTMENTS TO THE DEVICES, AND MAINTAIN INSPECTION LOGS DOCUMENTING THE DAILY INSPECTIONS AND ANY NECESSARY REPAIRS.

TION TIME TABLE	10-10-10 Fertilizer Oat Seed Rye Grain Seed Straw Mulch *	25 lbs/1000 sf 2 lbs/1000 sf 1 lbs/1000 sf 2 ton/acre
ll disturbed areas with ground cover as soon as and within required timeframe after completion —	SUMMER TEMPORARY COVER	MAY 1 - AUGUST 15
nase of clearing, grubbing, rough grading, or nrading. Perimeter dikes, swales, and ditches red to be stabilized within 7 calendar days. All seper than 3:1 and all slobes steeper than 4:1	Lime 10—10—10 Fertilizer Browntop Millet Seed Straw Mulch *	2 ton/acre or per soil test 15 lbs/1000 sf 1 lbs/1000 sf 2 ton/acre
er than 50' are to be stabilized within 7	SPRING/FALL PERMANENT COVER	MARCH 1 - APRIL 30
days. All other areas are to be stabilized within		AUGUST 16 - OCTOBER 31
	Lime	2 ton/acre or per soil test

e Area	Stabilization	Stabilization Time	GRASS	PLA
ription	Time Frame	Frame Exceptions	BERMUDAGRASS	Α
ter dikes, ditches, pes	7 days	None	BERMUDAGRASS(HYBRID) CENTIPDEGRASS ST.AUGISTINEGRASS TALL FESCUE	A M Al S
uality HQW)	7 days	None	ZOYSIAGRASS  1. OPTIMUM DATE OF PLANTING. THE CHANCE OF FAILURE. 2. POUNDS PER 1000 SQ.FT.	SEE
steeper 1	7 days	If slopes are 10' or less in length and are not steeper than 2:1, 14 days are allowed	3. BUSHELS PER 1000 SQ.FT.  Seedbed Preparation: Remove then rip the soil 4 to 6 inches to loosen and roughen it to rec	cieve
3:1 or	14 days	7 days for slopes greater than 50 feet in	Seed Temporary cover to stabili other accomplished. If planting cover. Contractor shall install with permanent grass at earliest  * 2 ton/acre straw mulch is appro-	pos

Lime 10-10-10 Fertilizer Improved Turf Type Fine F Straw Mulch * SUMMER PERMANENT COVER	escue Seed	2 ton APRIL	/acre or p 25 lbs/10 8 lbs/100 2 ton/c 1 — AUGUS	00 sf 00 sf icre
GRASS	PLANTING DATE <sup>1</sup>	SEEDS <sup>2</sup>	SPRIGS <sup>3</sup>	STOLON
BERMUDAGRASS	APRL-JULY	1-2	.75	3-5
BERMUDAGRASS(HYBRID)	APRL-JULY	-	.75	3-5
CENTIPDEGRASS	MARCH-JULY	.2550	.75	_
ST.AUGISTINEGRASS	APRIL-JULY	-	1.0	_

AUGUST 15 - MAY 1

2 ton/acre or per soil test

25 lbs/1000 sf 2 lbs/1000 sf 1 lbs/1000 sf

SEPT.-OCT.15 6 -MAY-JULY .50-1.0 .25 3-5 EDING BEYOND THESE DATES INCREASES

cks, stumps, roots, etc. Apply lime and fertilizer o mix the nutrients into the soil and temporary sedimentation control measures and ason is not suitable for installation of permanent nporary cover suitable for that season and reseed assible date.

\* 2 ton/acre straw mulch is approximately 90—95 bales/acre. Anchor straw mulch by applying an asphalt binder emulsion at a rate of 10 gallons per 1000 SF, or install jute, paper or twine netting or excelsior mats—staked to ground according to the manufacturer's instructions.

"EXPOSED" AREAS INCLUDE, BUT ARE NOT LIMITED TO:

• AREAS CLEARED FOR ROADWAY CONSTRUCTION.

• AREAS CLEARED ON RESIDENTIAL BUILDING LOTS.

DRAINAGE EASEMENTS AND OPEN DRAINAGE CHANNELS. • SEDIMENT AND EROSION CONTROL MEASURES (SEDIMENT TRAPS, DIVERSION DITCHES, ETC.) AND THE AREAS ADJECENT TO SUCH MEASURES.



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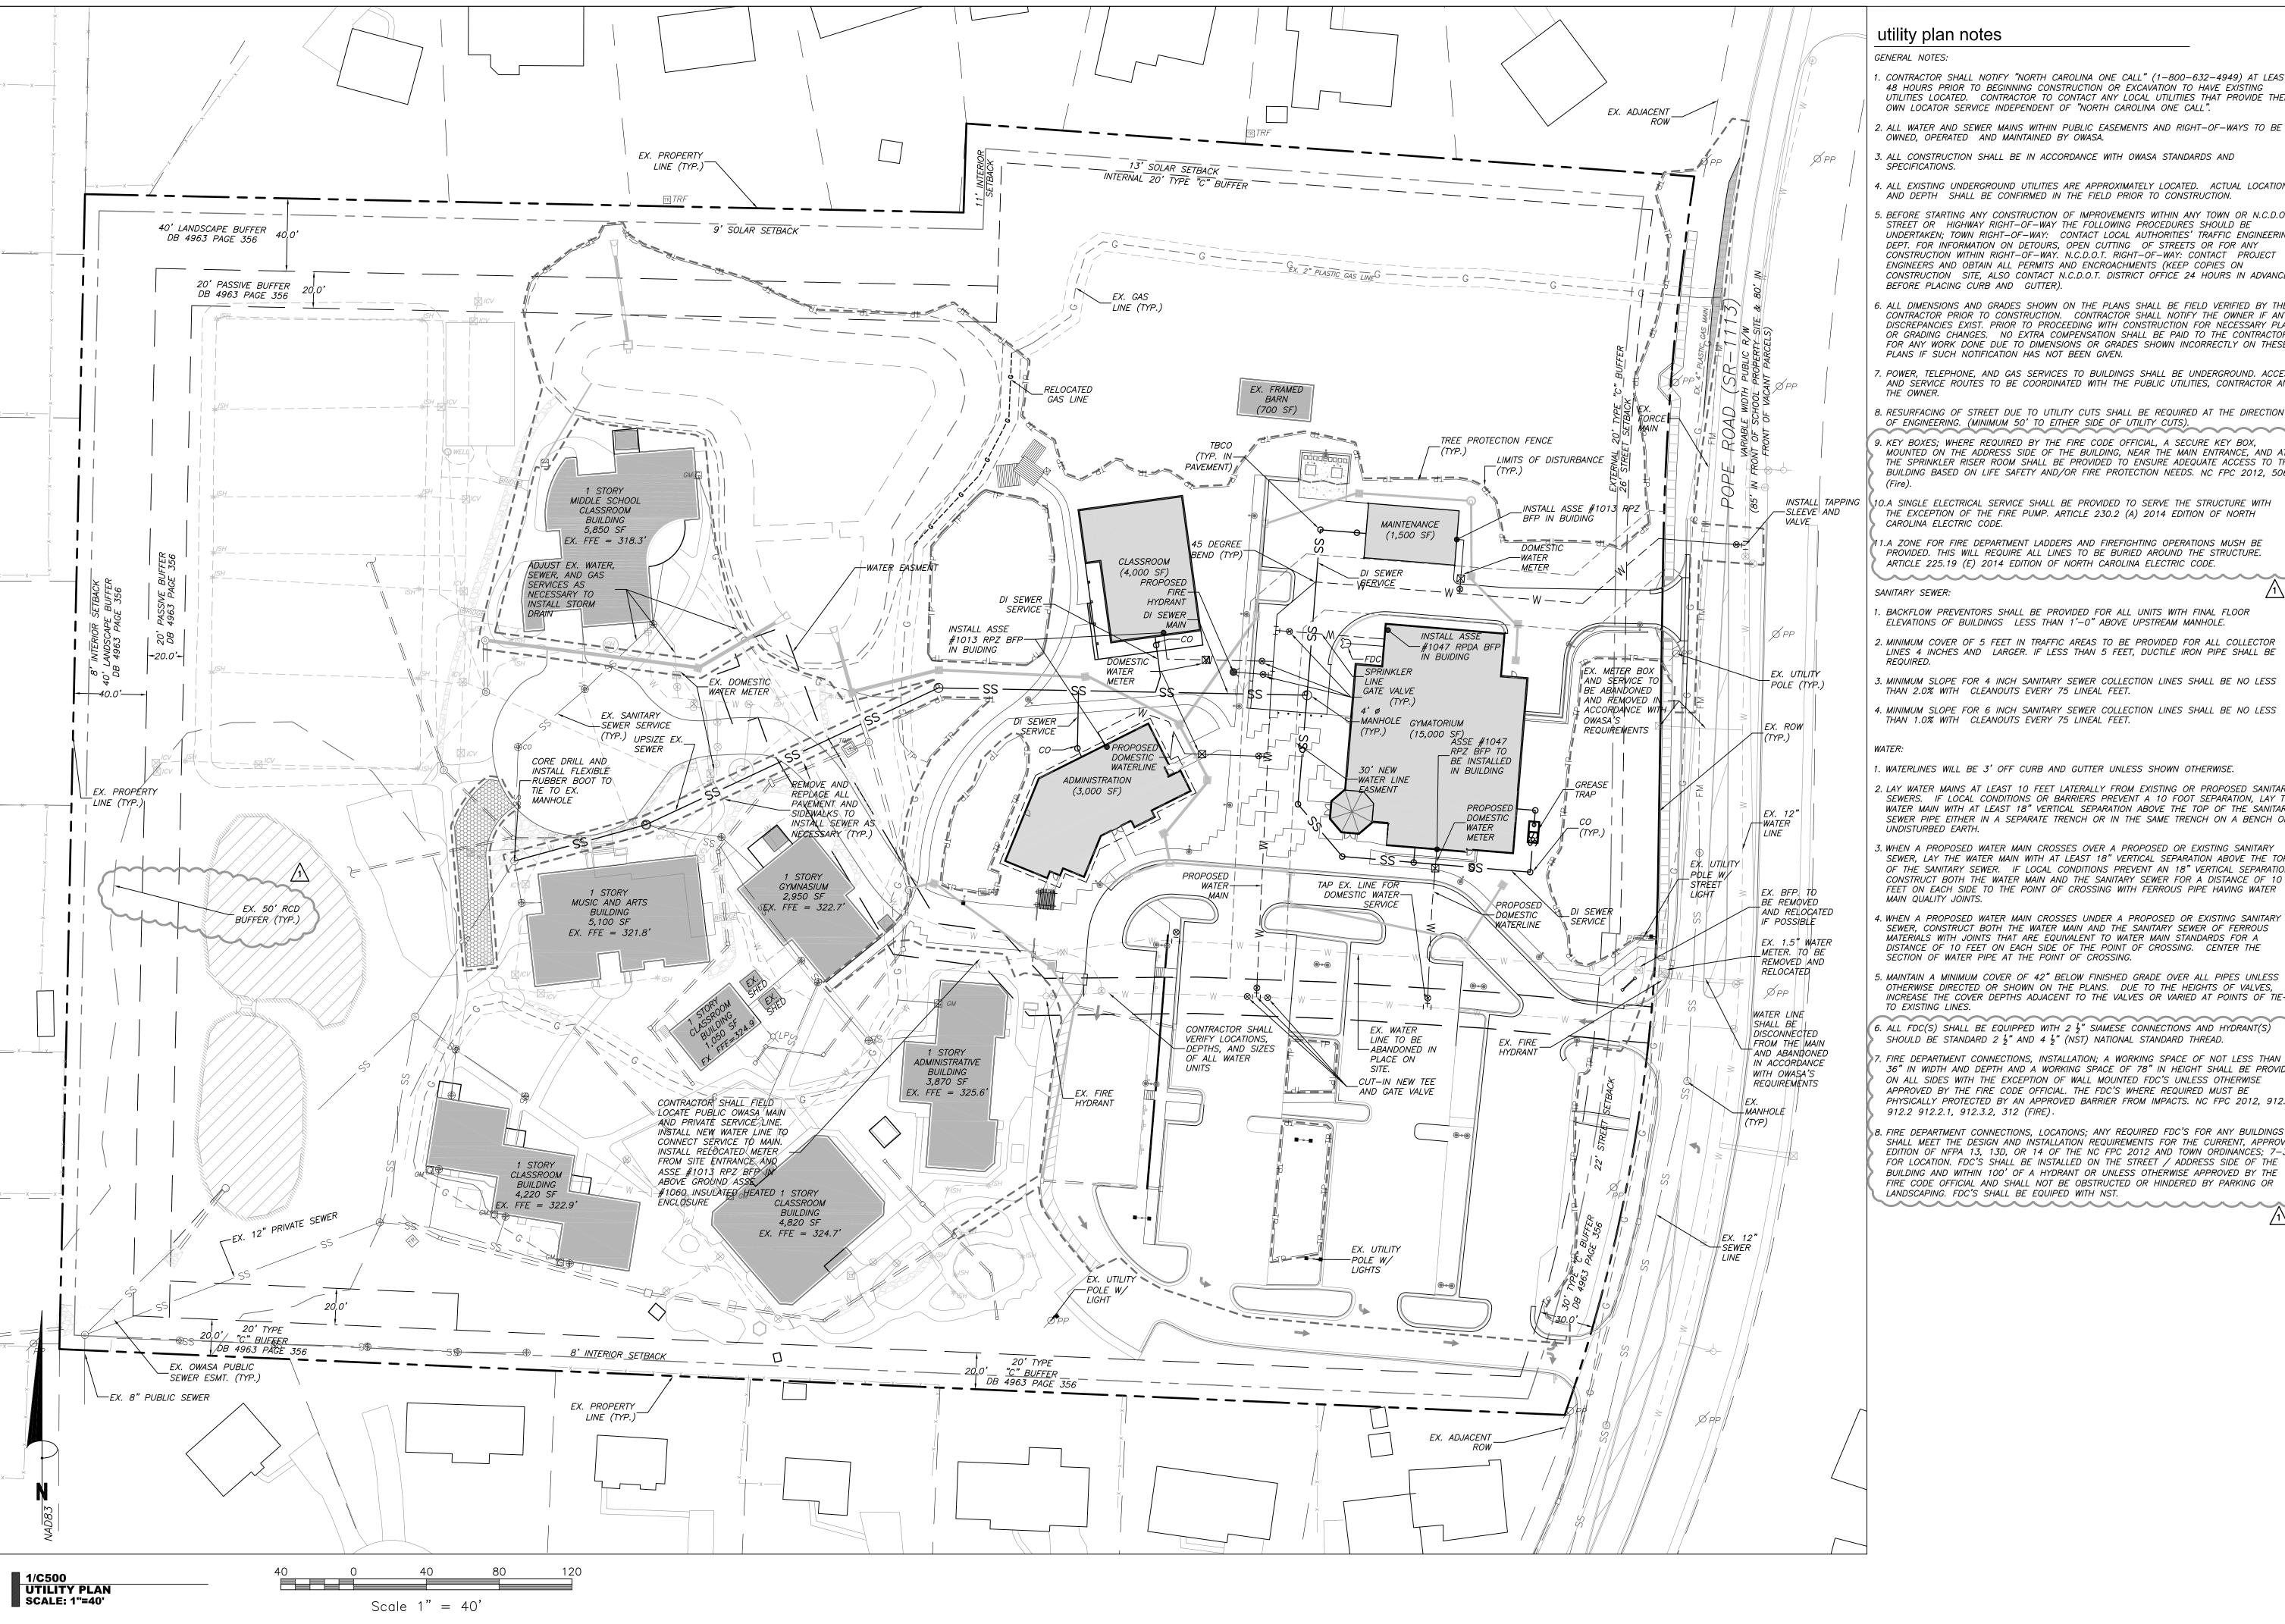
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Sheet Title:

erosion control plan



. CONTRACTOR SHALL NOTIFY "NORTH CAROLINA ONE CALL" (1—800—632—4949) AT LEAS 48 HOURS PRIOR TO BEGINNING CONSTRUCTION OR EXCAVATION TO HAVE EXISTING UTILITIES LOCATED. CONTRACTOR TO CONTACT ANY LOCAL UTILITIES THAT PROVIDE THEIR OWN LOCATOR SERVICE INDEPENDENT OF "NORTH CAROLINA ONE CALL".

2. ALL WATER AND SEWER MAINS WITHIN PUBLIC EASEMENTS AND RIGHT-OF-WAYS TO BE

3. ALL CONSTRUCTION SHALL BE IN ACCORDANCE WITH OWASA STANDARDS AND

4. ALL EXISTING UNDERGROUND UTILITIES ARE APPROXIMATELY LOCATED. ACTUAL LOCATION AND DEPTH SHALL BE CONFIRMED IN THE FIELD PRIOR TO CONSTRUCTION.

5. BEFORE STARTING ANY CONSTRUCTION OF IMPROVEMENTS WITHIN ANY TOWN OR N.C.D.O.T. STREET OR HIGHWAY RIGHT-OF-WAY THE FOLLOWING PROCEDURES SHOULD BE UNDERTAKEN; TOWN RIGHT-OF-WAY: CONTACT LOCAL AUTHORITIES' TRAFFIC ENGINEERING DEPT. FOR INFORMATION ON DETOURS, OPEN CUTTING OF STREETS OR FOR ANY CONSTRUCTION WITHIN RIGHT-OF-WAY. N.C.D.O.T. RIGHT-OF-WAY: CONTACT PROJECT ENGINEERS AND OBTAIN ALL PERMITS AND ENCROACHMENTS (KEEP COPIES ON CONSTRUCTION SITE, ALSO CONTACT N.C.D.O.T. DISTRICT OFFICE 24 HOURS IN ADVANCE

6. ALL DIMENSIONS AND GRADES SHOWN ON THE PLANS SHALL BE FIELD VERIFIED BY THE CONTRACTOR PRIOR TO CONSTRUCTION. CONTRACTOR SHALL NOTIFY THE OWNER IF ANY DISCREPANCIES EXIST. PRIOR TO PROCEEDING WITH CONSTRUCTION FOR NECESSARY PLAN OR GRADING CHANGES. NO EXTRA COMPENSATION SHALL BE PAID TO THE CONTRACTOR FOR ANY WORK DONE DUE TO DIMENSIONS OR GRADES SHOWN INCORRECTLY ON THESE PLANS IF SUCH NOTIFICATION HAS NOT BEEN GIVEN.

. POWER, TELEPHONE, AND GAS SERVICES TO BUILDINGS SHALL BE UNDERGROUND. ACCESS AND SERVICE ROUTES TO BE COORDINATED WITH THE PUBLIC UTILITIES, CONTRACTOR AND

B. RESURFACING OF STREET DUE TO UTILITY CUTS SHALL BE REQUIRED AT THE DIRECTION OF ENGINEERING. (MINIMUM 50' TO EITHER SIDE OF UTILITY CUTS, 9. KEY BOXES; WHERE REQUIRED BY THE FIRE CODE OFFICIAL, A SECURE KEY BOX, MOUNTED ON THE ADDRESS SIDE OF THE BUILDING, NEAR THE MAIN ENTRANCE, AND AT THE SPRINKLER RISER ROOM SHALL BE PROVIDED TO ENSURE ADEQUATE ACCESS TO THE BUILDING BASED ON LIFE SAFETY AND/OR FIRE PROTECTION NEEDS. NC FPC 2012, 506

10.A SINGLE ELECTRICAL SERVICE SHALL BE PROVIDED TO SERVE THE STRUCTURE WITH THE EXCEPTION OF THE FIRE PUMP. ARTICLE 230.2 (A) 2014 EDITION OF NORTH CAROLINA ELECTRIC CODE.

1.A ZONE FOR FIRE DEPARTMENT LADDERS AND FIREFIGHTING OPERATIONS MUSH BE PROVIDED. THIS WILL REQUIRE ALL LINES TO BE BURIED AROUND THE STRUCTURE. ARTICLE 225.19 (E) 2014 EDITION OF NORTH CAROLINA ELECTRIC CODE.

BACKFLOW PREVENTORS SHALL BE PROVIDED FOR ALL UNITS WITH FINAL FLOOR ELEVATIONS OF BUILDINGS LESS THAN 1'-0" ABOVE UPSTREAM MANHOLE.

2. MINIMUM COVER OF 5 FEET IN TRAFFIC AREAS TO BE PROVIDED FOR ALL COLLECTOR LINES 4 INCHES AND LARGER. IF LESS THAN 5 FEET, DUCTILE IRON PIPE SHALL BE

3. MINIMUM SLOPE FOR 4 INCH SANITARY SEWER COLLECTION LINES SHALL BE NO LESS THAN 2.0% WITH CLEANOUTS EVERY 75 LINEAL FEET.

. MINIMUM SLOPE FOR 6 INCH SANITARY SEWER COLLECTION LINES SHALL BE NO LESS THAN 1.0% WITH CLEANOUTS EVERY 75 LINEAL FEET.

. WATERLINES WILL BE 3' OFF CURB AND GUTTER UNLESS SHOWN OTHERWISE.

P. LAY WATER MAINS AT LEAST 10 FEET LATERALLY FROM EXISTING OR PROPOSED SANITARY SEWERS. IF LOCAL CONDITIONS OR BARRIERS PREVENT A 10 FOOT SEPARATION, LAY THE WATER MAIN WITH AT LEAST 18" VERTICAL SEPARATION ABOVE THE TOP OF THE SANITARY SEWER PIPE EITHER IN A SEPARATE TRENCH OR IN THE SAME TRENCH ON A BENCH OF

3. WHEN A PROPOSED WATER MAIN CROSSES OVER A PROPOSED OR EXISTING SANITARY SEWER, LAY THE WATER MAIN WITH AT LEAST 18" VERTICAL SEPARATION ABOVE THE TOP CONSTRUCT BOTH THE WATER MAIN AND THE SANITARY SEWER FOR A DISTANCE OF 10 FEET ON EACH SIDE TO THE POINT OF CROSSING WITH FERROUS PIPE HAVING WATER

4. WHEN A PROPOSED WATER MAIN CROSSES UNDER A PROPOSED OR EXISTING SANITARY SEWER, CONSTRUCT BOTH THE WATER MAIN AND THE SANITARY SEWER OF FERROUS MATERIALS WITH JOINTS THAT ARE EQUIVALENT TO WATER MAIN STANDARDS FOR A DISTANCE OF 10 FEET ON EACH SIDE OF THE POINT OF CROSSING. CENTER THE SECTION OF WATER PIPE AT THE POINT OF CROSSING.

5. MAINTAIN A MINIMUM COVER OF 42" BELOW FINISHED GRADE OVER ALL PIPES UNLESS OTHERWISE DIRECTED OR SHOWN ON THE PLANS. DUE TO THE HEIGHTS OF VALVES, INCREASE THE COVER DEPTHS ADJACENT TO THE VALVES OR VARIED AT POINTS OF TIE-IN

6. ALL FDC(S) SHALL BE EQUIPPED WITH  $2\frac{1}{2}$ " SIAMESE CONNECTIONS AND HYDRANT(S) SHOULD BE STANDARD 2  $\frac{1}{2}$ " AND 4  $\frac{1}{2}$ " (NST) NATIONAL STANDARD THREAD.

7. FIRE DEPARTMENT CONNECTIONS, INSTALLATION; A WORKING SPACE OF NOT LESS THAN 36" IN WIDTH AND DEPTH AND A WORKING SPACE OF 78" IN HEIGHT SHALL BE PROVIDED ON ALL SIDES WITH THE EXCEPTION OF WALL MOUNTED FDC'S UNLESS OTHERWISE APPROVED BY THE FIRE CODE OFFICIAL. THE FDC'S WHERE REQUIRED MUST BE PHYSICALLY PROTECTED BY AN APPROVED BARRIER FROM IMPACTS. NC FPC 2012, 912.1, 912.2 912.2.1, 912.3.2, 312 (FIRE).

8. FIRE DEPARTMENT CONNECTIONS, LOCATIONS; ANY REQUIRED FDC'S FOR ANY BUILDINGS SHALL MEET THE DESIGN AND INSTALLATION REQUIREMENTS FOR THE CURRENT, APPROVED EDITION OF NFPA 13, 13D, OR 14 OF THE NC FPC 2012 AND TOWN ORDINANCES; 7-38 FOR LOCATION. FDC'S SHALL BE INSTALLED ON THE STREET / ADDRESS SIDE OF THE BUILDING AND WITHIN 100' OF A HYDRANT OR UNLESS OTHERWISE APPROVED BY THE FIRE CODE OFFICIAL AND SHALL NOT BE OBSTRUCTED OR HINDERED BY PARKING OR LANDSCAPING. FDC'S SHALL BE EQUIPED WITH NST. 



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NC BOARD OF EXAMINERS FOR ENGINEERS AND SURVEYORS LIC # C-1209 NC BOARD OF LANDSCAPE ARCHITECTS LIC # C-104



Project:

**MONTESSORI COMMUNITY** *SCHOOL* CAMPUS **EXPANSION** 

4512 Pope Rd. Durham, NC 27707

Town of Chapel Hill Planning Jurisdiction

North Carolina

Durham County,

0709-03-04-0858

PRELIMINARY- NOT FOR CONSTRUCTION

Job Number: 1337


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Checked PBR, AJP 2-23-2017 
 Date
 2-23-2017

 Revisions
 1.7-21-17


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Sheet Title:

utility plan



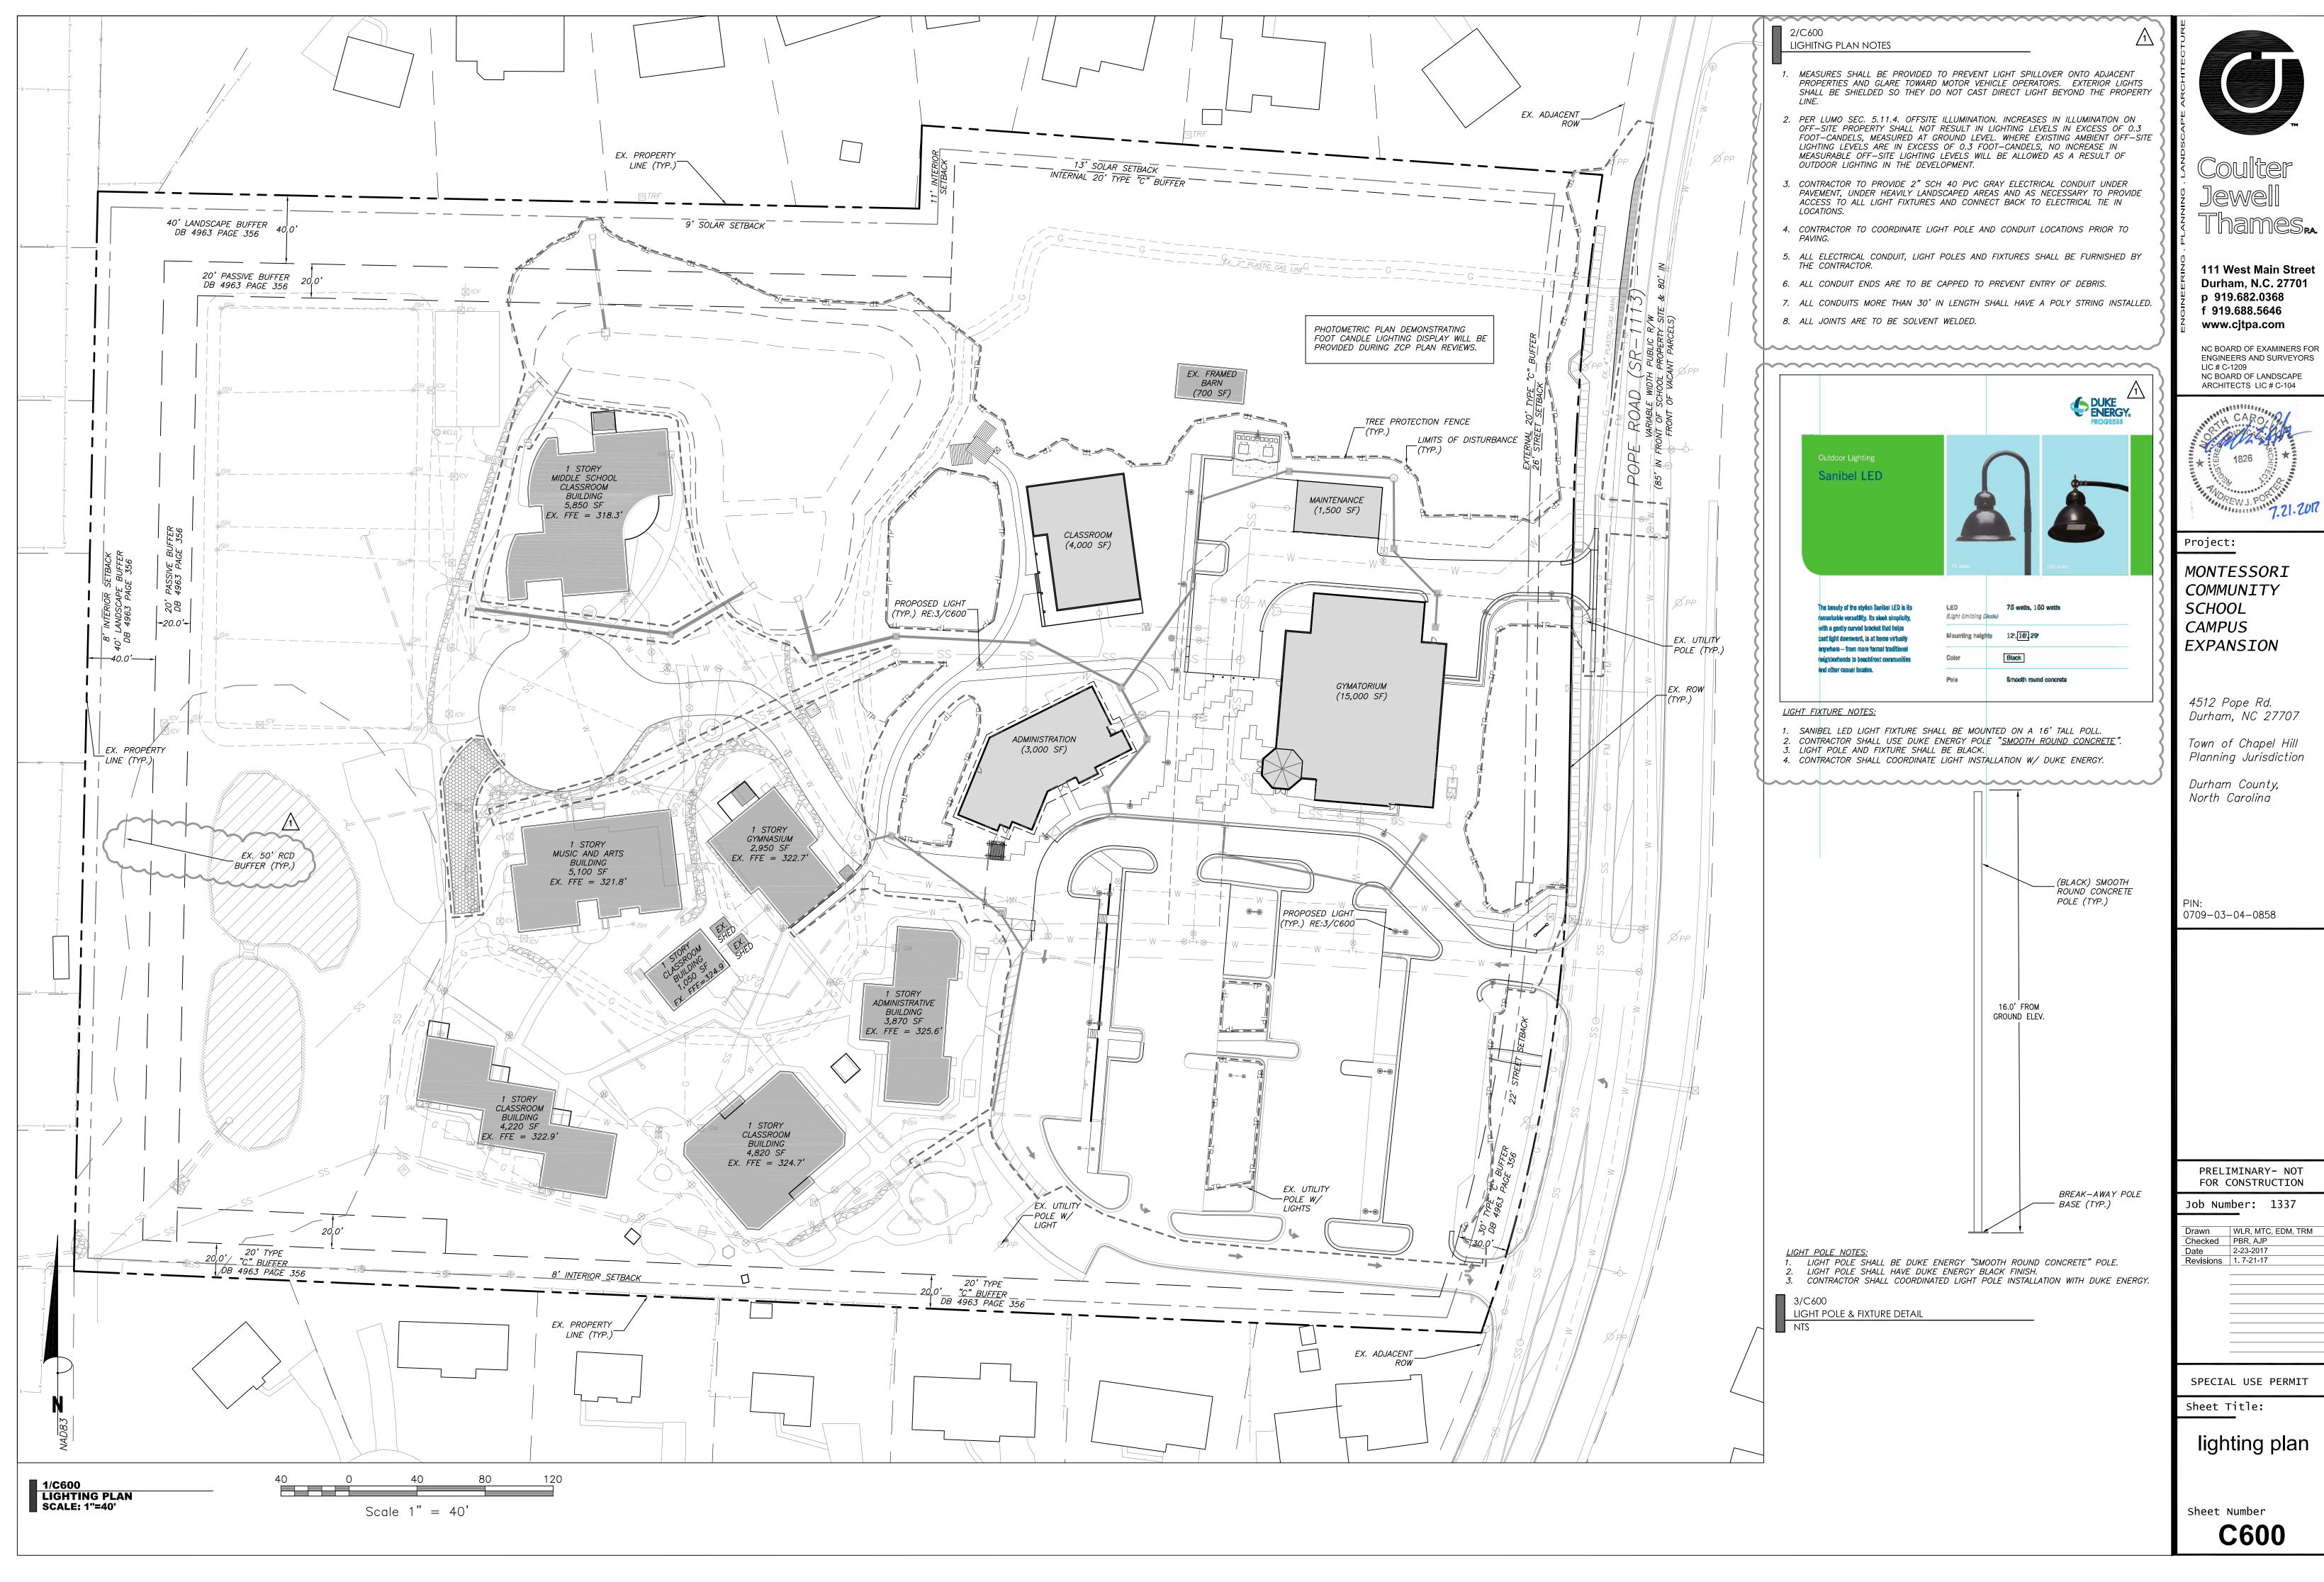

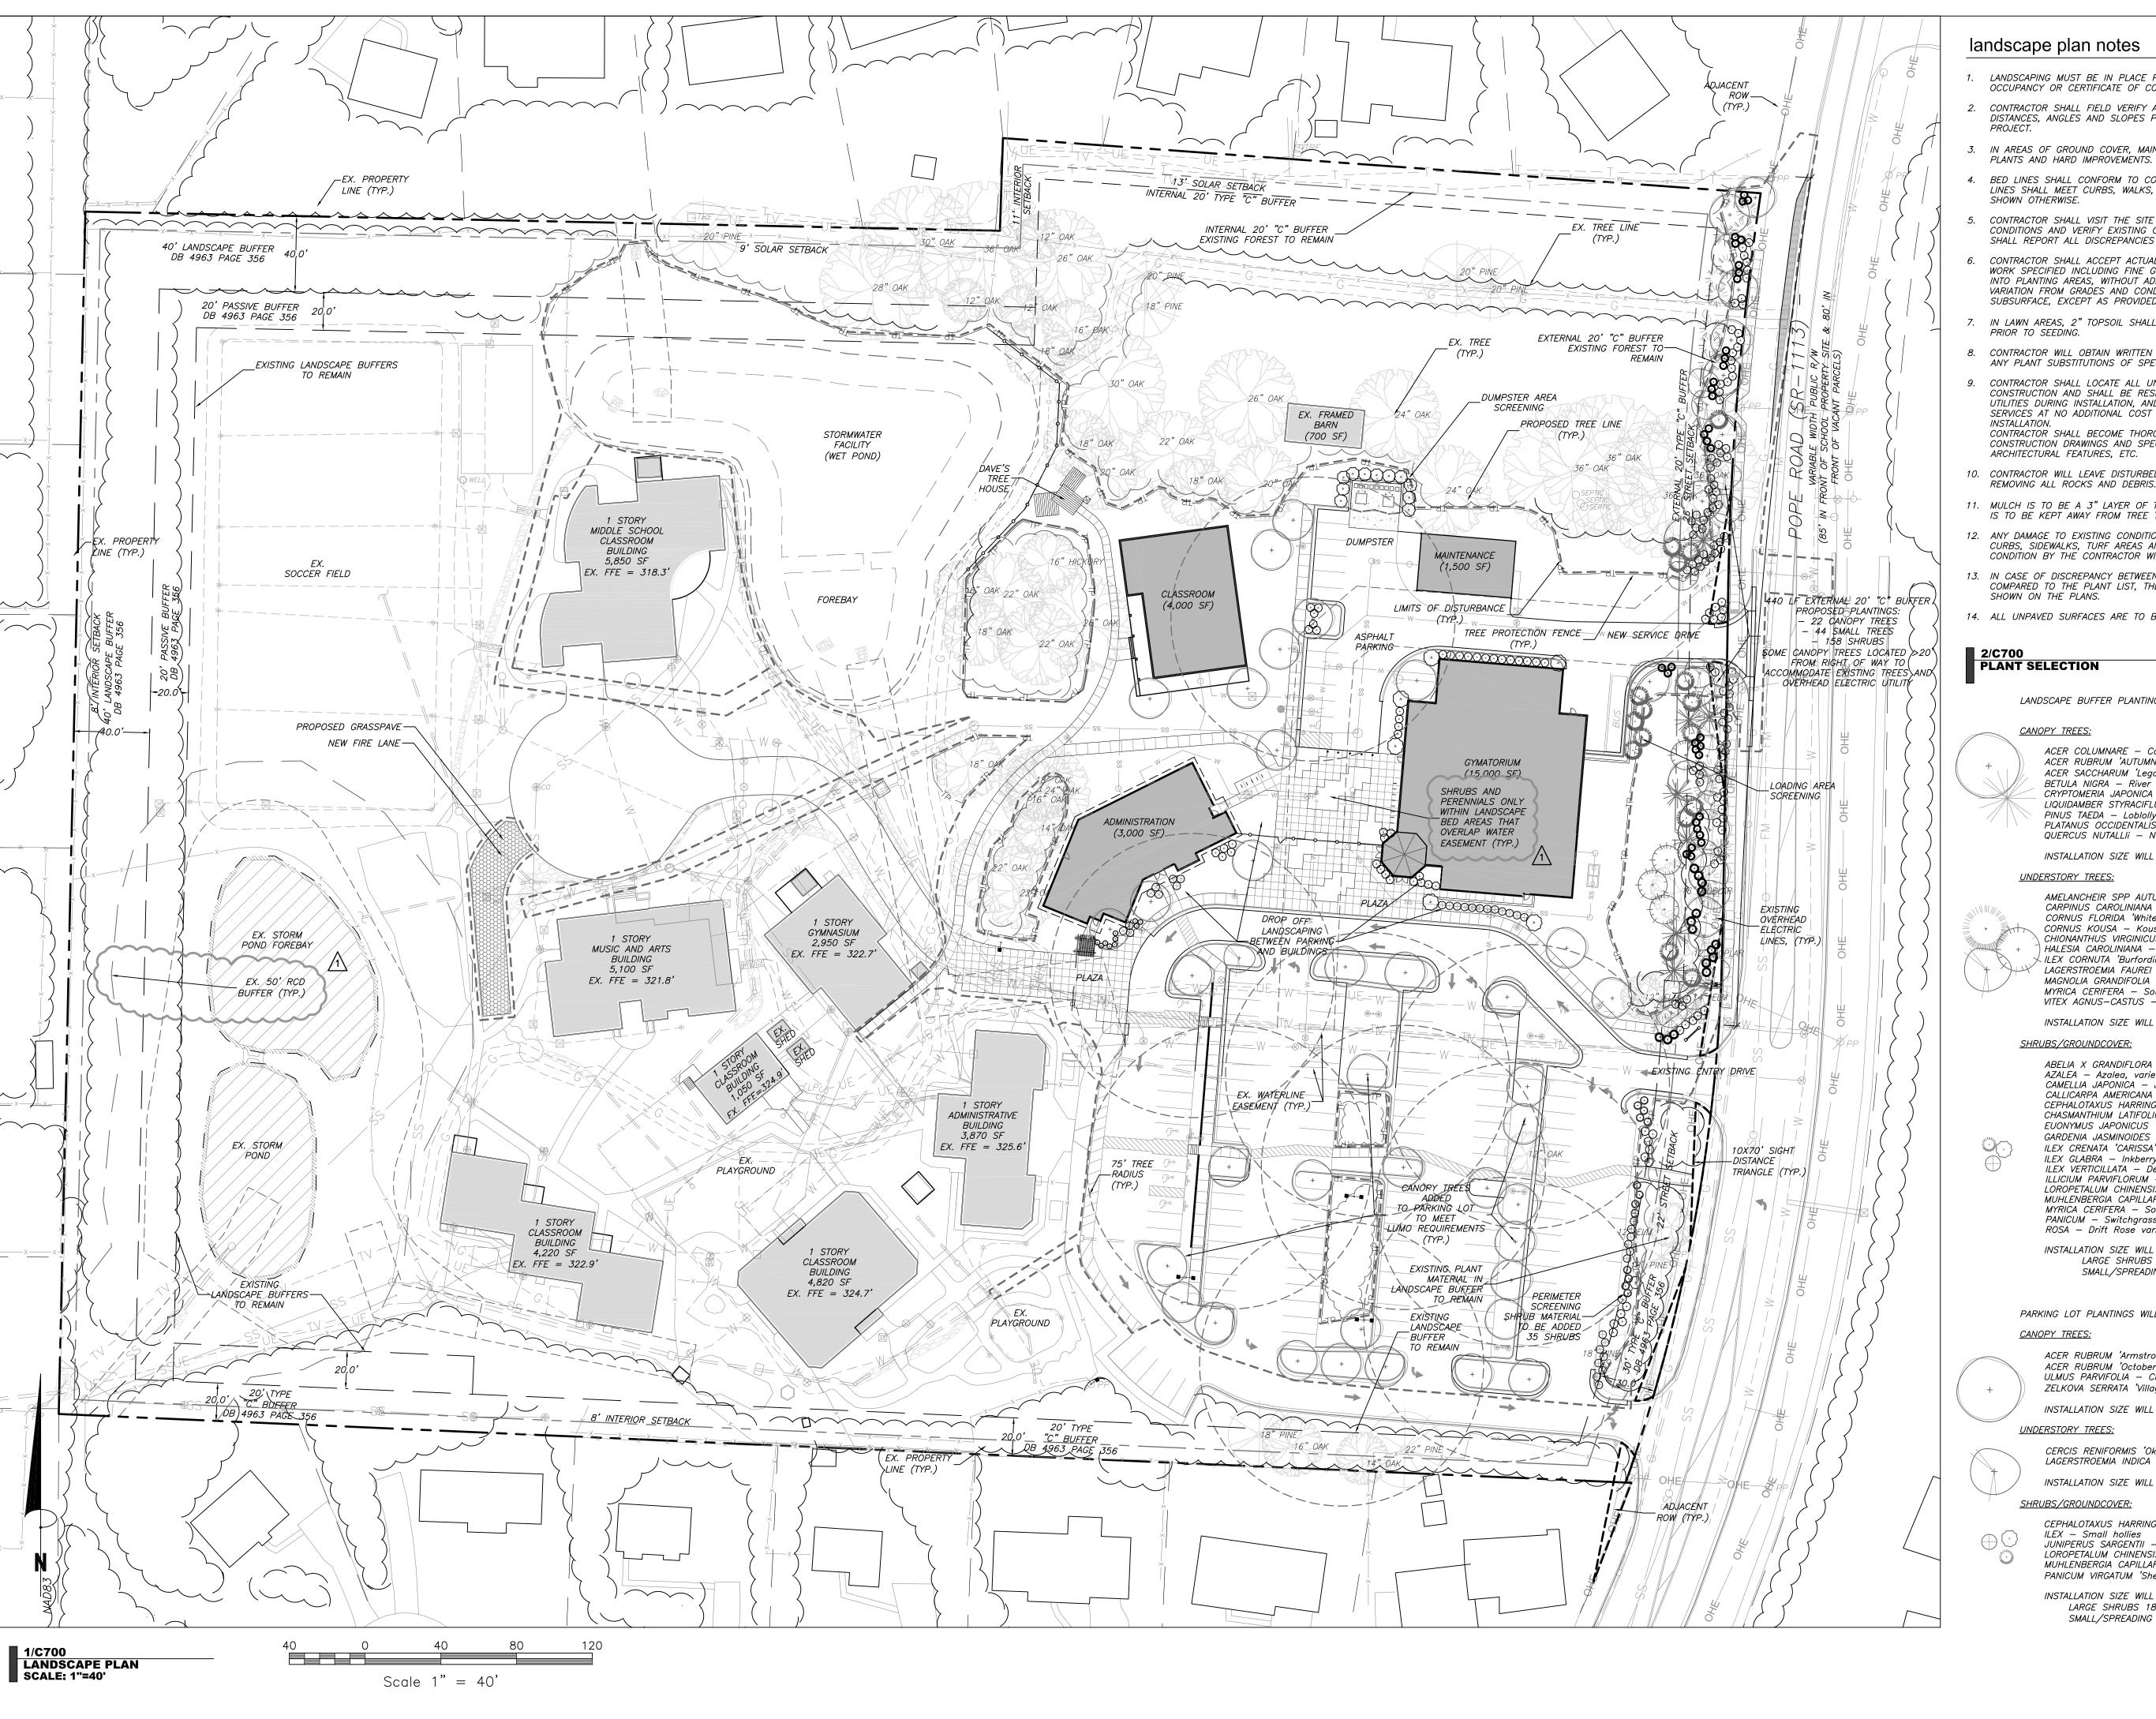

#### landscape plan notes

- LANDSCAPING MUST BE IN PLACE PRIOR TO REQUEST FOR A CERTIFICATE OF OCCUPANCY OR CERTIFICATE OF COMPLIANCE.
- CONTRACTOR SHALL FIELD VERIFY ALL DIMENSIONS, DEPTHS, QUANTITIES, DISTANCES, ANGLES AND SLOPES PRIOR TO ORDERING MATERIALS OR INSTALLING
- IN AREAS OF GROUND COVER, MAINTAIN A 12" MINIMUM DISTANCE BETWEEN
- BED LINES SHALL CONFORM TO CONFIGURATION SHOWN ON THE PLANS. BED LINES SHALL MEET CURBS, WALKS, BUILDINGS, ETC. AT RIGHT ANGLES UNLESS
- CONTRACTOR SHALL VISIT THE SITE AND FAMILIARIZE THEMSELF WITH ACTUAL CONDITIONS AND VERIFY EXISTING CONDITIONS IN THE FIELD. CONTRACTOR SHALL REPORT ALL DISCREPANCIES TO LANDSCAPE ARCHITECT.
- CONTRACTOR SHALL ACCEPT ACTUAL CONDITIONS AT SITE AND PERFORM THE WORK SPECIFIED INCLUDING FINE GRADING AND INCORPORATION OF TOP SOIL INTO PLANTING AREAS, WITHOUT ADDITIONAL COMPENSATION FOR POSSIBLE VARIATION FROM GRADES AND CONDITIONS SHOWN, WHETHER SURFACE OR SUBSURFACE, EXCEPT AS PROVIDED FOR IN CONTRACT DOCUMENTS.
- IN LAWN AREAS, 2" TOPSOIL SHALL BE TILLED INTO THE TOP 5" OF GROUND PRIOR TO SEEDING.
- CONTRACTOR WILL OBTAIN WRITTEN APPROVAL FROM LANDSCAPE ARCHITECT FOR ANY PLANT SUBSTITUTIONS OF SPECIES, SIZE, OR TYPE OF CONTAINER.
- CONTRACTOR SHALL LOCATE ALL UNDERGROUND UTILITIES PRIOR TO CONSTRUCTION AND SHALL BE RESPONSIBLE FOR THE PROTECTION OF THESE UTILITIES DURING INSTALLATION, AND SHALL PROMPTLY REPAIR AND RESTORE SERVICES AT NO ADDITIONAL COST TO THE OWNER IF DAMAGE OCCURS DURING CONTRACTOR SHALL BECOME THOROUGHLY FAMILIAR WITH THE FULL SET OF CONSTRUCTION DRAWINGS AND SPECIFICATIONS FOR COORDINATION WITH UTILITIES, ARCHITECTURAL FEATURES, ETC.
- 10. CONTRACTOR WILL LEAVE DISTURBED AREAS LEVEL AND RAKED SMOOTH, REMOVING ALL ROCKS AND DEBRIS.
- 11. MULCH IS TO BE A 3" LAYER OF TRIPLE SHREDDED HARDWOOD MULCH. MULCH IS TO BE KEPT AWAY FROM TREE TRUNKS.
- 12. ANY DAMAGE TO EXISTING CONDITIONS OUTSIDE THE CONTRACT LIMITS, INCLUDING CURBS, SIDEWALKS, TURF AREAS AND PAVING, SHALL BE RESTORED TO ORIGINAL CONDITION BY THE CONTRACTOR WITHOUT EXTRA COST TO THE OWNER.
- 13. IN CASE OF DISCREPANCY BETWEEN THE QUANTITY OF PLANTS ON THE PLANS COMPARED TO THE PLANT LIST, THE CONTRACTOR SHALL SUPPLY QUANTITIES AS SHOWN ON THE PLANS.
- 14. ALL UNPAVED SURFACES ARE TO BE COVERED IN PLANTS, MULCH, OR GRASS.

## **PLANT SELECTION**

LANDSCAPE BUFFER PLANTINGS WILL INCLUDE A SELECTION FROM:

#### CANOPY TREES:

ACER COLUMNARE - Columnar Maple ACER RUBRUM 'AUTUMN BLAZE' – Autumn Blaze Red Maple ACER SACCHARUM 'Legacy' - Legacy Sugar Maple BETULA NIGRA - River Birch CRYPTOMERIA JAPONICA - Japanese Cedar LIQUIDAMBER STYRACIFLUA 'Rotundiloba' - Fruitless Sweet Gum

QUERCUS NUTALLIi — Nuttal Oak INSTALLATION SIZE WILL BE 2 1/2" CALIBER MIN.

PINUS TAEDA - Loblolly Pine

PLATANUS OCCIDENTALÍS - Sycamore

#### **UNDERSTORY TREES:**

AMELANCHEIR SPP AUTUMN BRILLIANCE - Autumn Brilliance Serviceberry CARPINUS CAROLINIANA - Hornbeam CORNUS FLORIDA 'White Cloud' - White Flowering Dogwood CORNUS KOUSA — Kousa Dogwood CHIONANTHUS VIRGINICUS — Fringetree HALESIA CAROLINIANA – Carolina Silverbell

✓ ILEX CORNUTA 'Burfordii' — Burford Holly LAGERSTROEMIA FAUREI – Crape Myrtle MAGNOLIA GRANDIFOLIA 'LITTLE GEM' - Southern Magnolia MYRICA CERIFERA - Southern Wax Myrtle VITEX AGNUS-CASTUS - Chaste Tree

INSTALLATION SIZE WILL BE 6' HEIGHT MIN.

#### SHRUBS/GROUNDCOVER:

ABELIA X GRANDIFLORA - Glossy Abelia AZALEA – Azalea, variety CAMELLIA JAPONICA – Japanese Camellia CALLICARPA AMERICANA - American Beautyberry CEPHALOTAXUS HARRINGTONIA - Plum Yew CHASMANTHIUM LATIFOLIUM - River Oats EUONYMUS JAPONICUS 'Moness' — Silver Princess Euonymus GARDENIA JASMINOIDES 'Kleim's Hardy' – Kleim's Hardy Gardenia ILEX CRENATA 'CARISSA' — Carissa Holly ILEX GLABRA - Inkberry

ILEX VERTICILLATA — Deciduous Holly ILLICIUM PARVIFLORUM - Anise LOROPETALUM CHINENSIS - Loropetalum varieties MUHLENBERGIA CAPILLARIS — Pink Muhly Grass MYRICA CERIFERA - Southern Waxmyrtle PANICUM — Switchgrass ROSA — Drift Rose varieties

INSTALLATION SIZE WILL VARY: LARGE SHRUBS 18"-30" SMALL/SPREADING SHRUBS 12"-15"

#### PARKING LOT PLANTINGS WILL INCLUDE A SELECTION FROM: CANOPY TREES:

ACER RUBRUM 'Armstrong' -Armstrong Red Maple ACER RUBRUM 'October Glory' - October Glory Red Maple ULMUS PARVIFOLIA - Chinese Elm ZELKOVA SERRATA 'Village Green' - Village Green Zelkova INSTALLATION SIZE WILL BE 2 1/2" CALIBER MIN.

CERCIS RENIFORMIS 'Oklahoma' — Texas White Redbud

**UNDERSTORY TREES:** 

### LAGERSTROEMIA INDICA - Crape Myrtles INSTALLATION SIZE WILL BE 6' HT MIN.

### **SHRUBS/GROUNDCOVER:**

CEPHALOTAXUS HARRINGTONIA - Plum Yew ILEX – Small hollies JUNIPERUS SARGENTII - Low growing Juniper LOROPETALUM CHINENSIS – Loropetalum varieties MUHLENBERGIA CAPILLARIS — Pink Muhly Grass PANICUM VIRGATUM 'Shenandoah' - Shenandoah Switchgrass

INSTALLATION SIZE WILL VARY LARGE SHRUBS 18"-30" SMALL/SPREADING SHRUBS 12"-15"



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Project:

### **MONTESSORI** COMMUNITY **SCHOOL** CAMPUS EXPANSION

4512 Pope Rd. Durham, NC 27707

Town of Chapel Hill Planning Jurisdiction

Durham County, North Carolina

0709-03-04-0858

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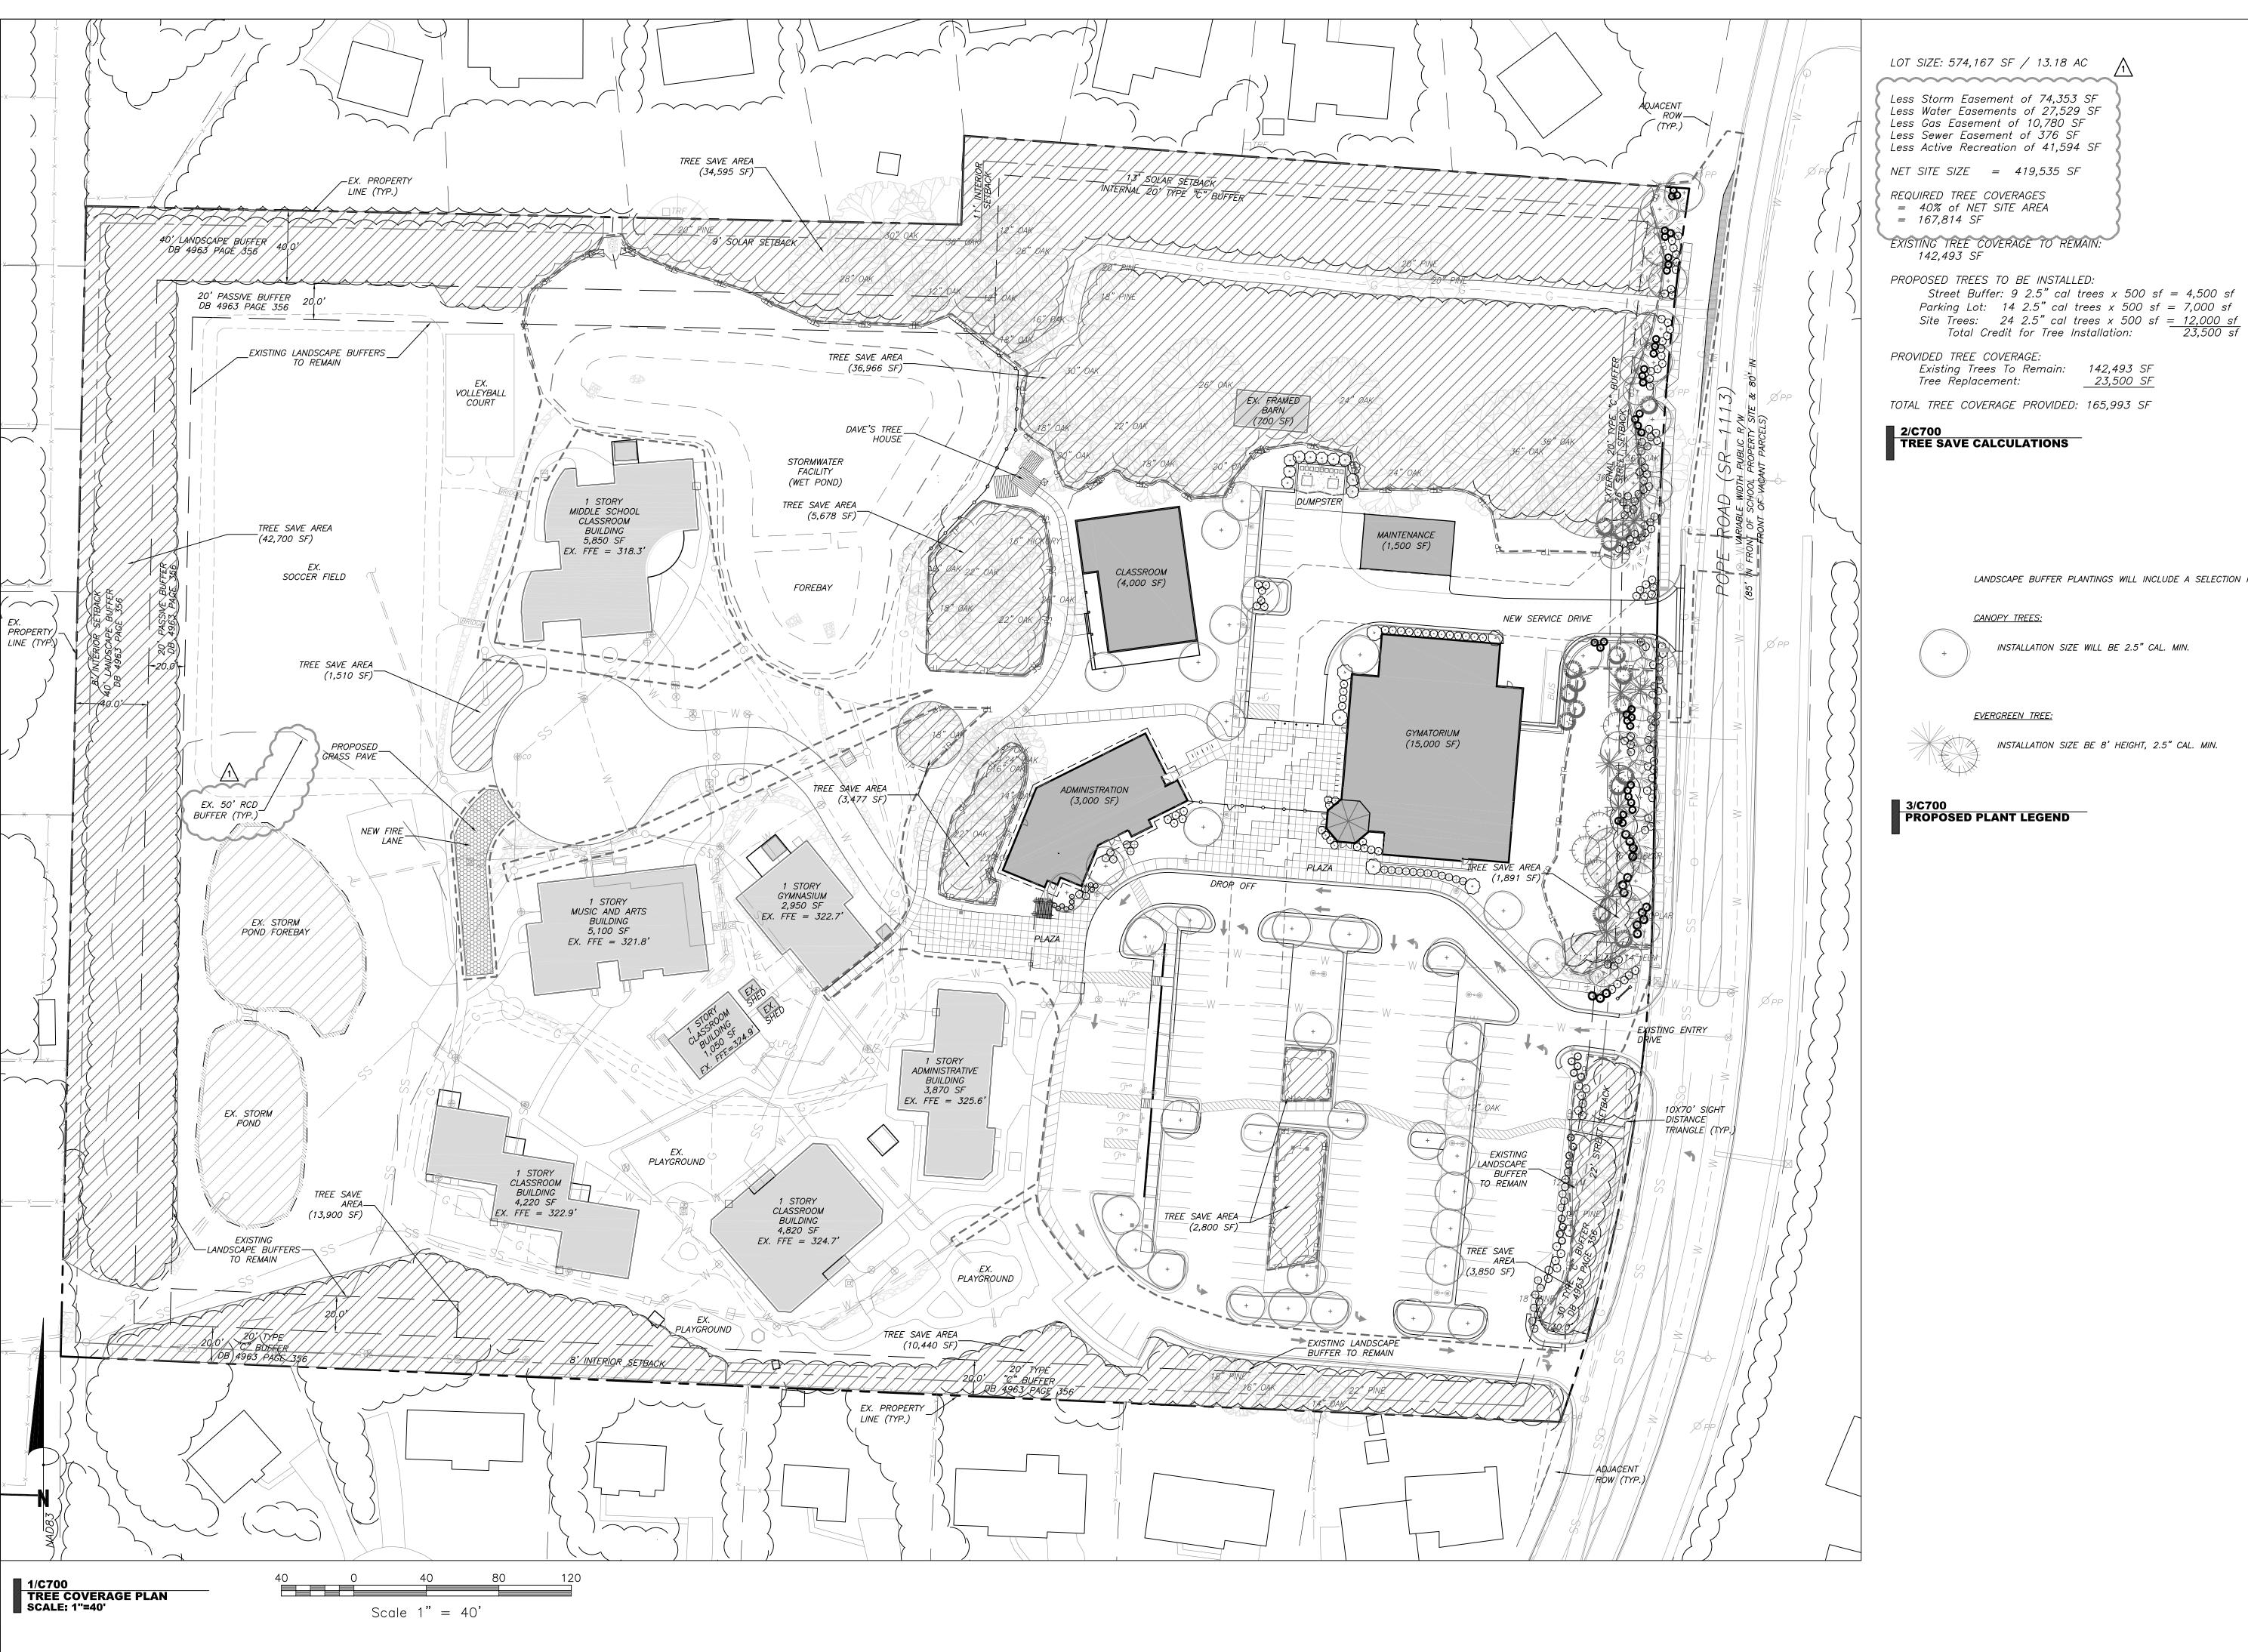
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 Revisions
 1. 7-21-17

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Sheet Title

landscape plan





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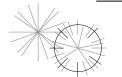


LANDSCAPE BUFFER PLANTINGS WILL INCLUDE A SELECTION FROM:

CANOPY TREES:

INSTALLATION SIZE WILL BE 2.5" CAL. MIN.

**EVERGREEN TREE:** 



INSTALLATION SIZE BE 8' HEIGHT, 2.5" CAL. MIN.

\_\_\_23,500\_SF

3/C700 PROPOSED PLANT LEGEND

Project:

*MONTESSORI* COMMUNITY *SCHOOL* CAMPUS EXPANSION

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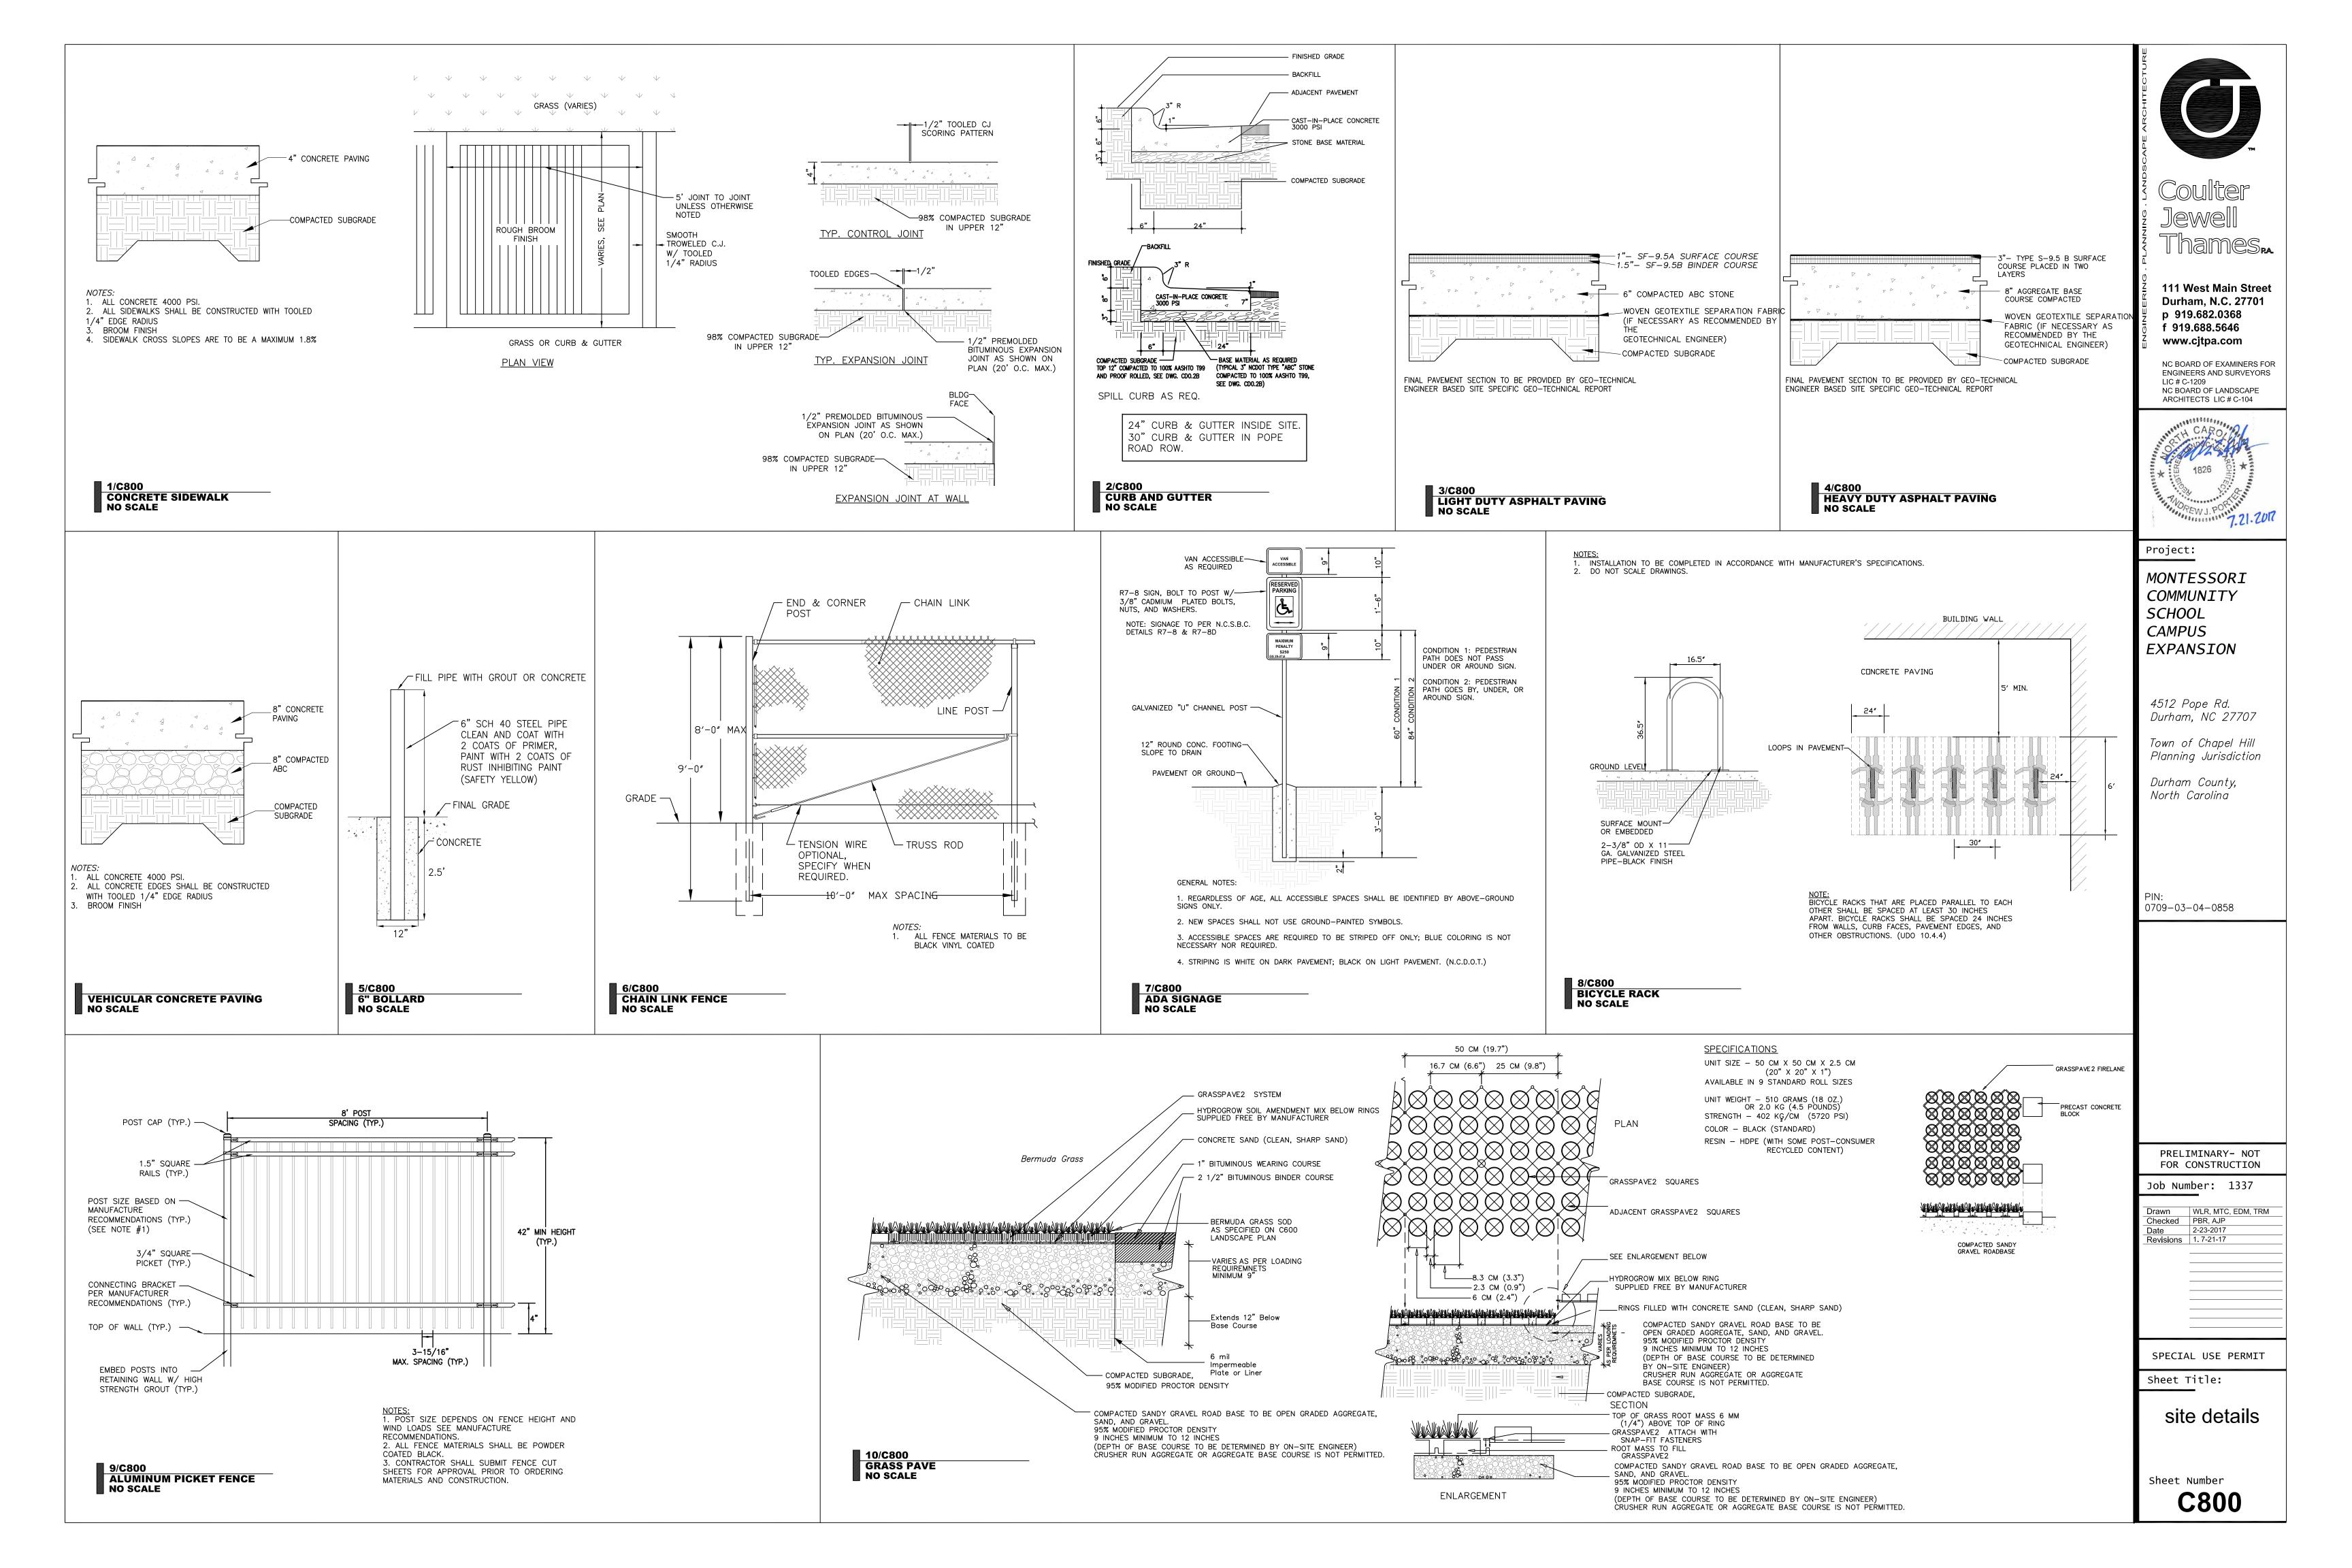
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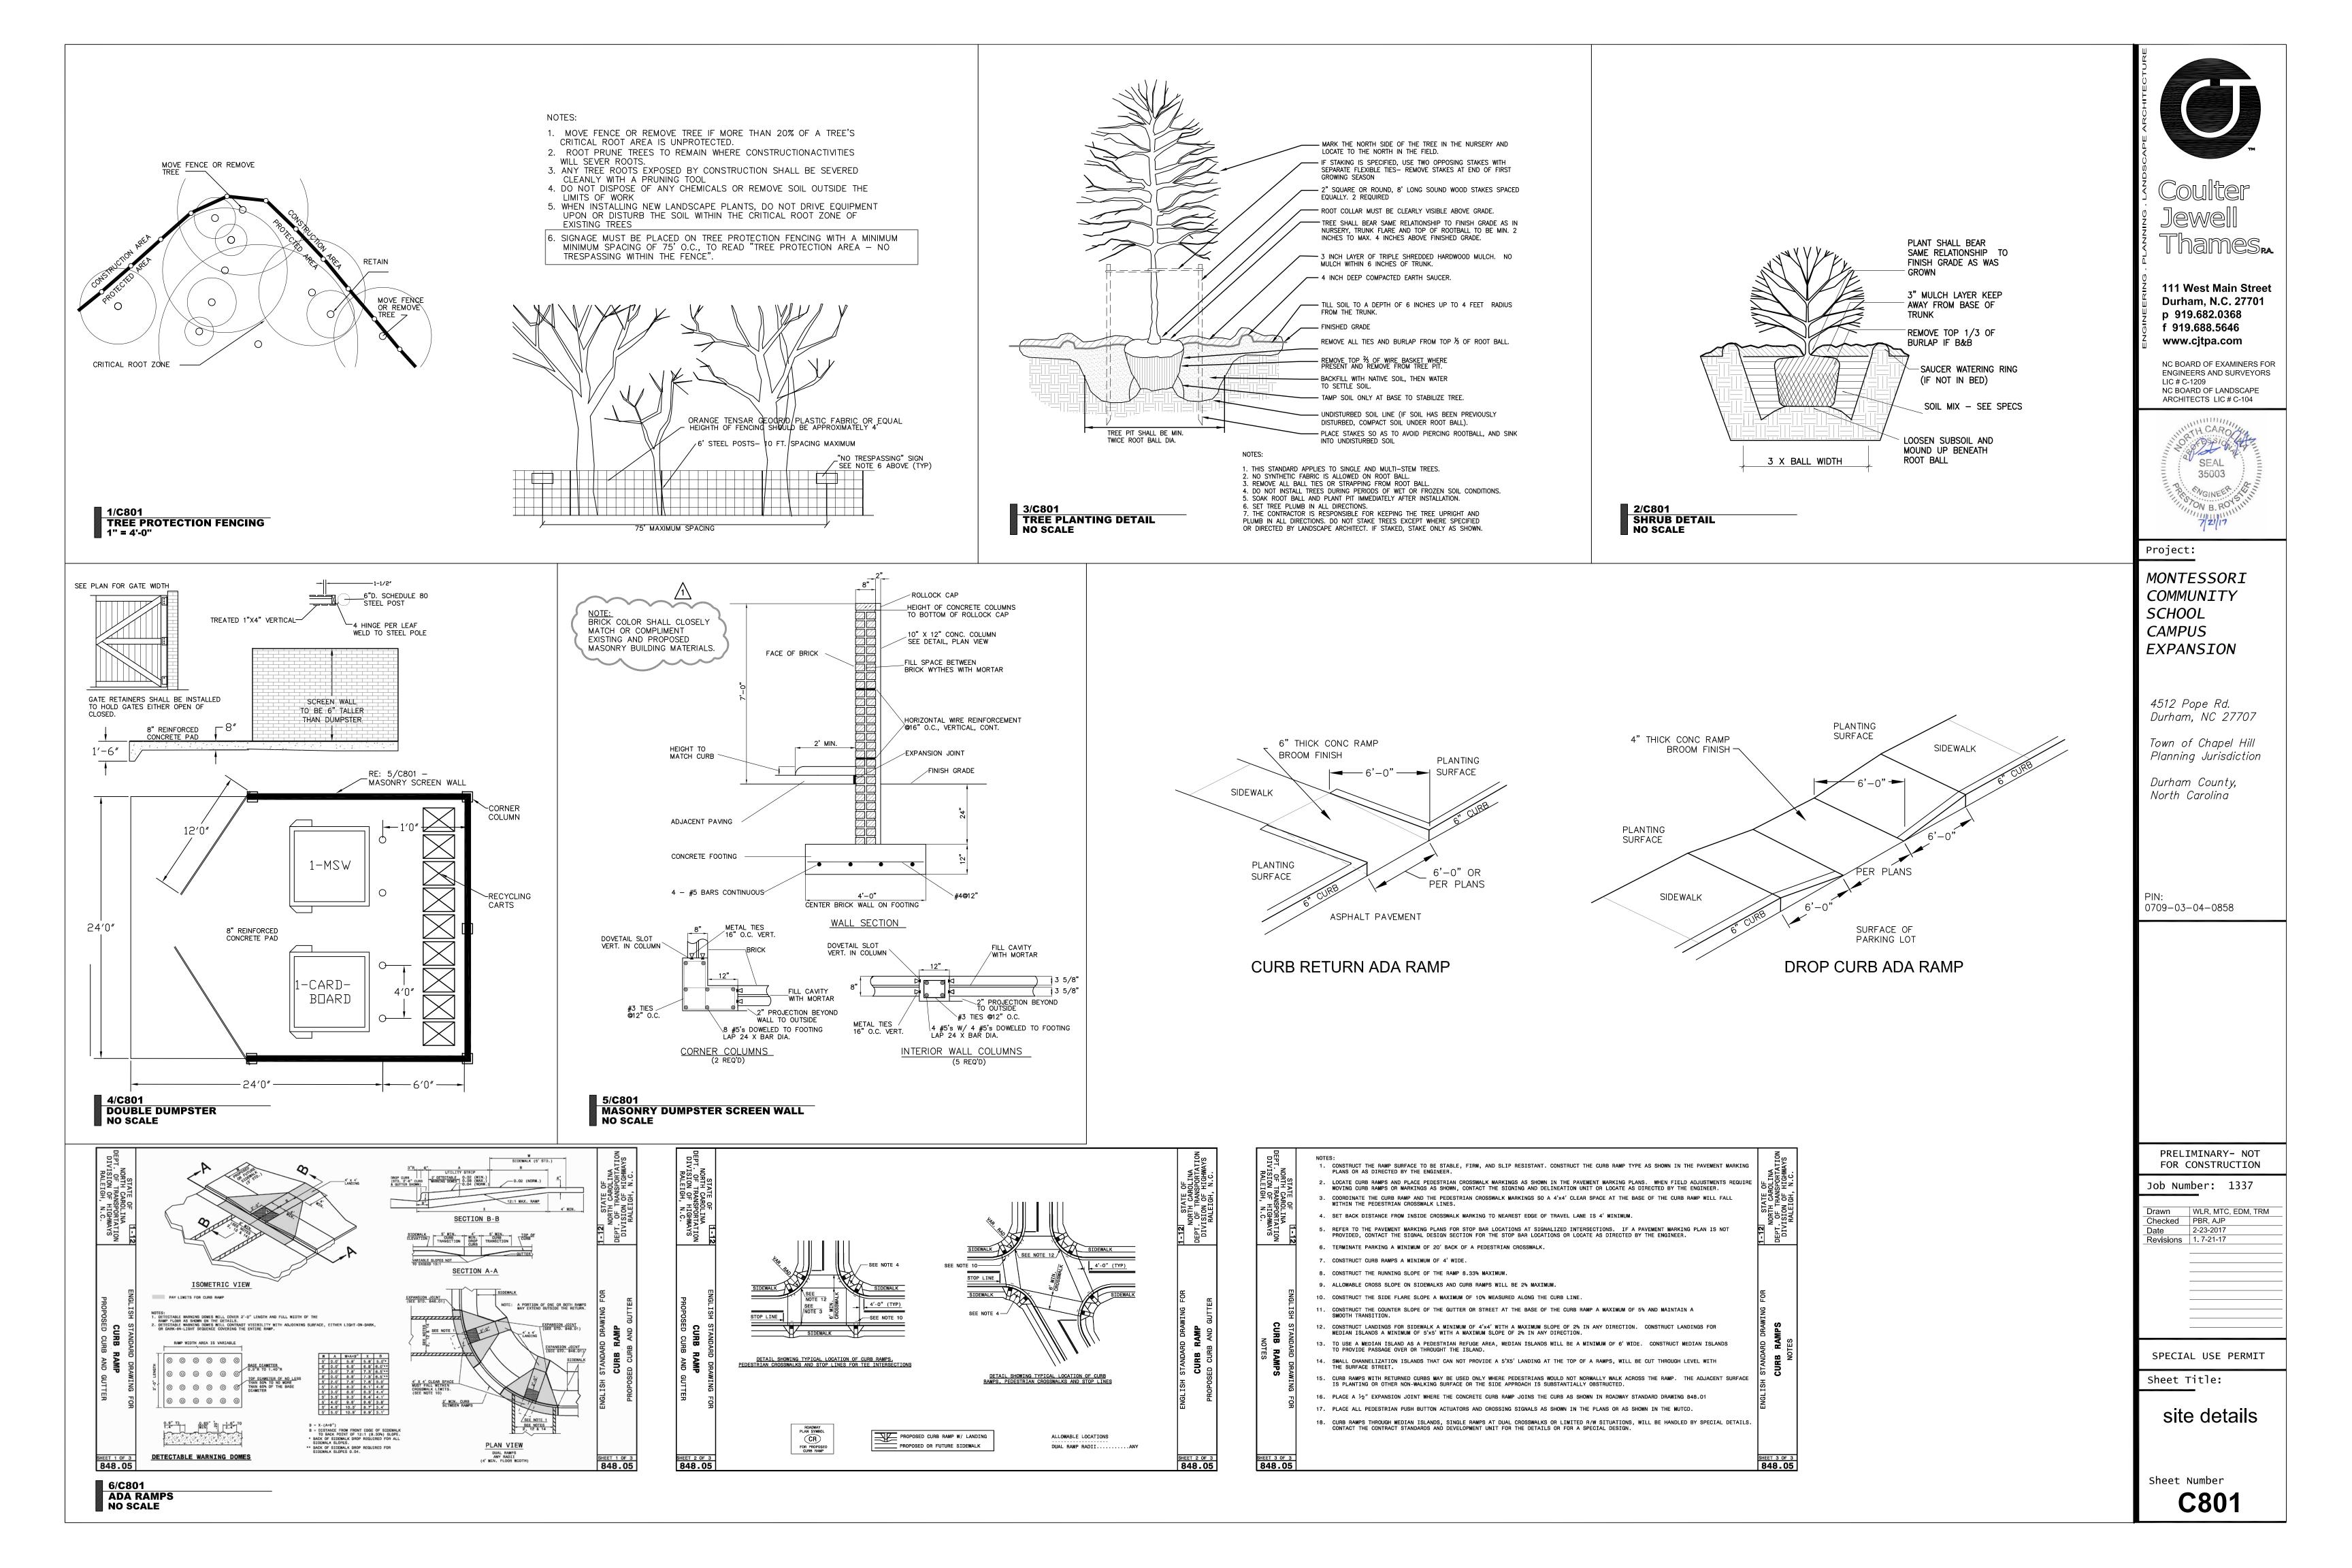
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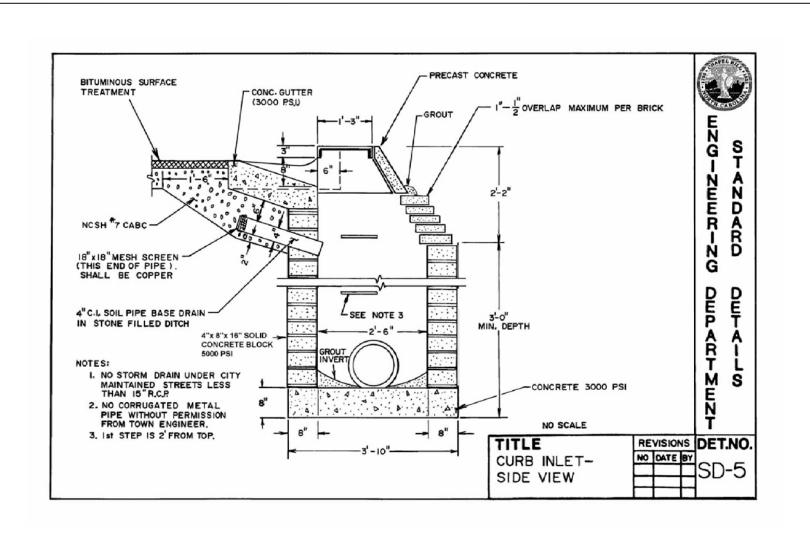
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Sheet Title:

tree coverage plan







MATERIALS AS NOTED ON SD-3.0 GRADING AND 3. ALL ROOF LEADERS AND

(SEE ARCH. PLANS FOR DETAILS)

\_OFF-SET AS REQUIRED

--- DOWNSPOUT, SEE ARCHITECTURAL SHEETS

LONG SWEEP WYE

SCH. 40 PVC AT 1% MIN. SLOPE (SEE NOTE BELOW ABOUT PIPE

1. A CLEAN OUT IS REQUIRED

AND JUNCTIONS IN LINES.

DOWNSPOUTS ARE TO BE PIPED TO NEAREST INLET.

ADAPT DOWNSPOUT TO PVC COLLECTOR LINE

(SEE ARCH. PLANS FOR DETAILS)

CLEANOUT WITH CONCRETE

-COLLAR (18"X18"X4" MIN.)

FINISHED GRADE

SCH. 40 PVC (SEE NOTE

BELOW ABOUT PIPE SIZES)

SCH. 40 PVC (SEE NOTE

BELOW ABOUT PIPE SIZES)

AT ALL DOWNSPOUT CONNECTIONS

2. ALL JOINTS SHALL BE SOLVENT WELDED

SCH. 40 PVC

ABOUT PIPE SIZES)

1/C802 CURB INLET NO SCALE

DRAINAGE PLAN.

ELBOW ----


4/C802
ROOF LEADER CONNECTION W/ CLEANOUT NO SCALE

ALL ROOF LEADER CONNECTIONS SHALL BE


— BUILDING WALL

MADE WITH 6" SCH. 40 PVC PIPE.

CONNECTING HEADER PIPE SIZES AND

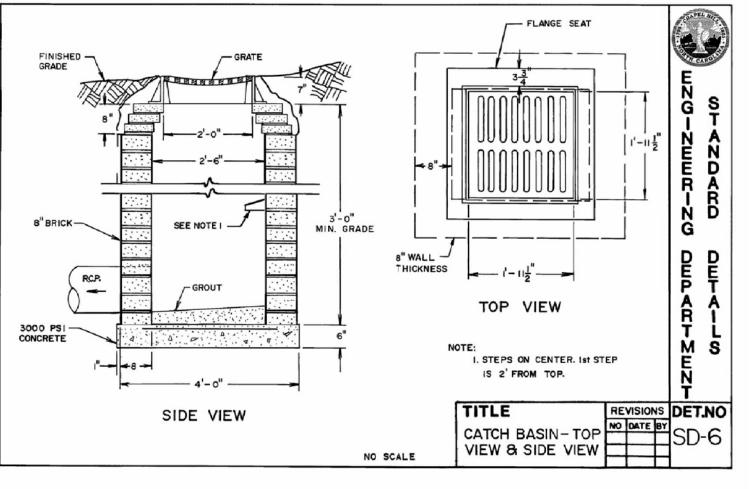


2/C802 DROP INLET NO SCALE

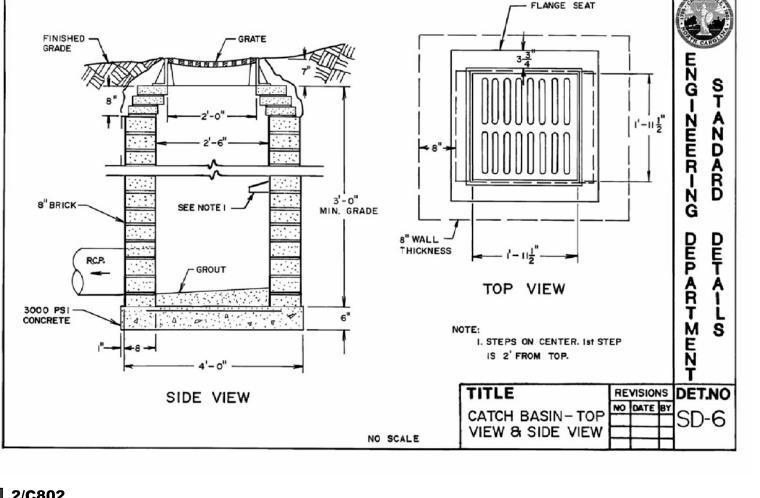

CHEEK WALL: 6" THICK CONCRETE GALV. STEEL PIPE RAIL -1-1/2" OD SCH.40 6" ABOVE NOSE OF STEP BRÚSHED BLACK FINISH 6" PAST HAND RAIL POST CENTER HAND RAIL IN WALL TREADS: 12" RISERS: 6" (# RISERS VARIES, SEE PLAN) →—SIDEWALK - #4 REBAR @ 12"O.C.E.W. COMPACTED / /-- #3 NOSING BAR SLOPE:1/8"/FT.\_\_ \_\_1/2" R

5/C802
CONCRETE STEP DETAIL (TYPICAL NUMBER OF RISERS VARIES)
NO SCALE

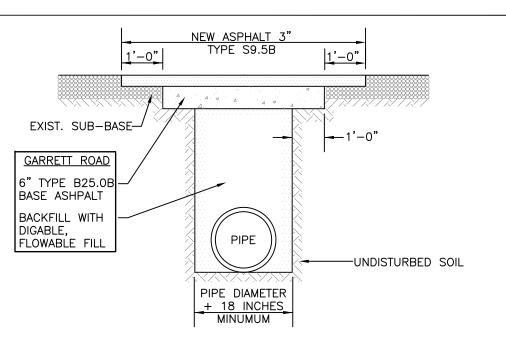


1. SAW CUT EDGES MUST BE STRAIGHT AND CLEAN.

- PATCHES MUST BE REGULAR, SQUARE, OR RECTANGULAR (4 STRAIGHT EDGES). FINAL SURFACE COURSE MUST BE FLUSH WITH THE EDGE OF EXISTING
- PAVEMENT, VERTICALLY AND HORIZONTALLY, WITH NO SPILLOVER OF ASPHALT OR TACK COAT.
- 4. CARE MUST BE TAKEN NOT TO DAMAGE INTEGRITY OR APPEARANCE OF SURROUNDING PAVEMENT. IF DAMAGED, THE ENTIRE SURFACE PATCH MUST BE EXPANDED TO COVER DAMAGES.
- 5. ALL STRIPING IMPACTED BY REPAIRS MUST BE REPLACED. 6. PROPER TRAFFIC CONTROL AND PLATING OF THE ROAD DURING CURE TIME FOR FLOWABLE FILL MUST BE CONDUCTED APPROPRIATELY.
- 7. THE MAXIMUM TIME TO COMPLETE FULL REPAIR SHALL NOT EXCEED 10 WORKING DAYS.

3/C802 OPEN CUT AND REPAIR NO SCALE

6/C802
ADA RAMP W/ HANDRAIL
NO SCALE

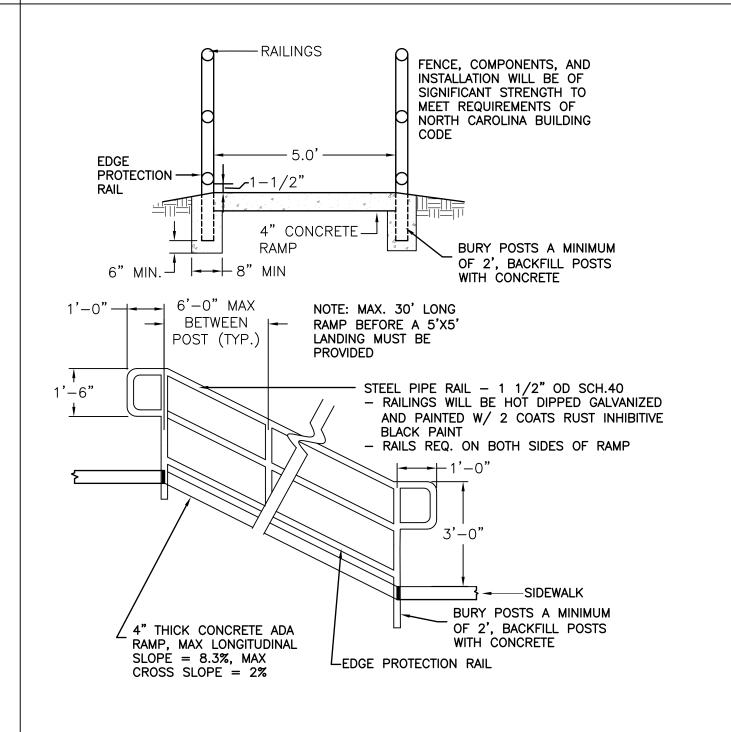

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Project

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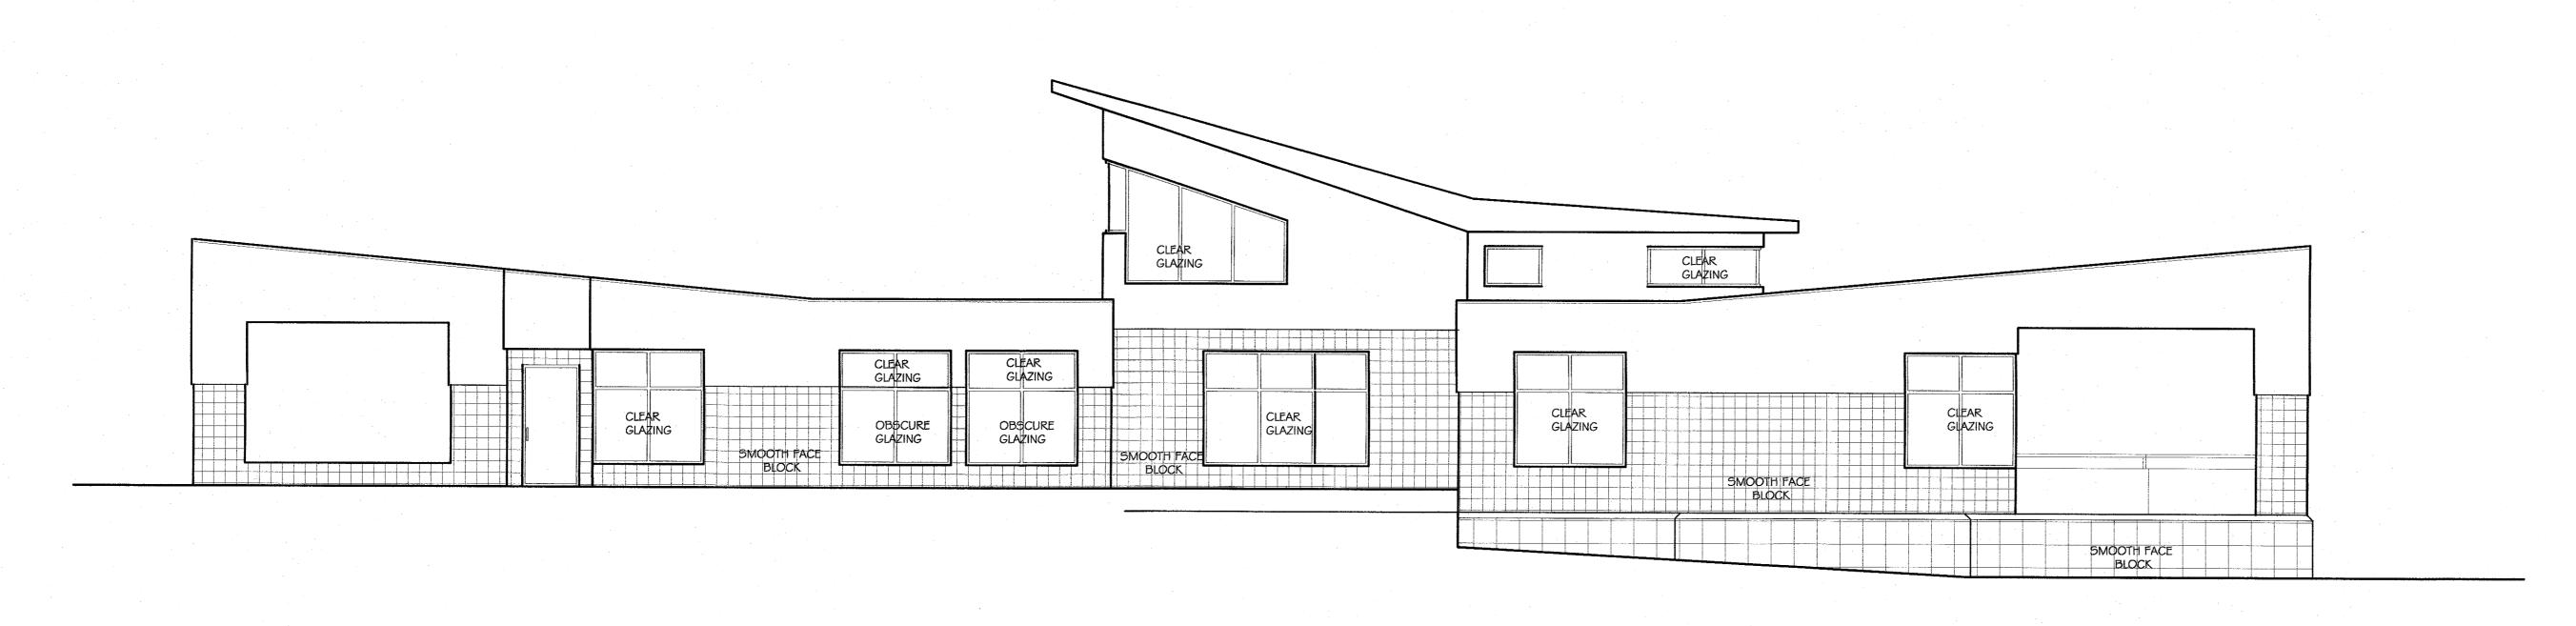
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site details

Sheet Number





WEST ELEVATION 3/16" = 1'-0"

#### GGA ARCHITECTS

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#### COULTER JEWELL THAMES

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ADMIN. BUILDING

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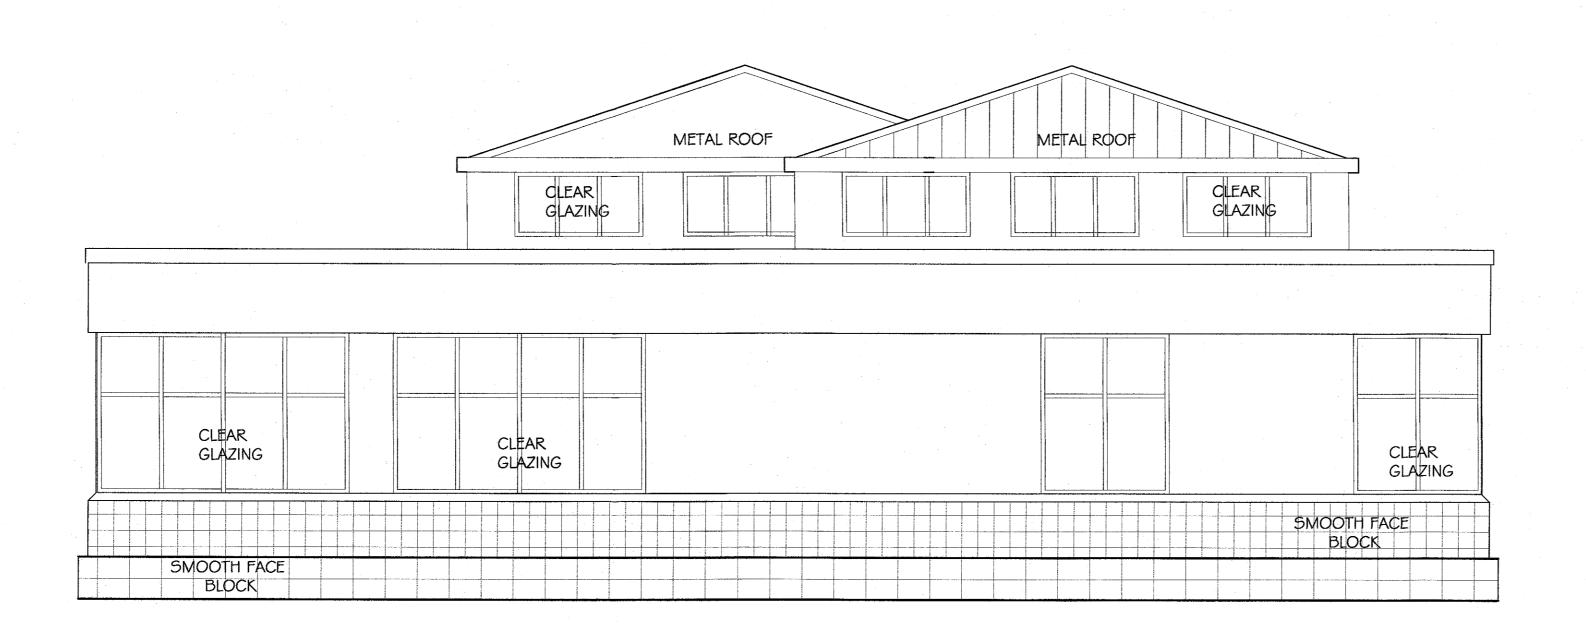
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6 PEBRUARY 20171 4

AS NOTED



## SOUTH ELEVATION 1/4" = 1'-0"



EAST ELEVATION 1/4" = 1'-0"

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# CLASSROOM BUILDING


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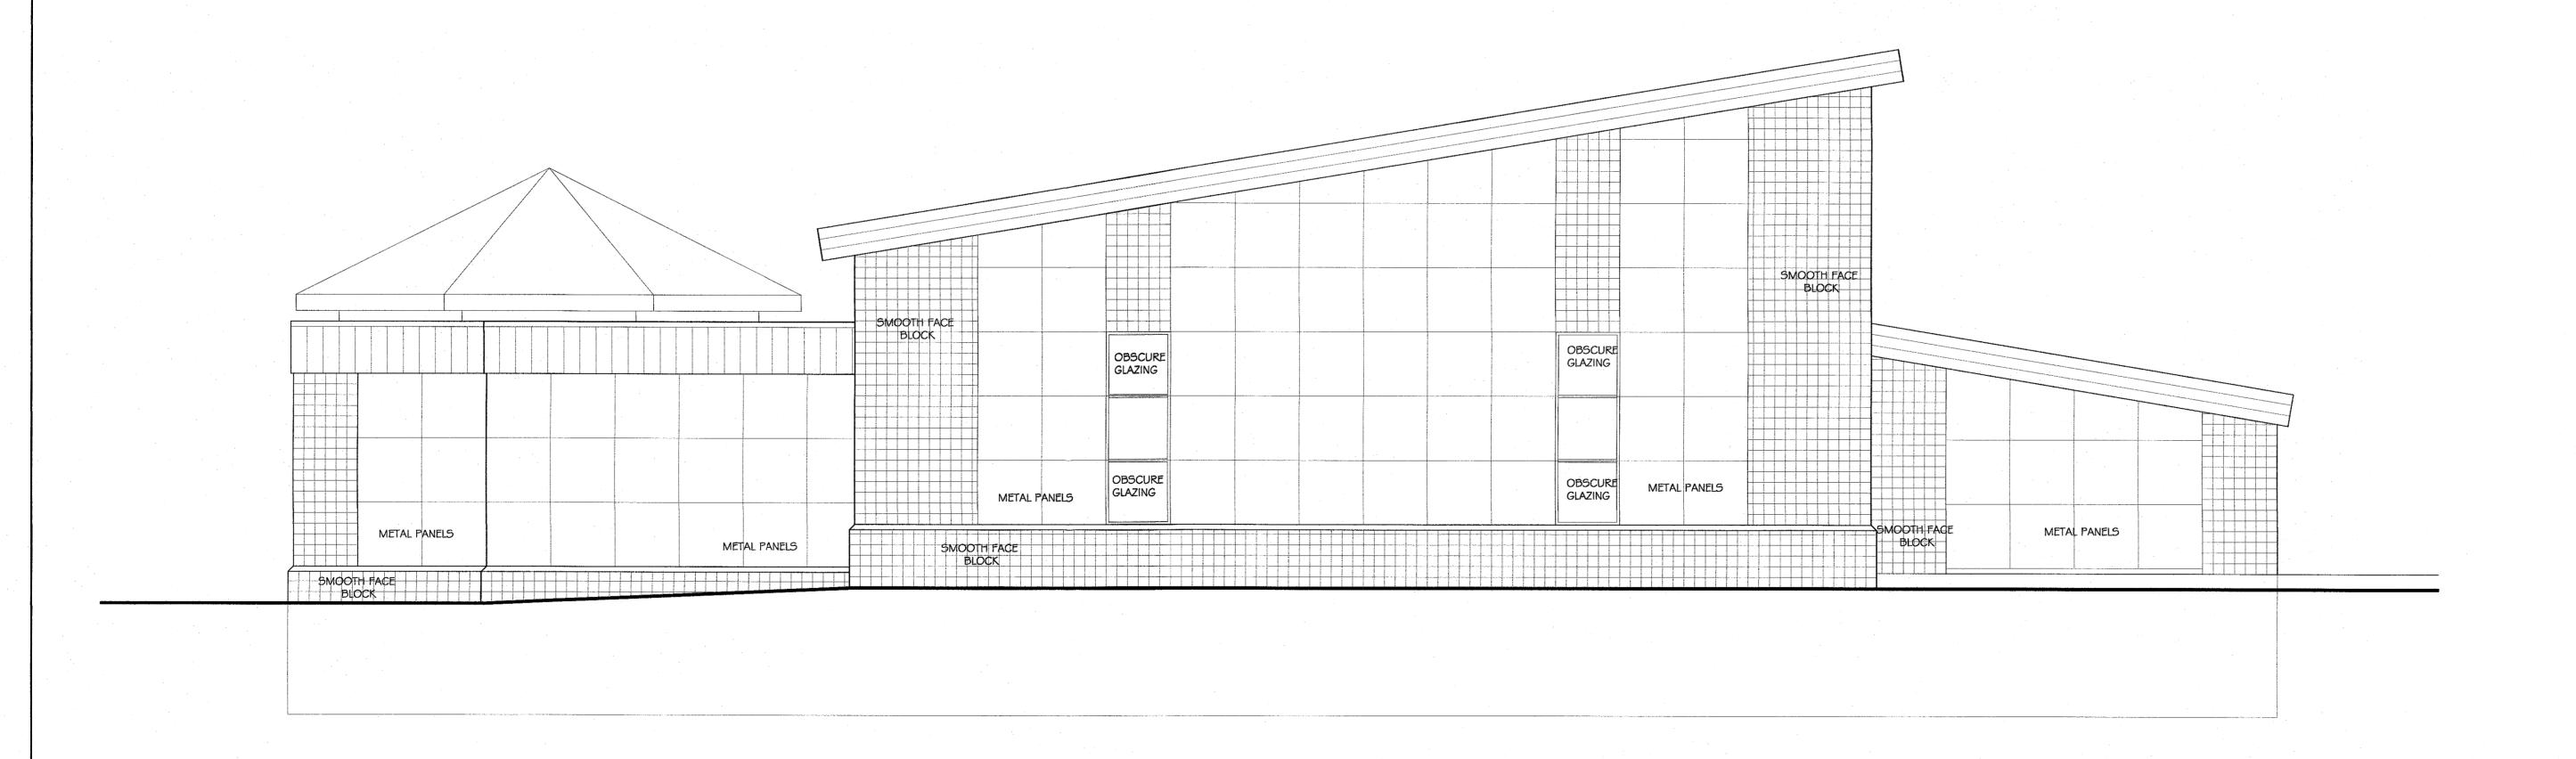
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## WEST ELEVATION 3/16" = 1'-0"



EAST ELEVATION 3/16" = 1'-0"

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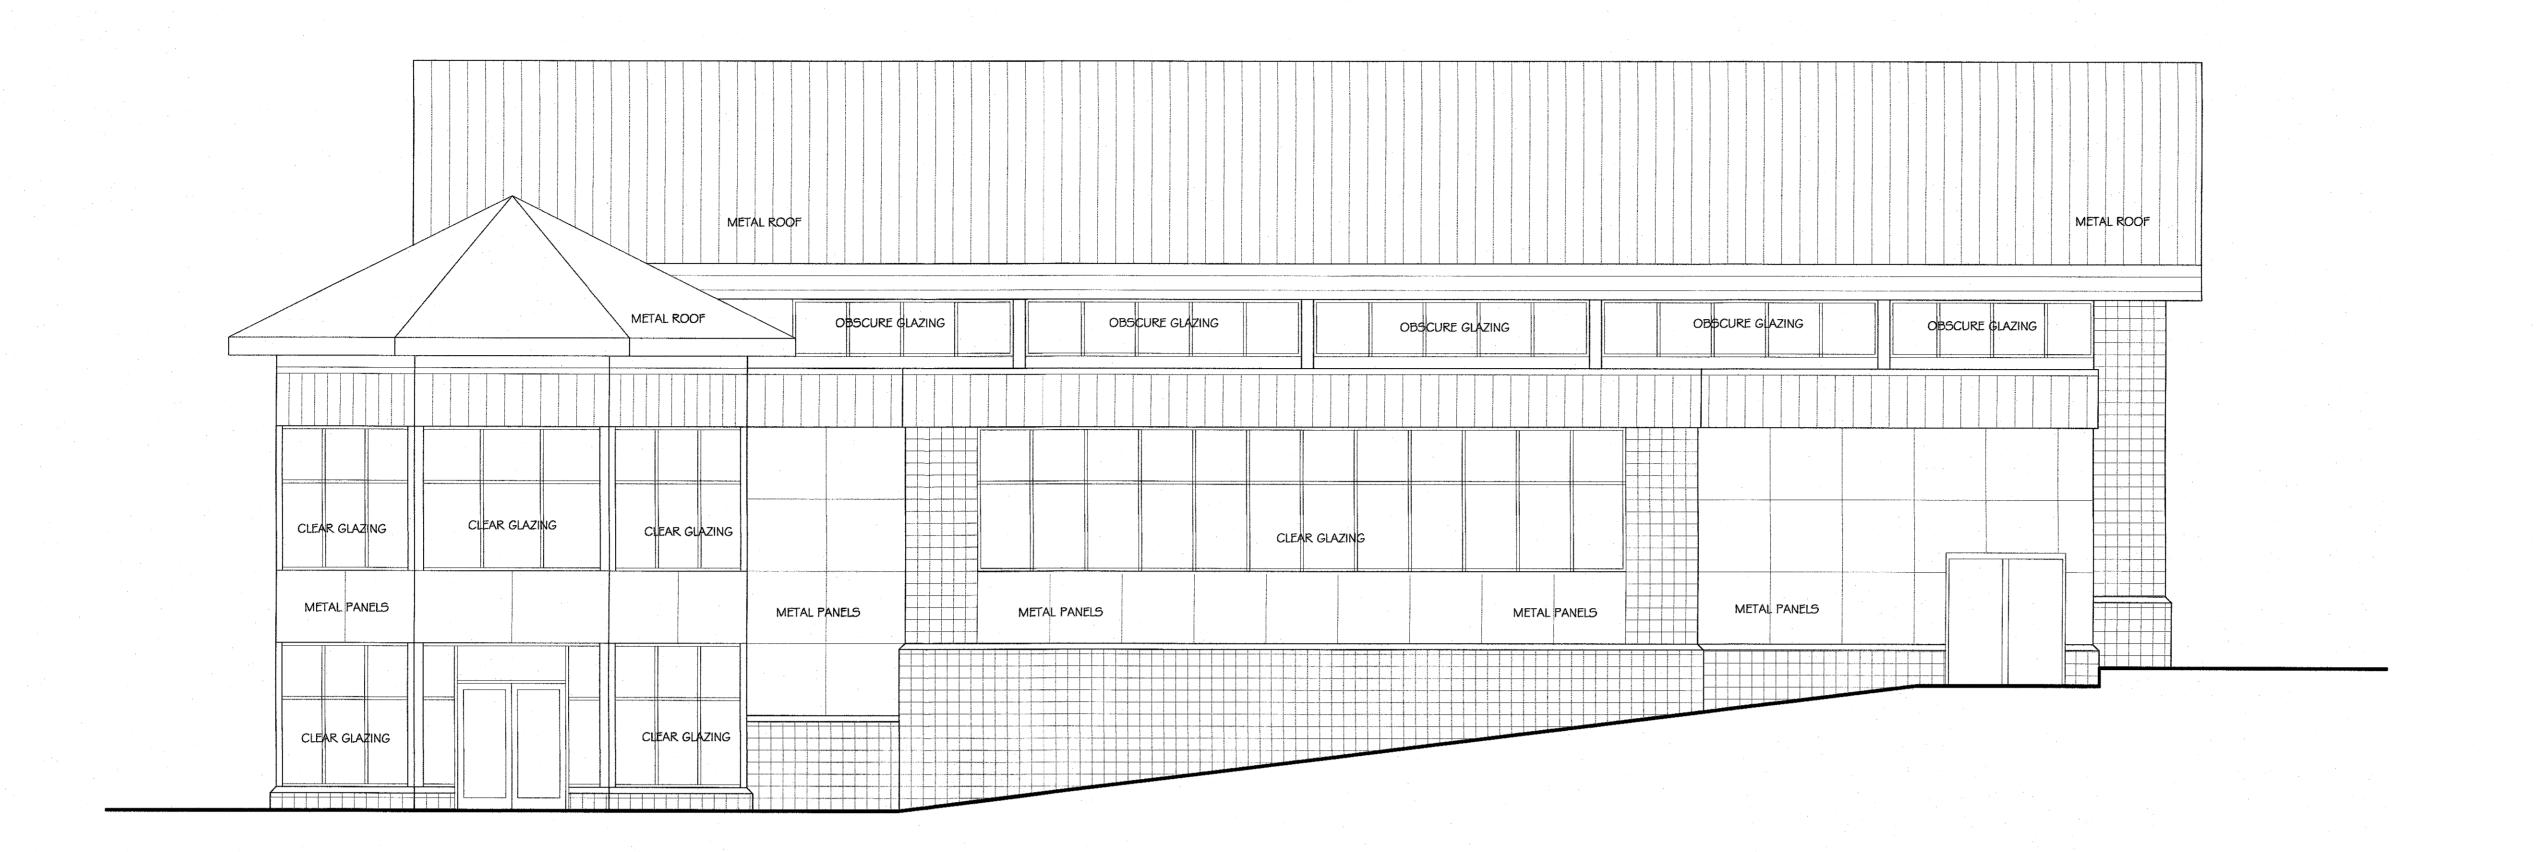
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# GYM E & W ELEVATIONS


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## SOUTH ELEVATION 3/16" = 1'-0"

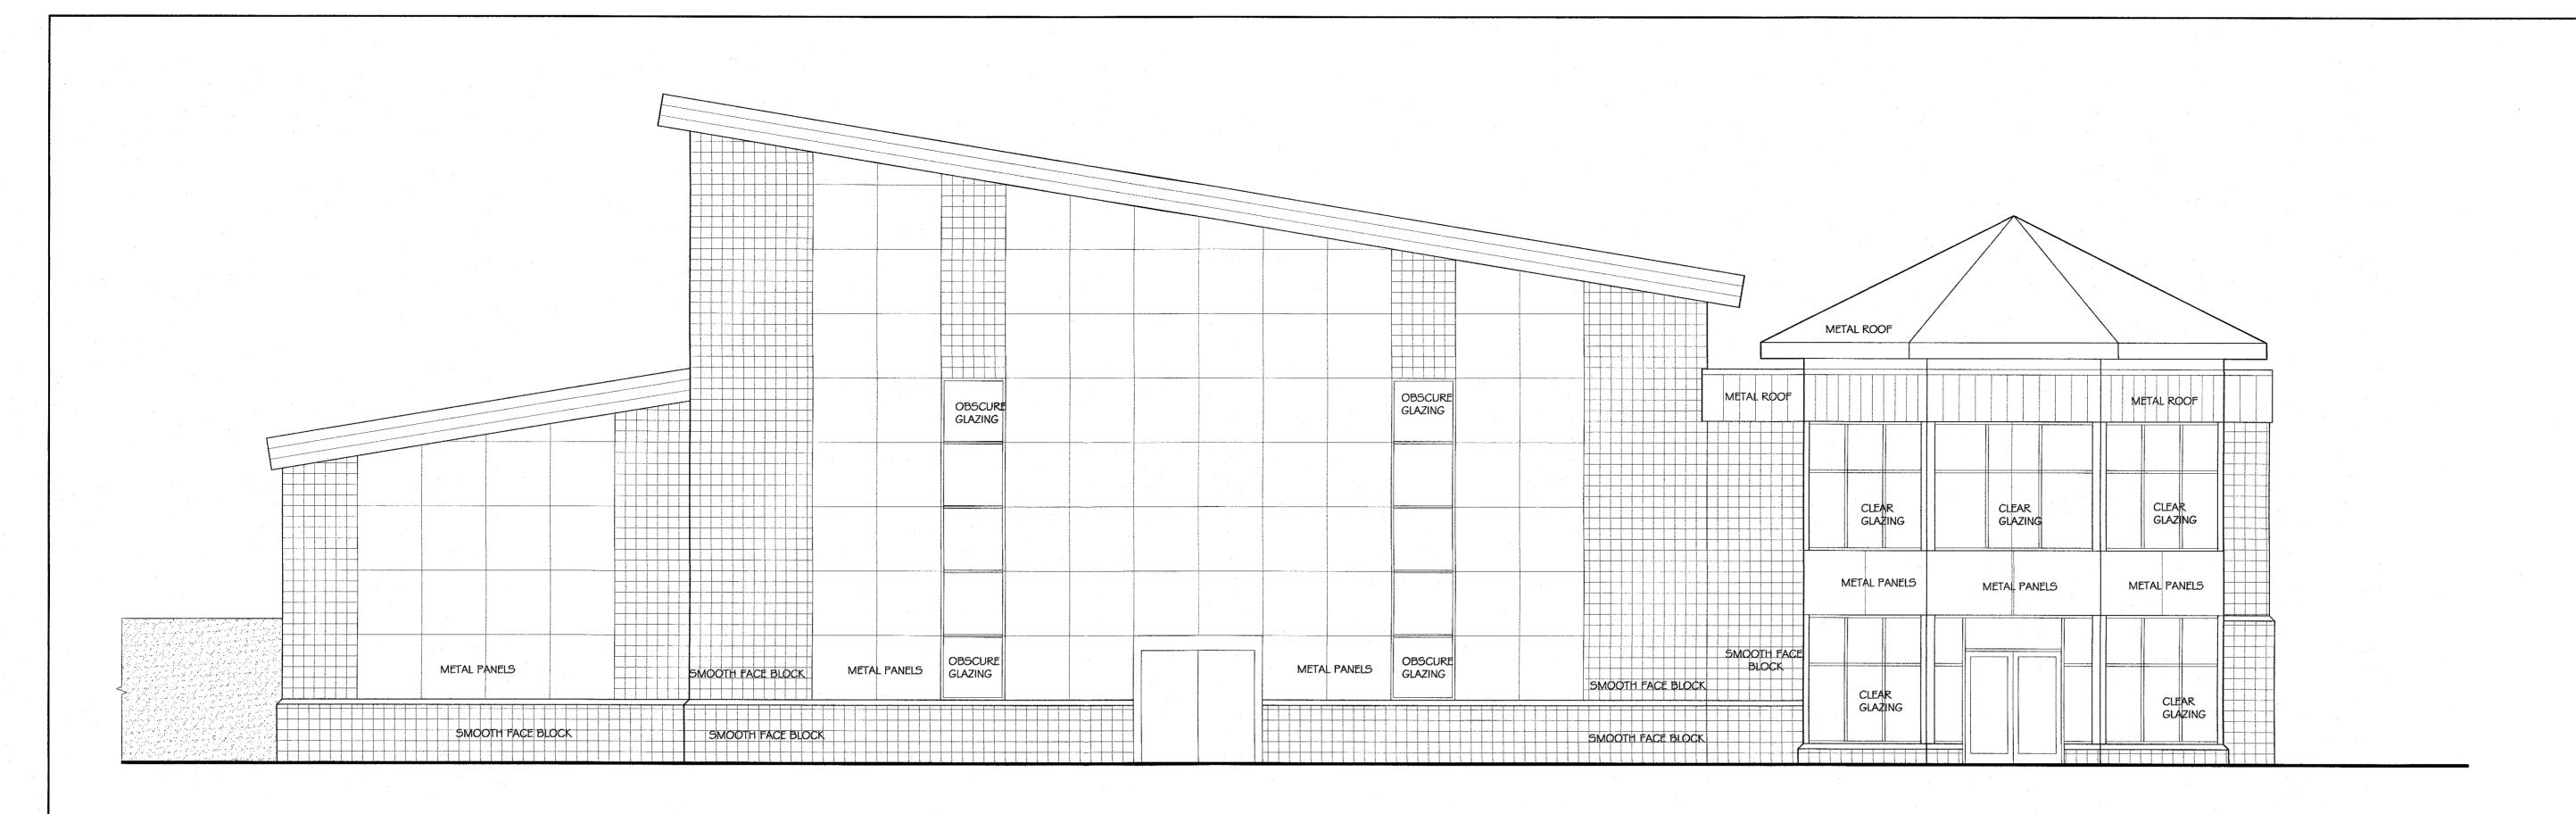

NORTH ELEVATION 3/16" = 1'-0"

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# GYM N & S ELEVATIONS


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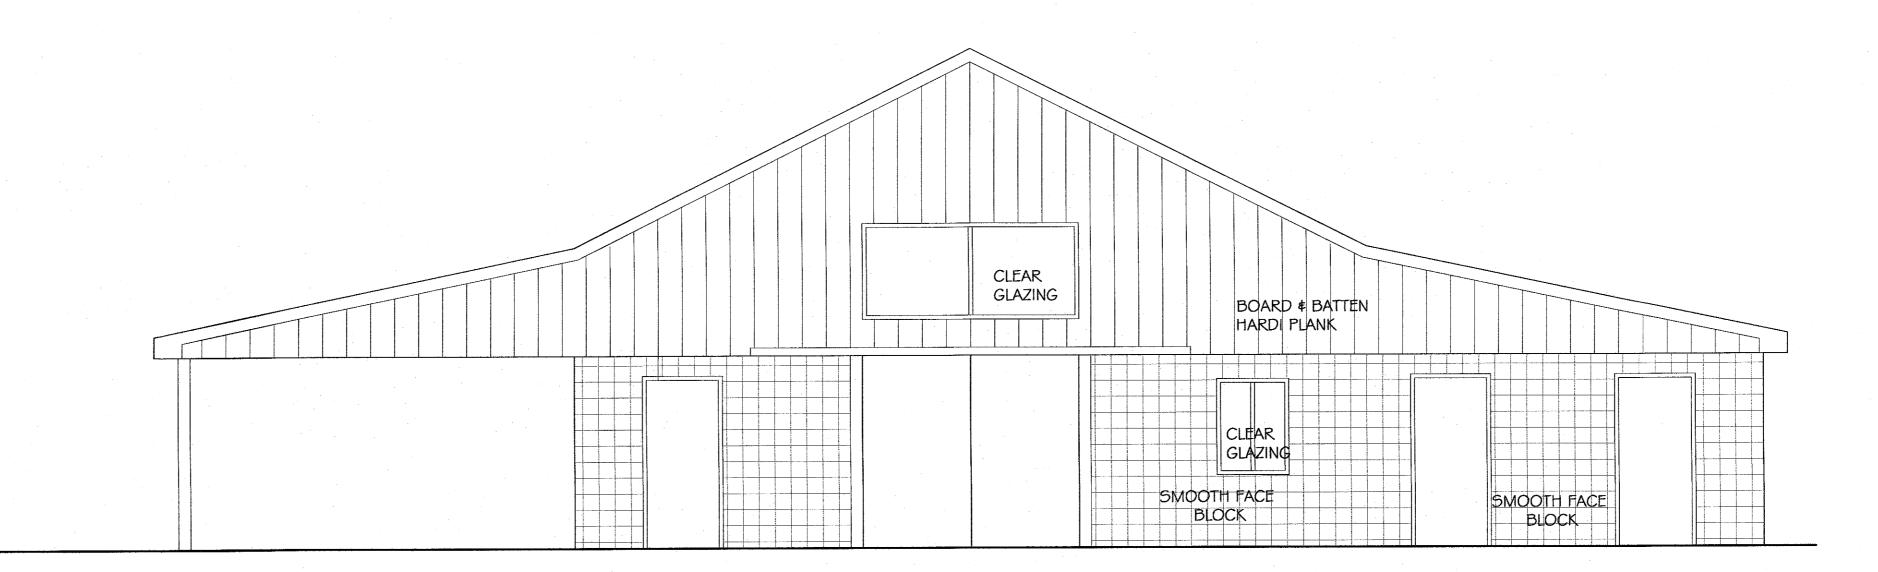
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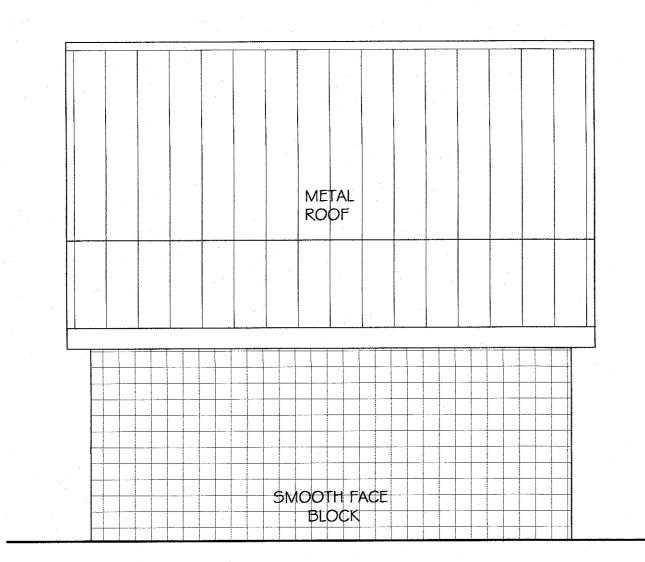
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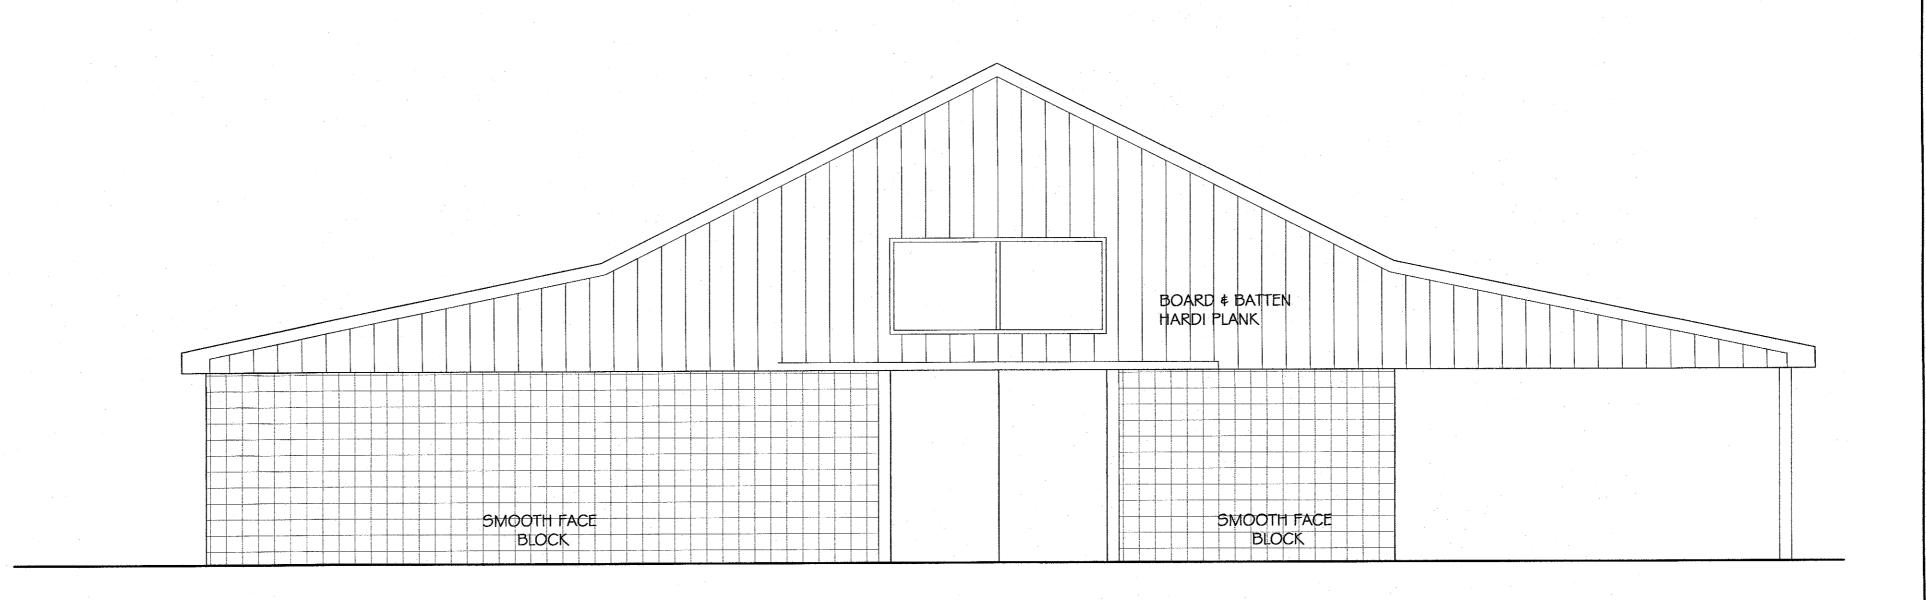


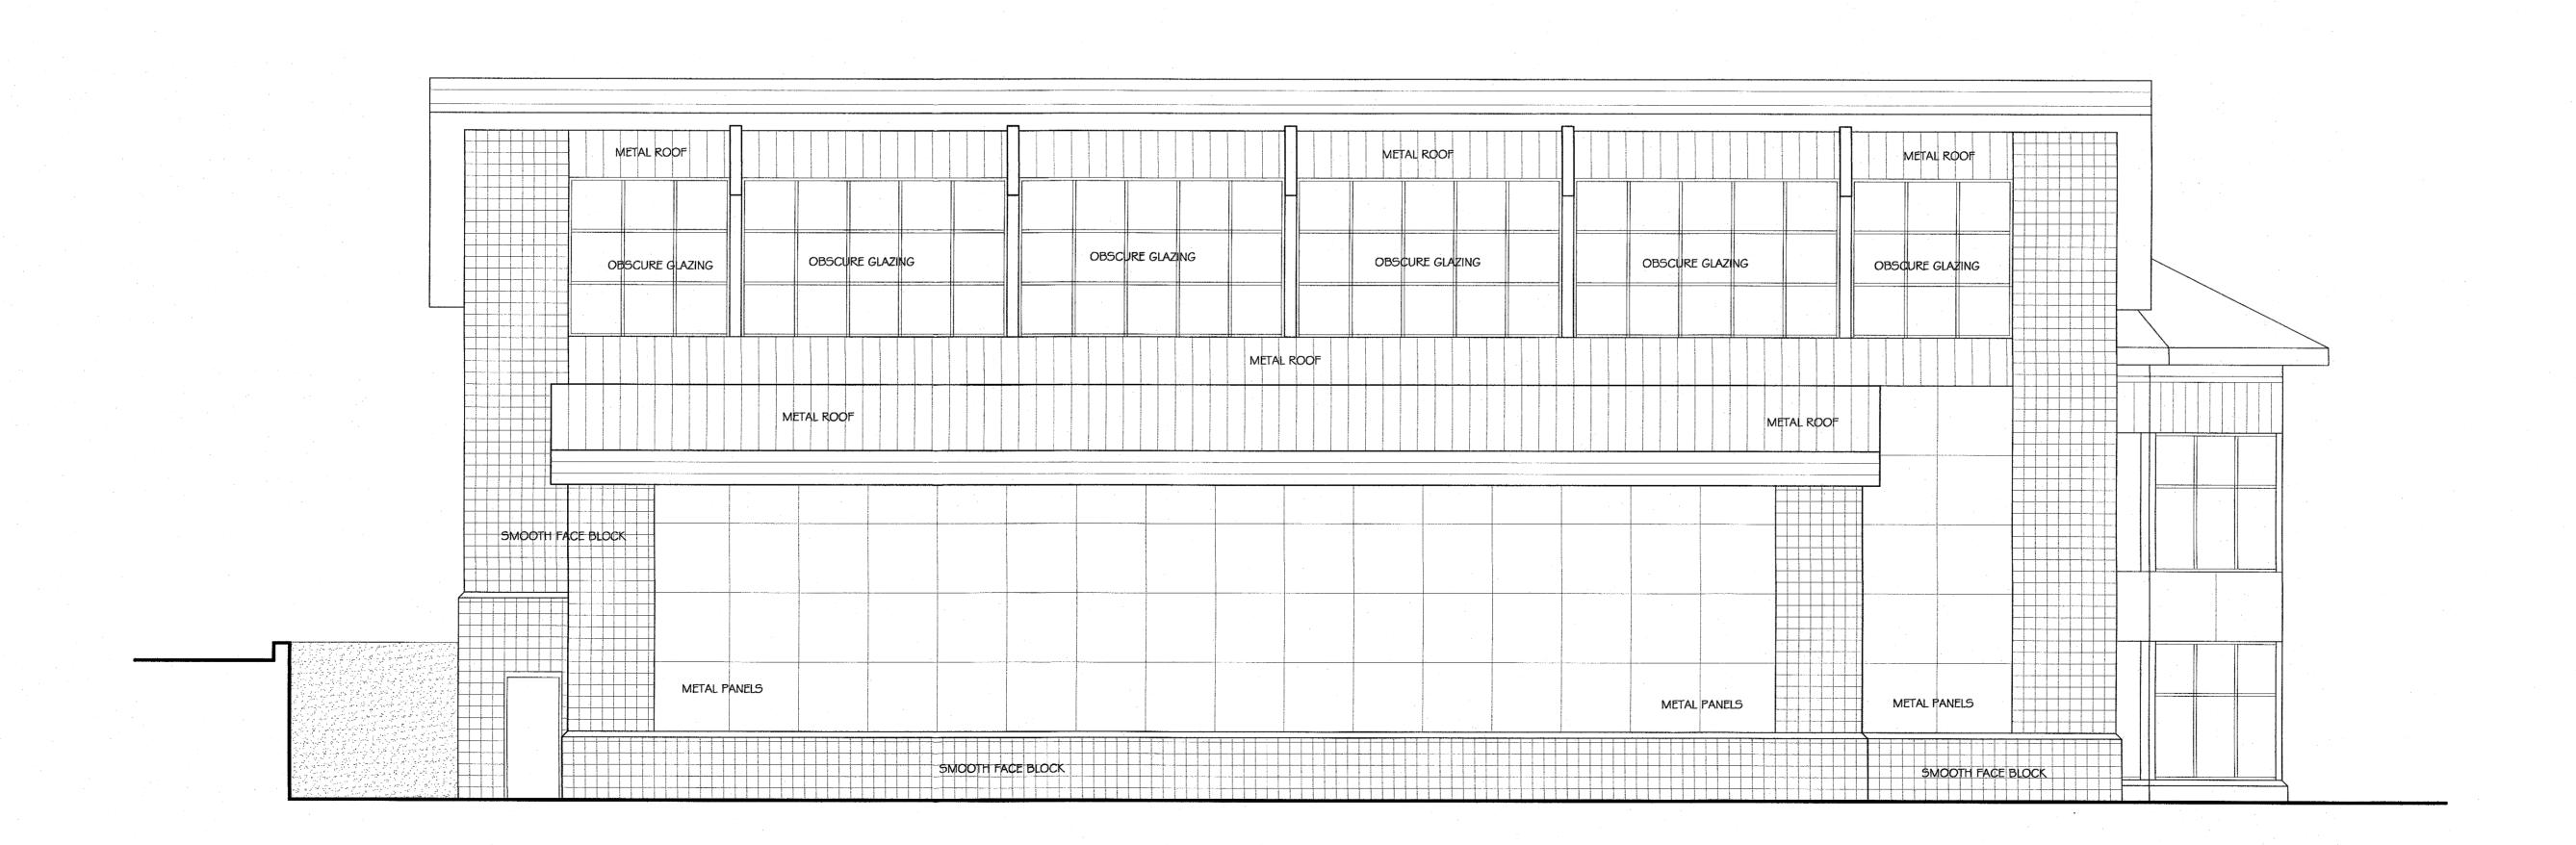EAST ELEVATION 1/4" = 1'-0"

SOUTH ELEVATION 1/4" = 1'-0"



WEST ELEVATION 1/4" = 1'-0"

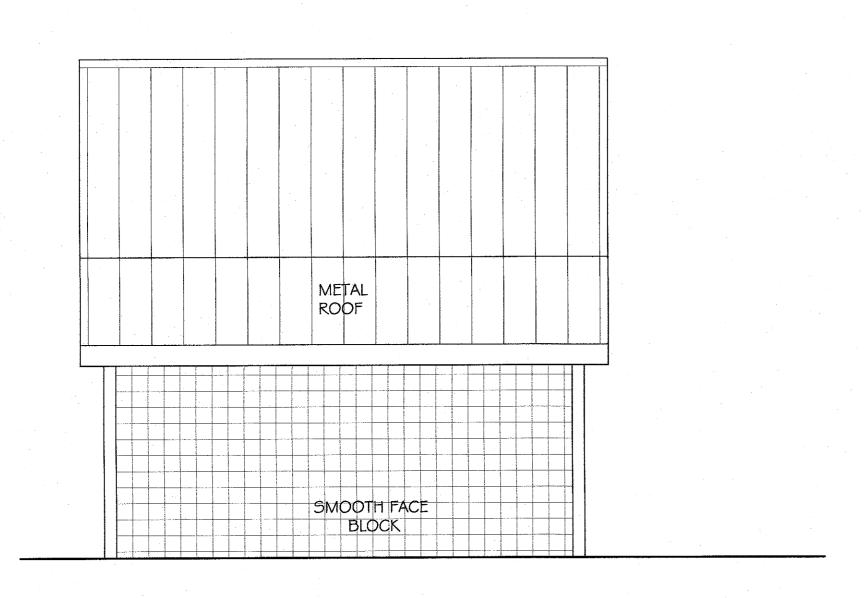

NORTH ELEVATION 1/4" = 1'-0"

#### GGA ARCHITECTS

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ISSUE/REVISION	DATE NO

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# MAINTENANCE BUILDING

Project Number:	
Scale:	AS NOTED
Date:	062FEBRUARY02017
Sheet Number:	