

DEMOLITION GENERAL NOTES

- 1. DEMOLITION PLANS SHOW APPROXIMATE LAYOUT OF EXISTING BUILDING AND IS NOT INTENDED TO REPRESENT "AS-BUILT" CONDITIONS. G.C. TO VISIT SITE AND OTHERWISE BECOME FAMILIAR WITH ACTUAL CONDITIONS WHEN BIDDING THE WORK
- 2. PRIOR TO ANY DEMOLITION WORK, CONTRACTOR MUST FIELD VERIFY ALL EXISTING MECHANICAL, PLUMBING AND ELECTRICAL WORK LOCATED IN THE TENANT SPACE WHICH AFFECTS THE ADJACENT TENANT SPACES. THE LANDLORD AND THE ADJACENT TENANTS MUST BE NOTIFIED PRIOR TO SHUTDOWN OF ANY SHARED MECHANICAL, PLUMBING AND ELECTRICAL SYSTEMS.
- WALLS, PARTITIONS, DOORS, FRAMES, AND OTHER ITEMS TO BE REMOVED ARE SHOWN DASHED. SERVICES WITHIN WALLS AND PARTITIONS SHALL ALSO BE REMOVED. EDGES OF WALLS SHOWN TO REMAIN SHALL BE SAWCUT OR CLEANLY TOOTHED TO ACCEPT NEW CONSTRUCTION. REPAIR AND PATCH EXISTING WALLS SHOWN TO REMAIN WHERE INTERSECTING WALLS, DOORS, FRAMES, ETC. ARE SHOWN TO BE REMOVED AND WHERE EXISTING CONSTRUCTION WILL NOW BE EXPOSED IN THE NEW CONSTRUCTION.
- 4. EXISTING CONSTRUCTION SHOWN TO REMAIN INCLUDING BUT NOT LIMITED TO WALLS, PARTITIONS, DOORS, FRAMES, ETC. SHALL BE PROTECTED DURING DEMOLITION. DAMAGE TO EXISTING CONSTRUCTION SHOWN TO REMAIN SHALL BE RESTORED TO MATCH PRE-DAMAGED CONDITION.
- 5. PROTECT FROM DAMAGE ALL EXISTING FINISH WORK TO REMAIN IN PLACE AND WHICH BECOMES EXPOSED DURING DEMOLITION OPERATIONS.
- 6. PROVIDE ALL NECESSARY SHORING, BRACING, AND SUPPORT TO PREVENT MOVEMENT, SETTLEMENT, OR COLLAPSE OF STRUCTURE OR ELEMENT TO BE DEMOLISHED, AND ADJACENT STRUCTURE OR ELEMENT SHOWN TO REMAIN. SHORING AND BRACING SHALL BE DESIGNED BY CONTRACTOR'S PROFESSIONAL ENGINEER LICENSED IN THE APPLICABLE JURISDICTION.
- 7. PROVIDE TEMPORARY WEATHER PROTECTION AND SECURITY DEVICES DURING INTERVAL BETWEEN DEMOLITION AND REMOVAL OF EXISTING CONSTRUCTION ON EXTERIOR SURFACES AND INSTALLATION OF NEW CONSTRUCTION TO ENSURE THAT NO WATER LEAKAGE OR DAMAGE OCCURS TO STRUCTURE OR TO INTERIOR AREAS OF EXISTING BUILDING.
- 8. WHERE FINISHES ARE SHOWN TO BE REMOVED FROM EXISTING CONSTRUCTION, REPAIR AND PATCH REMAINING SUBSTRATE AND PREPARE FOR NEW FINISH. REPAIR AND PATCH ALL REMAINING SUBSTRATES THAT WERE ORIGINALLY CONCEALED BY EXISTING FINISHES, BUT WILL NOW BE EXPOSED IN THE NEW
- 9. SALVAGE MATERIAL AS REQUIRED FOR PATCHING AND INFILL (SEE DRAWINGS FOR NEW WORK). SALVAGE MATERIAL SHALL BE CLEANED AND STORED IN AREAS AWAY FROM THE DEMOLITION OR UNTIL NEEDED.
- 10. ALL INFILL OR REPLACEMENT WORK SHALL MATCH EXISTING CONDITIONS IN MATERIALS, CONSTRUCTION AND FINISH, UNLESS SPECIFICALLY NOTED ELSEWHERE IN THE CONSTRUCTION DOCUMENTS.
- 11. DO NOT CHIP OR CRACK THE EXISTING CONCRETE DURING REMOVAL OF EXISTING FLOOR FINISHES 12. G.C. TO PROVIDE DUMPSTER & CONTINUOUS CLEAN-UP DURING DEMOLITION TO PROVIDE SAFE AND
- 13. G.C. TO SALVAGE ANY BRICK REMOVED DURING DEMOLITION PROCESS FOR REUSE IN CONSTRUCTION

PHASE.

KEYNOTE LEGEND (DEMOLITION)

D100	PORTION OF EXISTING EXTERIOR WALL TO BE REMOVED IN ITS ENTIRETY. G.C. TO VERIF
	EXTENTS OF EXISTING LINTEL AT OPENING. NOTIFY ARCHITECT IF LINTEL EXTENDS PAST
	LEASE SPACE.

D101 PORTION OF EXISTING INTERIOR WALL TO BE REMOVED IN ITS ENTIRETY. D102 EXISTING STOREFRONT SYSTEM AND DOORS TO BE REMOVED IN THEIR ENTIRETY.

FINISHES DURING DEMOLITION.

- D103 REMOVE INTERIOR FURRING AT INSIDE FACE OF FRONT WALL TO EXPOSE MASONRY FOR
- NEW WORK. D104 REMOVE INTERIOR FINISHES AT INSIDE FACE OF EXISTING MASONRY WALL IN ORDER TO EXPOSE EXISTING MASONRY FOR FUTURE WORK. G.C. TO PROTECT ADJACENT WALL
- REMOVE FACE STONE AT EXISTING PILASTER FOR FUTURE WORK. PROTECT CMU BACKER AND EIFS DURING DEMOLITION.

FLOOR PLAN GENERAL NOTES

1. DO NOT SCALE DRAWINGS

2. ALL CONSTRUCTION SHALL COMPLY WITH ALL APPLICABLE STATE, CITY AND LOCAL CODES AND ORDINANCES

3. WHERE EXISTING CONDITIONS ARE CUT OR DISTURBED TO PERMIT INSTALLATION OF NEW WORK, MATCH AND PATCH EXISTING DISTURBED CONSTRUCTION TO ORIGINAL CONDITION.

4. DIMENSIONS AND CONDITIONS SHALL BE VERIFIED IN THE FIELD BY THE GENERAL CONTRACTOR (G.C.) PRIOR TO CONSTRUCTION OR ORDER OF PROJECT MATERIALS. ANY REVISIONS, CHANGES, DEVIATIONS, OR INCONSISTENCIES BETWEEN THE AS BUILT CONDITIONS AND THESE DRAWINGS SHALL IMMEDIATELY BE REPORTED TO THE OWNER BEFORE CONSTRUCTION.

KEYNOTE LEGEND (NEW WORK)

REAR WALL TO RECIEVE CONTINUOUS WATERPROOFING APPLICATION AT INTEIROR FACE OF MASONRY UP TO 4'-0" A.F.F.. WHERE EXISTING FINISHES WERE REMOVED TO EXPOSE MASONRY, NEW FINISHES SHOULD BE INSTALLED TO MATCH EXISTING ADJACENT FINISHES. G.C. TO CONFIRM FIELD CONDITIONS.

NEW STOREFRONT WALL SYSTEM AND DOORS. REFER TO ELEVATIONS AND WINDOW/DOOR

SCHEDULES FOR ADDITIONAL INFORMATION. NEW KNEE WALLL WHERE EXISTING FRONT WALL WAS REMOVED. REFER TO WALL SECTIONS AND ELEVATIONS FOR ADDITIONAL INFORMATION.

NEW FLOODGATE BRACKET AT SMOOTH-FACE STONE AT NEW KNEEWALL. REFER TO WALL SECTIONS, ELEVATIONS AND DETAILS FOR ADDITIONAL INFORMATION. REFER TO DETAILS FOR FLOODGATE BRACKET ATTACHEMENT INFORMATION.

NEW FLOODGATE BRACKET AT EXISTING WALL. REFER TO ELEVATIONS AND DETAILS FOR ADDITIONAL INFORMATION. REFER TO DETAILS FOR FLOODGATE BRACKET ATTACHEMENT

BRAKE METAL COLUMN SURROUND WHERE EXISTING COLUMN SURROUND WAS REMOVED. REFER TO SECTIONS AND PLAN DETAILS FOR ADDITIONAL INFORMATION. BRAKE METAL SURROUND TO BE WATER TIGHT AND TO MATCH PROPOSED STOREFRONT FINISH.


NEW FACE STONE AND CAP WHERE EXISTING WERE REMOVED DURING DEMOLITION. APPLY CONTINUOUS CEMENTITIOUS FLOOD PROOFING TO OUTSIDE FACE OF EXSITING 8" CMU BACKER WITHIN PILASTER.

FRONT WALL TO RECIEVE CONTINUOUS WATERPROOFING APPLICATION AT INTERIOR FACE OF MASONRY UP TO 4'-0" A.F.F.. G.C. TO CONFIRM FIELD CONDITIONS.



No.

CASCO Professional Services, LLC ARCHITECTURAL LICENSE #: 52650 EXP. DATE: 12/31/24

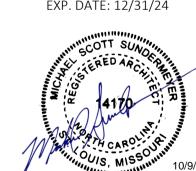


Professional of Record MICHAEL S. SUNDERMEYER LICENSE #: 14170 EXP. DATE: 06/30/25 Drawn/Checked JT

Project Number 2404551 --/--/--Bid Date 10/02/24 Permit Date --/--/--For Construction

FLOOR PLANS

A101

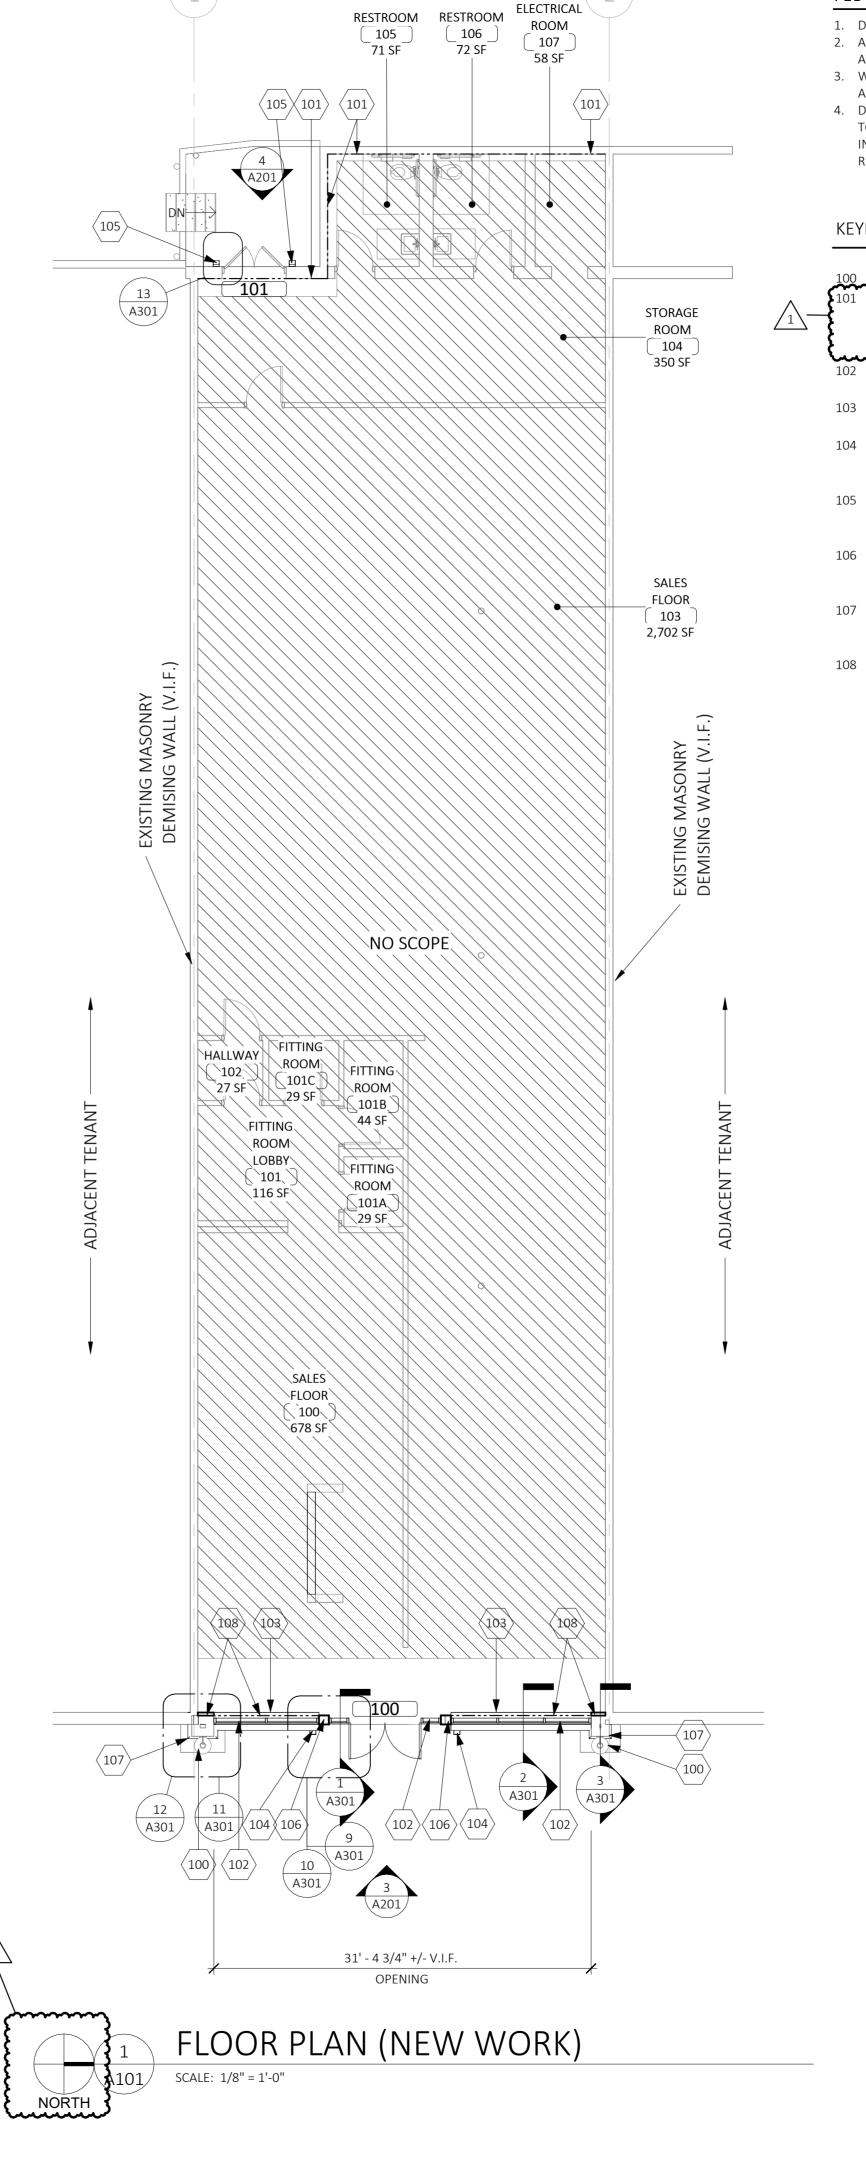



DEMOLITION FLOOR PLAN

SCALE: 1/8" = 1'-0"

